

FREEDOM HIGH SCHOOL

NEW AUXILIARY GYMNASIUM

1050 NEROLY RD, OAKLEY, CA 94561

LIBERTY UNION HIGH SCHOOL DISTRICT



DSA FILE NO 7-H4

DSA APPLICATION NO: 01-119278

PTN: 61721-78

DSA SUBMITTAL

DECEMBER 28, 2020

PROJECT TEAM

OWNER

Liberty Union School District
20 Oak Street
Brentwood, CA 94513
Phone: 925-634-2166 ext. 2036
Fax: 925-634-1687
Email: evolta@libertyuhdsd.k12.ca.us

ARCHITECT

Quattrocchi Kwok Architects
636 Fifth Street
Santa Rosa, CA 95404
Phone: 707-576-0829
Fax: 707-576-0295
Email: jimt@qka.com

CONSTRUCTION MANAGER

Lathrop Construction Associates, Inc.
4001 Park Road
Benicia, CA 94510
Phone: 707-746-8000
Direct: 707-746-4450
Email: anthony.damante@lathropconstruction.com

CIVIL ENGINEER

Carlson Barbee & Gibson, Inc.
2633 Camino Ramon, Suite 350
San Ramon, CA 94583
Phone: 925-866-0322 x297
Email: mvidra@cbandg.com

LANDSCAPE ARCHITECT

GSM Landscape Architects, Inc.
1700 Soscol Ave., Suite 23
Napa, CA 94559
Phone: 707-255-4630 (office)
Phone: 707-815-7661
Email: bart@gsmllainc.com

STRUCTURAL ENGINEER

ZFA Structural Engineers
1212 Fourth Street, Suite Z
Santa Rosa, CA 95404
Phone: 707-526-0992
Fax: 707-526-0217
Email: deidrad@zfa.com

MECHANICAL AND PLUMBING ENGINEER

Costa Engineers
3274 Villa Lane
Napa, CA 94558
Phone: 707-252-9177
Fax: 707-252-6473
Email: cdelcore@costaengineers.com

ELECTRICAL ENGINEER

O'Mahony & Myer (OM&M)
4340 Redwood Highway, Suite 245
San Rafael, CA 94903
Phone: 415-492-0420
Fax: 415-479-6962
Email: pcolenbrander@ommconsulting.com

FIRE PROTECTION

Cypress Engineering Group
8 Harris Court, Suite A8
Monterey, CA 93940
Phone: 831.917.0551
Email: steve@cypresseg.com

AUDIO-VISUAL CONSULTANT


The Shalleck Collaborative Inc.
1553 Martin Luther King Jr. Way
Berkeley, CA 94709
Phone: 415-956-4100
Email: krenzke@shalleck.com

ENERGY

Soldata Energy Consulting, Inc.
2227 Capricorn Way, Suite 202
Santa Rosa, CA 95407
p (707) 545-4440
f (707) 545-4447
sarah@soldata.com


CATHODIC PROTECTION

Cathodic Protection Consultant
V&A Consulting Engineers
1000 Broadway, Suite 320
Oakland, CA 94607
Phone: (510) 903-6600
Email: cteall@vaengineering.com

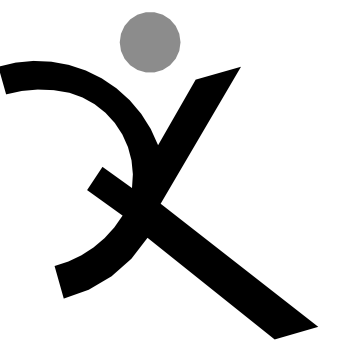

QUATTROCCHI KWOK
ARCHITECTS

Main:
636 Fifth Street, Santa Rosa, CA 95404
East Bay:
55 Harrison Street, Suite 525,
Oakland, CA 94607
(707) 576-0829

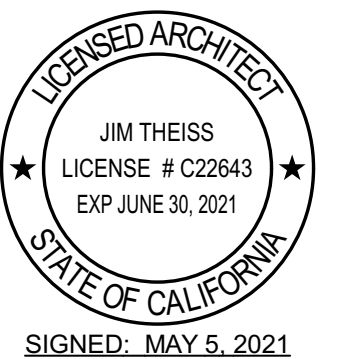

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ARCH PROJECT NO: 1869.00

DRAWN BY: CH

DRAWING SCALE: N.T.S.

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BID DOCUMENT

APRIL 27, 2021

SHEET TITLE

COVER SHEET

SHEET NUMBER

G-0.1

	AND	F	FACE		PC	PORTLAND CEMENT
	ANGLE	FA	FIRE ALARM		PTR	POUNDS PER CUBIC FOOT
@	AT	FCO	FLOOR CLEAN OUT		P.C.F.	POWER DRIVEN ANCHOR
Q	CENTERLINE	FDD	FLOOR DRAIN		PDA	PERFORATED
	FEET	FDN	FOUNDATION		PERF	PIRE HEIGHT
*	INCHES	FE	FIRE EXTINGUISHER		PH	PLATE
d	PENNY	FEC	FIRE EXTINGUISHER CABINET		PL	PROPERTY LINE
#	POUND/ NUMBER	FF	FINISH FLOOR		P/L	PLASTIC LAMINATE
		FG	FINISH GRADE		PLAM	PLASTER/ PLASTIC
AB	ANCHOR BOLT	FGL	FIBERGLASS		PLAS	POUNDS PER LINEAL FOOT
ABBREV	ABBREVIATION	FH	FIRE HYDRANT		PLYWD	PLYWOOD
AC	ASPHALT CONCRETE	FHMS	FLAT HEAD MACHINE SCREW		P.O.C.	POINT OF CONTACT
A/C	AIR CONDITIONING	FHS	FIRE HOSE STATION		PAR	PROPERTY
ACCESS	ACCESSIBLE	FHW	FLAT HEAD WOOD SCREW		PROP	POUNDS PER SQUARE FOOT
ACOUS	ACOUSTICAL	FIB CEM	FIBER CEMENT		PSI	POUNDS PER SQUARE INCH
AC T	ACOUSTICAL TILE	FIN	FINISH		PTDF	PRESSURE TREATED
AD	AREA DRAIN	FIXT	FIXTURE		PTN	PARTITION
ADJ	ADJUSTABLE	FL	FLOOR LINE		PTR	PAPER TOWEL RECEPTACLE
A.F.F.	ABOVE FINISH FLOOR	FLASH	FLASHING		PVC	POLYVINYL CHLORIDE
AGG	AGGREGATE	FLUOR	FLUORESCENT		PVMT	PAVEMENT
ALUM	ALUMINUM	FLR	FLOOR		R	RISER
ANOD	ANODIZED	FM/ FOM	FACE OF MASONRY		R / RAD	RADIUS
APPROX	APPROXIMATE	FN	FACE NAIL		RD	ROOF DRAIN
ARCH	ARCHITECTURAL	FOC	FACE OF CONCRETE		REF	REFERENCE
ASPH	ASPHALT	FOF	FACE OF FINISH		REFR	REFRIGERATOR
		FOS	FACE OF STUD		REG	REGULAR
BD	BOARD	FRMG	FRAMING		REQD	REQUIRED
BIDUM	BITUMINOUS	FR	FIRE-RESISTANT		REINF	REINFORCED
BLDG	BUILDING	FRP	FIBERGLASS REINFORCED		RH	ROOF HATCH
BLK	BLOCK		PANEL		RHMS	ROUND HEAD MACHINE SCREW
BLKG	BLOCKING	FT	FEET		RHWS	ROUND HEAD WOOD SCREW
BM	BEAM	FTG	FOOTING		RM	ROOM
BOT	BOTTOM	FURR	FURRING		RO	ROUGH OPENING
BO	BY OWNER				RWL	RAIN WATER LEADER
BRK	BREAK	GA	GAUGE		RWD	REDWOOD
BRG	BEARING	GALV	GALVANIZED		S	SOUTH
BTW	BETWEEN	GB	GRAB BAR		S.A.D.	SEE ARCHITECTURAL DRAWINGS
BUILT-UP	BUILT-UP	GC	GENERAL CONTRACTOR		S.A.V.D.	SEE AUDIO VIDEO DRAWINGS
BUR	GALVANIZED ROOFING	GI	GALVANIZED IRON		SC	SOLID CORE
		GL	GLASS/ GLAZING		S.C.D.	SEE CIVIL DRAWINGS
CAB	CABINET	GLB	GLUE LAMINATED BEAM		SCHD	SCHEDULE
CB	CATCH BASIN	GND	GROUND		SD	STORM DRAIN
CBC	CALIFORNIA BUILDING CODE	GR	GRADE		SECT	SECTION
CEM	CEMENT	GYP BD	GYPSUM BOARD		S.E.D.	SEE ELECTRICAL DRAWINGS
CER	CERAMIC				SEP	SEPARATION
CAST IRON	CAST IRON	HB	HOSE BIBB		S.F.P.D.	SEE FIRE PROTECTION DRAWING
CIR	CIRCLE	HCR	HOLLOW CORE		SHTG	SHEATHING
CJ	CONTROL JOINT	HDR	HEADER		SIM	SIM
CORR	CORRIDOR	HDWD	HARDWOOD		SL	SLIDING
CL	CLOSET/ CENTER LINE	HDWR	HARDWARE		S.L.D.	SEE LANDSCAPE DRAWINGS
CLG	CEILING	HM	HOLLOW METAL		S.M.D.	SEE MECHANICAL DRAWING
CLR	CLEAR	HOR	HORIZONTAL		SHT	SHUT OFF VALVE
CLS	CLOSURE	HR	HIGH POINT		S.P.D.	SEE PLUMBING DRAWINGS
CMU	CONCRETE MASONRY UNIT	HSS	HOLLOW STEEL SECTION		SPEC	SPECIFICATION
CO	CLEANOUT	HR	HOLLOW STEEL SECTION		SPKR	SPEAKER
COL	COLUMN	HT	HEIGHT		SS	SQUARE
COMB	COMBINATION	HTG	HEATING		SS	STAINLESS STEEL
COMP	COMPOSITION	HVAC	HEATING, VENTILATING, AIR-CONDITIONING		S.S.D.	SEE STRUCTURAL DRAWINGS
CONC	CONCRETE				S.T.H.D.	SEE THEATER DRAWINGS
CONN	CONNECTION				STA	STATION
CONST	CONSTRUCTION	ID	INSIDE DIAMETER		STD	STANDARD
CONT	CONTINUOUS	INSUL	INSULATION		STL	STEEL
CONTR	CONTRACTOR	INT	INTERIOR		STOR	STORAGE
CT	CERAMIC TILE	INTEG	INTEGRAL		STRUCT	STRUCTURAL
CTR	CENTER	INTERMED	INTERMEDIATE		SUSP	SUSPENDED
CTSK	COUNTERSINK	INV	INVERT		SYM	SYMMETRICAL
CUST	CUSTODIAN					
CW	COLD WATER	JH	JOIST HANGER			
		JST	JOIST			
DBL	DOUBLE	JT	JOINT			
DEPT	DEPARTMENT					
DET	DETAIL	KIT	KITCHEN			
DF	DRINKING FOUNTAIN	KP	KICK PLATE			
DG	DECOMPOSED					
		LAB	LABORATORY		T	TREAD
DI	DRAIN INLET	LAM	LAMINATE		T&B	TOP & BOTTOM
DIA	DIAMETER	LAV	LAVATORY		TC	TOP OF CURB
DIAG	DIAGONAL	LL	LINE LOAD		TEL	TELEPHONE
DM	DIMENSION	LP	LOW POINT		TER	TERRAZZO
DISP	DISPOSAL	LT	LIGHT		T&G	TONGUE & GROOVE
DIV	DIVISION				TH	THICK
DN	DOWN	MAT	MATERIAL			

	COLUMN GRIDS A AND 1 IN BUILDING A								
	DIMENSION TO FACE OF STUD OR MASONRY								
	DIMENSION TO FACE OF FINISH								
	DIMENSION TO CENTER LINE OR COLUMN LINE								
	RELATIVE ELEVATION DIMENSION								
	DOOR A IN ROOM NUMBER 101 IN BUILDING B ACCESSIBLE CLEARANCES SHOWN DASHED								
	SEE								
	WINDOW NUMBER 009								
	DETAIL NUMBER 11 ON SHEET NUMBER A-9.12								
	SECTION NUMBER 3 ON SHEET NUMBER A-B6.2								
	ELEVATION NUMBER 2 ON SHEET NUMBER A-B5								
FLOOR PLAN	<table> <tr> <td>CLASSROOM</td><td>ROOM NAME</td></tr> <tr> <td></td><td>ROOM NUMBER 204 IN BUILDING A</td></tr> <tr> <td></td><td>FLOOR FINISH CODE F-4</td></tr> <tr> <td></td><td>INTERIOR ELEVATION SHOWN ON SHEET A-A7.6</td></tr> </table>	CLASSROOM	ROOM NAME		ROOM NUMBER 204 IN BUILDING A		FLOOR FINISH CODE F-4		INTERIOR ELEVATION SHOWN ON SHEET A-A7.6
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	ROOM NUMBER 204 IN BUILDING A								
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REFLECTED CLG PLAN	<table> <tr> <td>CLASSROOM</td><td>ROOM NAME</td></tr> <tr> <td></td><td>ROOM NUMBER 204 IN BUILDING A</td></tr> <tr> <td></td><td>CEILING FINISH CODE CL-6</td></tr> <tr> <td></td><td>FINISH CEILING HEIGHT 10'-0"</td></tr> </table>	CLASSROOM	ROOM NAME		ROOM NUMBER 204 IN BUILDING A		CEILING FINISH CODE CL-6		FINISH CEILING HEIGHT 10'-0"
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	ROOM NUMBER 204 IN BUILDING A								
	CEILING FINISH CODE CL-6								
	FINISH CEILING HEIGHT 10'-0"								
	KEYNOTE NUMBER 33								
	METAL WALL FRAMING SIZE 8"								
	WALL ACOUSTIC RATING OF STC 50								
	TOILET ACCESSORY C								
	ARCHITECTURAL WOODWORK STANDARDS (AW) CABINET DESIGN SERIES IDENTIFIER								
	FINISH CODE, WALL FINISH 2 SHOWN								
	ROOM / BUILDING ACCESSIBLE SIGNAGE TYPE SEE ARCHITECTURAL GRAPHICS PLAN AND ACCESSIBLE SIGNAGE DETAIL								
	RELATIVE ORIGIN OR WORK POINT								
	EQUIPMENT TAG REFER TO EQUIPMENT SCHEDULE								

1. ALL WORK IS SHOWN, DESCRIBED OR SPECIFIED IN THE DRAWINGS INDEXED ON THIS PAGE OR IN THE SPECIFICATIONS.

ALL WORK NOT INDICATED AS EXISTING (E) IS NEW.

2. ALL FRAMING DIMENSIONS ARE TO FACE OF STUD UNLESS NOTED OTHERWISE.
● DO NOT SCALE DRAWINGS.
● VERIFY ALL DIMENSIONS WHERE WORK INVOLVES FRAMING FOR WINDOWS, DOORS, OR CABINETS.

3. ONLY WORK SO NOTED IS NOT IN CONTRACT (N.I.C.) ALL N.I.C. ITEMS ARE NOT PART OF DSA APPROVAL

4. GOVERNING CODES: A COPY OF TITLE 24 PARTS 1-5 SHALL BE KEPT ON THE JOB AT ALL TIMES.
CALIFORNIA CODE OF REGULATIONS TITLE 24 BUILDING STANDARDS CODE:
PART 1 2019 CALIFORNIA ADMINISTRATIVE CODE (CAC), PART 1, TITLE 24 CCR
PART 2 2019 CALIFORNIA BUILDING CODE (CBC), PART 2, TITLE 24 CCR
(2018 INTERNATIONAL BUILDING CODE, VOL. 1 & 2, AND 2019 CALIFORNIA AMENDMENTS)
PART 3 2019 CALIFORNIA ELECTRICAL CODE (CEC), PART 3, TITLE 24 CCR
(2017 NATIONAL ELECTRICAL CODE AND 2016 CALIFORNIA AMENDMENTS)
PART 4 2019 CALIFORNIA MECHANICAL CODE (CMC), PART 4, TITLE 24 CCR
(2018 IAPMO UNIFORM MECHANICAL CODE AND 2016 CALIFORNIA AMENDMENTS)
PART 5 2019 CALIFORNIA PLUMBING CODE (CPC), PART 5, TITLE 24 CCR
(2018 IAPMO UNIFORM PLUMBING CODE AND 2019 CALIFORNIA AMENDMENTS)
PART 6 2019 CALIFORNIA ENERGY CODE (CEC), PART 6, TITLE 24 CCR
PART 9 2019 CALIFORNIA FIRE CODE (CFC), PART 9, TITLE 24 CCR
(2018 INTERNATIONAL FIRE CODE AND 2019 CALIFORNIA AMENDMENTS)
PART 10 2019 CALIFORNIA EXISTING BUILDING CODE (CEBC), PART 10, TITLE 24 CCR
(2018 INTERNATIONAL EXISTING BUILDING CODE AND 2019 CALIFORNIA AMENDMENTS)
PART 11 2019 CALIFORNIA GREEN BUILDING STANDARDS CODE (CAL-GREEN), PART 11, TITLE 24 CCR
PART 12 2019 CALIFORNIA REFERENCED STANDARDS CODE, PART 12, TITLE 24 CCR
TITLE 19 CCR, PUBLIC SAFETY CODE, STATE FIRE MARSHAL REGULATIONS
2010 ADA STANDARDS FOR ACCESSIBILITY DESIGN
2016 ASME A17.1-16/CSA B44-16 SAFETY CODE FOR ELEVATORS AND ESCALATORS

5. STANDARD AND GUIDES:

NFPA 13	INSTALLATION OF FIRE SPRINKLER SYSTEMS (CA AMENDED)	2016 EDITION
NFPA 14	INSTALLATION OF STANDBY AND HOSE SYSTEMS	2016 EDITION
NFPA 17	DRY CHEMICAL EXTINGUISHING SYSTEMS	2017 EDITION
NFPA 17A	WET CHEMICAL FIRE EXTINGUISHING SYSTEMS	2017 EDITION
NFPA 20 EDITION NFPA 24	INSTALLATION OF STATIONARY PUMPS FOR FIRE PROTECTION	2016
NFPA 25	STANDARD FOR THE INSTALLATION OF PRIVATE FIRE SERVICE MAINS AND THEIR APPURTENANCES CALIFORNIA EDITION - TESTING, MAINTENANCE OF WATER-BASED FIRE PROTECTION SYSTEMS	2016 EDITION 2013 EDITION
NFPA 72	NATIONAL FIRE ALARM AND SIGNALING CODE (CA AMENDED)	2016 EDITION
NFPA 80	STANDARD FOR FIRE DOORS AND OTHER OPENING PROTECTIVES	2016 EDITION
NFPA 110	STANDARD FOR STANDBY POWER SYSTEMS	2016 EDITION
NFPA 170	STANDARD FOR FIRE SAFETY AND EMERGENCY SYMBOLS	2018 EDITION
NFPA 2001 EDITION	STANDARD ON CLEAN AGENT FIRE EXTINGUISHING SYSTEMS	2015
UL 300	STANDARD FOR FIRE TESTING OF FIRE EXTINGUISHING SYSTEMS FOR PROTECTION OF COMMERCIAL COOKING EQUIPMENT	2005 (R2010)
UL 464	AUDIBLE SIGNALING DEVICES FOR FIRE ALARM AND SIGNALING SYSTEMS, INCLUDING ACCESSORIES	2003 EDITION
UL 521	STANDARD FOR HEAT DETECTORS FOR FIRE PROTECTIVE SIGNALING SYSTEMS	1999 EDITION
UL 1971	STANDARD FOR SIGNALING DEVICES FOR THE HEARING IMPAIRED	2002 EDITION
UL 2034	STANDARD FOR SINGLE AND MULTIPLE CARBON MONOXIDE ALARMS	2017 EDITION
ICC 300	STANDARD FOR BLEACHERS, FOLDING AND TELESCOPIC SEATING, AND GRANDSTANDS	2017 EDITION

6. IN ACCORDANCE WITH TITLE 24 PART 1 CHAPTER 4: THE ADMINISTRATIVE REGULATIONS FOR THE DIVISION OF THE STATE ARCHITECT STRUCTURAL SAFETY (DSA/SS)
● 4-331 DSA SHALL BE NOTIFIED AT THE START OF CONSTRUCTION.
● 4-332 WHEN CONSTRUCTION IS SUSPENDED FOR MORE THAN ONE MONTH, THE PROJECT INSPECTOR SHALL INFORM DSA.
● 4-333(a) OBSERVATION OF THE WORK SHALL BE BY ARCHITECT OR REGISTERED ENGINEER.
● 4-333(b) THE DISTRICT MUST PROVIDE AND PAY FOR PROJECT INSPECTOR.
● 4-334 SUPERVISION OF CONSTRUCTION BY DSA SHALL BE IN ACCORDANCE WITH THIS SECTION.
● 4-335 STRUCTURAL TESTS AND INSPECTION ARE IN ACCORDANCE WITH THIS SECTION. TESTS OF MATERIALS AND TESTING LAB SHALL BE IN ACCORDANCE WITH SECTION 4-335 AND THE DISTRICT SHALL EMPLOY AND PAY THE LAB. COSTS OF RE-TEST MAY BE BACKCHARGED TO THE CONTRACTOR. ALL TESTS SHALL CONFORM TO THE REQUIREMENTS OF SECTION 4-335 AND APPROVED T & I SHEET (DSA-103)
● 4-336 VERIFIED REPORTS SHALL BE SUBMITTED BY CONTRACTORS (DSA 006-C), INSPECTORS (DSA 006-FI), ARCHITECTS AND ENGINEERS (DSA 006-E) IN ACCORDANCE WITH SECTIONS 4-336 AND 4-343.
● 4-337 SEMI-MONTHLY REPORTS SHALL BE SUBMITTED BY INSPECTORS (DSA - 155), IN ACCORDANCE WITH SECTIONS 4-337.
● 4-338 WORK SHALL BE EXECUTED IN ACCORDANCE WITH THE APPROVED PLANS, ADDENDA AND CONSTRUCTION DOCUMENTS. CHANGES IN THE APPROVED PLANS AND SPECIFICATIONS SHALL BE MADE BY ADDENDA OR CHANGE DOCUMENTS. TESTS AND INSPECTIONS ARE REQUIRED AND SIGNED BY THE ARCHITECT OR REGISTERED ENGINEER IN CHARGE. ADDENDA AND CHANGE DOCUMENTS SHALL BE SUBMITTED TO AND APPROVED BY DSA PRIOR TO COMMENCEMENT OF WORK.
● 4-341(a) THE ARCHITECT AND THE REGISTERED ENGINEER SHALL PERFORM THEIR DUTIES IN ACCORDANCE WITH SECTIONS 4-333(a) AND 4-341.
● 4-341(c) INSPECTORS SHALL BE APPROVED BY DSA.
● 4-342 INSPECTION SHALL BE IN ACCORDANCE WITH SECTION 4-333 THE DUTY OF THE INSPECTOR SHALL BE IN ACCORDANCE WITH THIS SECTION.
● 4-343 THE CONTRACTOR SHALL PERFORM HIS DUTIES IN ACCORDANCE WITH THIS SECTION.

7. THE INTENT OF THE DRAWINGS AND SPECIFICATIONS IS THAT THE WORK OF ALTERATION, REHABILITATION OR RECONSTRUCTION IS TO BE IN ACCORDANCE WITH TITLE 24, C.C.R. SHOULD ANY EXISTING CONDITIONS BE DISCOVERED WHICH ARE NOT COVERED BY THE CONTRACT DOCUMENTS WHEREIN THE FINISHED WORK WILL NOT COMPLY WITH SAID TITLE 24 C.C.R. A CONSTRUCTION CHANGE DOCUMENT DETAILING AND SPECIFYING THE REQUIRED REPAIR WORK SHALL BE SUBMITTED TO AND APPROVED BY DSA BEFORE PROCEEDING WITH THE REPAIR WORK. (TITLE 24 PART 1, SECTION 4-338(c))

8. COMPLIANCE WITH CFC CHAPTER 33, FIRE SAFETY DURING CONSTRUCTION AND DEMOLITION AND CBC CHAPTER 33, SAFETY DURING CONSTRUCTION SHALL BE ENFORCED.

9. EMERGENCY VEHICLE ACCESS ROADS AND ON-SITE FIRE HYDRANTS SHALL BE IN SERVICE AND OPERABLE PRIOR TO LOADING THE SITE WITH COMBUSTIBLE MATERIALS.


10. GRADING PLANS, DRAINAGE IMPROVEMENTS, ROAD AND ACCESS REQUIREMENTS, AND ENVIRONMENTAL HEALTH CONSIDERATIONS SHALL COMPLY WITH APPLICABLE LOCAL ORDINANCES.

NONE

QUATTROCCHI KWOK
ARCHITECTS

Main:
Fifth Street, Santa Rosa, CA 95404

East Bay:
55 Harrison Street, Suite 525,
Oakland, CA 94607
(707) 576-0829

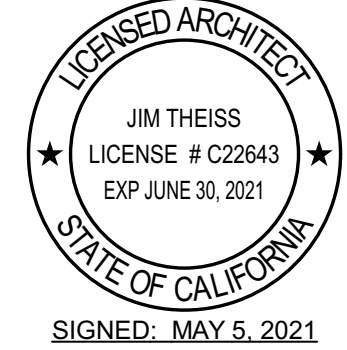

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[illegible]

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DRAWN BY: *fill out manually ea sheet*

DRAWING SCALE: _____ N.T.S.

BID DOCUMENT

APRIL 27, 2021

SHEET NUMBER

G-0.2

SHEET INDEX (TOTAL 135 SHEETS)

FIRE PROTECTION (9 SHTS)

FP-0.1	LEGEND, NOTES, AND ABBREVIATIONS	FIRE PROTECTION
FP-0.2	DETAILS - FIRE PROTECTION	
FP-1.1	SITE PLAN - FIRE PROTECTION	
FP-M2.1	PIPING PLAN - FIRE PROTECTION	
FP-M3.1	CEILING PLAN - FIRE PROTECTION	
FP-M4.1	SECTIONS - FIRE PROTECTION	
FP-6.1	DETAILS - FIRE PROTECTION	
FP-6.2	DETAILS - FIRE PROTECTION	
FP-6.3	SEISMIC BRACING CALCULATIONS - FIRE PROTECTION	

AUDIO VISUAL (11 SHTS)

AV-M0.1	AV PANEL SCHEDULE & ALS INFORMATION
AV-M0.2	AV WIRETYPE SCHEDULE
AV-M0.3	AV STANDARD DETAILS
AV-M0.4	AV STANDARD DETAILS
AV-M1.1	AV DEVICE PLAN AT LEVEL 1
AV-M2.1	AV DEVICE RCP AT LEVEL 1
AV-M3.1	AUDIO PLANS & SECTIONS AT THEATRE
AV-M5.1	WIRE & CONDUIT RISER DIAGRAMS
AV-M6.1	AV BLOCK DIAGRAMS
AV-M7.1	AV PANEL ELEVATIONS
AV-M8.1	AV MOUNTING DETAILS

BLEACHERS (11 SHTS)

B1	A00: TITLE SHEET A01: PLAN VIEW
B2	A02: SECTION VIEW A03: DETAILS
B3	S1: COVER SHEET S2: 10° RISE PLAN, ELEVATION & FRAMING
B4	S4: DECK & SEAT ASSEMBLIES S5:NARROW IDS POWER ASSY
B5	S7: POST ASSEMBLIES S8: POST ASSEMBLIES CONT.
B6	S9: DECK SUPPORTS S10: DECK SUPPORTS CONT.
B7	S11: BRACING S12: BRACING CONT.
B8	S13: WALL ATTACHMENT DETAIL S14: S15: END RAILS
B9	S16: AISLE STEPS S17: AISLE HAND RAIL
B10	S18: ACCESSIBLE SPACES S19: ACCESSIBLE SPACES CONT.
B11	S20: DIMENSIONS

TITLE 24 ENERGY CALCS (3 SHTS)

T-1.1	TITLE 24 ENERGY CALCS
T-1.2	TITLE 24 ENERGY CALCS
T-1.3	TITLE 24 ENERGY CALCS

CATHODIC PROTECTION (2 SHTS)

CP-1.1	CATHODIC PROTECTION
CP-1.2	CATHODIC PROTECTION

GENERAL (7 SHTS)

G-0.1	COVER SHEET
G-0.2	ABBREVIATIONS AND NOTES
G-0.3	SHEET INDEX
G-0.4	FIRE LIFE SAFETY SITE PLAN
G-0.5	SITE ACCESS PLAN
G-0.6	ENLARGED SITE PLAN, CODE ANALYSIS, EXITING PLAN
G-0.7	OVERALL SITE PLAN

CIVIL (7 SHTS)

C-1.0	EXISTING CONDITIONS/DEMOLITION
C-2.0	HORIZONTAL CONTROL PLAN
C-2.1	DETAILS
C-3.0	UTILITY PLAN
C-4.0	GRADING AND DRAINAGE PLAN
C-5.0	STORMWATER CONTROL PLAN
C-6.0	EROSION CONTROL PLAN

LANDSCAPE (11 SHOTS)

- L1.0 MATERIAL AND DETAIL REFERENCE PLAN
- L1.1 CONSTRUCTION DETAILS
- L1.2 CONSTRUCTION DETAILS
- L2.0 LAYOUT PLAN
- L3.0 IRRIGATION PLAN
- L3.1 IRRIGATION LEGEND AND NOTES
- L3.2 IRRIGATION DETAILS
- L3.3 IRRIGATION DETAILS
- L3.3 IRRIGATION SCHEDULES
- L4.0 PLANTING PLAN
- L4.1 PLANTING DETAILS

ARCHITECTURAL (25 SHTS)

- A-M2.1 FLOOR PLAN
- A-M2.2 COMPOSITE COURT STRIPING PLAN
- A-M3.1 REFLECTED CEILING PLAN
- A-M4.1 ROOF PLAN
- A-M5.1 EXTERIOR ELEVATIONS
- A-M6.1 BUILDING SECTIONS
- A-M6.2 WALL SECTIONS
- A-M6.3 WALL SECTIONS
- A-M7.1 INTERIOR ELEVATIONS
- A-M7.2 INTERIOR ELEVATIONS
- A-M7.3 INTERIOR ELEVATIONS
- A-M7.4 INTERIOR ELEVATIONS
- AG-2.1 ARCH GRAPHIC PLAN AND DETAILS
- AG-2.2 DOOR AND WINDOW SCHEDULE AND DETAILS
- A-9.1 EXTERIOR WALL DETAILS
- A-9.2 WALL DETAILS
- A-9.3 OPENING DETAILS
- A-9.4 ROOF DETAILS
- A-9.5 ROOF DETAILS
- A-9.6 ROOF DETAILS
- A-9.7 RAIN CANOPY DETAILS
- A-10.1 CEILING DETAILS WOOD
- A-10.2 CEILING DETAILS AT METAL DECK
- A-10.3 INTERIOR DETAILS
- A-10.4 INTERIOR DETAILS

STRUCTURAL (14 SHTS)

S-M0.1	GENERAL NOTES
S-M1.1	TYPICAL CONCRETE DETAILS
S-M1.2	TYPICAL WOOD DETAILS
S-M1.3	TYPICAL WOOD DETAILS
S-M1.4	TYPICAL METAL DECKING DETAILS
S-M2.1	FOUNDATION PLAN
S-M2.2	LOWER ROOF FRAMING PLAN
S-M2.3	UPPER ROOF FRAMING PLAN
S-M3.1	ELEVATION & SCHEDULES
S-M3.2	ELEVATIONS
S-M4.1	FOUNDATION DETAILS
S-M5.1	STEEL FRAMING DETAILS
S-M5.2	STEEL TRUSS ELEVATIONS AND DETAILS
S-M6.1	WOOD DETAILS

MECHANICAL (10 SHTS)


M-M1.1	MECHANICAL LEGENDS & SCHEDULE
M-M2.1	MECHANICAL FLOOR PLAN
M-M3.1	MECHANICAL ROOF PLAN
M-M6.1	MECHANICAL SECTIONS
M-M7.1	MECHANICAL DETAILS
M-M7.2	MECHANICAL DETAILS
M-M7.3	MECHANICAL DETAILS
M-M7.4	MECHANICAL DETAILS
M-M8.1	CONTROL DIAGRAMS
M-M8.2	CONTROL DIAGRAMS

PLUMBING (7 SHTS)

P-M1.1	PLUMBING SCHEDULES & LEGENDS
P-M2.0	GAS SITE PLAN
P-M2.1	PLUMBING WASTE & VENT FLOOR PLAN
P-M2.2	PLUMBING WATER & GAS
P-M3.1	PLUMBING ROOF PLAN
P-M7.1	PLUMBING DETAILS
P-M7.2	PLUMBING DETAILS

ELECTRICAL (18 SHTS)

E-0.1	SYMBOLS LIST, GENERAL NOTES & LIST OF DRAWINGS
E-0.2	LUMINAIRE SCHEDULE
E-1.1	SITE PLAN - ELECTRICAL
E-M2.1	FLOOR PLAN - LIGHTING
E-M3.1	FLOOR PLAN - POWER & SIGNAL
E-M3.2	ROOF PLAN - ELECTRICAL
E-S.1	SINGLE LINE DIAGRAM - POWER
E-S.2	SINGLE LINE DIAGRAM - SIGNAL
E-S.3	LIGHTING CONTROL DIAGRAM
E-6.1	PANEL SCHEDULES
E-7.1	DETAILS
E-7.2	DETAILS
E-8.1	TITLE 24 COMPLIANCE DOCUMENTS
E-8.2	TITLE 24 COMPLIANCE DOCUMENTS
FE-0.1	FIRE ALARM EQUIPMENT LIST, NOTES & DETAILS
FE-1.1	SITE PLAN - FIRE ALARM
FE-M3.1	FLOOR PLAN - FIRE ALARM
FE-S.1	FIRE ALARM RISER DIAGRAM

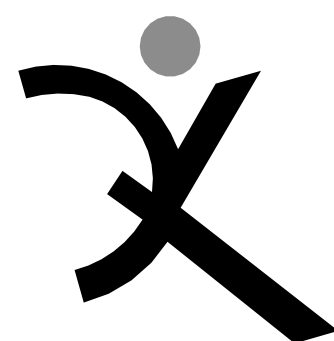

QUATTROCCHI KWOK
ARCHITECTS

Main:
636 Fifth Street, Santa Rosa, CA 95404

East Bay:
55 Harrison Street, Suite 525,
Oakland, CA 94607
(707) 576-0829



FREEDOM HIGH SCHOOL

NEW AUXILIARY GYMNASIUM

1050 NEROLY RD,
OAKLEY, CA 94561

LIBERTY UNION
HIGH SCHOOL
DISTRICT

[illegible]

DSA APP NO. 01-119278

ARCH PROJECT NO: 1869.00

DRAWN BY: RIC

DRAWING SCALE: N.T.S

PIN: 61721-78 FILE NO: 7-H4

BID DOCUMENT

APRIL 27, 2021

SHEET TITLE

SHEET INDEX

SHEET NUMBER

G-0.3

1	(E) ACC CONC WALK
2	(E) PARKING TOW-AWAY SIGN
3	(E) ACCESS TO PUBLIC
4	(E) PASSENGER DROP OFF & LOADING ZONE
5	CIVIL ITEM, S.C.D.
6	LANDSCAPE ITEM, S.L.D.
7	ACC CURB CUT, S.C.D.
8	ACC SLOPED WALK, S.C.D., S.L.D.
9	ELECTRICAL ITEM, S.E.D.

1. IMPERVIOUS SURFACES WITHIN 10 FEET OF THE BUILDING FOUNDATION SHALL BE SLOPED NOT LESS THAN 2% AWAY FROM THE BUILDING. SUCH SURFACES SHALL BE PERMITTED TO SLOPE LESS THAN 2% WHERE THE SURFACE IS A DOOR LANDING OR REQUIRED RAMP.
2. SEE THIS SHEET FOR ACCESSIBLE PATH OF TRAVEL INFORMATION
3. SEE SHEET C-0.6 FOR CODE INFORMATION
4. REFER TO CIVIL ENGINEERING DWGS FOR SIDEWALK GRADES
5. REFER TO CIVIL ENGINEERING DRAWINGS AND LANDSCAPE PLANS FOR SITE FEATURES NOT OTHERWISE INDICATED.

THE P.O.T. IDENTIFIED IN THESE CONSTRUCTION DOCUMENTS IS COMPLIANT WITH THE CURRENT APPLICABLE CALIFORNIA BUILDING CODE ACCESSIBILITY PROVISIONS FOR PATH OF TRAVEL. THE CONSTRUCTION DOCUMENTS INCLUDE THE NECESSARY STRUCTURAL REPAIRS, AS PART OF THE DESIGN OF THIS PROJECT THE P.O.T. WAS EXAMINED AND ANY ELEMENT, COMPONENTS OR PORTIONS OF THE P.O.T. THAT WERE DETERMINED TO BE NONCOMPLIANT

- 1) HAVE BEEN IDENTIFIED AND
- 2) THE CORRECTIVE WORK NECESSARY TO BRING THEM INTO COMPLIANCE HAS BEEN INCLUDED WITHIN THE SCOPE OF THIS PROJECT'S WORK THROUGH DETAILS, DRAWINGS AND SPECIFICATIONS INCORPORATED INTO THESE CONSTRUCTION DOCUMENTS.

DURING CONSTRUCTION IF P.O.T. ITEMS WITHIN THE SCOPE OF THE PROJECT REPRESENTED AS CODE-COMPLIANT ARE FOUND TO BE NONCONFORMING BEYOND REASONABLE CONSTRUCTION TOLERANCES, THEY SHALL BE BROUGHT INTO COMPLIANCE WITH THE CBC AS A PART OF THIS PROJECT BY MEANS OF A CONSTRUCTION CHANGE DOCUMENT.

THE ACCESSIBLE ROUTE (PATH OF TRAVEL) INDICATED ON THE PLAN IS A BARRIER-FREE ACCESS ROUTE AND HAS BEEN PROVIDED IN ACCORDANCE WITH IR 11B-10 AND SHALL COMPLY WITH THE FOLLOWING:

- 1:20 MAXIMUM SLOPE WITHOUT A RAMP HANDRAIL
 - 1:48 MAXIMUM CROSS SLOPE
 - NO ABRUPT VERTICAL CHANGES EXCEEDING 1/4"
 - CHANGES BETWEEN 1/4" TO 1/2" VERTICAL CAN BE 1 FT. 1:2 MAX SLOPE. CHANGES LESS THAN 1/4" CAN BE VERTICAL
 - 48" MIN. CLEAR IN WIDTH (60" MIN PASSING SPACE EVERY 200 LINEAL FEET)
 - NON-SLIP SURFACE - HEAVY BROOM FINISH AT EXTERIOR CONCRETE PAVING WHERE SLOPED <6%, MEDIUM BROOM FINISH AT SLOPES <6%
 - MAINTAIN FREE OF OVERHANGING OBSTRUCTIONS TO 90" MIN
 - PROTRUDING OBJECTS NOT GREATER THAN 4" SHALL BE MOUNTED BETWEEN 27" AND 80" A.F.F.
 - WHERE A DRAIN INLET IS IN THE PATH OF TRAVEL, THE GRATE SHALL BE ORIENTED TO THE DRAIN INLET IS 1/2" & LONG DIM IS PERPENDICULAR TO THE PREDOMINANT DIRECTION OF PEDESTRIAN TRAVEL
 - CONTRACTOR TO VERIFY THAT NO BELOW-GRADE PULL BOXES OCCUR WITHIN THE AREA OF TRUNCATED DOMES
- PARKING AND PEDESTRIAN SITE SIGNAGE SHALL COMPLY WITH CBC SECTIONS 11B-502.6 11B-502.8 & 11B-703.7.2.1**
- BLIND SIGNAGE SHALL COMPLY WITH CBC 11B-703**
- PEDESTRIAN GATES SHALL COMPLY WITH CBC 101.0.2 & 11B-206.5**

NEW BUILDING

(E) BUILDING TO REMAIN, NO WORK

BARRIER FREE PATH OF TRAVEL

(E) BARRIER FREE PATH OF TRAVEL

ACCESSIBLE ENTRY/ EXTERIOR DOOR AT P.O.T.

(E) ACCESSIBLE DRINKING FOUNTAIN

ACCESSIBLE DRINKING FOUNTAIN


ACCESSIBLE UNISEX TOILET

(E) RESTROOM - G-GIRLS; B-BOYS; S-STAFF

PROPERTY LINE (APPROX.)

	OVERALL	ACC STALL	ACC VAN STALL	REQUIRED	
				STD	VAN
(E) PARKING LOT A VISITOR & STAFF DSA 61017	352	11	2	6	2
(E) PARKING LOT B STUDENT PARKING DSA 61017; A01-61721-41	397	8	2	6	2
(E) PARKING LOT C STUDENT DSA 10-117924	72	4	1	3	1

CBC 2019 SECTION 11B-208.2.4:
FOR EVERY 6 OR FRACTION OF 6 ACC PARKING SPACES
REQUIRED, AT LEAST 1 SHALL BE A VAN ACCESSIBLE PARKING
SPACE.

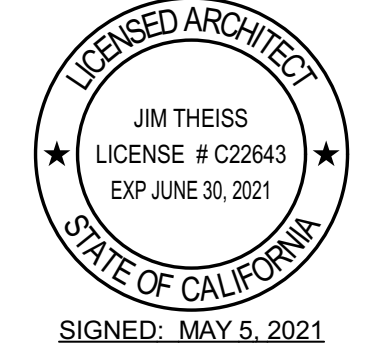

1050 NEROLY RD,
OAKLEY, CA 94561

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HIGH SCHOOL
DISTRICT[illegible]

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DRAWN BY:	R/C
DRAWING SCALE:	1:60
PTN: 61721-78	FILE NO: 7-H4

APRIL 27, 2021


SHEET TITLE

SITE ACCESS PLAN

SHEET NUMBER

G-0.5


BIMcloud: archserver - BIMcloud Basic for ARCHICAD 22/1869.00 Freedom HS Aux. Gym_CD 4/27/2021 1:26 PM

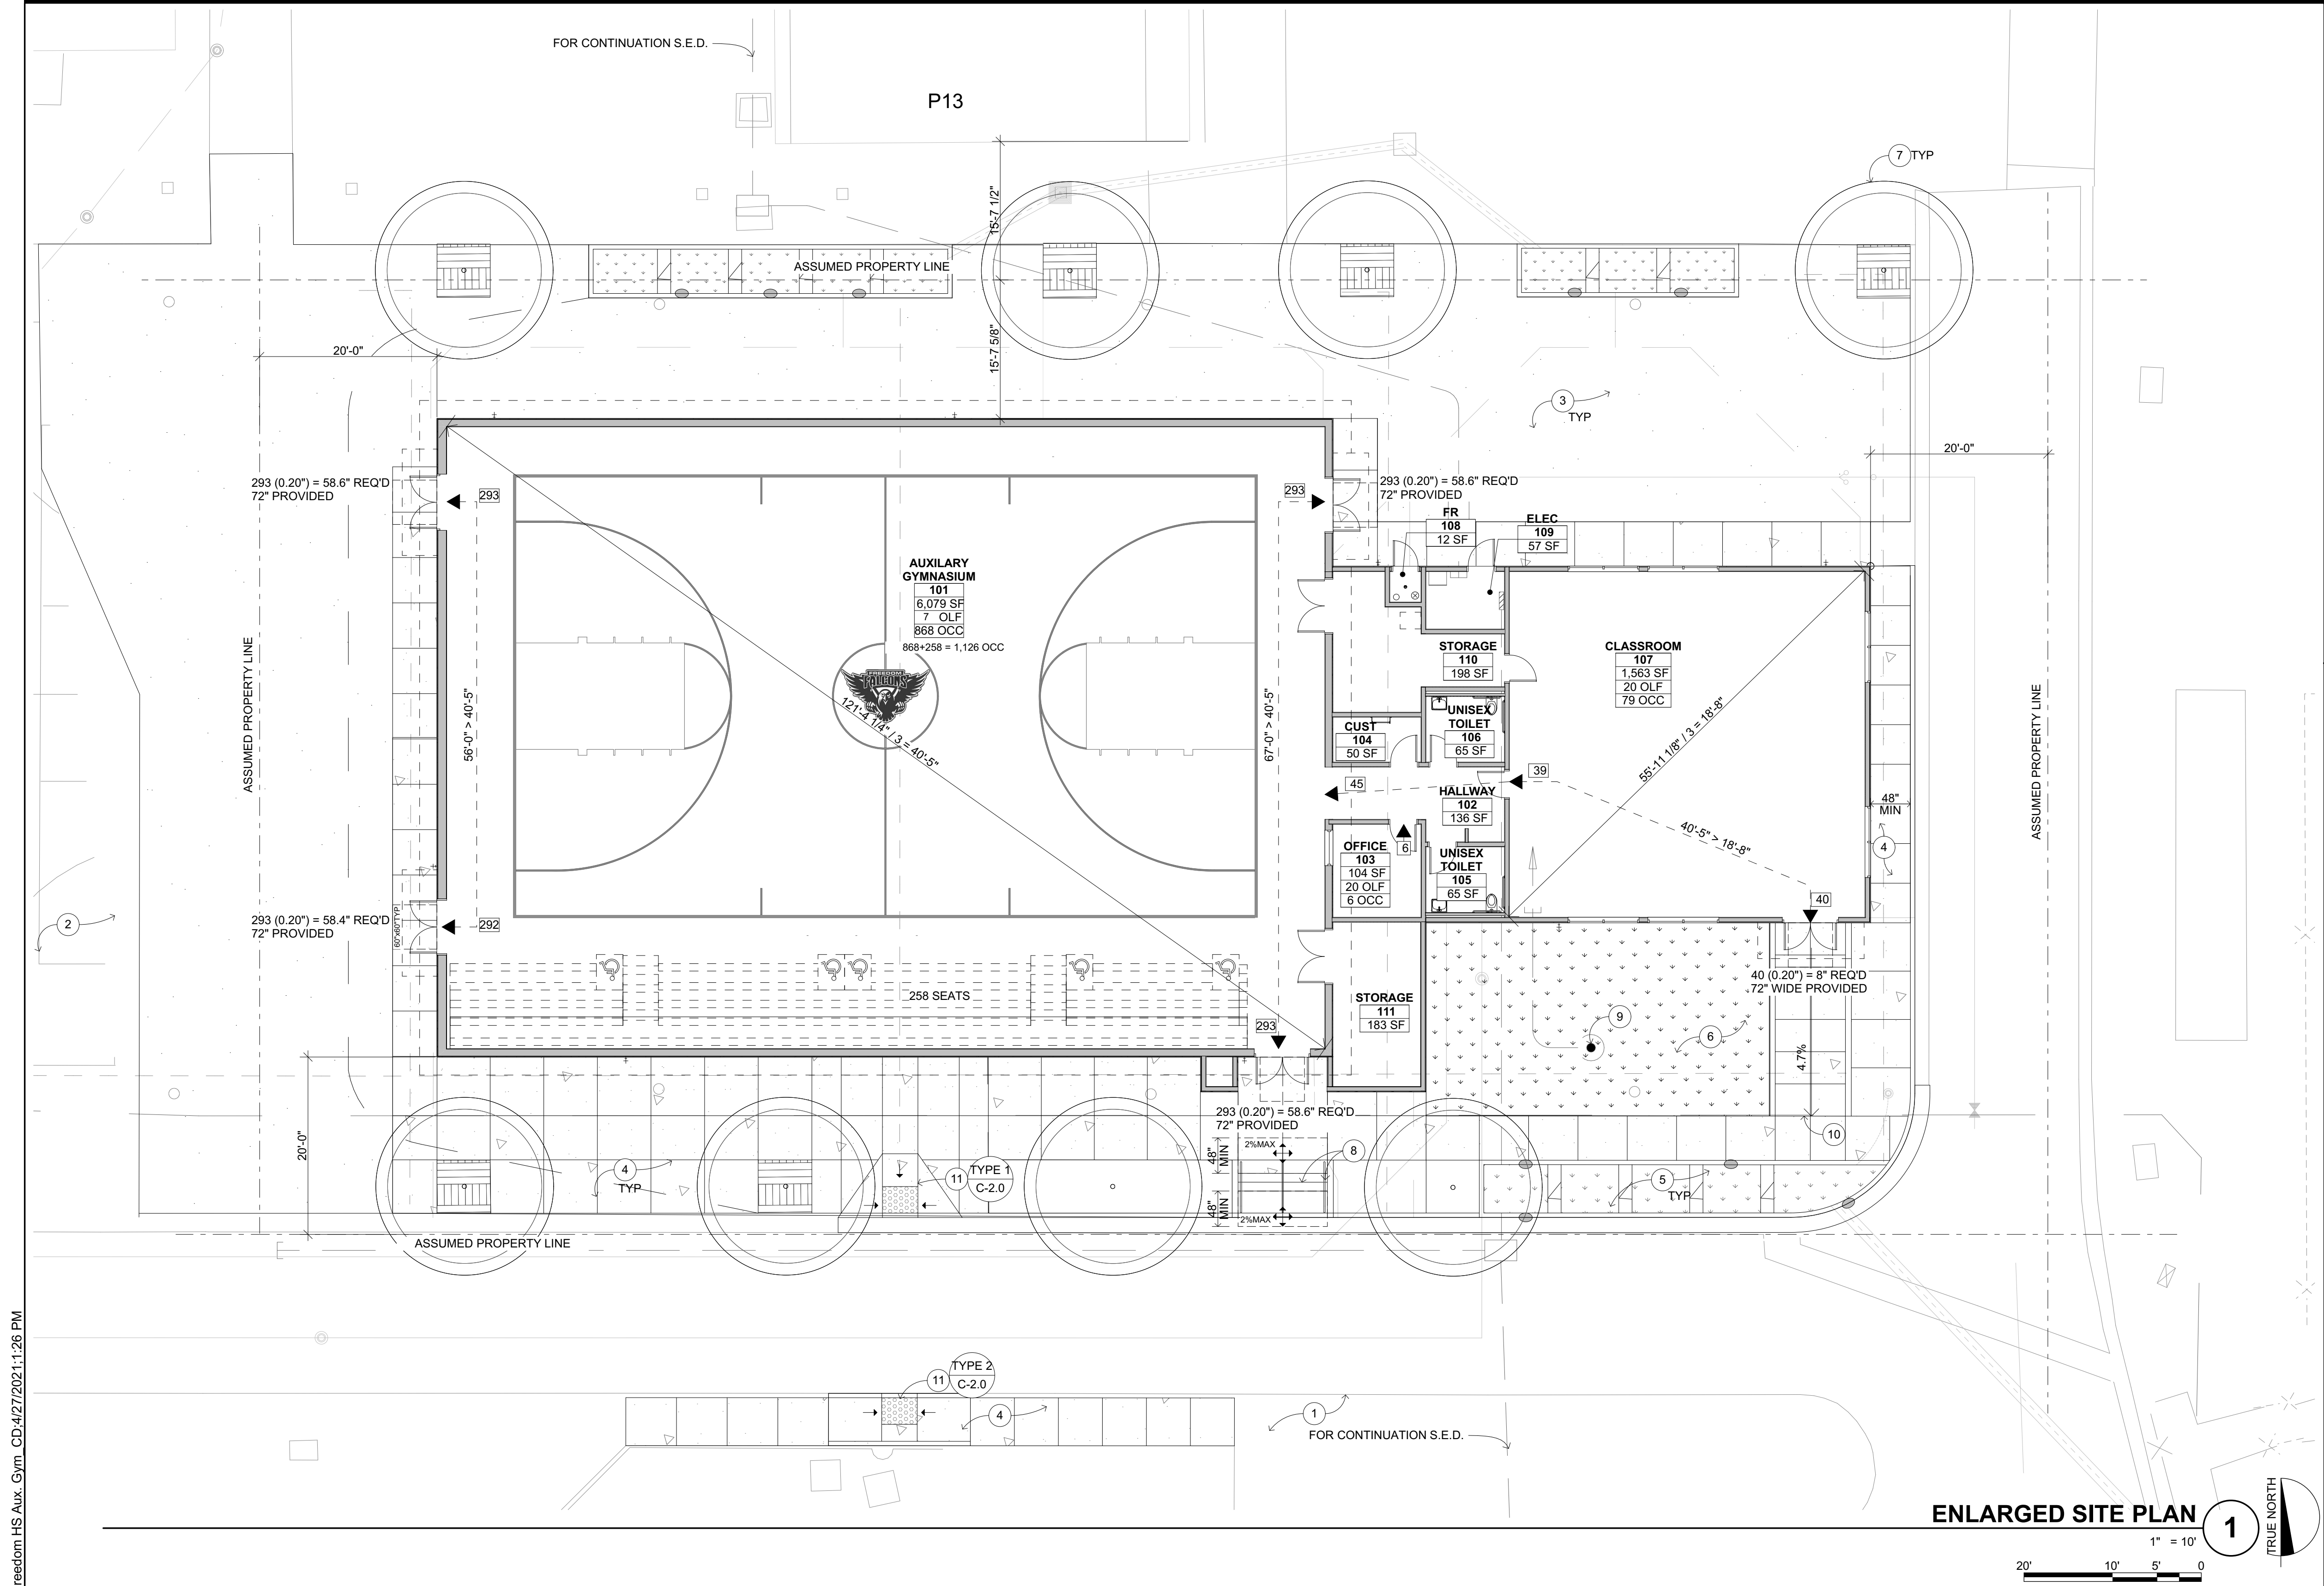

SITE KEYNOTES

- (E) CONCRETE WALK
- (E) PAVING WITH SPORTS STRIPING
- ASPHALT PAVING, S.C.D.
- CONCRETE SIDEWALK/GUTTER, S.C.D.
- BIO-RETENTION AREA, S.L.D.; S.C.D.
- SYNTHETIC TURF, S.L.D.
- PLANTING, S.L.D.
- CONCRETE STEPS AND RAILINGS, S.L.D.; S.C.D.
- ELECTRICAL ITEM, S.E.D.
- SLOPED WALK, S.C.D.
- ACC CURB CUT, S.C.D.

SITE PLAN LEGEND

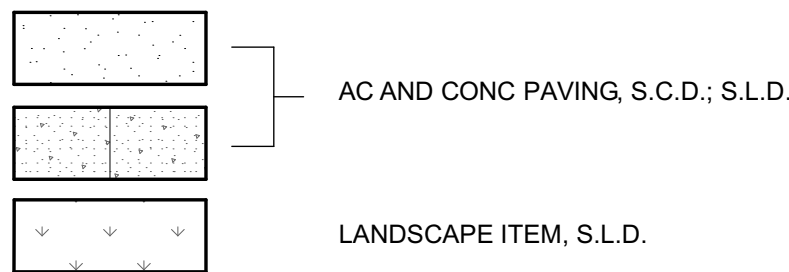

QUATTROCCHI KWOK
ARCHITECTS
Main:
636 Fifth Street, Santa Rosa, CA 95404
East Bay:
55 Harrison Street, Suite 525,
Oakland, CA 94607
(707) 576-0829



SIGNED: MAY 5, 2021

FREEDOM HIGH SCHOOL

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DISTRICT

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ARCH PROJECT NO: 1869.00

DRAWN BY: R/C

DRAWING SCALE: 1/8" = 1'-0"

PTN: 61721-78 FILE NO: 7-H4

BID DOCUMENT


APRIL 27, 2021

SHEET TITLE

ENLARGED SITE PLAN, CODE ANALYSIS, EXITING PLAN

SHEET NUMBER

G-0.6

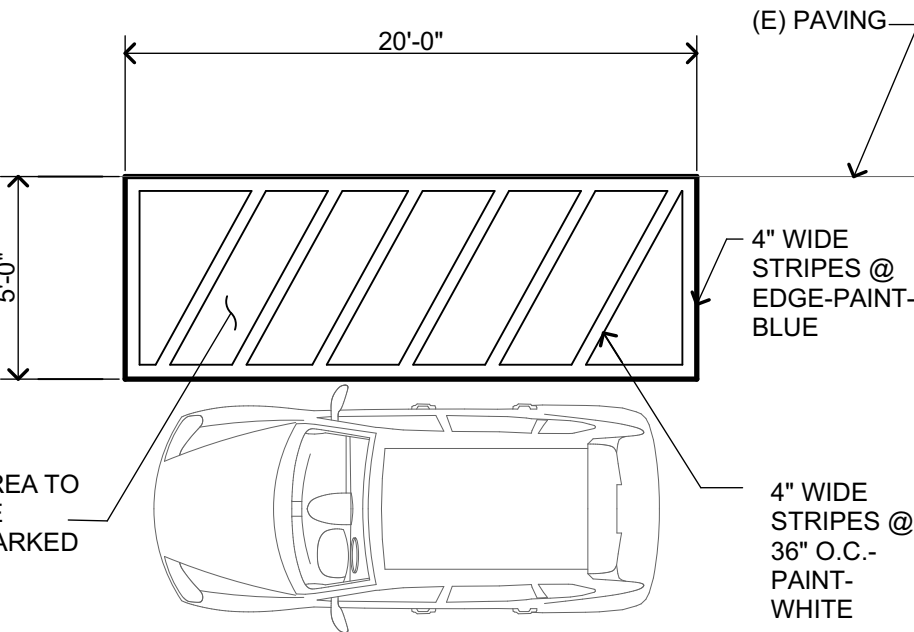

PASSENGER DROP-OFF AND LOADING ZONE

1 1/2" = 1'-0"

UNAUTHORIZED VEHICLES PARKED
IN DESIGNATED ACCESSIBLE SPACES
NOT DISPLAYING DISTINGUISHABLE
PLACARDS OR SPECIAL LICENSE
PLATES ISSUED FOR PERSONS WITH
DISABILITIES WILL BE TOWED AWAY
AT THE OWNER'S EXPENSE

TOWED VEHICLES MAY BE
RECLAIMED AT
OAKLEY POLICE DEPARTMENT
OR BY TELEPHONING
(925) 625-8060

ADD INFO

(E) SIGNAGE TO REMAIN. ADD
INFORMATION ON POLICE
DEPARTMENT AND TELEPHONE
NUMBER AS NOTED.

(E) TOW-AWAY SIGN

N. T. S.

1869.07

Freedom High School

Building M = 9,942 SF = 2,750 GPM required
* Buildings are equipped with automatic sprinklers in accordance with CBC 903 and
are allow a 50% reduction in flow
Actual require fire flow
Building : 1,375 GPM minimum 1,500 per DSA PL-09-01



Fire Flow provided
Static Pressure (SP): 62psi
Residual Pressure (RP): 37 psi
Predicted flow (PW) 20psi
Flow: 843

SP-PF: 62-20 = 42
SP-RP: 62-37 = 25
42/25 = 1.68
1.68 x 54 = 1.38
1.38 x 843 (flow) = 1,164 GPM Adjusted per hydrant (2) hydrants within 150' of new
building

CODE COMPLIANCE SUMMARY Based on 2019 California Building Code (CBC)

BUILDING ID	AUX. GYM	COMPLIES	ATTACHED CLASSROOM	COMPLIES	REMARKS
Scope	New Gym Building		New Classroom		
OCCUPANCY GROUP - Sec 303	A-4		F		
CONSTRUCTION TYPE - Sec 601	VB		VB		NO PROTECTION OF STRUCTURAL ELEMENTS
AUTOMATIC FIRE SUPPRESSION SYSTEM	YES		YES		
ALLOWABLE BUILDING HT - Table 504.3	40'		60'		
ACTUAL BUILDING HT	32'	OK	19'	OK	
ALLOWABLE NUMBER OF STORIES - Table 504.4	1		2		
ACTUAL STORIES	1	OK	1	OK	
ALLOWABLE AREA FACTOR (SF) A - Table 506.2	24,000		38,000		
ALLOWABLE AREA W/ FRONTAGE INCREASE - Sec 506.3.3	N/A	(Not Needed)	N/A	(Not Needed)	
ACTUAL AREA*	9,942 S.F.	OK	2,630 S.F.		
COMMON PATH OF EGRESS TRAVEL - Sec 1006	75'	OK	75'	OK	4 EXITS PROVIDED AT 100' FULLY SPRINKLED; THE ORIGINAL INTENT AT ALL LOCATIONS WHERE THE OCCUPANT LOAD EXCEEDS 40 PER 1007.1.1.
EXIT ACCESS TRAVEL DISTANCE - Table 1017.2	250'	OK	250'	OK	
FIRE RESISTANCE RATING FOR BUILDING ELEMENTS - Table	0-Hour	OK	0-Hour	OK	
FIRE RESISTANCE RATING FOR EXTERIOR WALLS BASED ON FIRE SEPARATION DISTANCE - Table 602	10-x<30 = 0 HR X<30 = 0 HR	OK	10-x<30 = 0 HR X<30 = 0 HR	OK	
ALLOWABLE AREAS FOR OPENINGS - Table 705.8	UP 45%	OK	UP 45%	OK	
*MIXED USE RATIO CALCULATION CBC Section 508.4 (9942/24000) + ((2630/38000) = .41+.06 = .47<1.0 COMPLIES					

STORAGE IS UNDER 10% OF TOTAL SQUARE FOOTAGE AND DOESNT NEED REQUIRE SEPARATION FROM OTHER SPACES

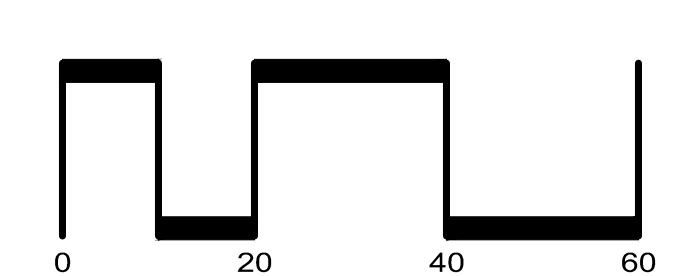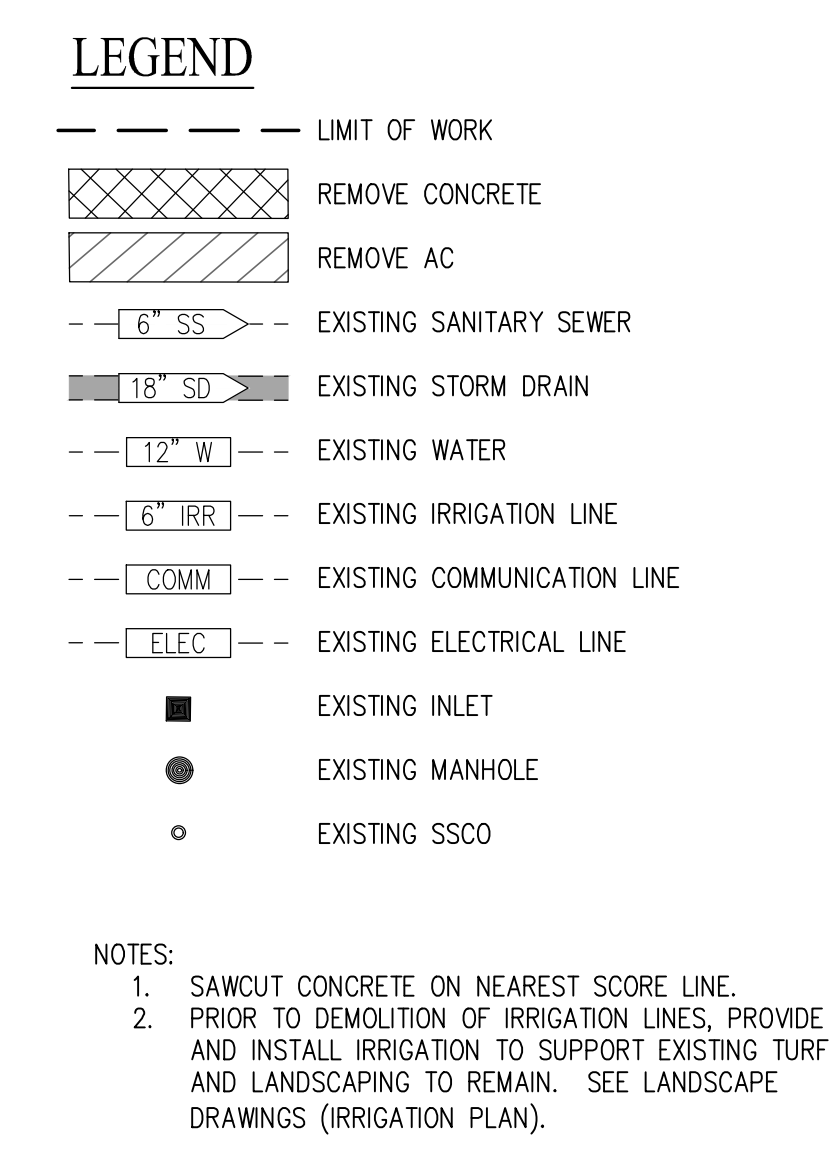

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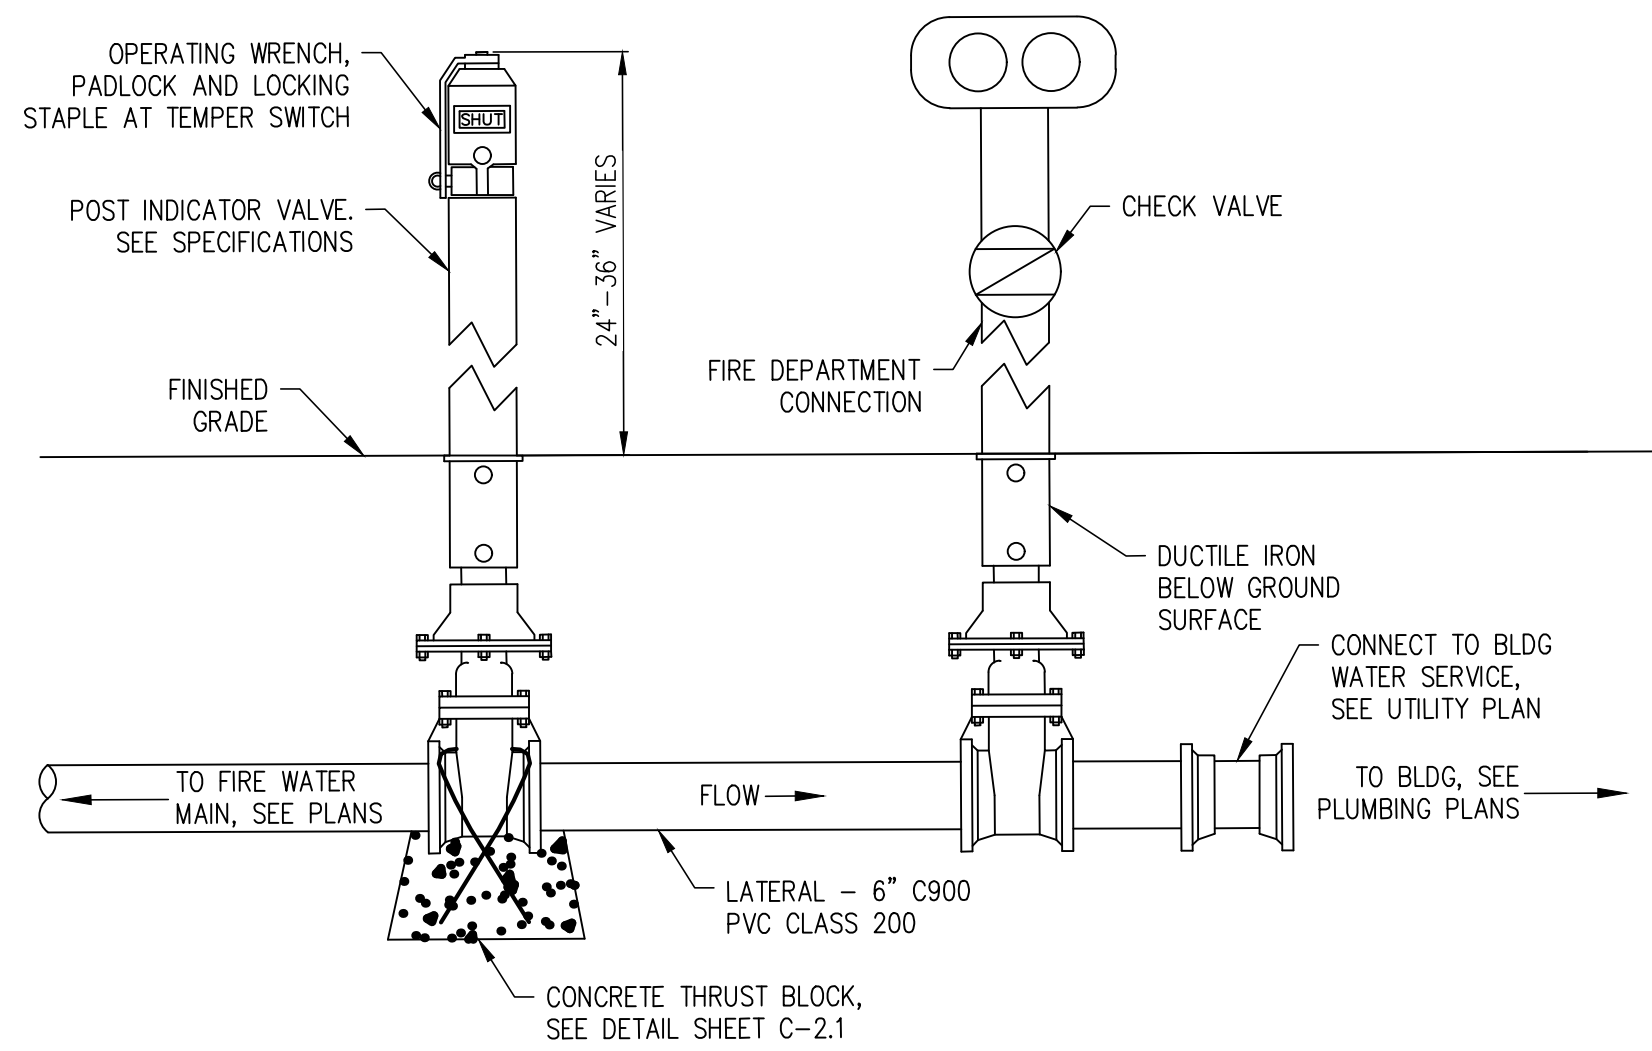
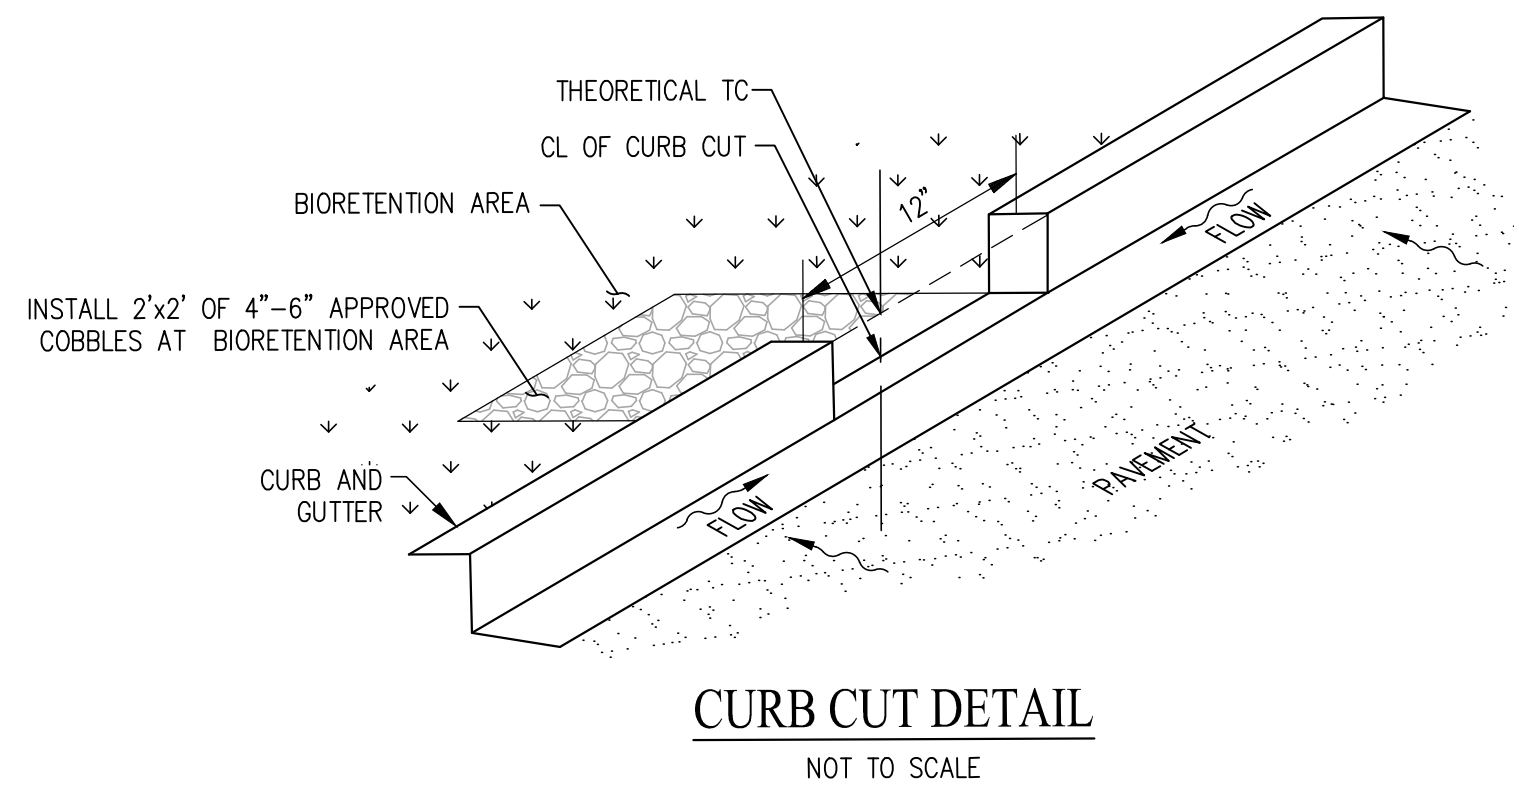
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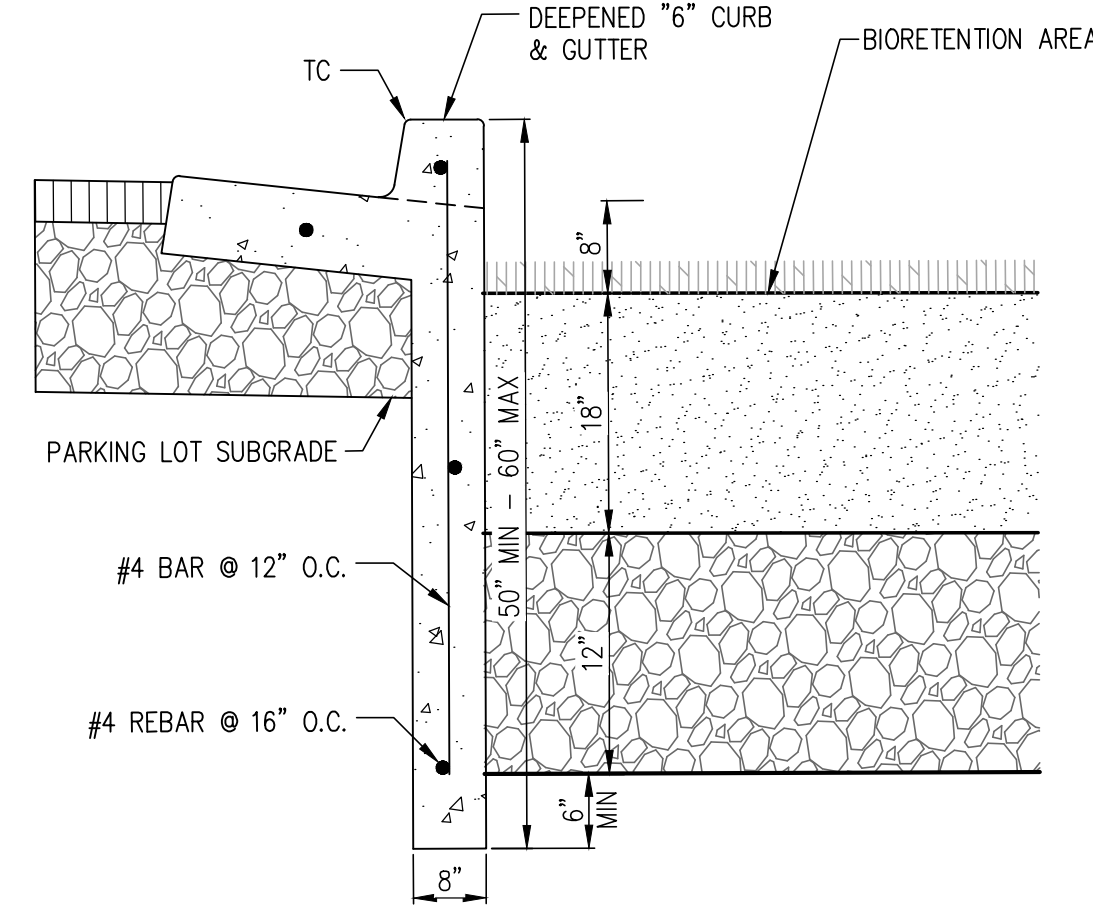
**EXISTING
CONDITIONS /
DEMOLITION**

SHEET NUMBER


C-1.0




POST INDICATOR VALVE & FIRE DEPARTMENT CONNECTION
NOT TO SCALE




6" DEEPENED CURB & GUTTER
NOT TO SCALE

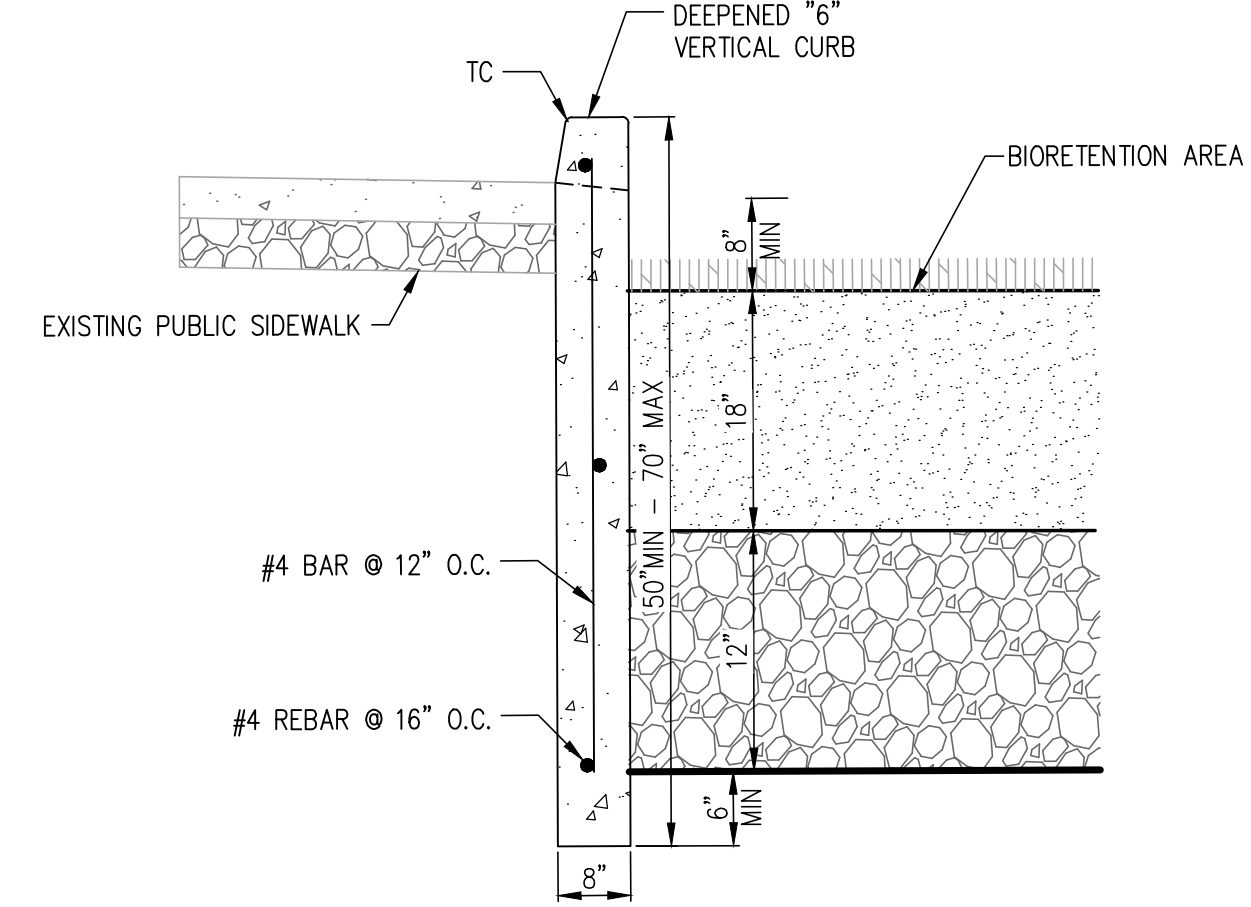


6" DEEPENED VERTICAL CURB
NOT TO SCALE

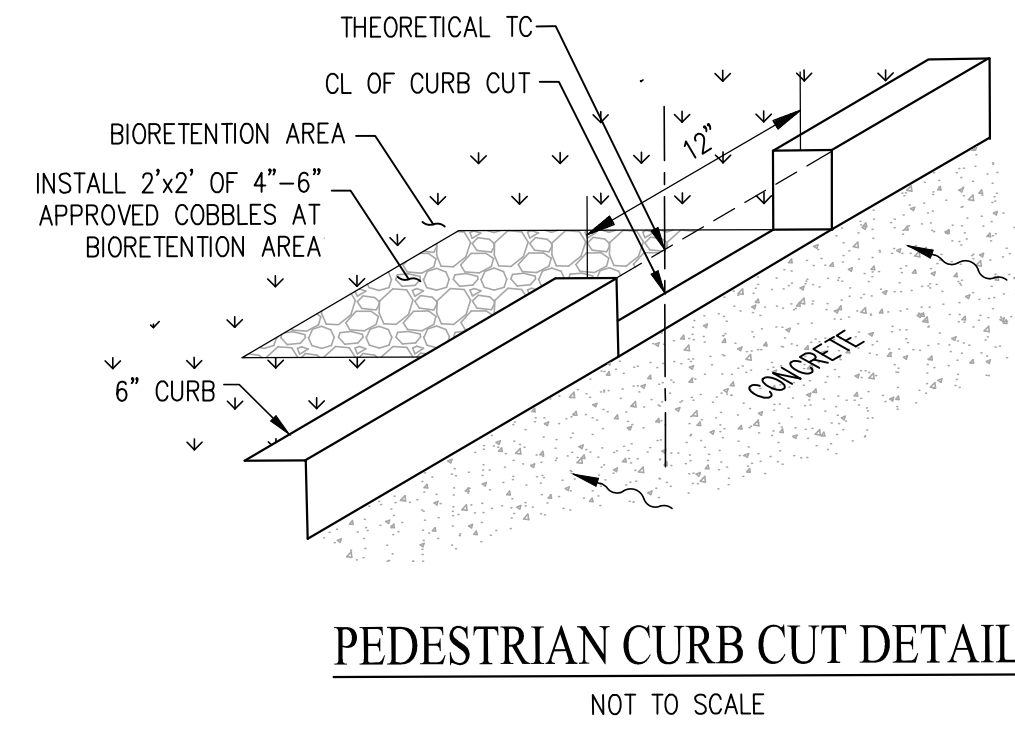



PEDESTRIAN CURB CUT DETAIL
NOT TO SCALE

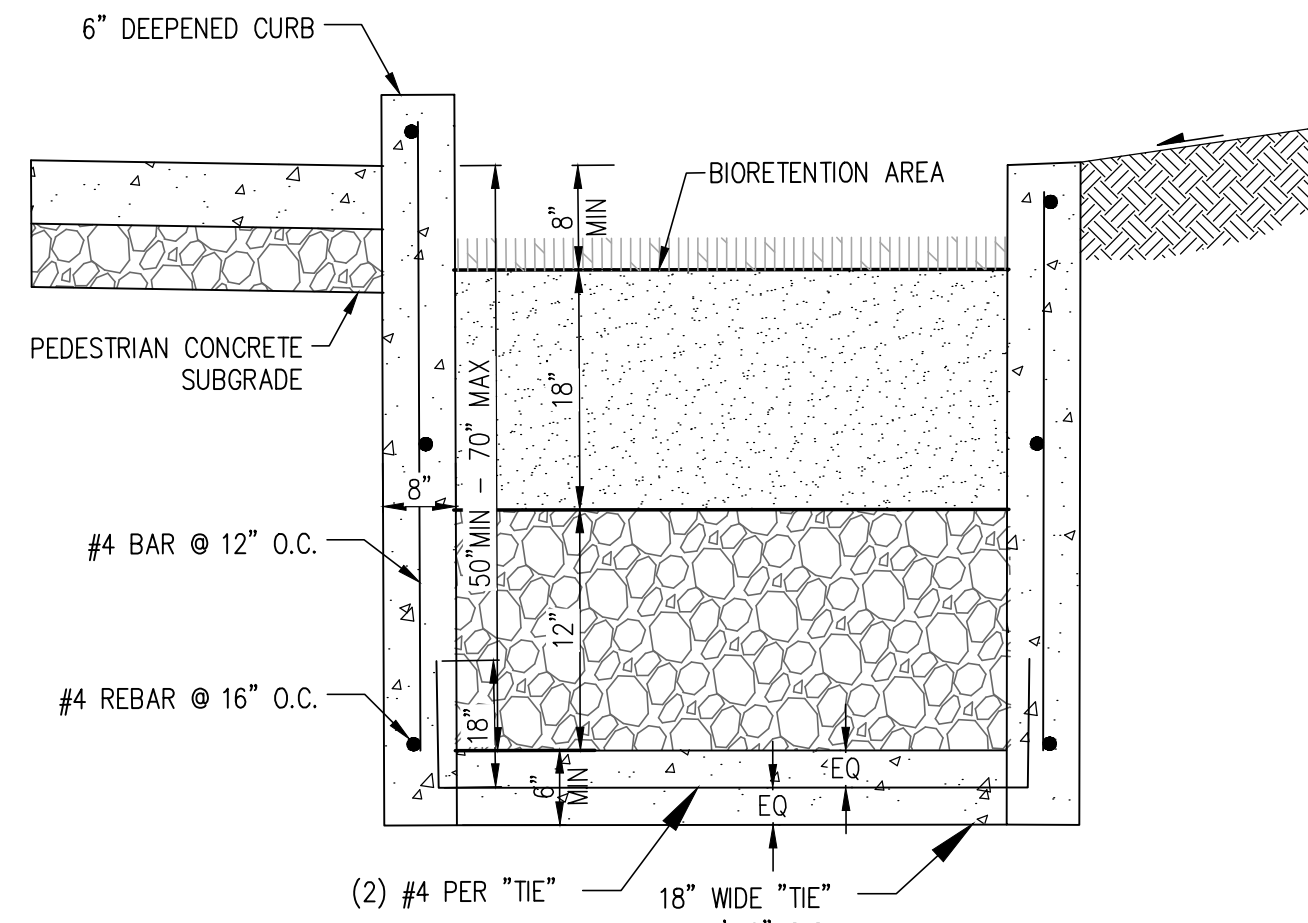


DEEPENED VERTICAL CURB WITH TIE
NOT TO SCALE

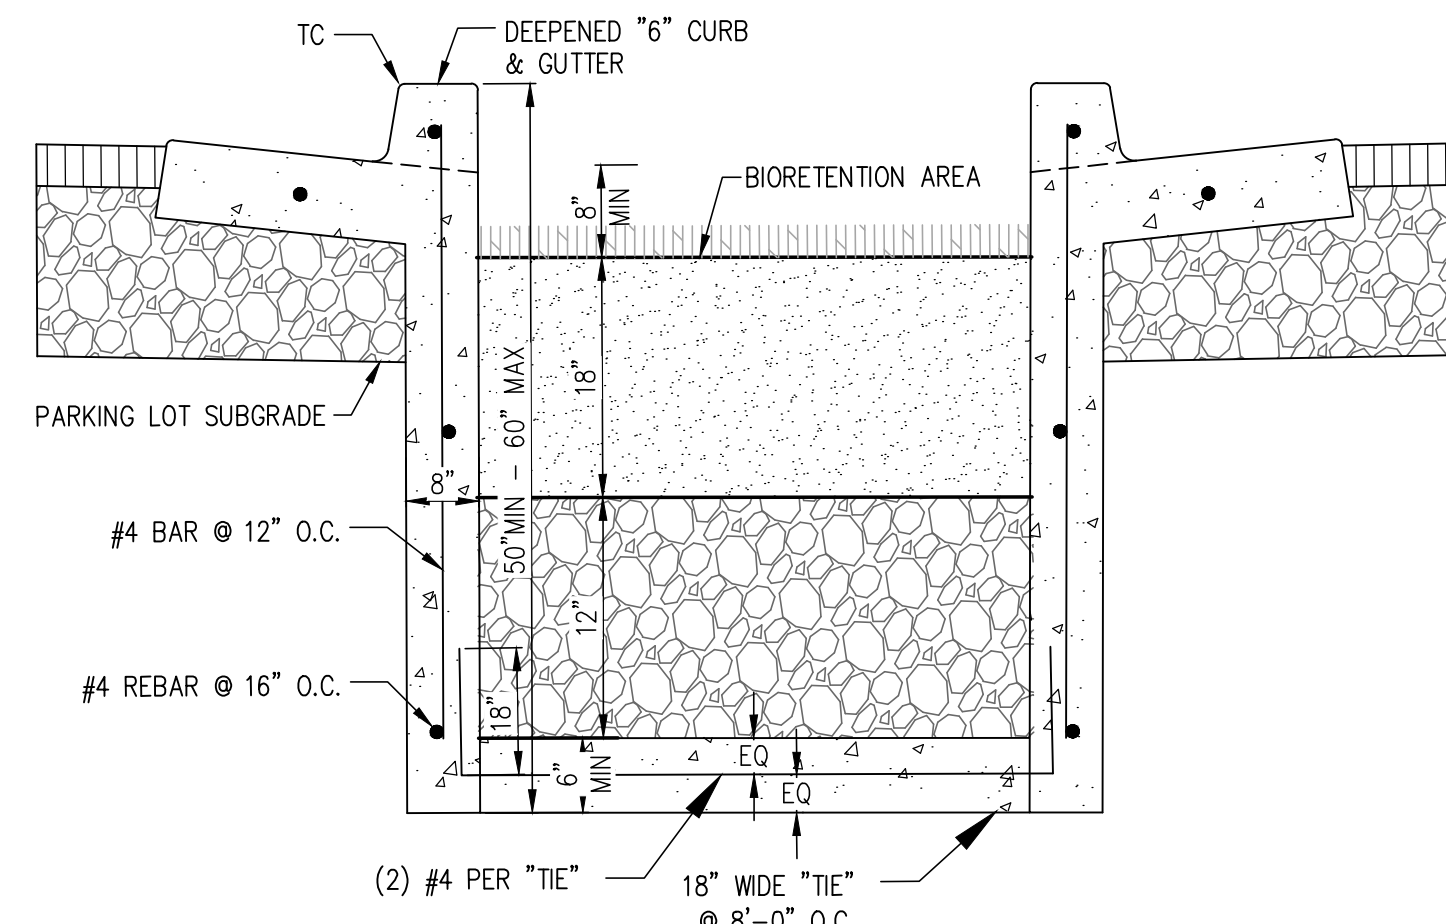


6" DEEPENED CURB & GUTTER WITH TIE
NOT TO SCALE

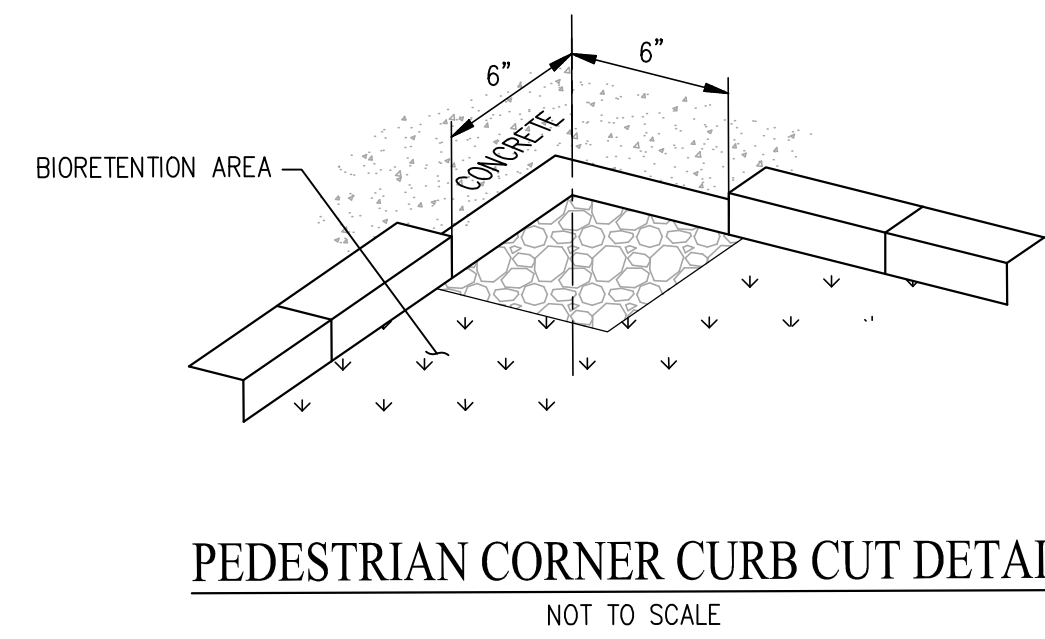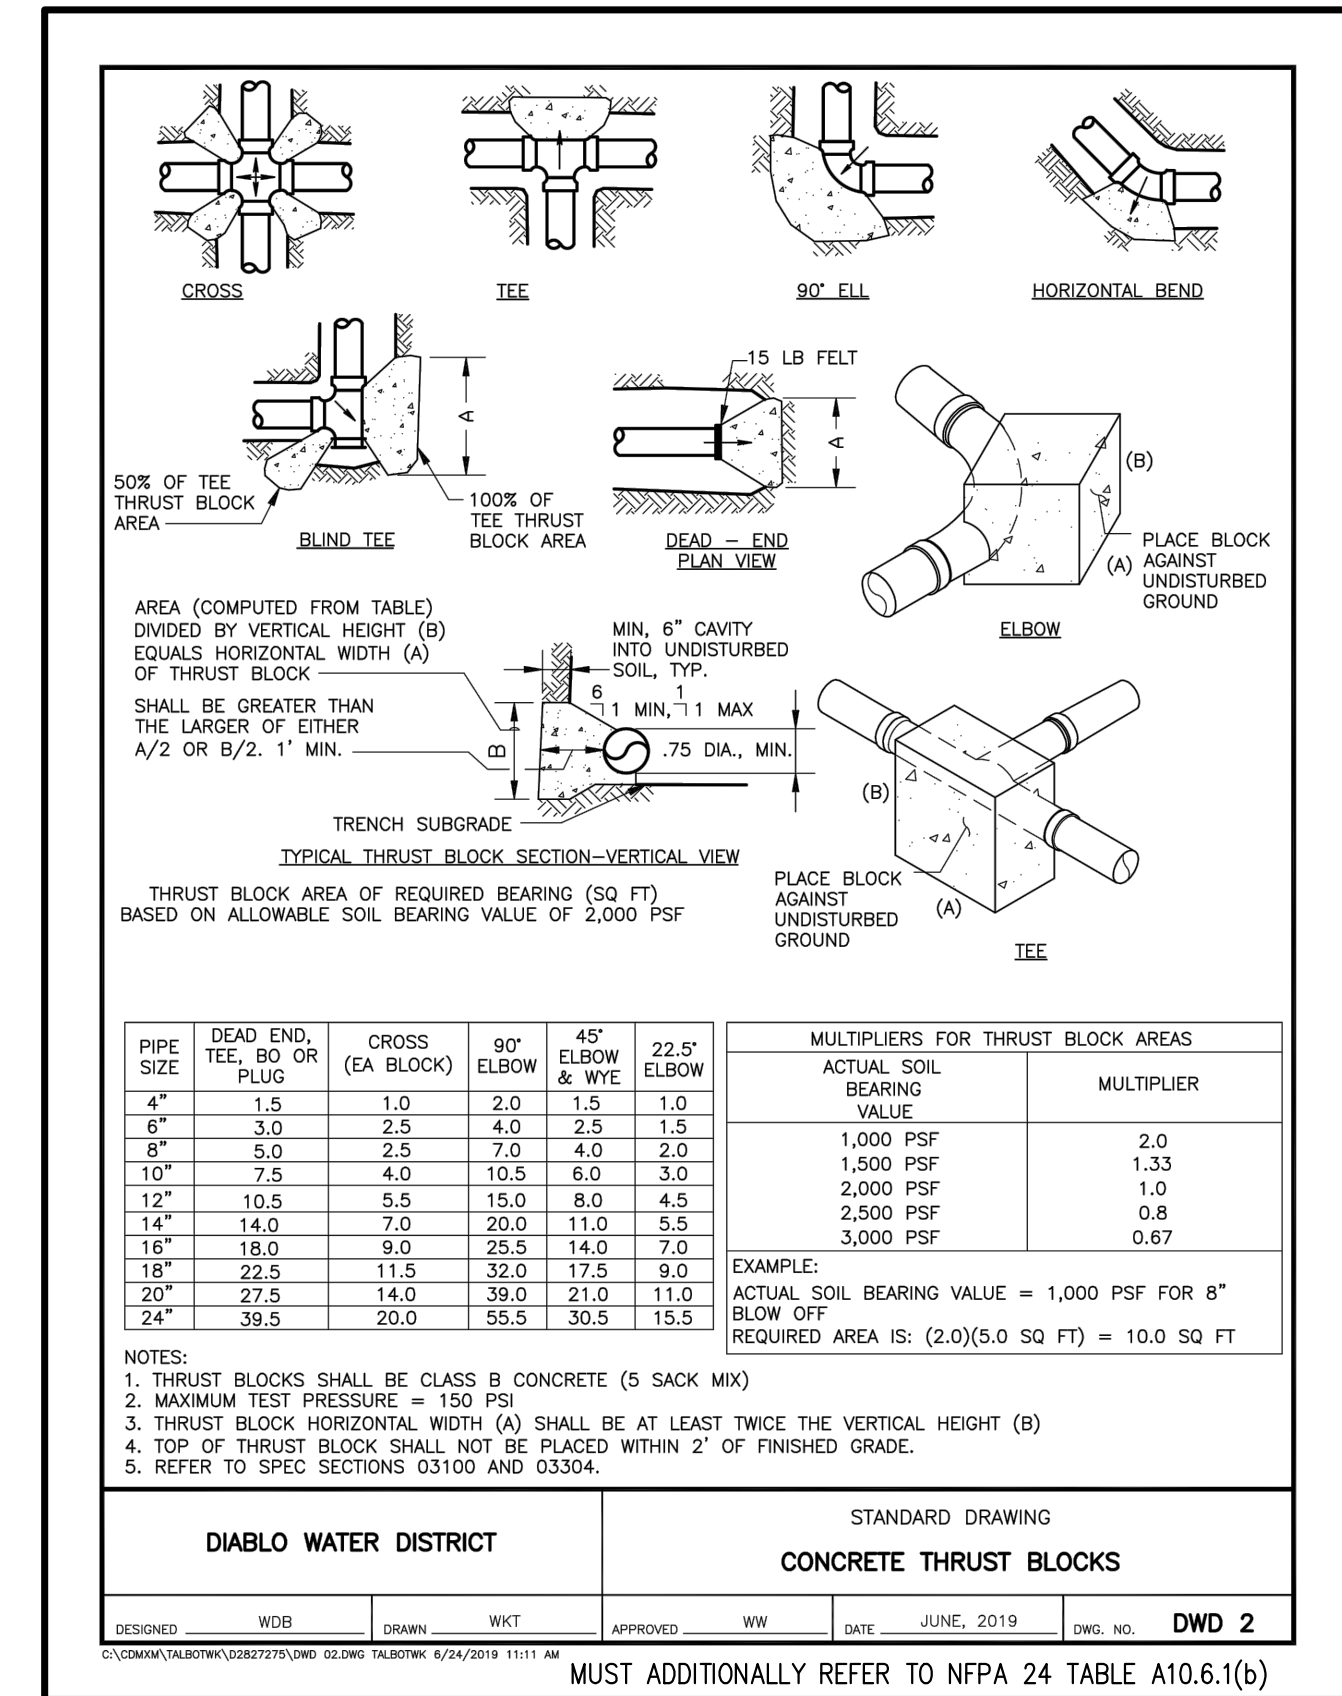


PEDESTRIAN CORNER CURB CUT DETAIL
NOT TO SCALE

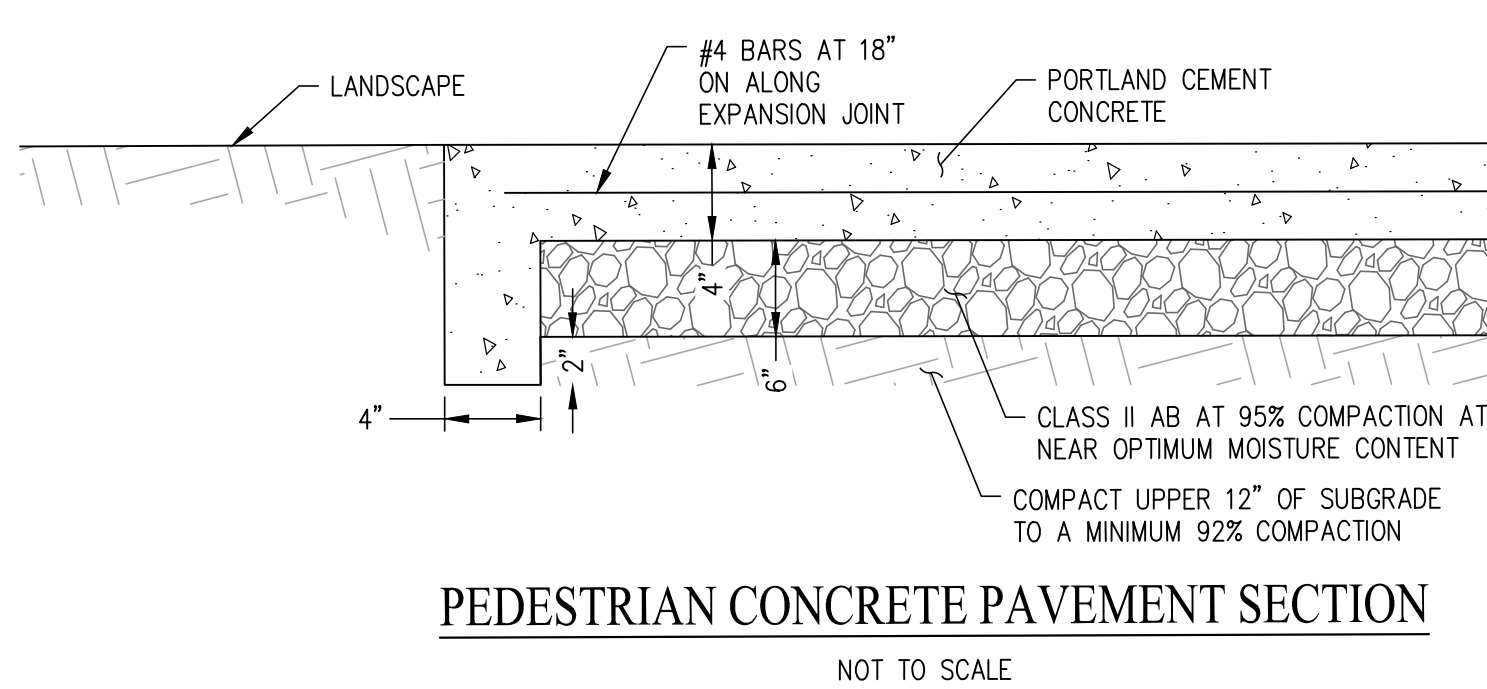


PEDESTRIAN CONCRETE PAVEMENT SECTION
NOT TO SCALE

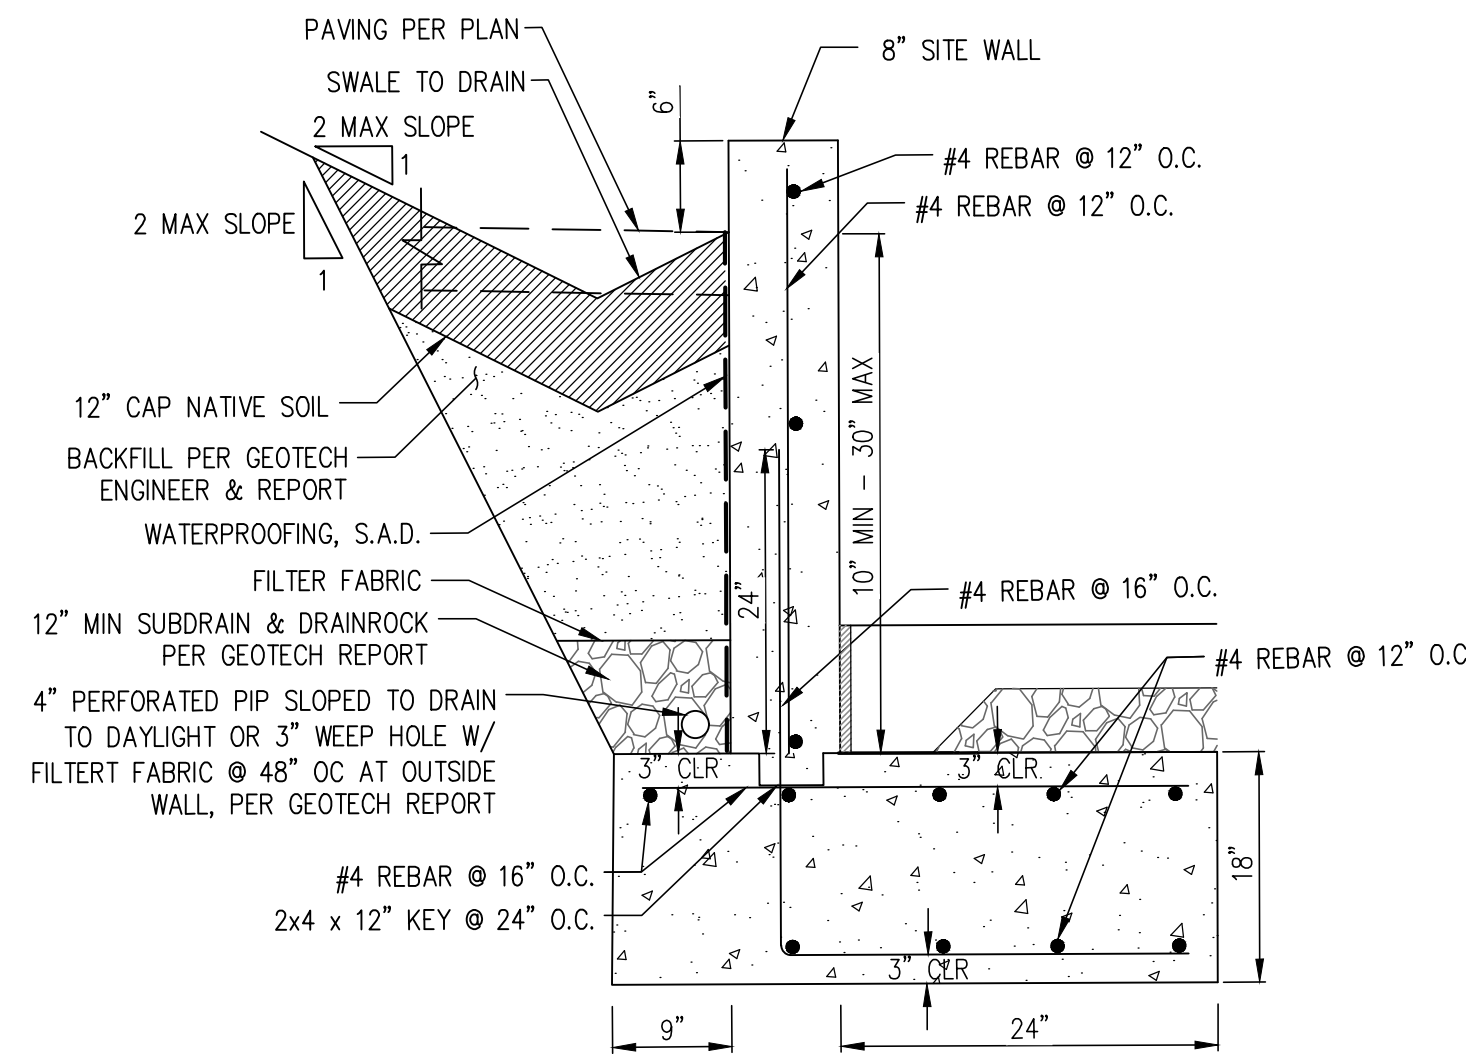

8" SITE WALL WITH FOOTING
NOT TO SCALE

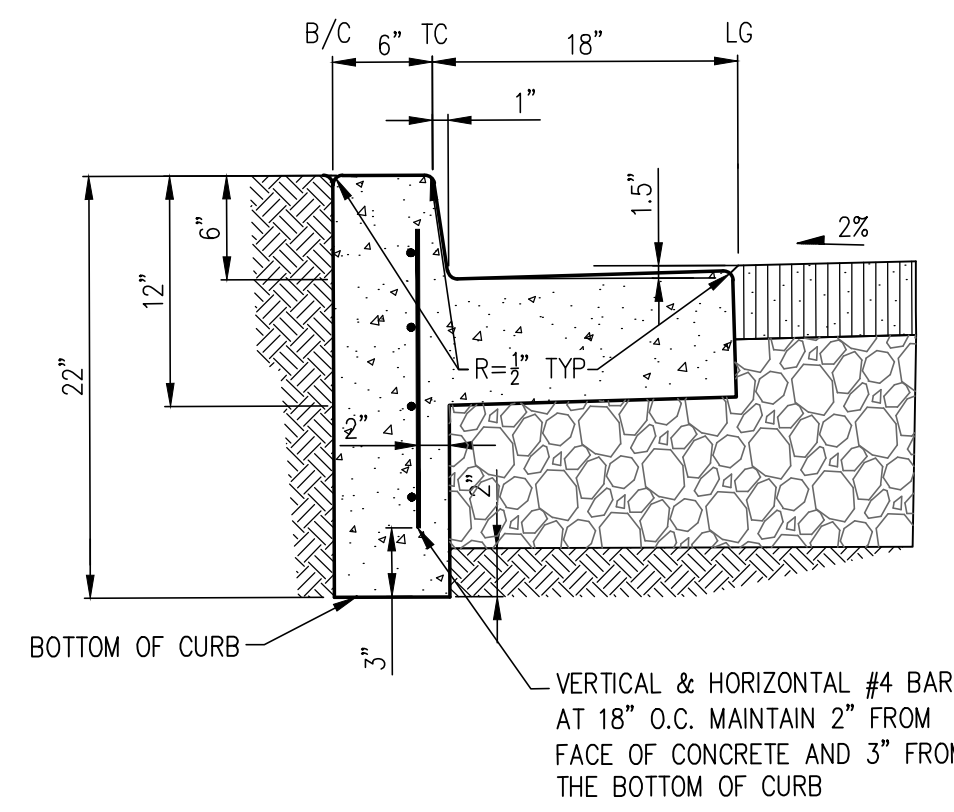


6" VERTICAL CURB AND GUTTER DETAIL
NOT TO SCALE

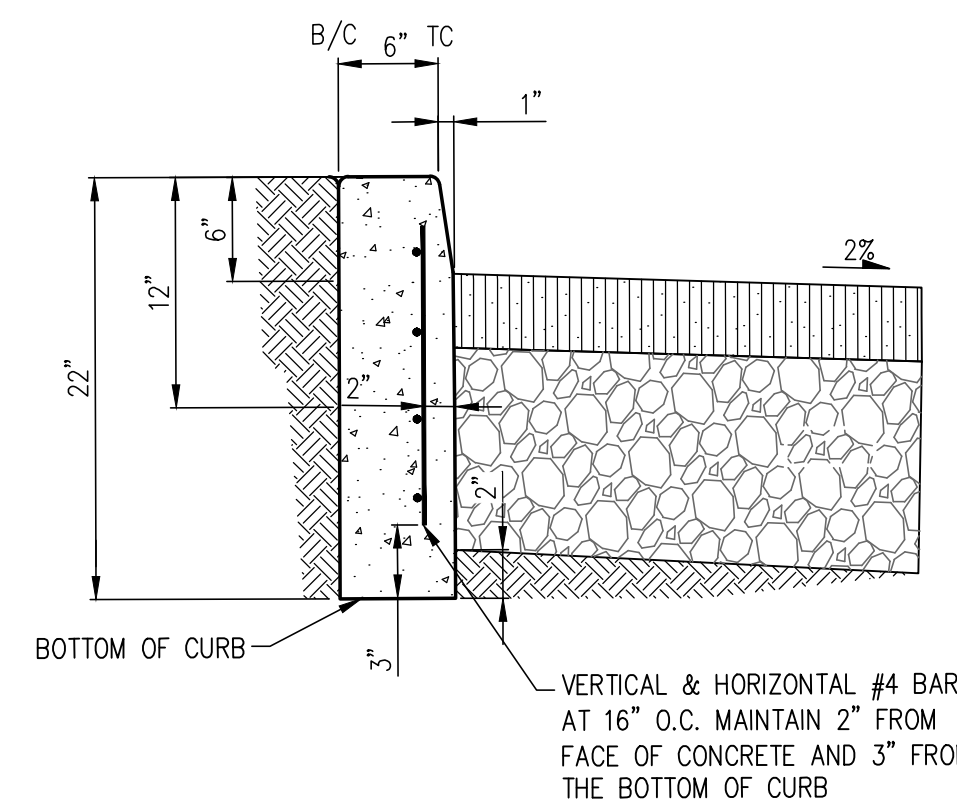





6" VERTICAL CURB DETAIL
NOT TO SCALE

STORM DRAIN PIPE SCHEDULE		STORM DRAIN STRUCTURE SCHEDULE		SANITARY SEWER PIPE SCHEDULE		SANITARY SEWER STRUCTURE SCHEDULE		WATER PIPE SCHEDULE		WATER STRUCTURE SCHEDULE	
STRUCTURE	DESCRIPTION	STRUCTURE	DESCRIPTION	STRUCTURE	DESCRIPTION	STRUCTURE	DESCRIPTION	STRUCTURE	DESCRIPTION	STRUCTURE	DESCRIPTION
4" PERFORATED PIPE	264 LF PVC	BUBBLE UP (2 TOTAL)	NDS POP-UP DRAINAGE EMITTER	4" PIPE	299 LF, PVC SDR 35	SSCO (3 TOTAL)	PER CITY OF BRENTWOOD STANDARD SS-1	2" PIPE	295 LF PVC	GATE VALVE (1 TOTAL)	6" MUELLER GATE VALVE #A-2360
12" PIPE	79 LF HDPE	FIELD INLET (4 TOTAL)	OLDCASTLE PRECAST CB1818					6" PIPE	166 LF PVC	PVI (1 TOTAL)	MUELLER A-20801 PER CITY OF BRENTWOOD STANDARDS W-4
15" PIPE	55 LF HDPE									FIRE DEPT. CONNECTION (1 TOTAL)	CROKER 6545 4-WAY FDC


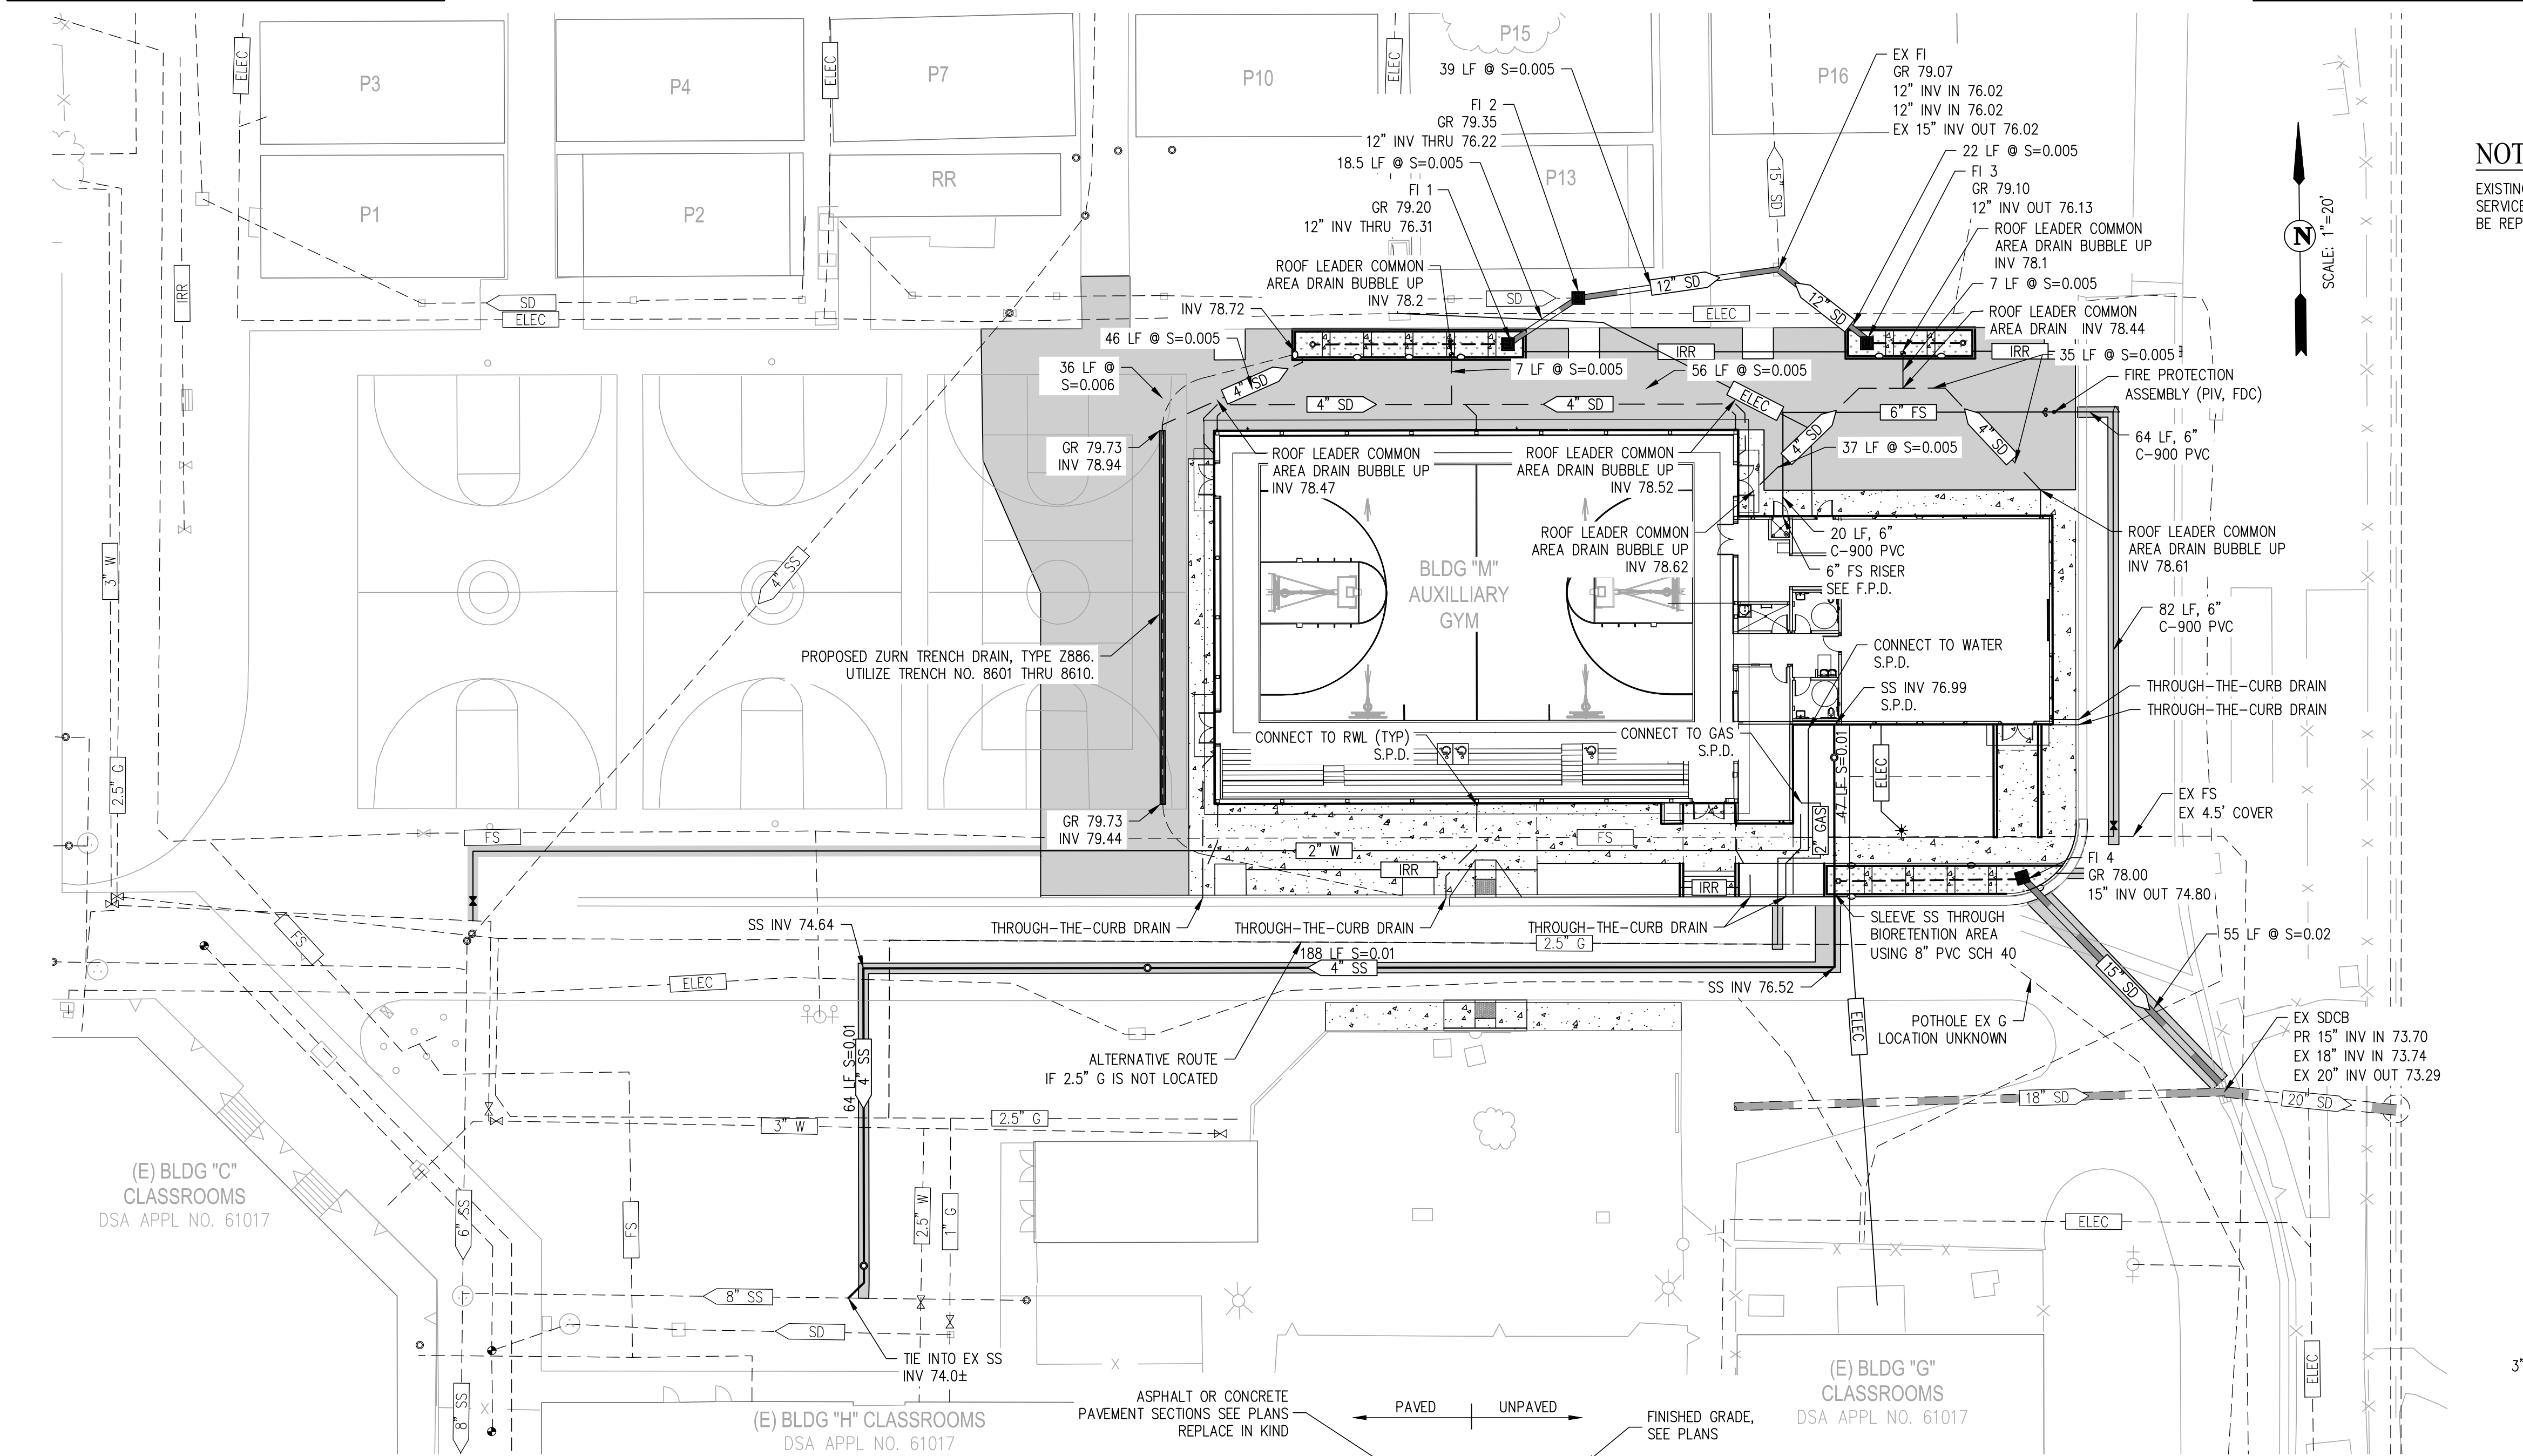


- LEGEND**
- AC PAVEMENT
 - CONCRETE SIDEWALK/GUTTER
 - BIO-RETENTION AREA
 - PROPOSED STORM DRAIN
 - PROPOSED PERFORATED STORM DRAIN
 - PROPOSED SEWER LATERAL
 - PROPOSED WATER LATERAL
 - PROPOSED FIRE SERVICE
 - IRRIGATION SLEEVE - SEE LANDSCAPE PLANS
 - RAIN WATER LEADER / COMMON AREA DRAIN
 - PROPOSED TRUST BLOCK - SEE SHEET C-2.1
 - PIV
 - FDC
 - PROPOSED MANHOLE
 - PROPOSED CATCH BASIN
 - BUBBLE UP (SEE DETAIL ON SHEET C-4.0)
 - PROPOSED SD OR SS CLEANOUT
 - PROPOSED CURB CUT
 - PROPOSED STREET LIGHT, SEE ELECTRICAL PLANS
 - EXISTING SEWER
 - EXISTING STORM DRAIN
 - EXISTING WATER
 - EXISTING IRRIGATION
 - EXISTING FIELD INLET
 - EXISTING MANHOLE

NOTE
EXISTING IRRIGATION TO REMAIN IN SERVICE. ALL DAMAGED TURF TO BE REPLACED WITH SOD

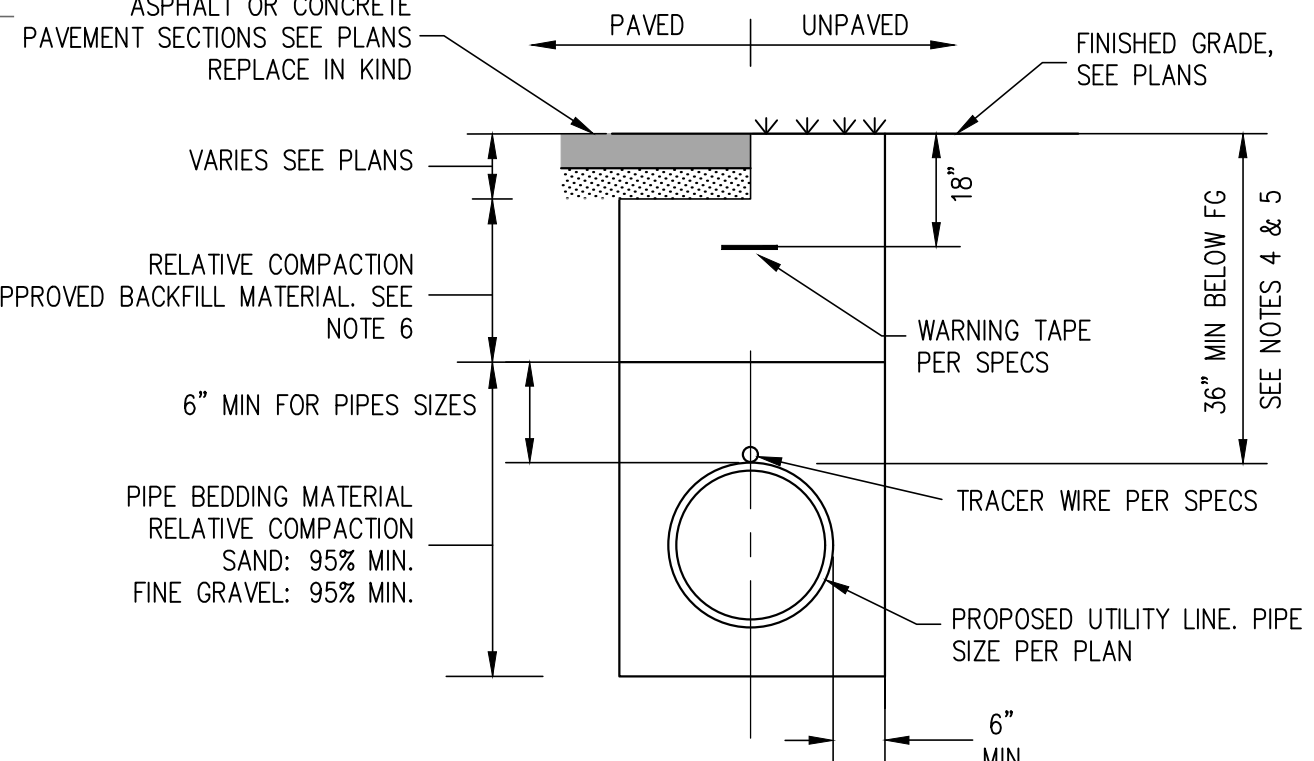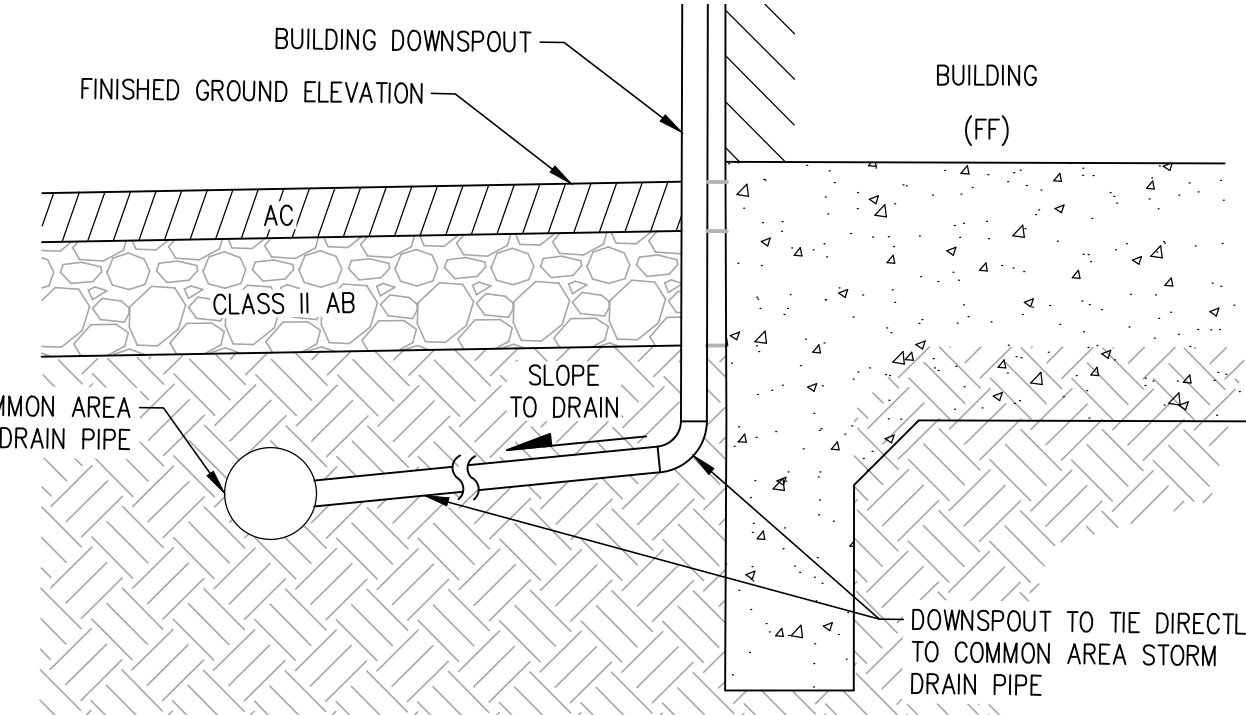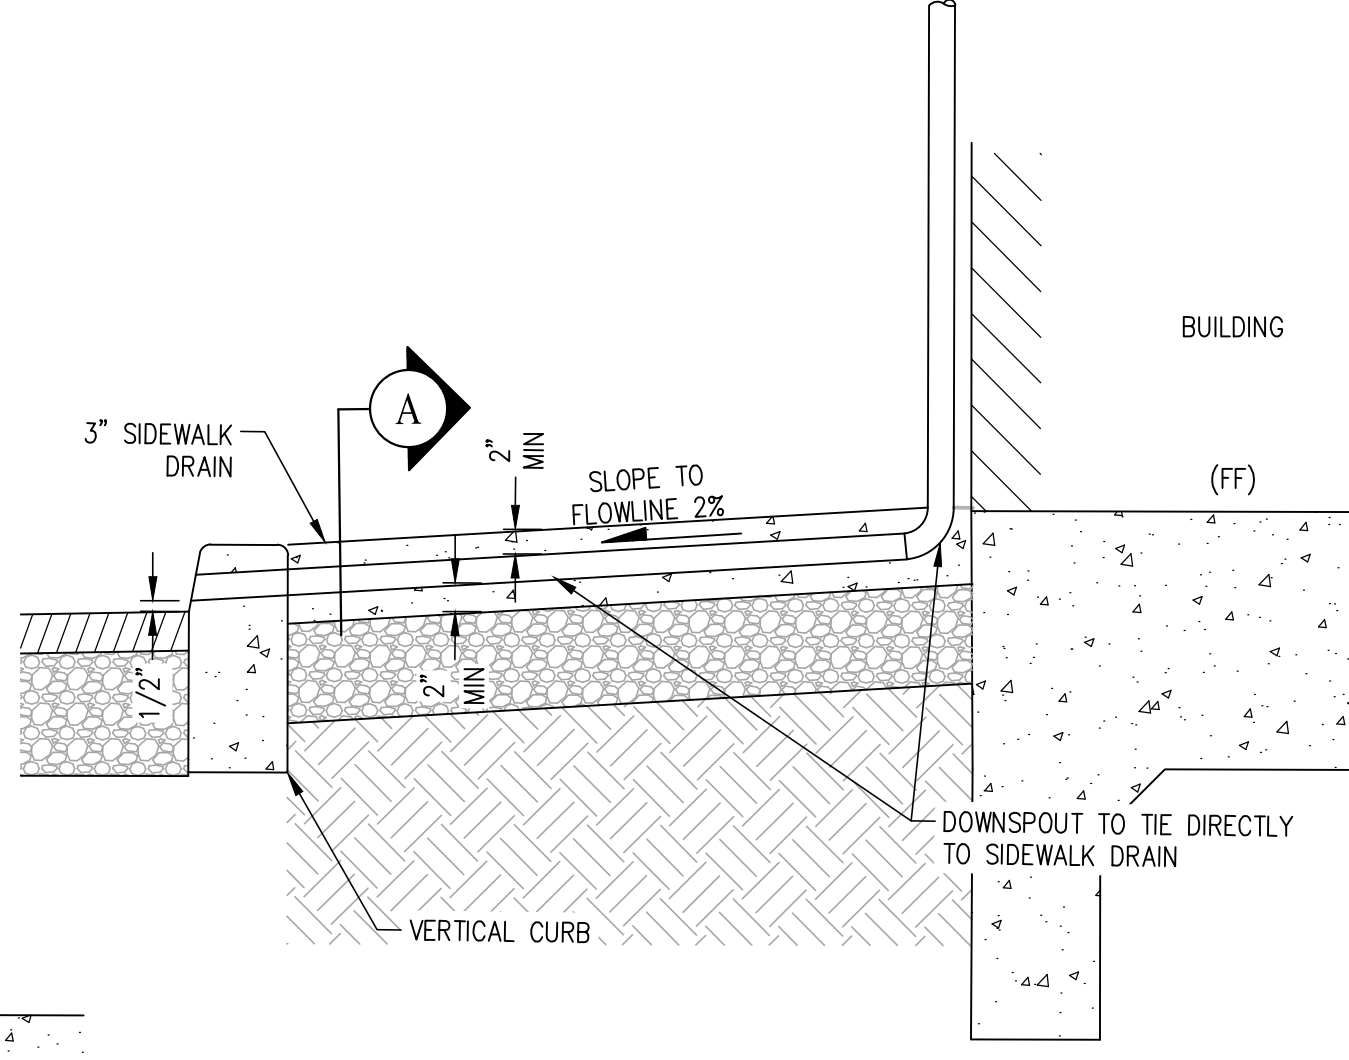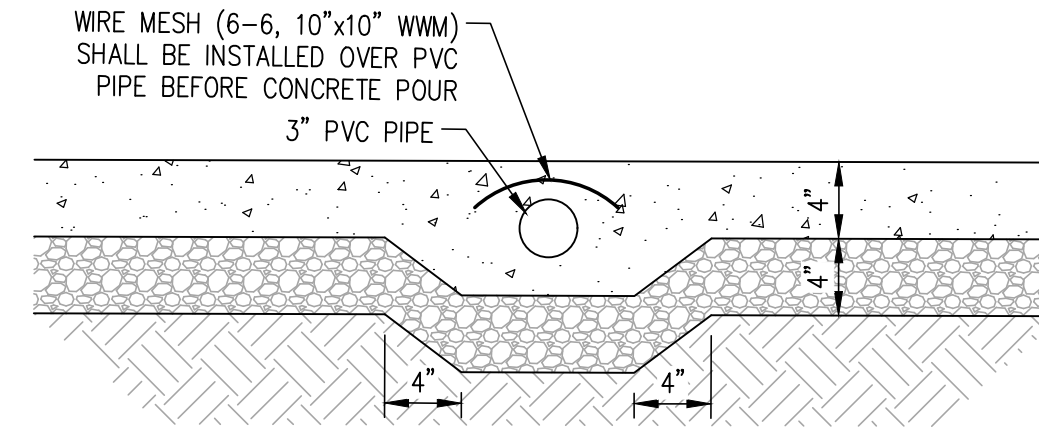

- NOTES:**
- BEDDING SHOULD EXTEND A MINIMUM D/4 (D=OUTSIDE PIPE DIAMETER) BELOW BOTTOM OF PIPE.
 - SEE PROJECT SPECIFICATIONS FOR FURTHER UTILITY TRENCH REQUIREMENTS.
 - WHERE TRENCHES EXCEED 5' DEEP, CONTRACTOR TO CONFORM TO CURRENT OSHA REQUIREMENTS FOR SHORING, SLOPING, AND WORKING SAFELY.
 - COVER FOR PAVED AREAS IS DEFINED FROM TOP OF PIPE TO BOTTOM OF AGGREGATE BASE.
 - COVER FOR UNPAVED AREAS IS DEFINED FROM TOP OF PIPE TO TOP OF FINISHED SURFACE.
 - THE RELATIVE COMPACTION FOR APPROVED NATIVE MATERIAL, IMPORTED FILL, AND CALTRANS CLASS II AGGREGATE BASE SHALL BE AS FOLLOW:
PAVED AREAS: 95% MINIMUM
NON-PAVED AREAS: 90% MINIMUM

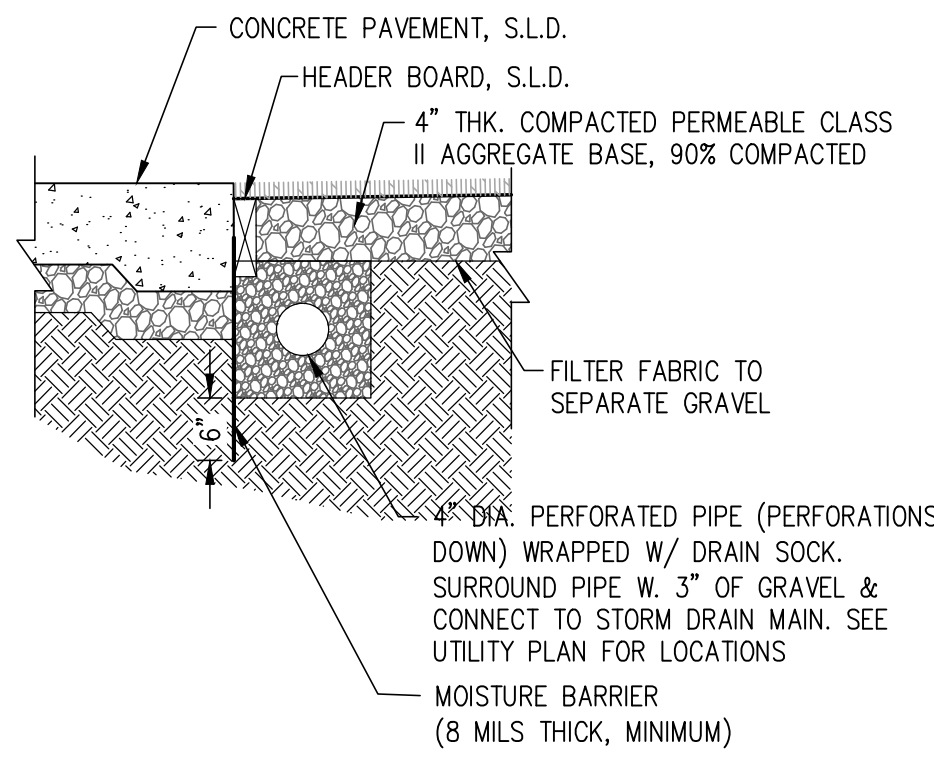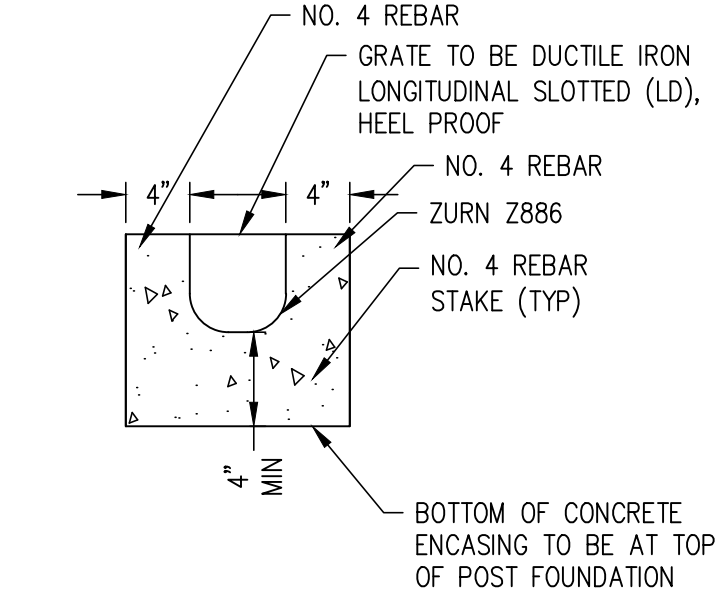

QUATTROCCHI KWOK ARCHITECTS
Main:
636 Fifth Street, Santa Rosa, CA 95404
East Bay:
55 Harrison Street, Suite 525,
Oakland, CA 94607
(707) 576-0829

cbg SAN RAMON (925) 866-0322
ROSEVILLE (916) 788-4456
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LIBERTY UNION HIGH SCHOOL DISTRICT


REVISIONS	

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PTN: 61721-78 FILE NO: 7-H4

BID DOCUMENT
APRIL 27, 2021
SHEET TITLE

UTILITY PLAN


SHEET NUMBER
C-3.0

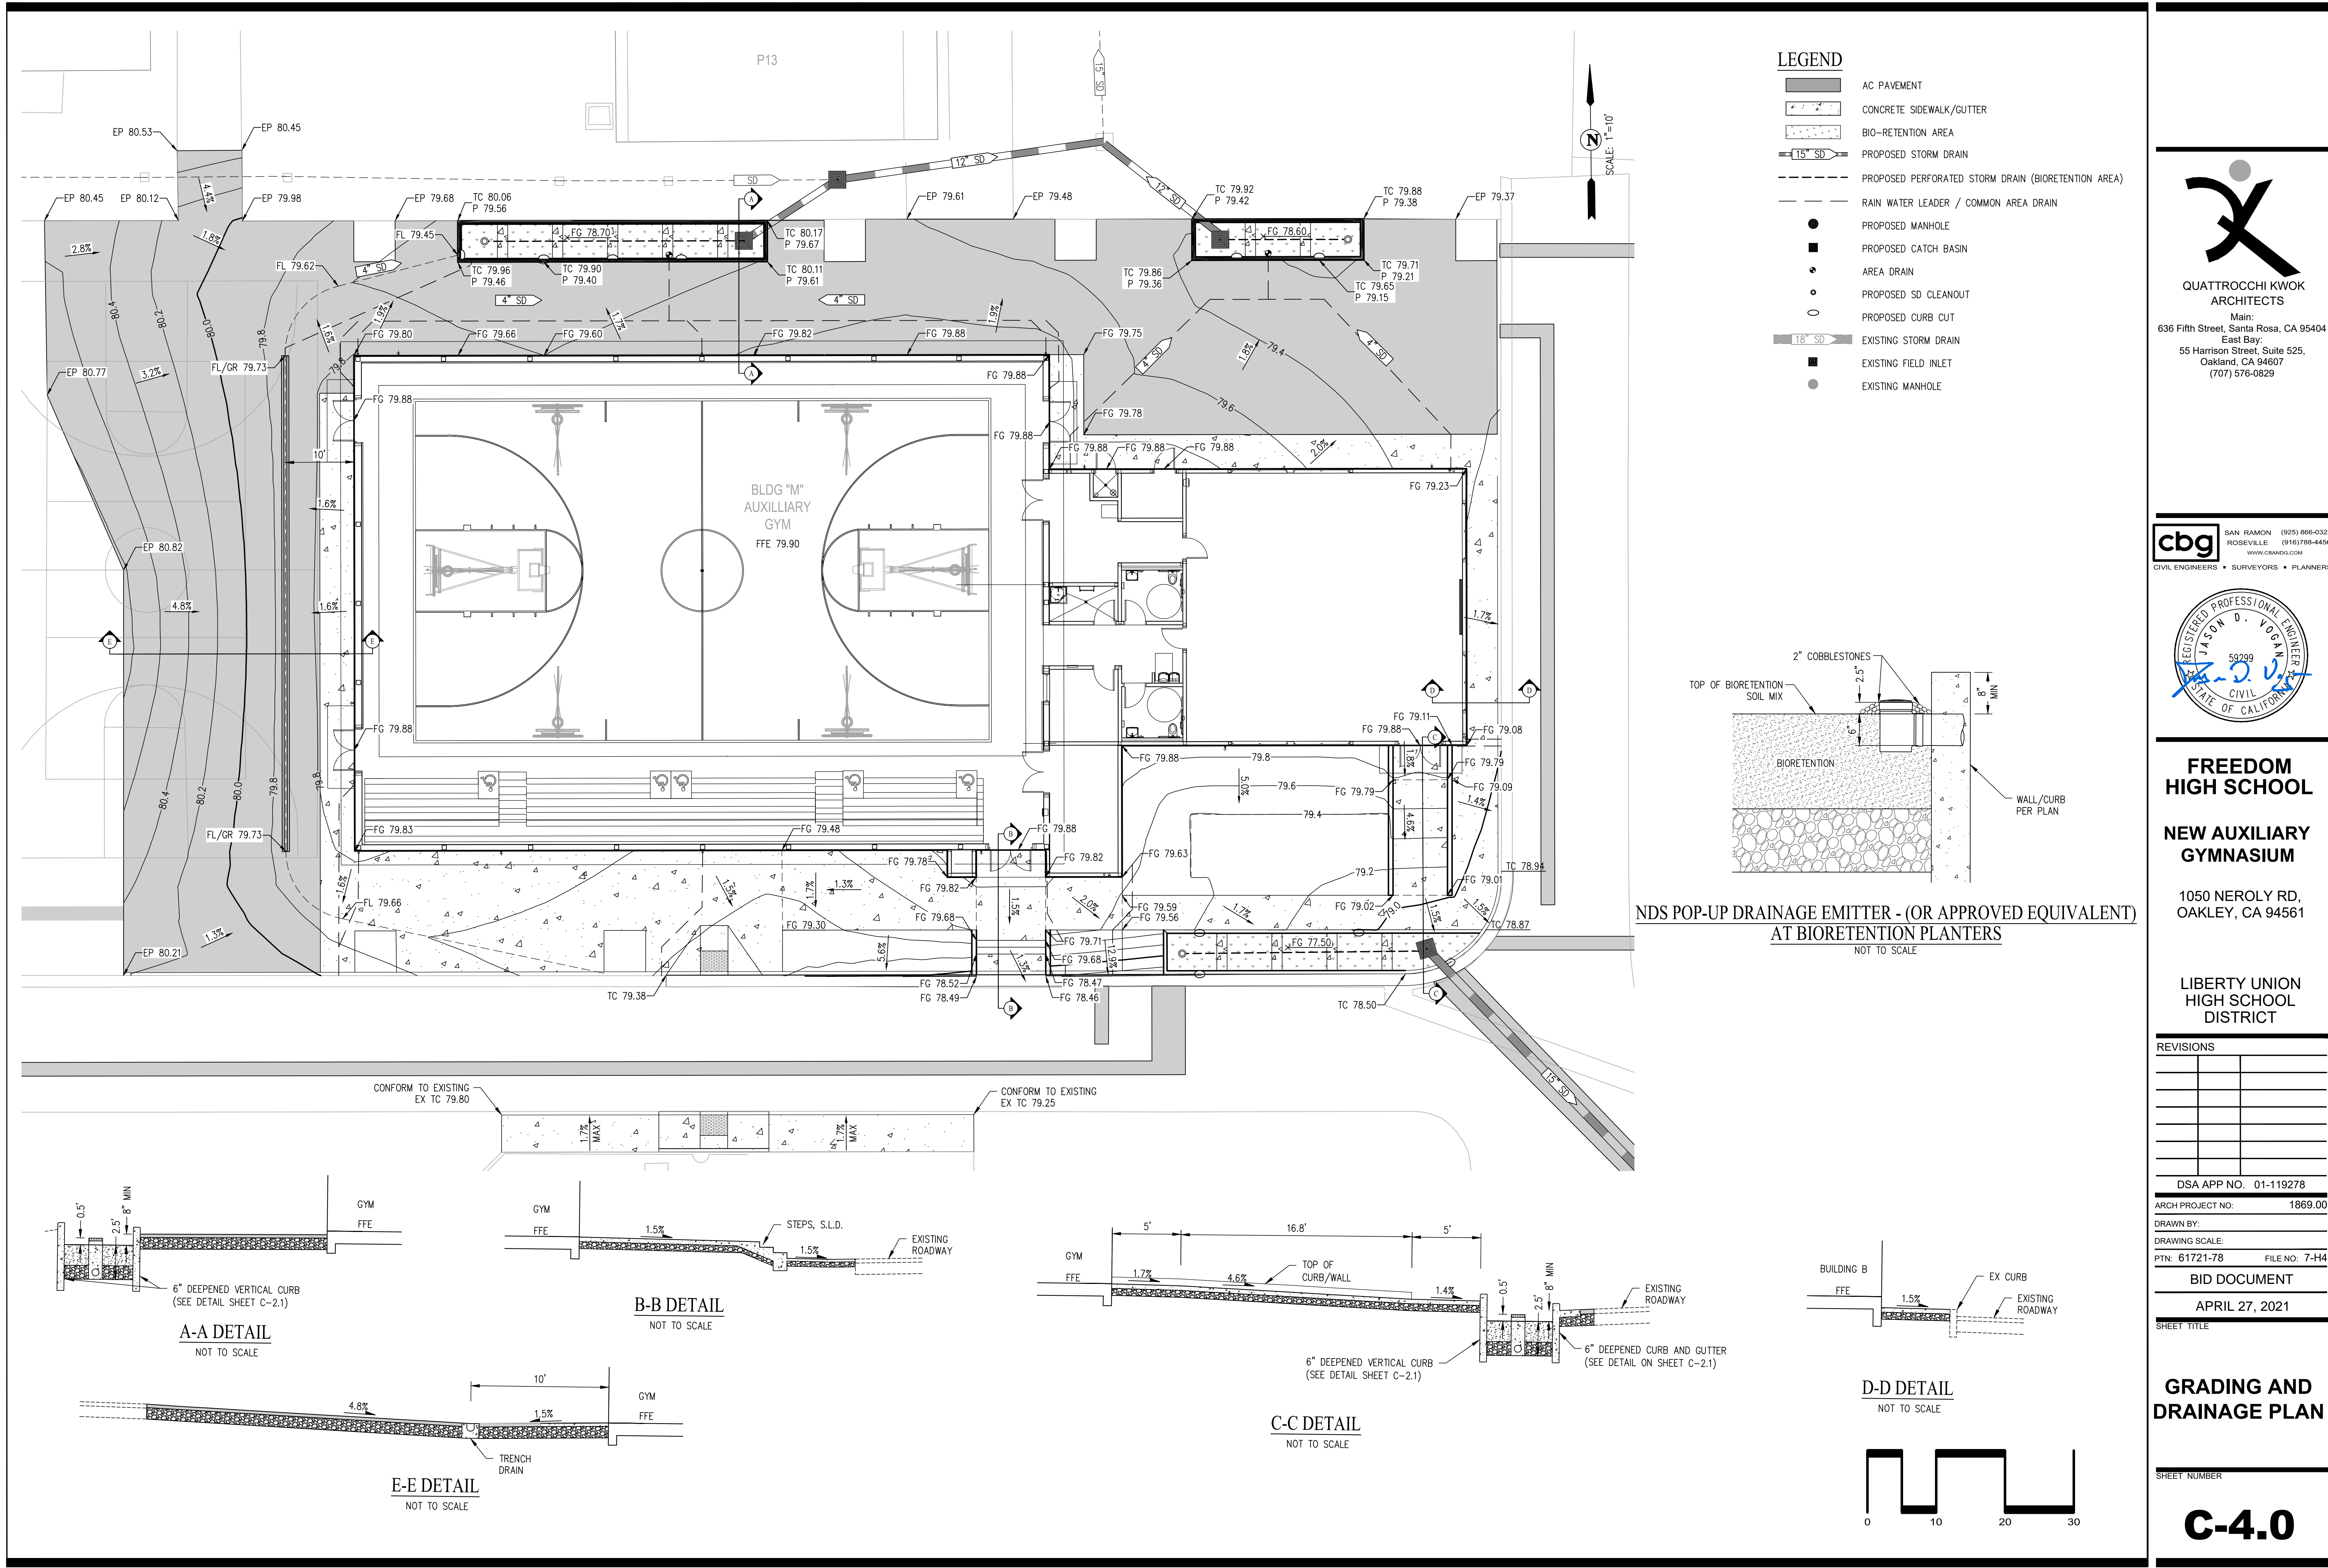



QUATTROCCHI KWOK
ARCHITECTS

Main:
636 Fifth Street, Santa Rosa, CA 95404
East Bay:
55 Harrison Street, Suite 525,
Oakland, CA 94607
(707) 576-0829



SAN RAMON (925) 866-0322
ROSEVILLE (916) 788-4456
WWW.CBG6060.COM

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FREEDOM
HIGH SCHOOL

NEW AUXILIARY
GYMNASIUM

1050 NEROLY RD,
OAKLEY, CA 94561


LIBERTY UNION
HIGH SCHOOL
DISTRICT

REVISIONS		
DSA APP NO. 01-119278		
ARCH PROJECT NO.	1869.00	
DRAWN BY:		
DRAWING SCALE:		
PTN: 61721-78	FILE NO:	7-H4

BID DOCUMENT
APRIL 27, 2021
SHEET TITLE

GRADING AND
DRAINAGE PLAN

SHEET NUMBER
C-4.0

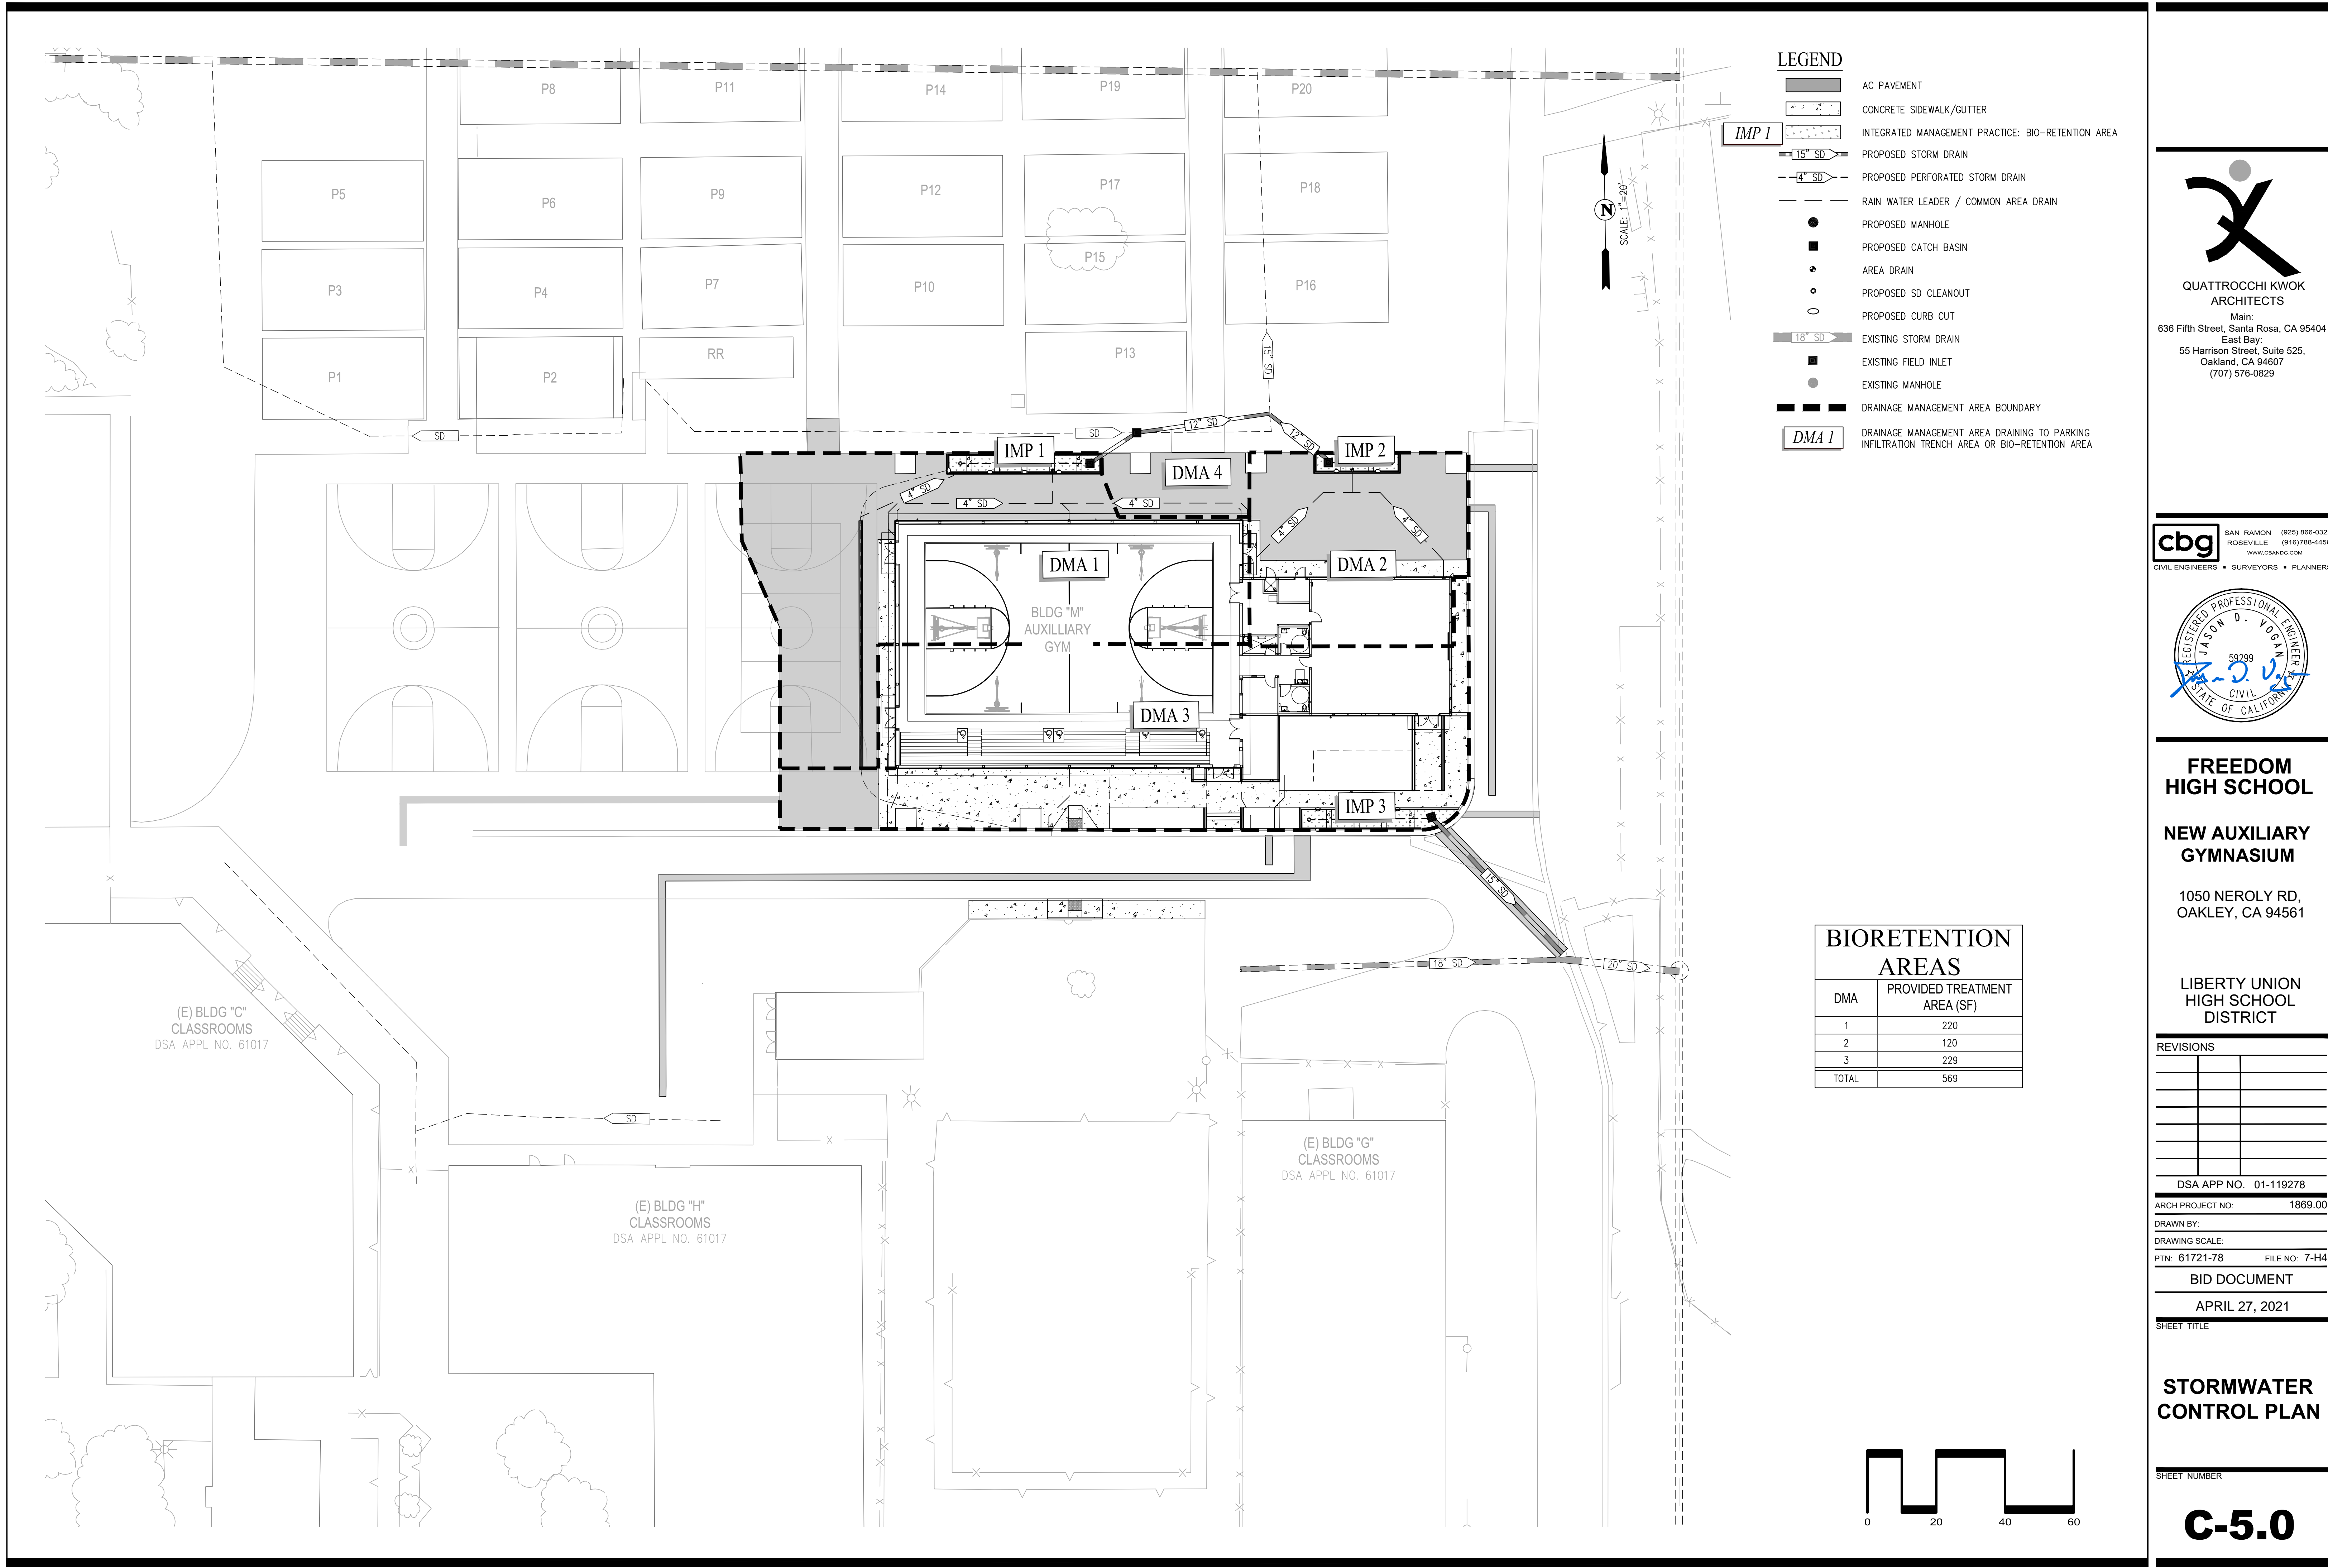

LEGEND

- AC PAVEMENT
- CONCRETE SIDEWALK/GUTTER
- INTEGRATED MANAGEMENT PRACTICE: BIO-RETENTION AREA
- PROPOSED STORM DRAIN
- PROPOSED PERFORATED STORM DRAIN
- RAIN WATER LEADER / COMMON AREA DRAIN
- PROPOSED MANHOLE
- PROPOSED CATCH BASIN
- AREA DRAIN
- PROPOSED SD CLEANOUT
- PROPOSED CURB CUT
- EXISTING STORM DRAIN
- EXISTING FIELD INLET
- EXISTING MANHOLE
- DRAINAGE MANAGEMENT AREA BOUNDARY
- DRAINAGE MANAGEMENT AREA DRAINING TO PARKING INFILTRATION TRENCH AREA OR BIO-RETENTION AREA

BIORETENTION AREAS	
DMA	PROVIDED TREATMENT AREA (SF)
1	220
2	120
3	229
TOTAL	569

QUATTROCCHI KWOK ARCHITECTS
Main:
636 Fifth Street, Santa Rosa, CA 95404
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55 Harrison Street, Suite 525,
Oakland, CA 94607
(707) 576-0829

cbg SAN RAMON (925) 866-0322
ROSEVILLE (916) 788-4456
WWW.CBG600.COM
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NEW AUXILIARY GYMNASIUM
1050 NEROLY RD,
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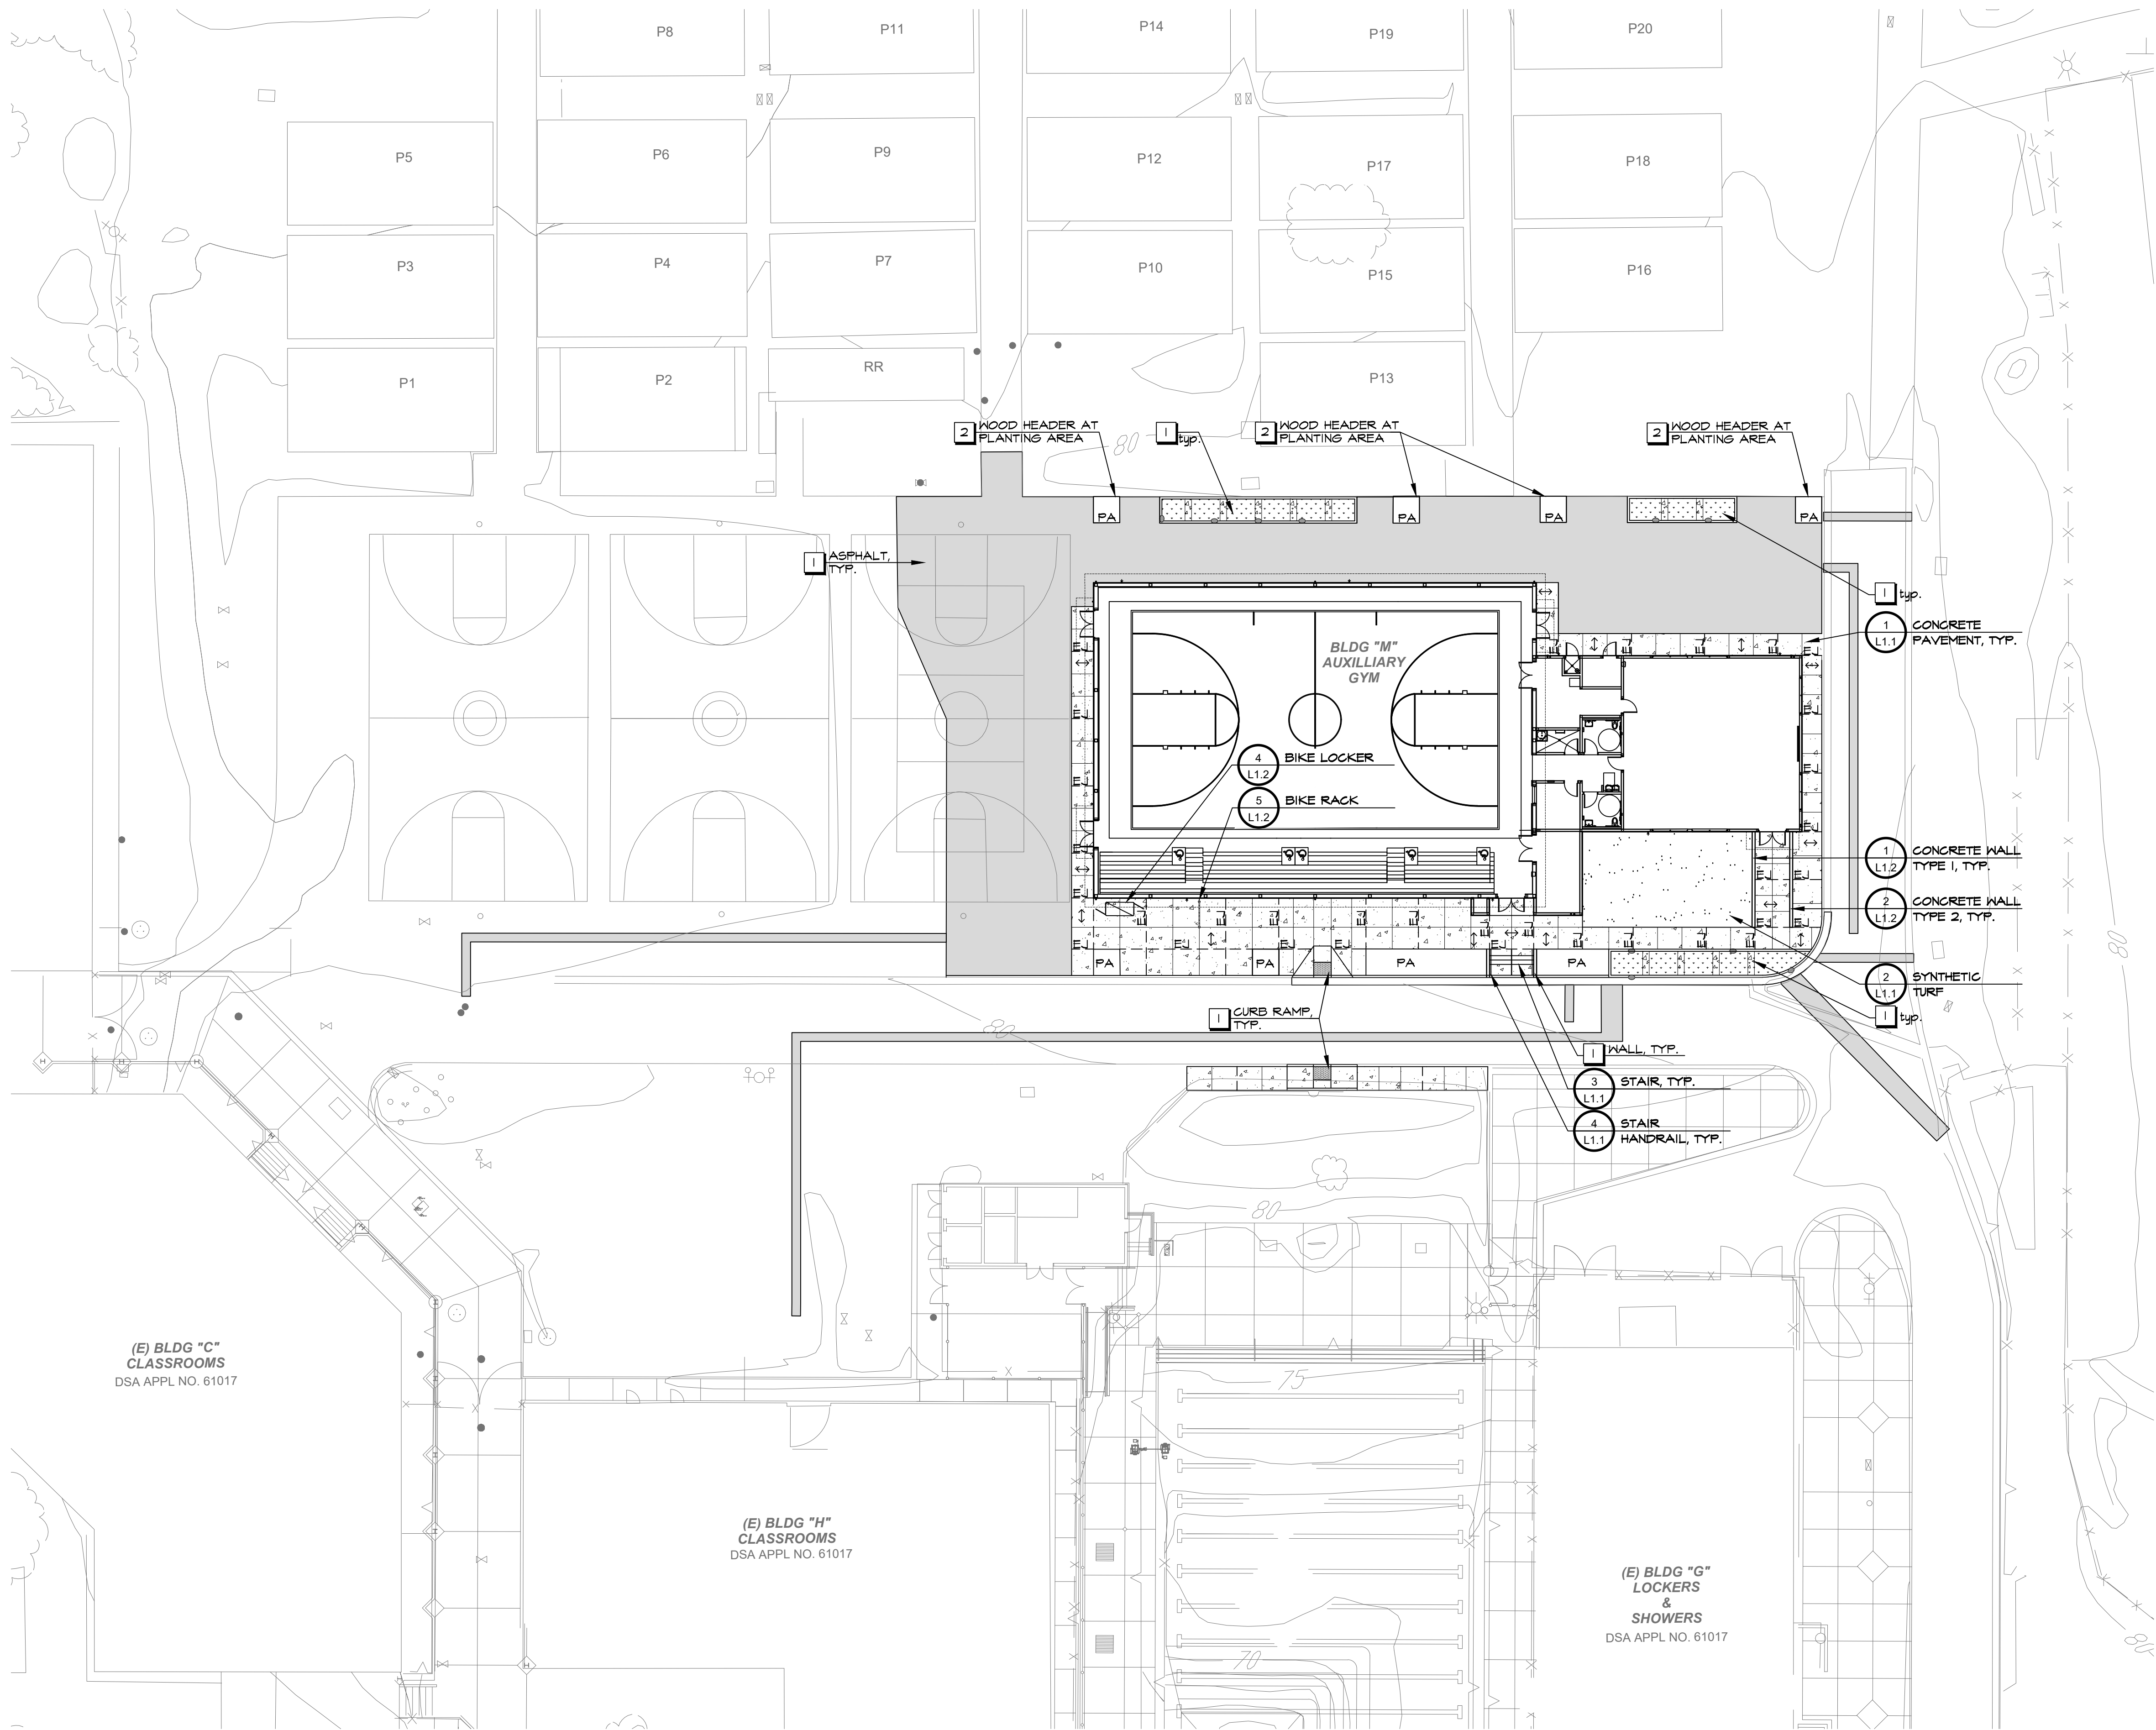
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STORMWATER CONTROL PLAN

SHEET NUMBER

C-5.0



KEY NOTES

- 1 See Civil Drawings
- 2 Wood Header. See Planting Details on Sheet L4.1.

MATERIAL LEGEND

- Concrete Pavement. Concrete shall have a slip resistant broom finish in the direction shown on this sheet.
- Asphalt Pavement. See Civil Drawings.
- Synthetic Turf. Synthetic turf shall be Nutmeg Premium (or approved equal), with Rounded Silica Granules Infill, as available through FieldTurf. Contact Charles Colletti, FieldTurf, 252.208.2444, charles.colletti@fieldturfcommercial.com. See Civil Drawings for Base and Drainage.
- Biofiltration Facilities. See Civil Drawings.
- Concrete Wall. See plan for type.
- Handrail
- Expansion Joint. See Civil Drawings.
- Tooled Control Joint. See Civil Drawings.
- Direction of broom finish
- PA Planting Area. See L4.0.

CONCRETE NOTES

- Subgrade preparation shall be done in accordance with the recommendations in the Geotechnical Report.
- Tooled control joints shall run continuously and extend through integral curbs and thickened edges. Toolled control joint layout shall be as shown on the Layout Plan, and coincide with the corners of objects, structures and the beginning and ends of curves. Joints should have a minimum depth of 25% of the slab thickness, unless otherwise noted on plans.
- Expansion joints shall be laid out as shown on the Layout Plan.
- Contractor shall place 3/8" asphalt impregnated fiber board where new concrete meets building, walls, curbs and planters.
- The base rock layer, prior to placement of concrete, shall be sprinkled with clean water several times to restore any moisture that may have been lost after completion of compaction.
- Cure concrete with curing compound or keep continuously moist for a minimum of 7 days.
- Contractor shall prepare a 4"x4" sample of all flatwork and 4' length of all walls and curbs in the field prior to construction, for review and approval by the District.
- Concrete pavement with slopes less than 6% shall receive a medium broom finish and slopes greater than 6% shall receive a heavy broom finish. Finish shall be in the direction shown on this sheet.

Existing features and topographic information have been taken from a Survey provided by CBE, dated September 17, 2020. GSM landscape architects, inc. assumes no liability, real or alleged, regarding the accuracy of existing features or topographic information shown.

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East Bay:
55 Harrison Street, Suite 525,
Oakland, CA 94607
(707) 576-0829

GSM landscape architects, inc.
1700 Second Ave, Suite 23
Napa, CA 94559
707-255-4630
www.gsmainc.com

LANDSCAPE ARCHITECT
No. 2790
Exp. 10-31-22
STATE OF CALIFORNIA

FREEDOM HIGH SCHOOL
NEW AUXILIARY GYMNASIUM
1050 NEROLY RD,
OAKLEY, CA 94561

LIBERTY UNION HIGH SCHOOL DISTRICT

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MATERIAL AND
DETAIL
REFERENCE
PLAN

SHEET NUMBER
L1.0



Aggregate Base. See Civil Drawings

Synthetic Turf

Synthetic Turf backing adhered to recycled plastic header

Separation Fabric. See Civil Drawings

Subgrade preparation. See Civil Drawings

1 CONCRETE PAVEMENT

2"x4" recycled plastic header board at all edges

- NOTES:
1. See Concrete Notes on the Material and Detail Reference Plan in addition to requirements in the Specifications.
 2. Concrete shall be uncolored concrete with a medium broom finish on all sides and parallel with concrete stairs.
 3. Contractor shall submit paint samples that provide 70% contrast with concrete color and with slip resistant finish to the District for review and approval.
 4. Contractor shall comply with all requirements of the 2019 CBC 11B-504.4.1
 5. See Structural Drawings for lap splice requirements and hook/bend information.

The diagrams illustrate the structural details of a handrail system at three key locations:

- TOP OF STAIRS:** Shows the handrail (5) and stairs (3) meeting at a concrete footing (1). The handrail has a 34" min. height and a 12" min. level. The footing is 5'-0" OC max. Dowels (2) are shown connecting the footing to the stairs.
- INTERMEDIATE POST:** Shows the handrail (5) and stairs (3) meeting at a concrete footing (1). The handrail has a 34" min. height and a 12" min. level. The footing is 5'-0" OC max. Dowels (2) are shown connecting the footing to the stairs.
- BOTTOM OF STAIRS:** Shows the handrail (5) and stairs (3) meeting at a concrete footing (1). The handrail has a 34" min. height and a 12" min. level. The footing is 5'-0" OC max. Dowels (2) are shown connecting the footing to the stairs.

Labels and dimensions include:

- Handrail (5), Stairs (3), Concrete Footing (1), Dowels (2)
- 34" min. typ.
- 12" min. level
- 5'-0" OC max.
- 1 5/8" OD Galvanized steel handrail, cont. (extra strong) grind smooth all welds. 5/16" fillet weld all around all joints, seam weld all splices.
- 1 Tread, typ.
- 34" min. typ.
- 12" min. level
- R 4", typ.

- NOTES:
1. Handrails shall be manufactured from steel pipe, and then hot-dipped galvanized. All joints shall be fully welded and sanded smooth before hot-dipping the handrails.
 2. Architect shall review and approve handrails in place prior to grouting.
 3. See Material and Detail Reference Plan for handrail locations.

1 CONCRETE PAVEMENT, TYP.

OR

3 STAIRS

Steel pipe

Slope top of grout to drain

#4 x 12" hairpins each side, tack weld to sleeve
See Hairpin Plan View

Non-shrink grout

Galvanized steel sleeve insert, cast into concrete

Labels: 1/2" dia., 1/2", 2" min., 6" min., 8" O.D., 3", 3"

HAIRPIN PLAN VIEW


Steel pipe

Non-shrink grout

#4 x 12" hairpins each side, tack weld to sleeve

Galvanized steel sleeve insert, cast into concrete


Label: 12"

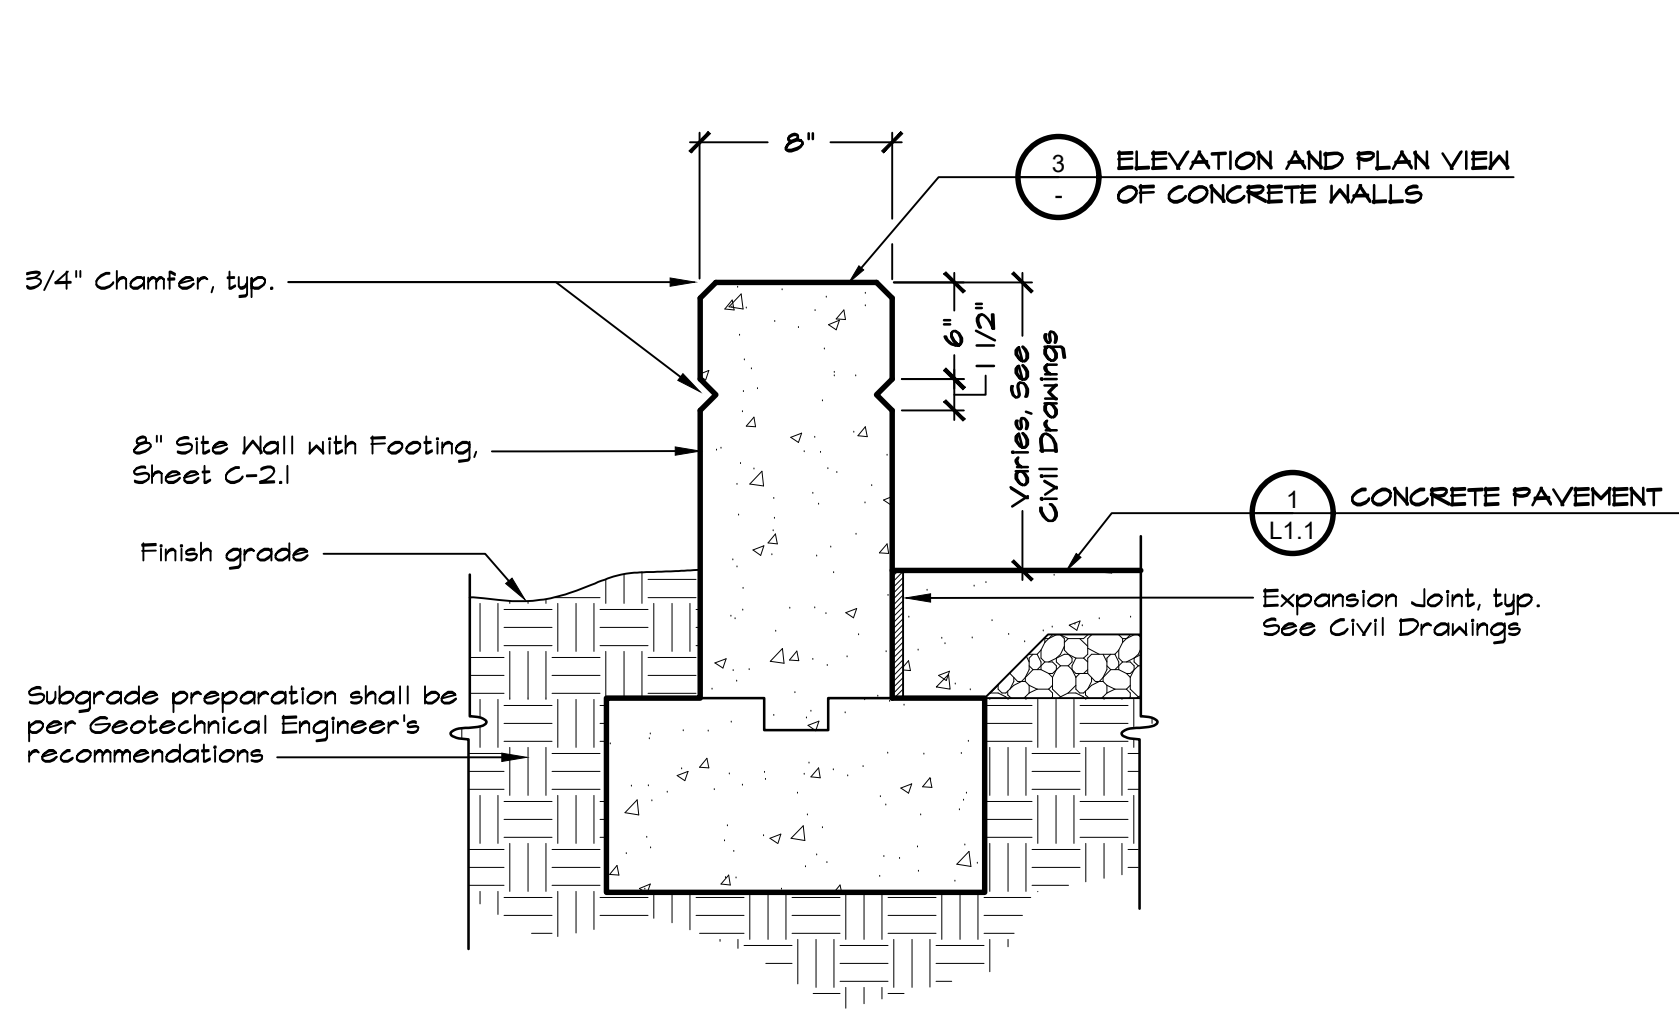

- NOTES:
1. See Concrete Notes on the Material and Detail Reference Plan.
 2. See Civil Drawings for detailed grading and drainage plans.
 3. Hold top of wall level unless otherwise noted on Civil Drawings.
 4. Wall finish shall be smooth sack finish on all surfaces and edges.
 5. See Civil Drawings for detailed wall, reinforcement and wall drainage design.

1 CONCRETE WALL - TYPE 1


NOT TO SCALE

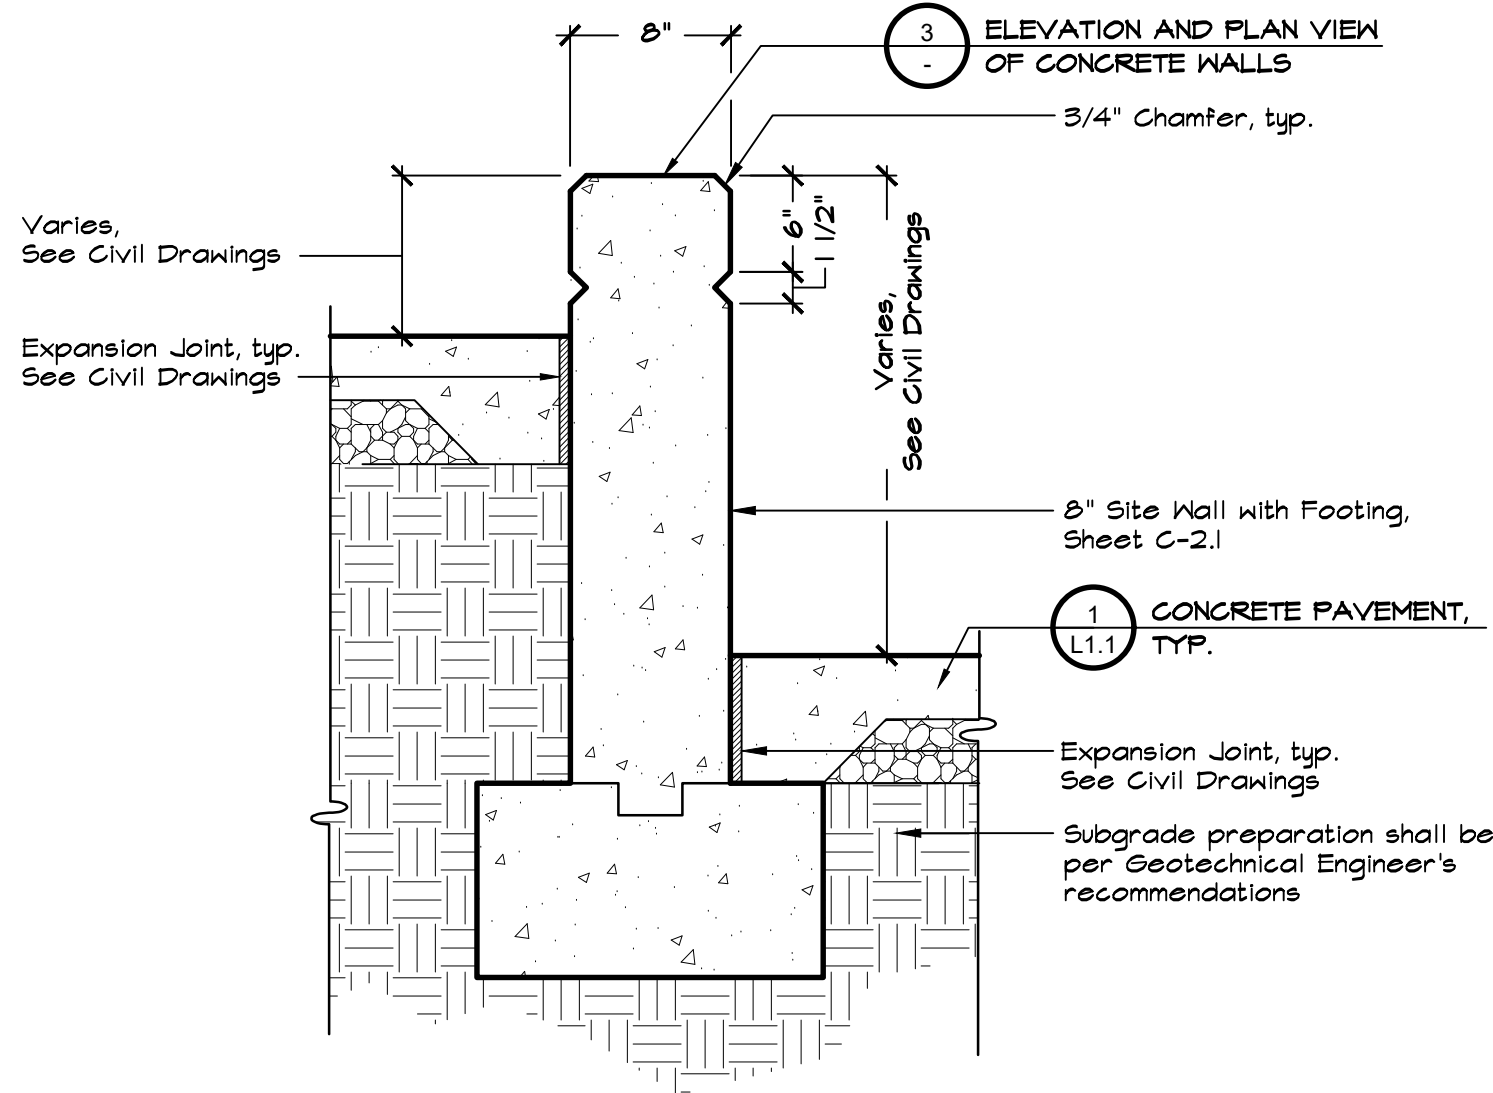

- Notes:
1. See Concrete Notes on the Material and Detail Reference Plan.
 2. See Civil Drawings for detailed grading and drainage plans.
 3. Hold top of wall level unless otherwise noted on the Civil Drawings.
 4. Wall finish shall be smooth sack finish on all surfaces and edges.
 5. See Civil Drawings for detailed wall, reinforcement and wall drainage design.

2 CONCRETE WALL - TYPE 2


NOT TO SCALE

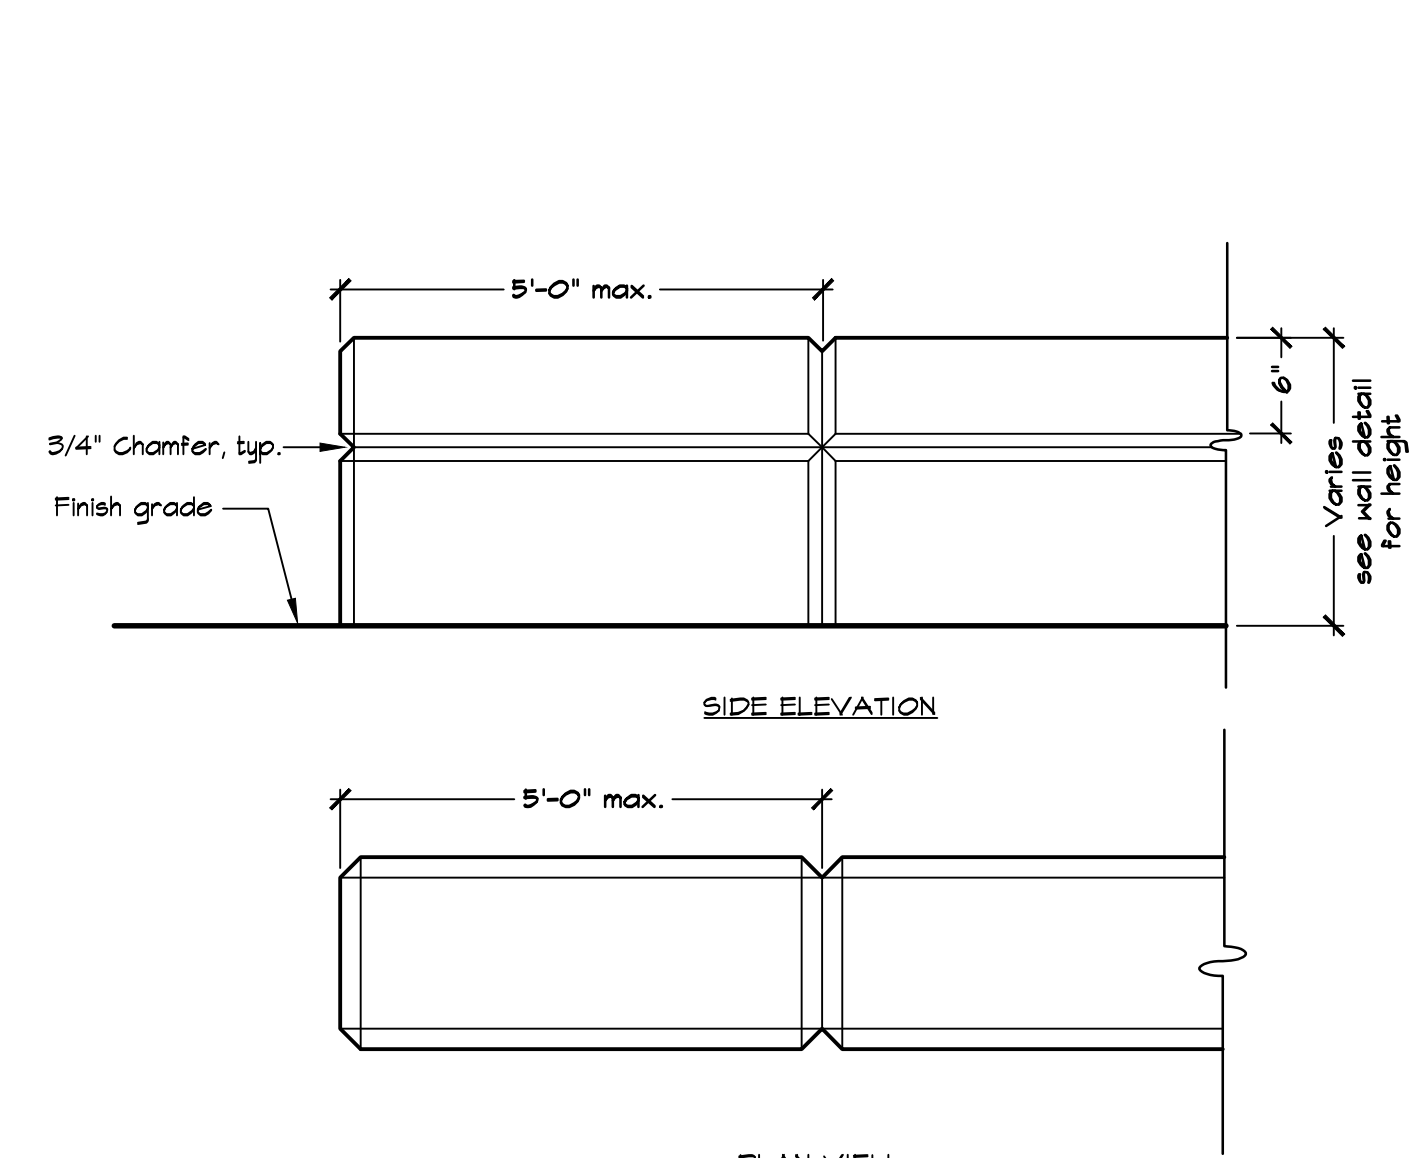

- NOTES:
1. See Civil Drawings for reinforcement and expansion joints.

3 ELEVATION AND PLAN VIEW OF CONCRETE WALLS

NOT TO SCALE

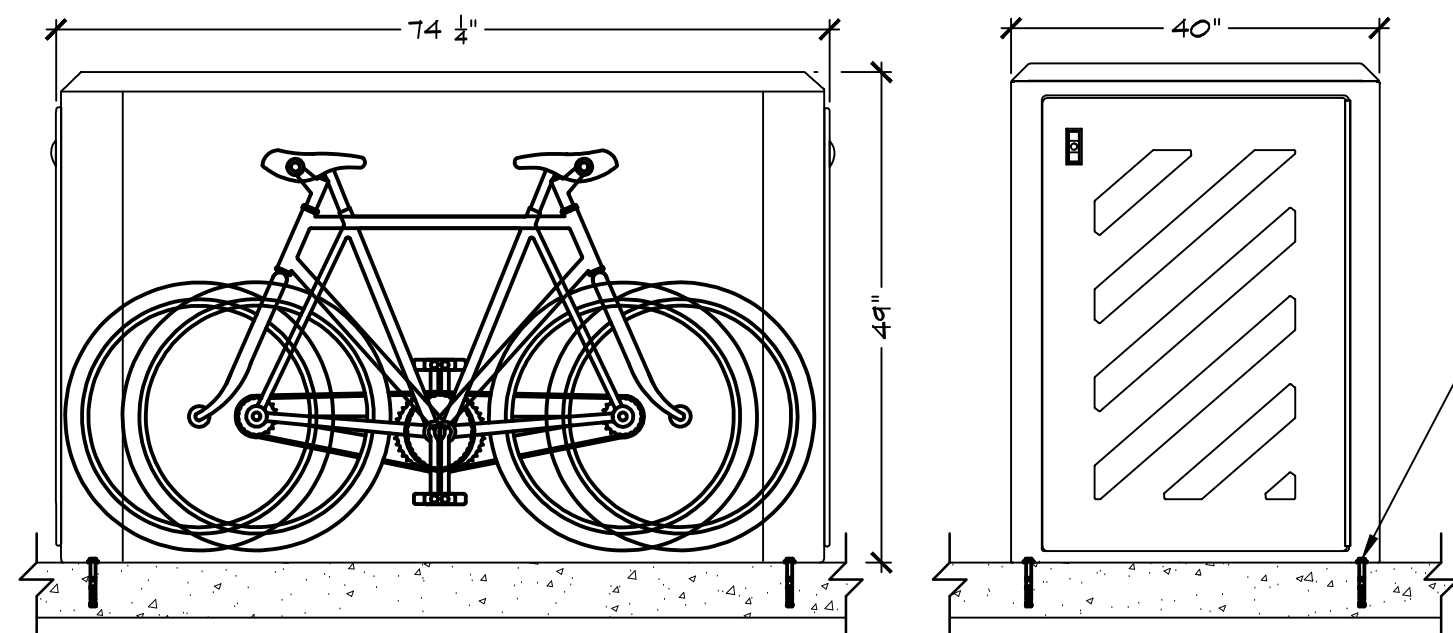


- NOTES:
1. Bike Locker shall be Ground Control Systems Fiberglass Bicycle Vault, Bike Locker-FBV2, Leather (Tan) UV stable color, fire retardant composite finish, closed door and padlock handle. Available through Ground Control Systems, (800) 630-7225, info@groundcontrolsystems.com, or approved equal.
 2. Installation shall be per manufacturer's specifications.

GROUND CONTROL
SYSTEMS

4 BIKE LOCKER


NOT TO SCALE

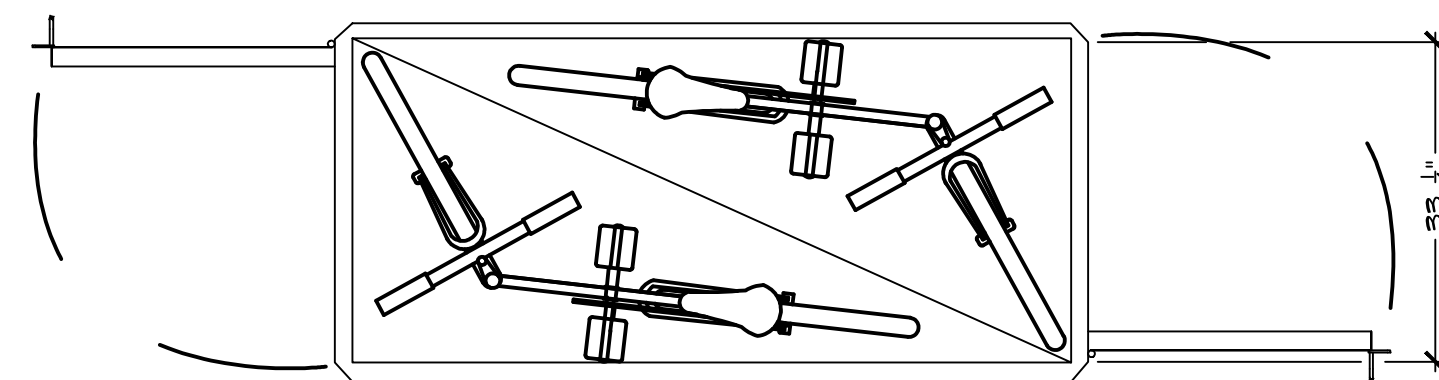

- NOTES:
1. Bike Rack shall be DuMor Series 130-40HS, hot-dipped galvanized, 4 peaks. Contact Jon Banden of Ross Recreation Equipment Co. (530) 342-2860.
 2. Installation shall be per manufacturer's specifications.

5 BIKE RACK

NOT TO SCALE

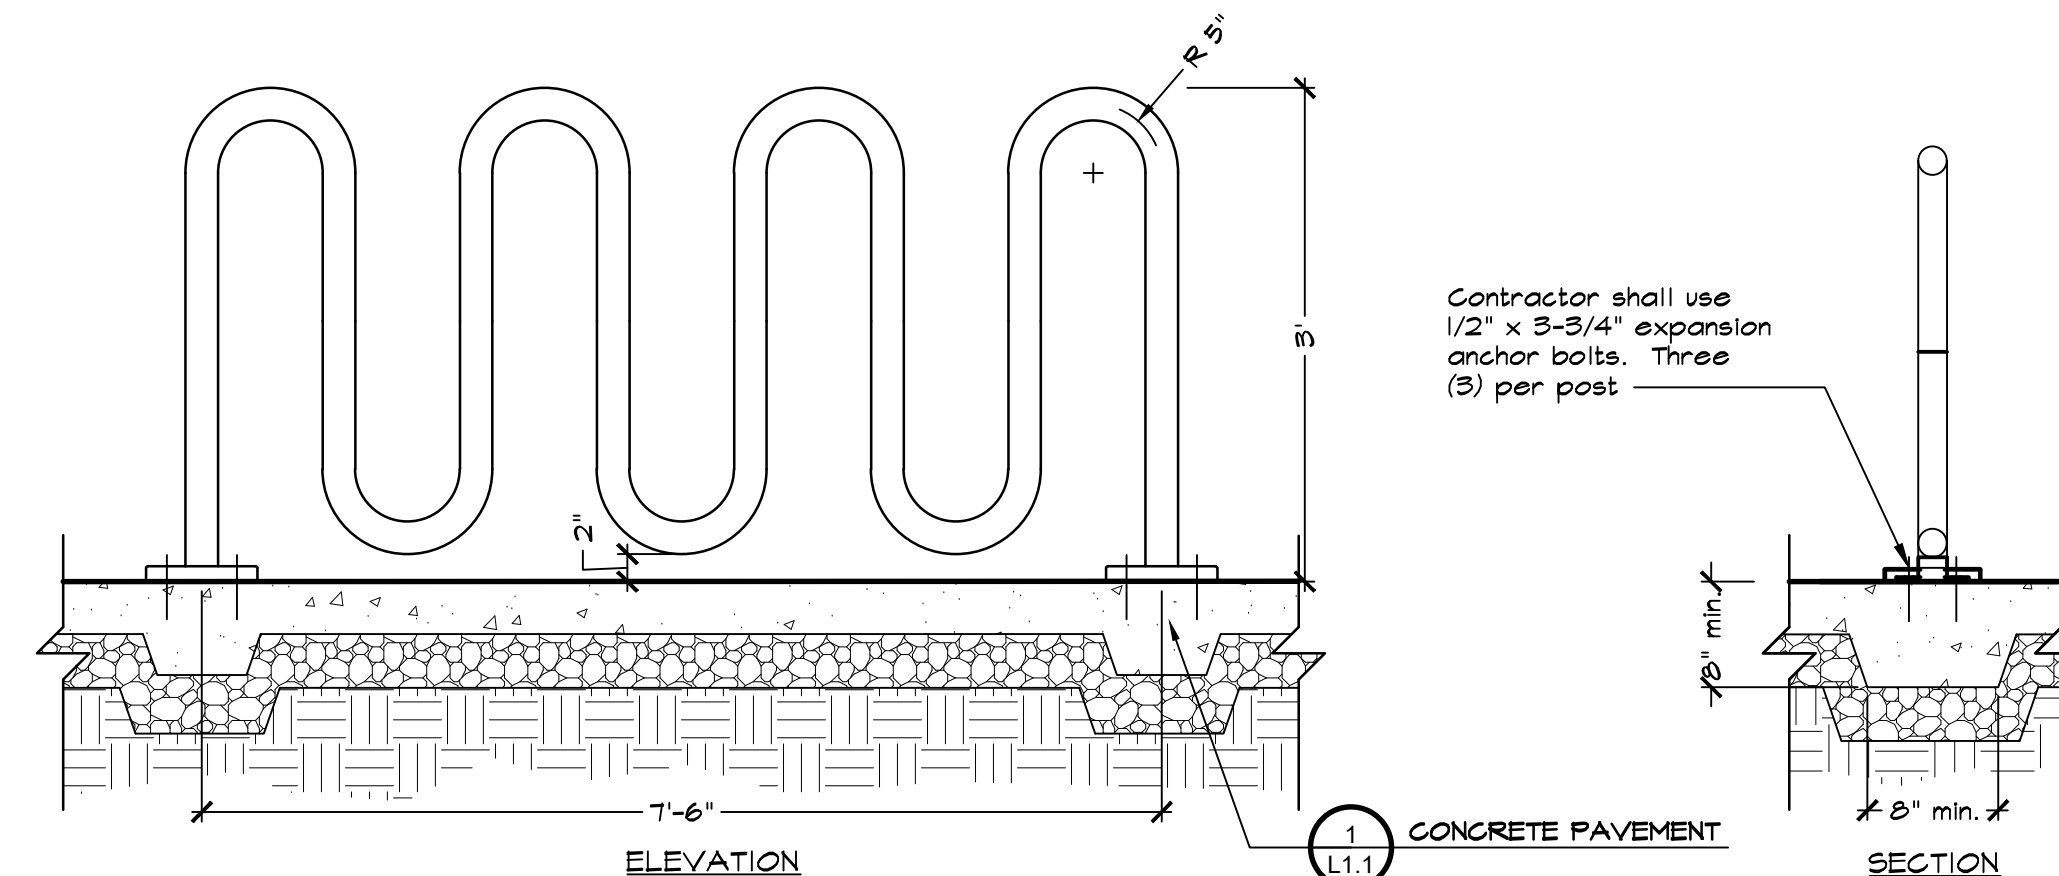

QUATTROCCHI KWOK
ARCHITECTS
Main:
636 Fifth Street, Santa Rosa, CA 95404
East Bay:
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Oakland, CA 94607
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GSM landscape architects, inc.
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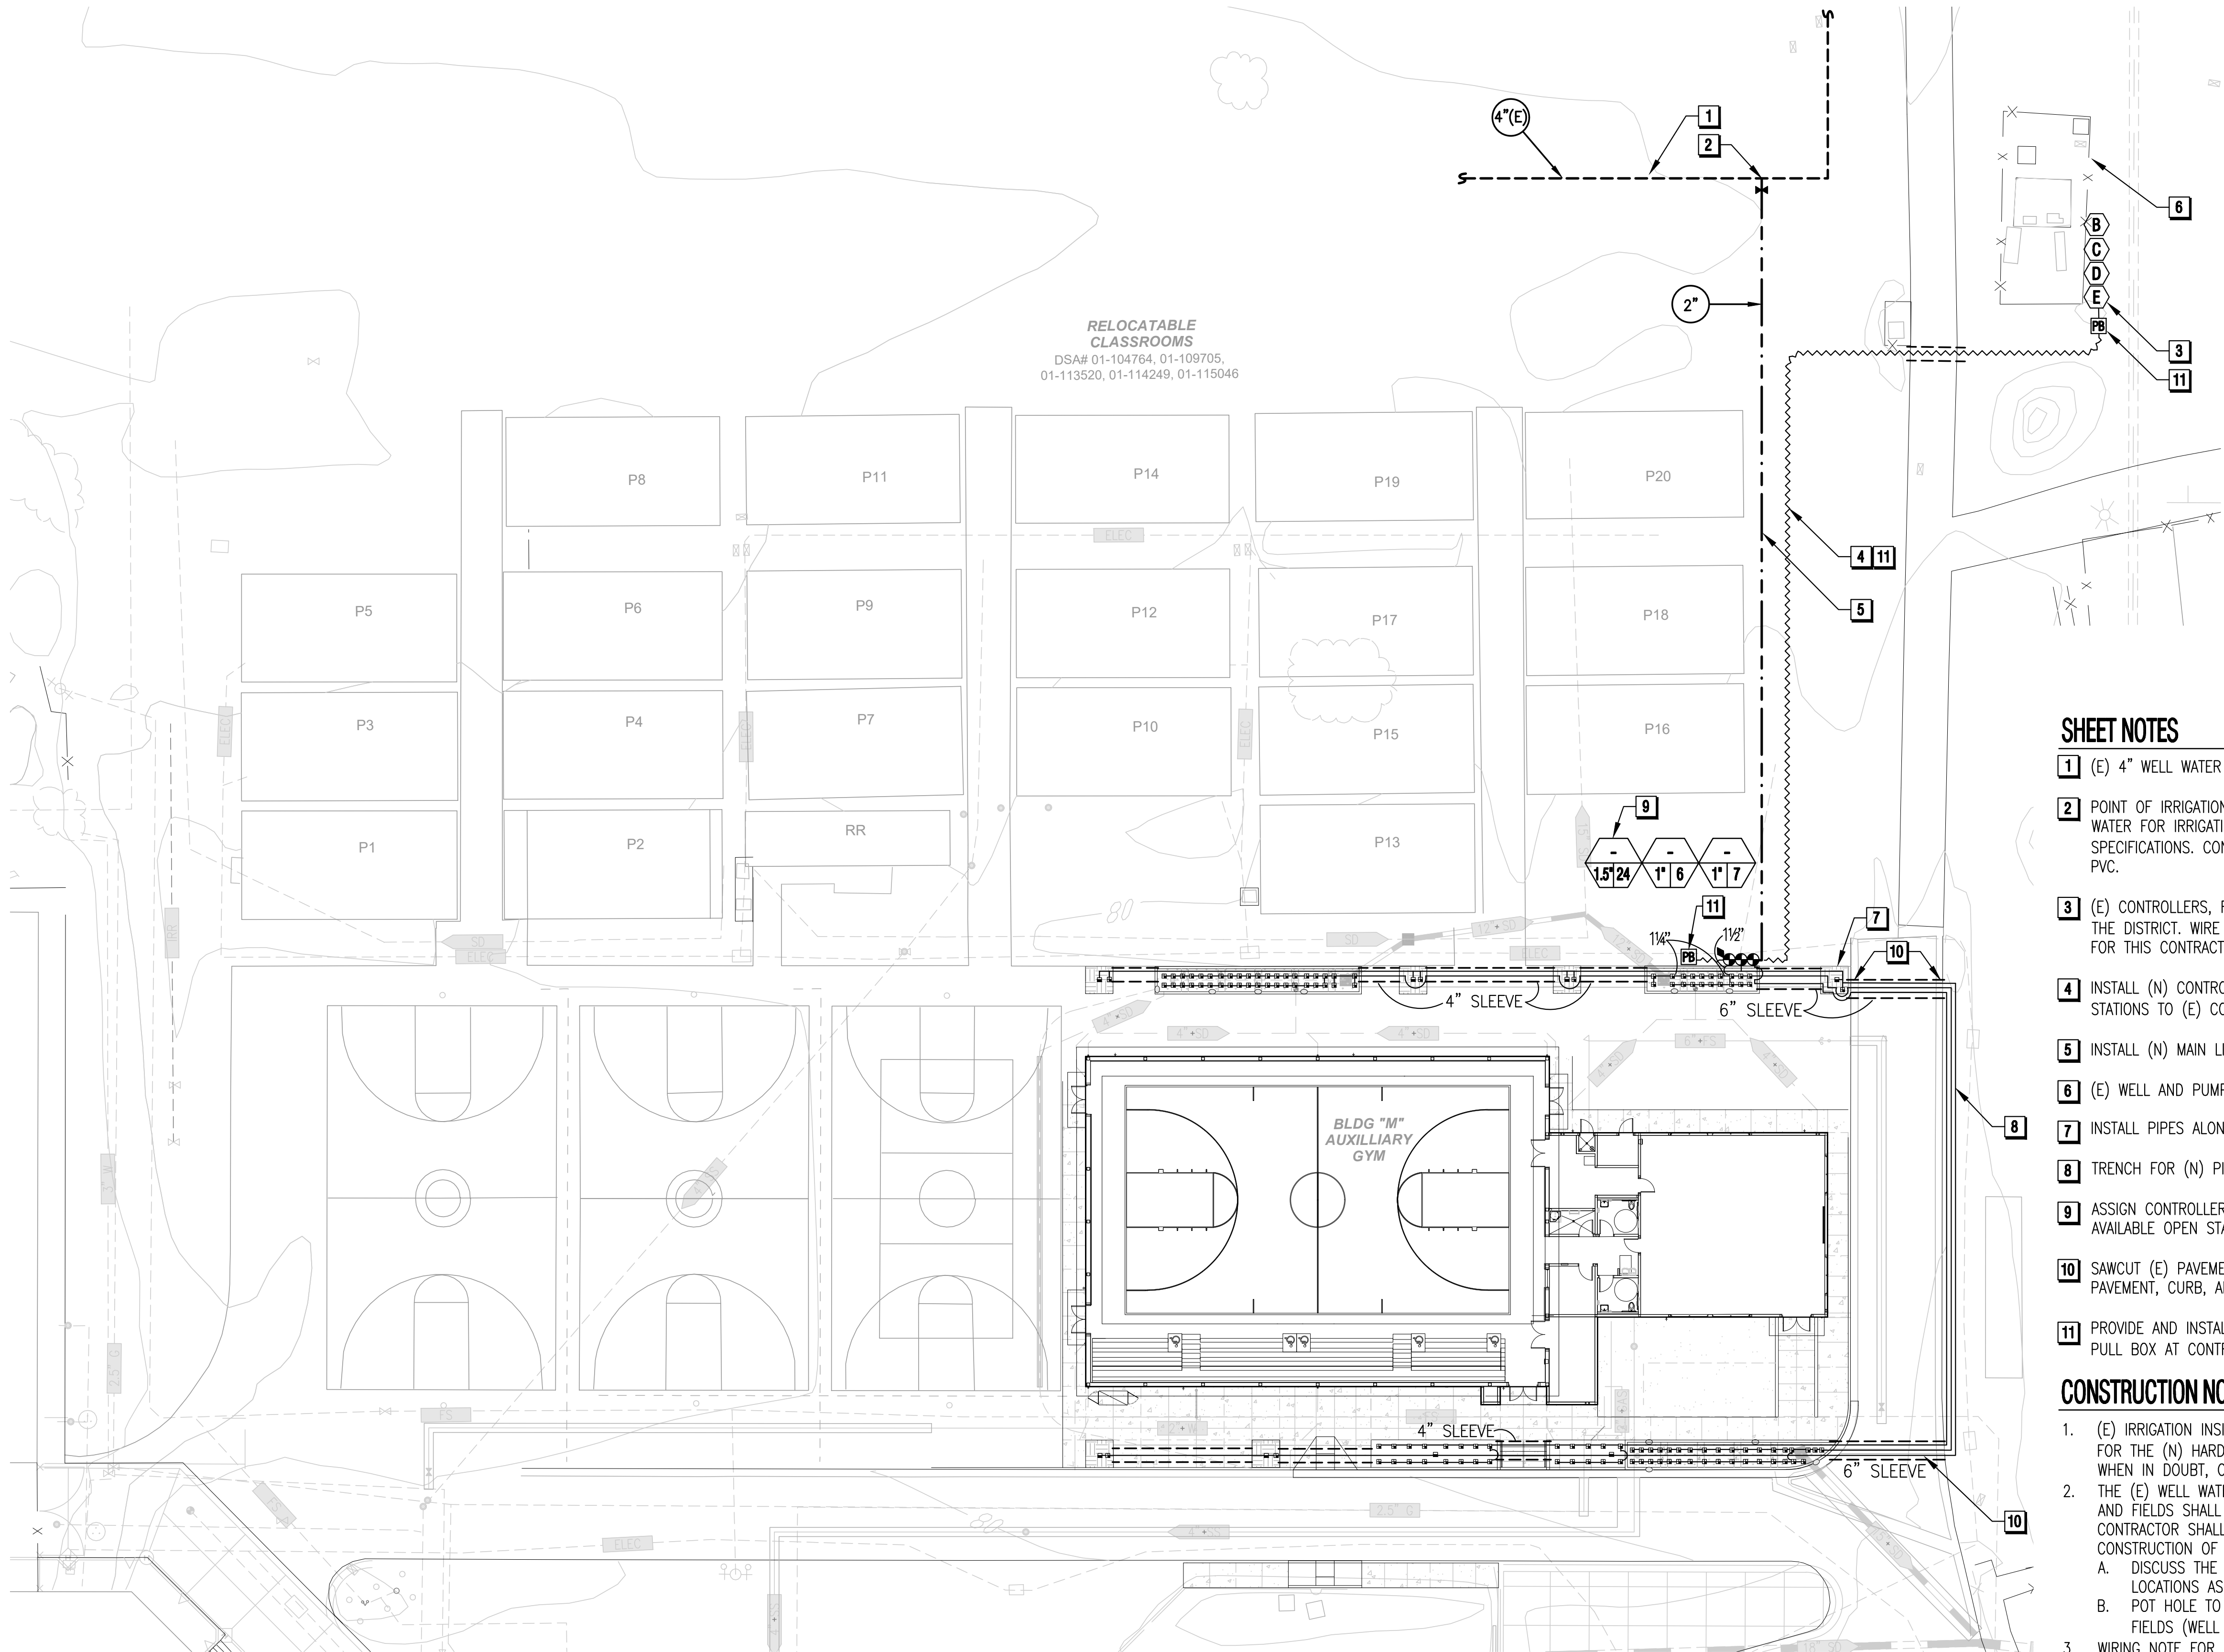
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
SHEET TITLE

CONSTRUCTION DETAILS

SHEET NUMBER

L1.2





JDE

JAMES D. EDDY ASSOCIATES
LANDSCAPE IRRIGATION ENGINEERS
P.O. BOX 2291
DANVILLE, CALIFORNIA 94526
P: (925) 867-3339
EMAIL: JDE@EDDYASSOCIATES.COM
PLANNING-DESIGN-MANAGEMENT
JDE PROJECT NO: 20037

IRRIGATION DESIGNER:
James D. Eddy
JAMES D. EDDY ASSOCIATES, DANVILLE, CALIFORNIA
NOTE: NO LICENSE FOR THE LANDSCAPE IRRIGATION
SYSTEM DESIGN PROFESSION IS AVAILABLE IN THE STATE
OF CALIFORNIA.
MEMBER: AMERICAN SOCIETY OF IRRIGATION CONSULTANTS

SHEET NOTES

- 1 (E) 4" WELL WATER MAIN LINE TO REMAIN IN SERVICE, AS-IS.
- 2 POINT OF IRRIGATION WATER CONNECTION: CONNECT TO (E) 4" DIA. IRRIGATION PIPING USING WELL WATER FOR IRRIGATION USE ONLY. USE A DOUBLE STRAP SADDLE PER THE PLANS AND SPECIFICATIONS. CONTACT THE DISTRICT FOR FURTHER INSTRUCTIONS IF THE (E) MAIN LINE IS NOT PVC.
- 3 (E) CONTROLLERS, FOUR TOTAL. LOCATE AVAILABLE UNUSED STATIONS AT ONE CONTROLLER WITH THE DISTRICT. WIRE (N) STATIONS TO THE DESIGNATED CONTROLLER WITH ENOUGH OPEN STATIONS FOR THIS CONTRACT WORK.
- 4 INSTALL (N) CONTROL WIRE TO (E) CONTROLLER DESIGNATED TO USE BY THE DISTRICT. WIRE STATIONS TO (E) CONTROLLER WHERE OPEN STATIONS ARE LOCATED.
- 5 INSTALL (N) MAIN LINE AND ROUTE AS SHOWN.
- 6 (E) WELL AND PUMP
- 7 INSTALL PIPES ALONG EDGE OF TREE PLANTER AND AWAY FROM TREE ROOTZONE, TYPICAL.
- 8 TRENCH FOR (N) PIPING IN (E) PLANTED AREA. REPLACE (E) PLANTING IN KIND.
- 9 ASSIGN CONTROLLER AND STATION NUMBER TO RCV BASED UPON (E) CONTROLLER USED AND AVAILABLE OPEN STATION NUMBERS.
- 10 SAWCUT (E) PAVEMENT, CURBS, AND GUTTER. PATCH PAVEMENT, CURB, AND GUTTER WITH PAVEMENT, CURB, AND GUTTER PER DETAILS ON CIVIL DRAWINGS.
- 11 PROVIDE AND INSTALL EIGHT (8) SPARE CONTROL WIRES AND ONE (1) COMMON WIRE FROM (N) PULL BOX AT CONTROLLER TO (N) PULL BOX AT VALVE GROUP FOR FUTURE USE.


CONSTRUCTION NOTES

1. (E) IRRIGATION INSIDE THE (N) WORK AREA SHALL BE DEMOLISHED AS REQUIRED TO MAKE WAY FOR THE (N) HARDSCAPE/LANDSCAPE CONSTRUCTION. THIS INCLUDES (E) LATERAL LINE PIPE. WHEN IN DOUBT, CONFER WITH ARCHITECT FOR DIRECTION.
2. THE (E) WELL WATER IRRIGATION MAIN LINE SERVING FREEDOM HIGH SCHOOL CAMPUS LANDSCAPE AND FIELDS SHALL REMAIN IN SERVICE AND IN GOOD WORKING ORDER AT ALL TIMES. THE CONTRACTOR SHALL PROVIDE THE FOLLOWING RESEARCH AND SERVICES PRIOR TO ACTUAL CONSTRUCTION OF THE NEW WORK:

A. DISCUSS THE ACTUAL IRRIGATION MAIN LINE PIPE LOCATIONS WITH THE ARCHITECT. STAKE LOCATIONS AS REQUIRED.

B. POT HOLE TO ESTABLISH WHAT BURIED PIPES ARE IRRIGATION MAIN LINES SERVING THE FIELDS (WELL WATER).
3. WIRING NOTE FOR (E) RCV WIRING FOUND IN THIS CONTRACT AREA: (E) RCV'S CONTROLLED FROM AND WIRED TO (E) ON-SITE CONTROLLERS MAY BE FOUND DURING EXCAVATION. SALVAGE AND PROTECT (E) CONVENTIONAL CONTROL WIRING FOUND NEXT TO THE (E) PVC MAIN LINE. REROUTE WITH (N) WIRE WHERE NECESSARY TO KEEP THE (E) IRRIGATION SYSTEM IN OPERATION. (E) SPLICED WIRES SHALL BE CONTAINED WITHIN AN APPROVED BURIED SPLICE BOX WITH LID SURFACE AT GRADE.

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APRIL 27, 2021

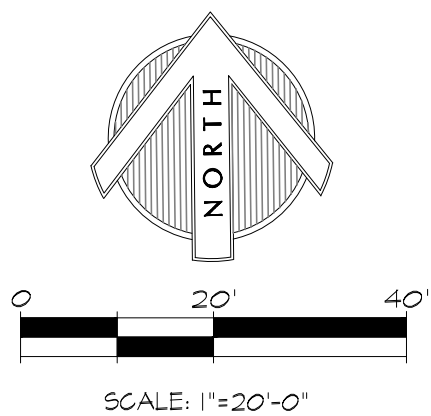SHEET TITLE

IRRIGATION
PLAN


SHEET NUMBER

L3.0

IRRIGATION INSTALLATION NOTES

- REFER TO IRRIGATION SPECIFICATIONS FOR DETAILED INFORMATION.
LUHSD = LIBERTY UNION HIGH SCHOOL DISTRICT
- PROVIDE INSTALLATION BY PERSONS FAMILIAR WITH IRRIGATION WORK AND UNDER THE SUPERVISION OF A QUALIFIED SUPERVISOR.
 - OBTAIN THE PERMITS REQUIRED AND PROVIDE LABOR AND MATERIALS NECESSARY TO FULLY COMPLETE THE WORK IN ACCORDANCE WITH THE DRAWINGS AND THE SPECIFICATIONS.
 - LOCATE AND PROTECT NEW AND EXISTING UTILITIES PRIOR TO EXCAVATION. DO NOT DAMAGE EXISTING UTILITIES, PAVING OR STRUCTURES. PROVIDE THE NECESSARY REPAIRS AT NO ADDITIONAL COST TO LUHSD.
 - REMOVE DEBRIS AND ACCUMULATION OF DEBRIS AS A RESULT OF IRRIGATION CONSTRUCTION FROM THE SITE AND LEAVE AREA IN A CLEAN CONDITION ACCEPTABLE TO LUHSD. MAINTAIN SITE FOR THE SPECIFIED CALENDAR DAYS FOLLOWING ACCEPTANCE OF THE WORK BY LUHSD AND MAKE CORRECTIONS OR REPAIRS TO THE IRRIGATION AS DIRECTED BY LUHSD AT THE COMPLETION OF THE MAINTENANCE PERIOD.
 - THE DRAWINGS ARE DIAGRAMMATIC. PIPE AND EQUIPMENT MAY BE SHOWN IN PAVING FOR CLARITY ONLY – INSTALL IN PLANTING AREAS WHERE POSSIBLE. DUE TO THE SCALE OF THE DRAWINGS, ALL OFFSETS, FITTINGS, SLEEVES, ETC. WHICH MAY BE REQUIRED ARE NOT INDICATED. INVESTIGATE THE STRUCTURAL AND FINISHED CONDITIONS AFFECTING THE CONTRACT WORK INCLUDING OBSTRUCTIONS GRADE DIFFERENCES OR AREA DIFFERENCES WHICH MAY HAVE NOT BEEN CONSIDERED IN THE ENGINEERING. WHERE FIELD CHANGES EXIST, COORDINATE THE INSTALLATION WORK ACCORDINGLY BY NOTIFICATION AND APPROVAL OF LUHSD AS PER THE CONTRACT SPECIFICATIONS. COORDINATE IRRIGATION CONTRACT WORK WITH ALL APPLICABLE CONTRACTORS FOR THE LOCATION AND INSTALLATION OF PIPE, CONDUIT, OR SLEEVES OF PIPE, CONDUIT OR SLEEVES THROUGH OR UNDER WALLS, ROADWAYS, PAVING, STRUCTURE, ETC. BEFORE CONSTRUCTION. ASSUME FULL RESPONSIBILITY FOR REQUIRED REVISIONS IF THESE NOTIFICATIONS ARE NOT PERFORMED.
 - CONTRACTOR SHALL COORDINATE WITH OTHER CONTRACTORS ALL IRRIGATION SLEEVES, CONDUIT, AND PIPING INSTALLED UNDER PAVEMENT PRIOR TO INSTALLATION.
 - THE INTENT OF THIS IRRIGATION SYSTEM DESIGN IS TO PROVIDE THE MINIMUM AMOUNT OF WATER REQUIRED TO SUSTAIN GOOD PLANT HEALTH.
 - PROGRAM THE CONTROLLER TO PROVIDE THE MINIMUM AMOUNT OF WATER NEEDED TO SUSTAIN GOOD PLANT HEALTH. MAKE ADJUSTMENTS TO THE PROGRAM FOR SEASONAL WEATHER CHANGES, PLANT MATERIAL, WATER REQUIREMENTS, MOUNDS AND SLOPES, SUN, SHADE AND WIND EXPOSURES.
 - THE IRRIGATION SYSTEM FOR THIS CONTRACT WORK AREA IS DESIGNED FOR 1 VALVE TO OPERATE AT ONE TIME. THIS WILL ALLOW THE SYSTEM TO IRRIGATE IN APPROXIMATELY 8 HOURS OR LESS ACCORDING TO WEATHER CONDITIONS. TOTAL GPM DEMAND OF SYSTEM WILL BE APPROXIMATELY 23 GPM MAXIMUM. DO NOT UNDER ANY CIRCUMSTANCE EXCEED 23 GPM OR OPERATE MORE THAN ONE (1) VALVE AND ONE QUICK COUPLING VALVE AT THE SAME TIME.
 - IRRIGATION CONTROL WIRE: RAINMASTER 2–WIRE CABLE, TW–CAB–14, WITH U.L. APPROVAL FOR DIRECT BURIAL IN GROUND, SIZE AWG–UF #14–1.
 - SPLICES: MADE WITH 3M–DBY, OR SPEARS MODEL #400, OR APPROVED EQUAL SEAL PACKS.
 - INSTALL ONE SPARE 2–WIRE CABLE FROM CONTROLLER ALONG THE ENTIRE MAIN LINE. INSTALL 36” EXCESS WIRE INTO A QUICK COUPLER BOX AT EACH VALVE GROUP. WEATHERPROOF UNUSED WIRE ENDS. SPLICING OF 2–WIRE CABLE AND 24 VOLT WIRES IS NOT PERMITTED EXCEPT IN VALVE BOXES. LEAVE A 36” LONG, 1” DIAMETER COIL OF EXCESS WIRE AT EACH SOLENOID WIRE SPLICE.
 - PLASTIC VALVE BOXES AND LIDS SHALL BE PURPLE IN COLOR WITH BOLT DOWN, NON–HINGED COVER MARKED "IRRIGATION". BOX BODY SHALL HAVE KNOCK OUTS. MANUFACTURER: RAIN BIRD, NDS, CARSON/BROOKS, OR APPROVED EQUAL.
 - INSTALL REMOTE CONTROL VALVE BOXES 12” FROM WALK, CURB, BUILDING OR LANDSCAPE FEATURE. AT MULTIPLE VALVE BOX GROUPS, EACH BOX SHALL BE AN EQUAL DISTANCE FROM THE WALK, CURB, ETC. AND EACH BOX SHALL BE 12” APART. SHORT SIDE OF RECTANGULAR VALVE BOXES SHALL BE PARALLEL TO WALK, CURB, ETC. REFER TO BOX INSTALLATION DETAIL.
 - FLUSH AND ADJUST IRRIGATION HEADS FOR EFFICIENT PERFORMANCE. PREVENT OVERSPRAY ON THE WALKS, PLAYGROUNDS, ROADWAYS, SIGNS, LIGHTS, AND/OR BUILDINGS. SELECT THE BEST DEGREE OF ARC TO FIT THE EXISTING SITE CONDITIONS AND THROTTLE THE FLOW CONTROL OR PRESSURE REGULATION DEVICE AT EACH VALVE TO OBTAIN THE BEST OPERATING PRESSURE FOR EACH SYSTEM.
 - SET POP–UP HEADS PERPENDICULAR TO FINISH GRADE OF THE AREA TO BE IRRIGATED UNLESS OTHERWISE NOTED ON THE DRAWINGS.
 - IRRIGATION HEAD LAYOUT AND PIPING AS SHOWN ON THE DRAWINGS IS INDICATIVE OF THE WORK TO BE INSTALLED. IRRIGATION HEADS, ARC OF SPRAY, RADIUS OF SPRAY AND PIPING AT CERTAIN LOCATIONS MAY REQUIRE FIELD ADJUSTMENT TO PREVENT HARM TO TREE ROOTS AND INTERFERENCE OF TREES TO IRRIGATION SPRAY.
 - EXERCISE PARTICULAR ATTENTION AT ALL EXISTING AND NEW TREES TO ELIMINATE DIRECT SPRAY OF IRRIGATION HEADS ON TREE TRUNKS.
 - THE SPRINKLER SYSTEM DESIGN IS BASED ON THE MINIMUM OPERATING PRESSURE SHOWN ON THE IRRIGATION DRAWINGS. VERIFY WATER PRESSURE PRIOR TO CONSTRUCTION. REPORT ANY DIFFERENCE BETWEEN THE WATER PRESSURE INDICATED ON THE DRAWINGS AND THE ACTUAL PRESSURE READING AT THE IRRIGATION POINT OF CONNECTION TO LUHSD.
 - IRRIGATION DEMAND: 23 GPM MAX. (THIS WORK ONLY) AT 80 PSI WELL WATER PRESSURE.
 - PIPE SIZING SHOWN ON THE DRAWINGS IS TYPICAL. AS CHANGES IN LAYOUT OCCUR DURING STAKING AND CONSTRUCTION ADJUST THE SIZE ACCORDINGLY.
 - PIPE THREAD SEALANT COMPOUND SHALL BE PERMATEX 51 OR RECTORSEAL T+2.
 - BEFORE COMMENCING WITH WORK UNDER THIS CONTRACT, NOTIFY UNDERGROUND SERVICE ALERT AT 811 OR 1–800–227–2600 AND LUHSD. DETERMINE THE EXACT LOCATION OF EXISTING UTILITIES, PIPES, AND STRUCTURES BEFORE COMMENCING WORK. COSTS OF DAMAGES WHICH OCCUR FROM FAILURE TO ACCURATELY LOCATE AND PRESERVE THESE UTILITIES SHALL BE THE RESPONSIBILITY OF THE IRRIGATION CONTRACTOR.
 - CAUTION: USE SHOVELS AND HAND DIG TRENCHES AROUND (E) TREE ROOT SYSTEMS. INSTALL PIPING AWAY FROM (E) TREE ROOT SYSTEMS. PROTECT (E) TREE ROOT SYSTEMS AT ALL TIMES. TYPICAL FOR ALL (E) TREE ROOT SYSTEMS. INSTALL ALL BURIED IRRIGATION SUCH AS PVC PIPING, VALVES, HEADS, BOXES, CONDUIT WITH WIRES, IN A MANNER TO AVOID EXCAVATING OR TRENCHING WITHIN THE EXISTING TREE DRIPLINES AND ROOTZONES.
 - NOTE: NO PLASTIC PIPE OR SOLVENT WELDED JOINTS ARE PERMITTED ABOVE GRADE.
 - CONTROLLER, MASTER VALVE, AND FLOW SENSOR NOTE: CONTRACTOR SHALL BE RESPONSIBLE FOR ORDERING, COORDINATION WITH DISTRIBUTOR AND CONTROLLER ASSEMBLY VENDOR, THE INSTALLATION OF MASTER VALVE, FLOW SENSOR, AND ALL ASSOCIATED PARTS AND HARDWARE TO PROVIDE A COMPLETE AND FULLY OPERABLE SYSTEM.
 - CONTRACTOR SHALL COORDINATE WORK AFFECTING EXISTING, TEMPORARY AND PROPOSED IMPROVEMENTS TO PROVIDE CONTINUOUS IRRIGATION SYSTEM OPERATION.
 - CATHODIC PROTECTION REQUIRED – SEE CATHODIC PROTECTION PLANS AND SPECIFICATIONS.
 - SUBSURFACE EMITTER IRRIGATION:
 - CONTACT THE LOCAL SUBSURFACE MANUFACTURER’S REPRESENTATIVE FOR THE INSTALLATION PROCEDURES AND FOR ASSISTANCE WITH THE INSTALLATION OF THE SUBSURFACE EMITTER LINE.
 - INSTALL EMITTER DRIPPERLINE ACCORDING TO THE MANUFACTURER’S INSTRUCTIONS AND GUIDELINES AND THE DETAILS SHOWN ON THE PLANS.
 - PRIOR TO PLANTING, THOROUGHLY FLUSH ALL EMITTER TUBING TO REMOVE CONSTRUCTION DEBRIS AND SOIL FROM THE TUBING.
 - PRIOR TO PLANT INSTALLATION MAKE SURE THE SURROUNDING SHRUB PLANTING SOIL AND SOIL BASE FOR PLANTS IS THOROUGHLY MOISTENED.
 - TEMPORARY SURFACE WATERING IS REQUIRED AFTER INITIAL PLANTING OF THE PLANTS, SEED, OR SOD. ALLOW TWO WEEKS OR MORE AS NEEDED TO PROMOTE ROOT GROWTH AND SUSTAIN GOOD PLANT HEALTH.
 - CONTAINER ROOTBALL SOIL WILL HOLD WATER DIFFERENTLY FROM THE SITE’S NATIVE SOIL. DO NOT ALLOW SHRUB CONTAINER ROOTBALLS TO DRY OUT. KEEP CONTAINER ROOTBALLS MOIST AT ALL TIMES.
 - OBSERVE PLANTS TO MAKE SURE THAT THE PLANTS ARE ROOTING IN THE PREPARED SURROUNDING SOIL BASE AND HAVE ENOUGH MOISTURE.

IRRIGATION LEGEND

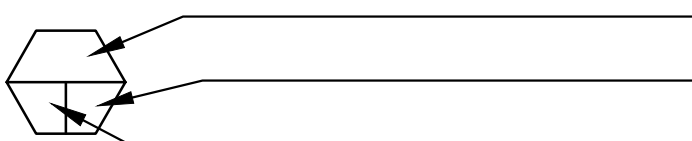SYMBOL	NUMBER	MANUFACTURER/DESCRIPTION	PSI	FLOW (GPM OR GPH)	RADIUS (MIN./MAX.)	PRECIP. RATE
TREE ROOT WATERING SYSTEM WITH SOCK						
▪	[RWS–B–C–1401]+[RWS–SOCK]	RAIN BIRD INSTALL 1 BUBBLER PER TREE, STAND–ALONE TREE AND TREE WITHIN SHRUB BUBBLER AREA	30	0.25	FLOOD	0.5 GPM
BUBBLERS						
▪	1401	RAIN BIRD BUBBLER, ONE PER SHRUB, ONE PER STAND–ALONE TREE ONLY, INSTALL AT FINISHED GRADE PER DETAIL.	30	0.25	FLOOD	0.25 GPM
VALVES						
⦿	[100DWS.IB–R(1”)]+[TW–D–1] [150DWS.IB–R(1.5”)]+[TW–D–1]	GRISWOLD REMOTE CONTROL VALVE, NORMALLY CLOSED, BRASS CONSTRUCTION, FIPT, WITH INTEGRAL UNION, BALL VALVE, AND RAINMASTER ONE STATION DECODER. (MINIMUM FLOW: 0.1 GPM)				
◆	44NP (1”)	RAIN BIRD QUICK COUPLING VALVE WITH PURPLE LOCKING RUBBER COVER				
✂	LGT22SS304X (2”)	LEEMCO 304SS GATE VALVE WITH FIPT CONNECTIONS AND CROSS TOP. SIZE GATE VALVE EQUAL TO MAIN LINE PIPE SIZE.				
CONTROLLER						
⬡E	NIC	EXISITNG CONTROLLER ASSEMBLY WITH OPEN STATIONS FOR THIS CONTRACT’S USE.				
						
CONTROLLER STATION NUMBER						
APPROXIMATE FLOW (GPM)						
REMOTE CONTROL VALVE SIZE						
SLEEVES AND PIPE						
-----		MAIN LINE: (E) IRR MAIN LINE USING WELL WATER FOR IRRIGATION.				
- - - - -		2–INCH MAIN LINE: 1120–CLASS 315 PVC PURPLE PLASTIC PIPE WITH SOLVENT WELDED CONNECTIONS. PROVIDE SCHEDULE 80 PVC PLASTIC SOLVENT WELDED FITTINGS. SOIL COVER: 18–INCH IN SOIL, 18–INCH UNDER PEDESTRIAN PAVEMENT, 24–INCH UNDER VEHICULAR PAVEMENT. SIZE AS NOTED. PROVIDE T. CHRISTY ENTERPRISES NON–POTABLE WATER DETECTABLE MARKING TAPE, TA–DT–6–BNP, PER THE SPECIFICATION, ABOVE PIPE.				
-----		LATERAL LINE: 1120–SCHEDULE 40 PVC PURPLE PLASTIC PIPE WITH SCHEDULE 40 PVC PLASTIC SOLVENT WELDED FITTINGS. 12–INCH SOIL COVER. SIZE 1–INCH UNLESS OTHERWISE NOTED.				
-----		SLEEVE: 1120–CLASS 200 OR 1120–SCHEDULE 40 PVC PLASTIC PIPE, WHICHEVER HAS THE LARGEST WALL THICKNESS, WITH SCHEDULE 40 PVC PLASTIC SOLVENT WELDED FITTINGS. SOIL COVER TO BE EQUAL TO COVER REQUIRED FOR PIPE CONTAINED WITHIN SLEEVE 18–INCH MINIMUM COVER. SIZE AS NOTED.				
~~~~~		LOW VOLTAGE CONVENTIONAL CONTROL AND COMMON WIRE ROUTE				
⬡PB		ELECTRICAL PULL BOX: RECTANGULAR 14x19 PLASTIC BOX WITH PLASTIC BOLT–DOWN LID.				

JDE

JAMES D. EDDY ASSOCIATES  
LANDSCAPE IRRIGATION ENGINEERS  
P.O. BOX 2291  
DANVILLE, CALIFORNIA 94526  
P:(925) 867-3339  
EMAIL: JDE@EDDYASSOCIATES.COM  
PLANNING-DESIGN-MANAGEMENT  
JDE PROJECT NO: 20037

IRRIGATION DESIGNER:  
*James D. Eddy*  
JAMES D. EDDY ASSOCIATES, DANVILLE, CALIFORNIA  
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ABBREVIATIONS:	
AV	AIR VALVE
CI	CAST IRON
CU	COPPER
DEG	DEGREES
DI	DUCTILE IRON
DIA	DIAMETER
ECV	EMITTER CONTROL VALVE
EFF	EFFICIENCY
ETWU	ESTIMATED TOTAL WATER USE
ETO(ET)	EVAPOTRANSPIRATION
(E)	EXISTING
(F)	FUTURE
FC	FULL CIRCLE (360°)
FT	FEET
FIPT	FEMALE IRON PIPE THREAD
FPS	FEET PER SECOND
FS	FLOW SENSOR
FV	FLUSH VALVE
GA	GAUGE
GI	GALVANIZED IRON
GV	GATE VALVE
GPH	GALLONS PER HOUR
GPM	GALLONS PER MINUTE
ID	INTERNAL DIAMETER
IN	INCHES
IRR	IRRIGATION
LA	LANDSCAPE ARCHITECT
MAWA	MAXIMUM APPLIED WATER ALLOWANCE
MAX	MAXIMUM
MCV	MASTER CONTROL VALVE
MV	MASTER VALVE
MIN	MINIMUM
MIPT	MALE IRON PIPE THREAD
MPR	MATCHED PRECIPITATION RATE
MWEL0	MODEL WATER EFFICIENT LANDSCAPE ORDINANCE
(N)	NEW
NIC	NOT IN CONTRACT
NPW	NON POTABLE WATER
NTS	NOT TO SCALE
OD	OUTSIDE DIAMETER
PC	PART CIRCLE (20°–360°)
PE	POLYETHYLENE
POC	POINT OF CONNECTION
PRECIP	PRECIPITATION
PRV	PRESSURE REDUCING VALVE
PVBA	PRESSURE VACUUM BREAKER ASSEMBLY
PSI	POUNDS PER SQUARE INCH
PVC	POLYVINYLCHLORIDE
PW	POTABLE WATER
QTY	QUANTITY
QCV	QUICK COUPLING VALVE
RCV	REMOTE CONTROL VALVE
RPBA	REDUCED PRESSURE BACKFLOW ASSEMBLY
RS	RIGID STEEL
RW	RECYCLED WATER
SCH	SCHEDULE
SF	SQUARE FOOT OR FEET
SQ	SQUARE
SS	STAINLESS STEEL
STD	STANDARD
TBD	TO BE DETERMINED
TBE	THREADED BOTH ENDS
TOE	THREADED ONE END
TYP	TYPICAL
UON	UNLESS OTHERWISE NOTED
UPC	UNIFORM PLUMBING CODE
USA	UNDERGROUND SERVICE ALERT
UV	ULTRAVIOLET
UVR	ULTRAVIOLET RESISTANT
VAC	VOLTS–ALTERNATING CURRENT
VB	VALVE BOX
WM	WATER METER



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Main:  
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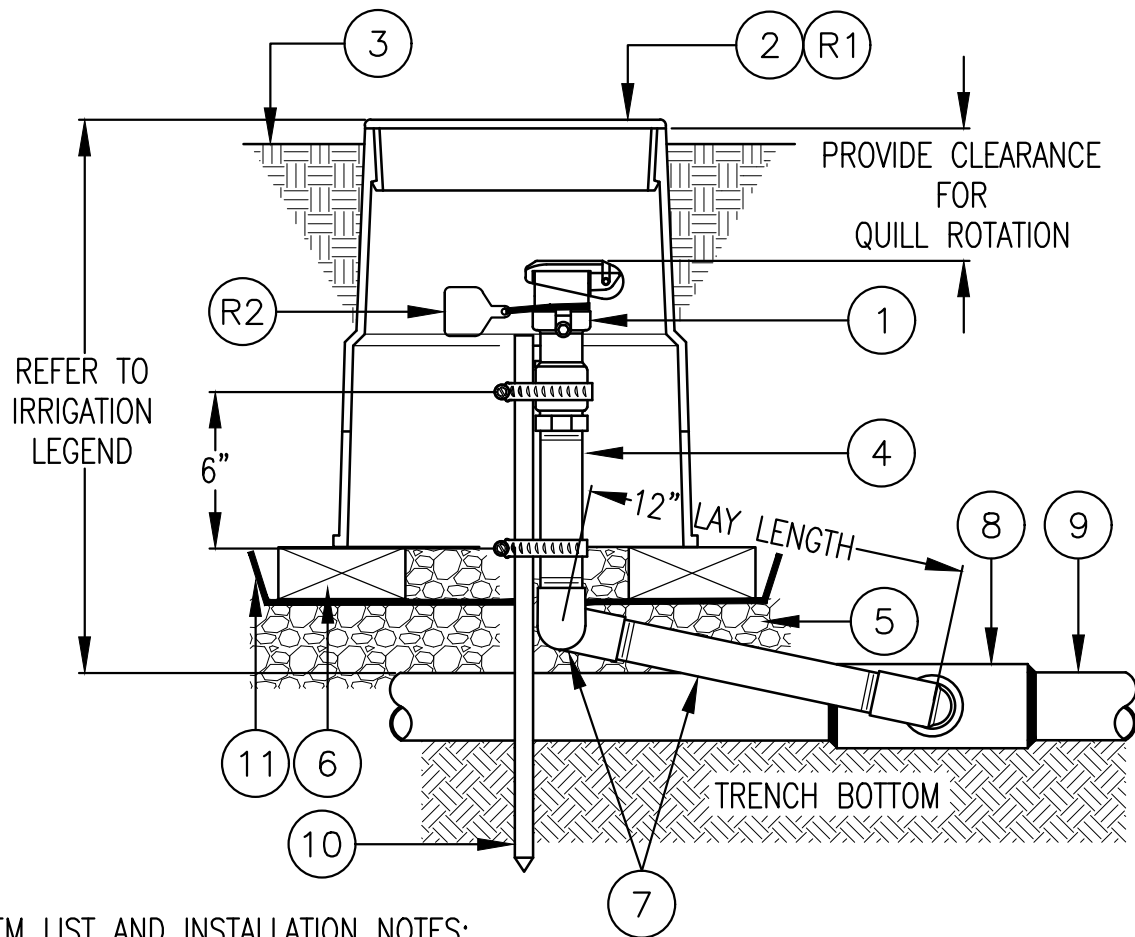
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ARCH PROJECT NO:		1869.00
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NON-POTABLE WATER ITEMS:  
R1. VALVE BOX AND LID COLOR: RECYCLED WATER PURPLE  
R2. RED WELL WATER TAG - ATTACH TO VALVE WITH A PLASTIC ZIP TIE.




ITEM LIST AND INSTALLATION NOTES:

1. QUICK COUPLING VALVE - INSTALL VALVE PERPENDICULAR TO FINISHED GRADE UNLESS FIELD CONDITIONS REQUIRE ADJUSTMENT. INSTALL IN OUT-OF-PLAY OR PEDESTRIAN ACCESS AREAS. UNLESS OTHERWISE NOTED, FITTINGS ARE THE SAME IPT SIZE AS THE VALVE IPT INLET THREAD SIZE.
2. PLASTIC VALVE BOX AND LID, 10" ROUND, BOLT-DOWN LID - INSTALL VALVE BOX FLUSH WITH FINISH GRADE IN TURF AND 1" ABOVE FINISH GRADE IN SHRUB AREAS
3. FINISH GRADE OR TOP OF MULCH
4. PVC SCH 80 NIPPLE (LENGTH AS REQUIRED)
5. CRUSHED GRAVEL BASE, 6" DEEP
6. COMMON BRICK, 2 TOTAL, 180 DEGREES APART
7. SWING JOINT ASSEMBLY:
  - A. FINGER TIGHTEN O-RING JOINTS AND BACK-OFF ONE FULL TURN TO ALLOW FOR SWING ACTION.
  - B. PROVIDE 12" BETWEEN CENTER LINES OF ELBOWS ON SWING ARM.
  - C. INSTALL THE SWING JOINT LAY ARM AT AN ANGLE BETWEEN 30° AND 45° OF THE LATERAL IN ORDER TO ABSORB DOWNWARD IMPACT.
  - D. SWING JOINT MANUFACTURER: RAIN BIRD SWJ SERIES, 1" DURA STANDARD UNI-BODY MODEL 1-A2-2-1-12, OR APPROVED EQUAL.
8. TEE, ELBOW OR SADDLE CONNECTION (PER MAIN LINE FITTING SPECIFICATIONS)
9. MAIN LINE PIPE, (MATERIAL AND TYPE PER LEGEND AND SPECIFICATIONS)
10. #4 X 24" REBAR STAKE W/STAINLESS STEEL GEAR CLAMPS OR EQUIVALENT SUPPORT SYSTEM
11. METAL WIRE MESH TO PREVENT GOPHER INTRUSION, 1/2" MESH, 19 GA, GALVANIZED


1 QUICK COUPLING VALVE IN LANDSCAPED AREAS  
NOT TO SCALE

INSTALLATION NOTES:

1. INSTALL QUANTITY OF BUBBLERS PER LEGEND, SEE SHEET L3.1.
2. INSTALL DEEP WATERING TUBE ADJACENT AND AGAINST THE ROOTBALL.

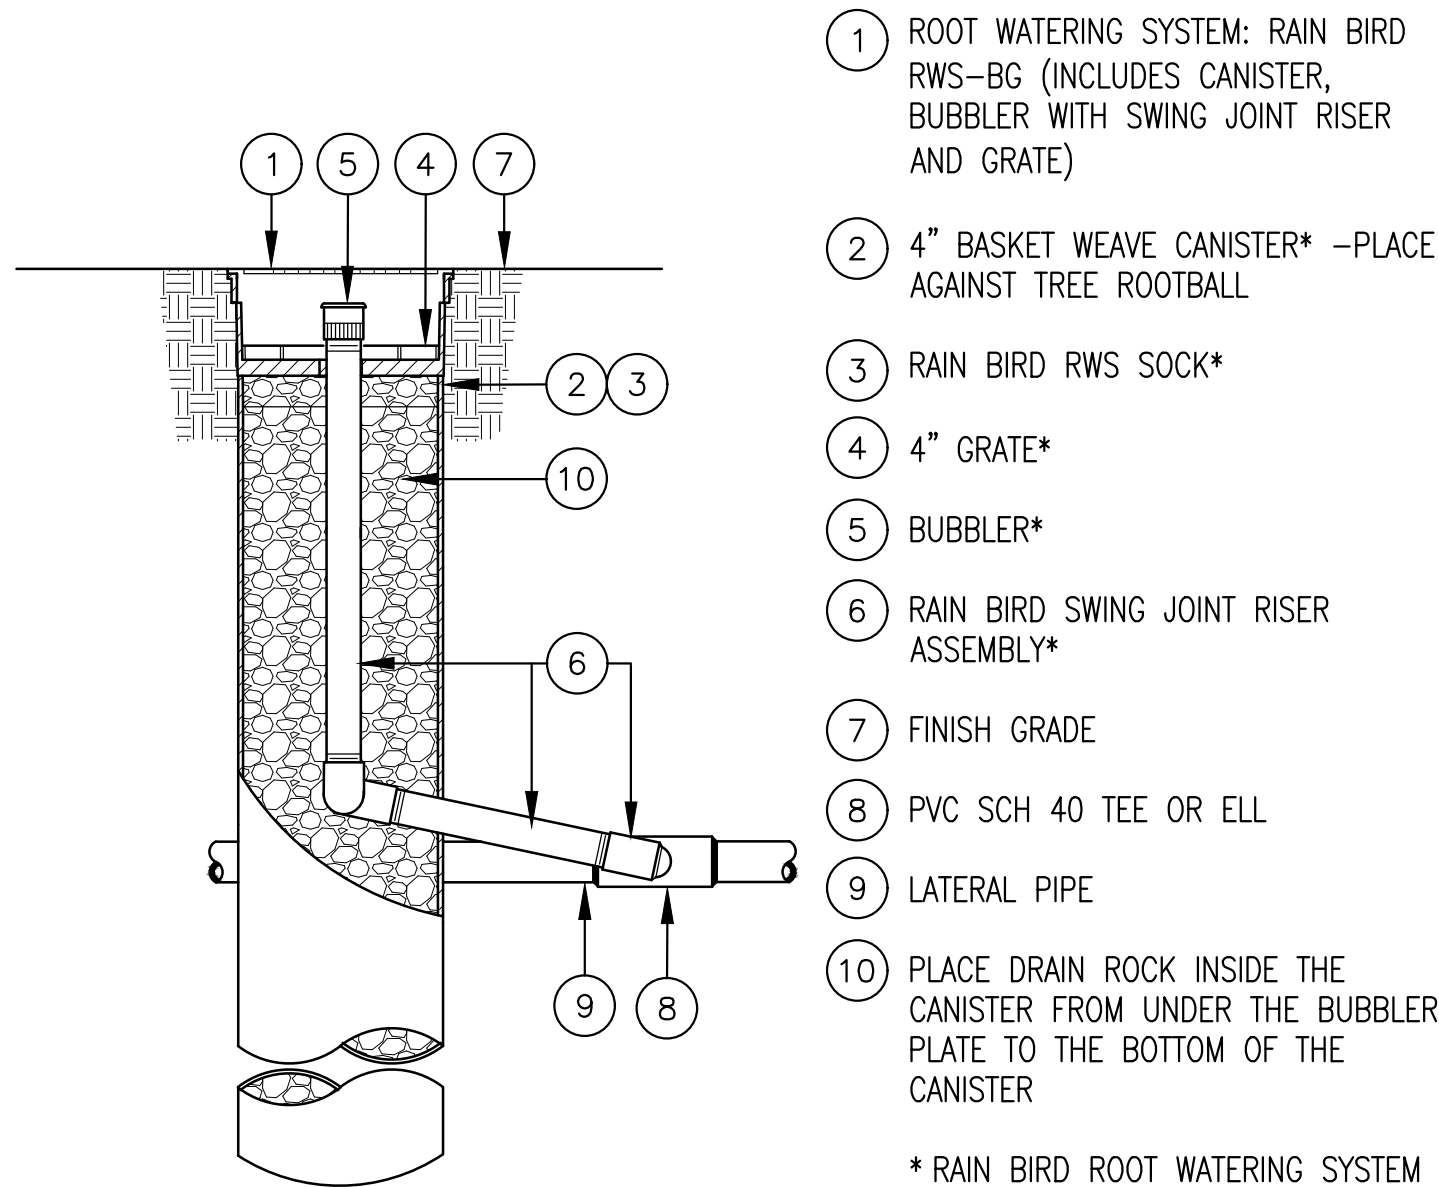


4 TREE DEEP ROOT WATERING SYSTEM  
NOT TO SCALE

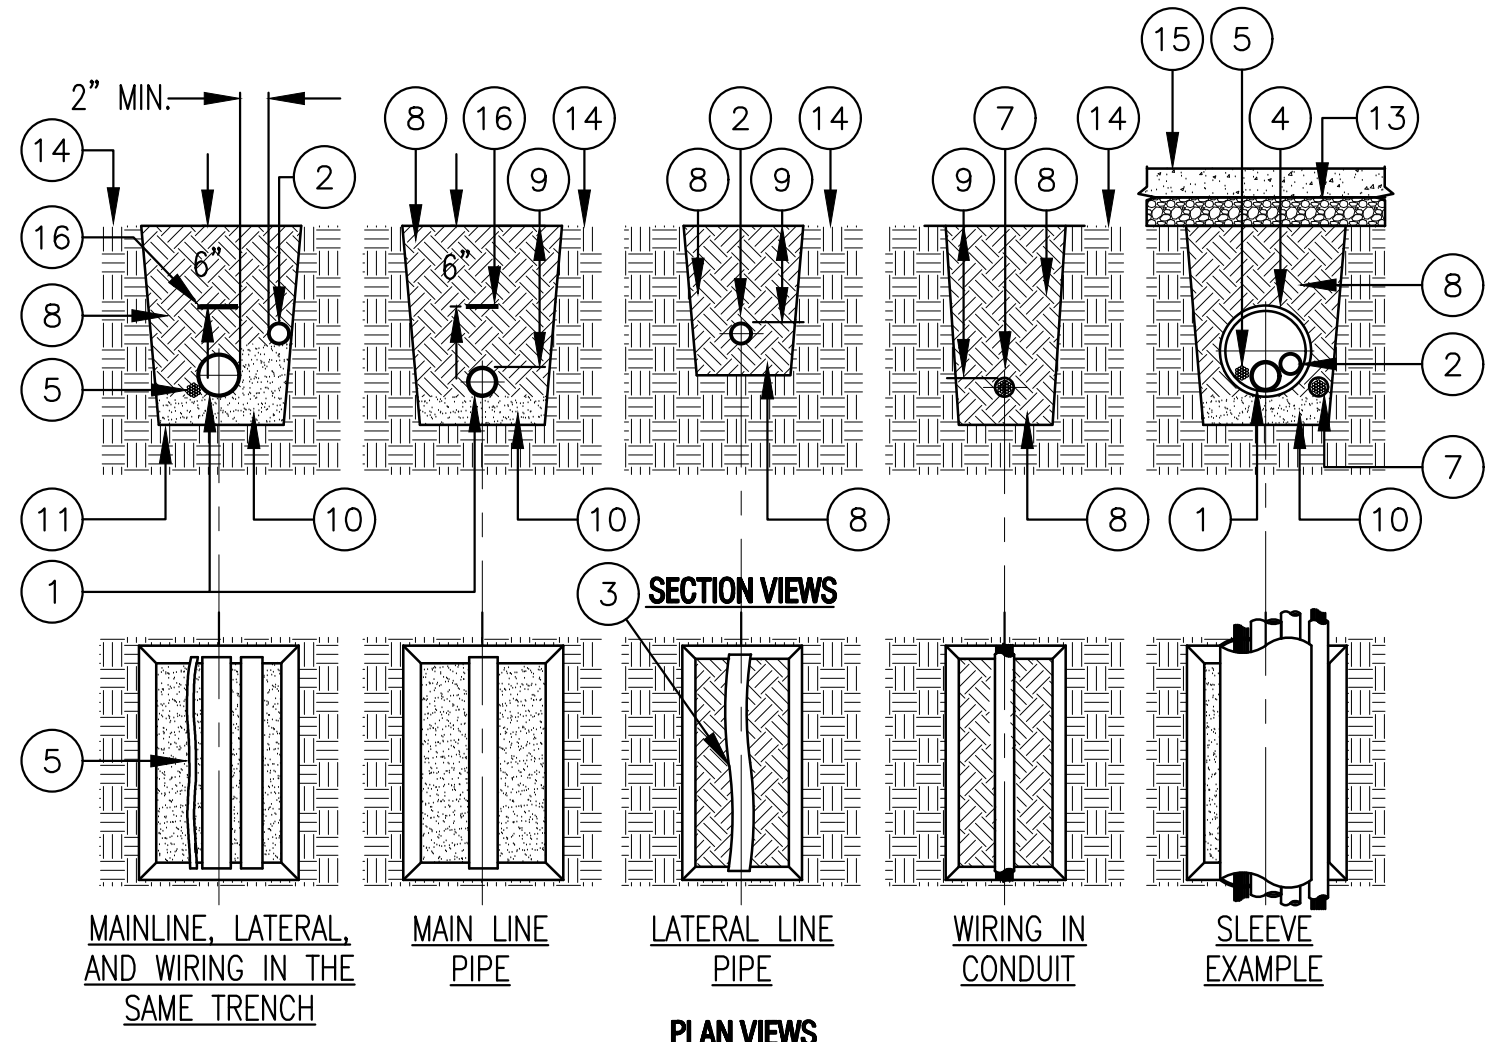

ITEM LIST AND INSTALLATION NOTES:

1. MAIN LINE PIPE; PROVIDE A MINIMUM OF 2" BETWEEN ALL PIPES.
2. LATERAL LINE PIPE; PROVIDE A MINIMUM OF 2" BETWEEN ALL PIPES.
3. SNAKE SOLVENT WELD PLASTIC PIPING IN TRENCH AS SHOWN.
4. SLEEVE BELOW ALL HARDSCAPE ELEMENTS WITH SLEEVING TWICE THE DIAMETER OF THE PIPE OR WIRE BUNDLE WITHIN.
5. WIRE BUNDLE: INSTALL WIRING BENEATH AND BESIDE MAIN LINE. TAPE AND BUNDLE AT 10-FOOT INTERVALS.
6. TIE A 24-INCH LOOP IN WIRING AT CHANGES OF DIRECTION OF 30° OR GREATER. UNTIE AFTER ALL CONNECTIONS HAVE BEEN MADE.
7. LOW VOLTAGE WIRE CONDUIT (WHERE SPECIFIED).
8. CLEAN BACKFILL PER THE SPECIFICATIONS, TYPICAL.
9. FOR PIPE, SLEEVE AND WIRE BURIAL DEPTHS, REFER TO IRRIGATION LEGEND AND SPECIFICATIONS.
10. PROVIDE A SAND BED FOR PIPE.
11. TRENCH BOTTOM OF UNDISTURBED SOIL, TYPICAL.
12. WHERE BORING UNDER EXISTING PAVEMENT IS REQUIRED - REFER TO DRAWINGS FOR SPECIFIC INFORMATION.
13. PAVEMENT AND SUBGRADE
14. FINISH GRADE
15. PAVED OR CONCRETE SURFACE
16. DETECTABLE WARNING TAPE PER SPECIFICATIONS

2 TRENCH  
NOT TO SCALE

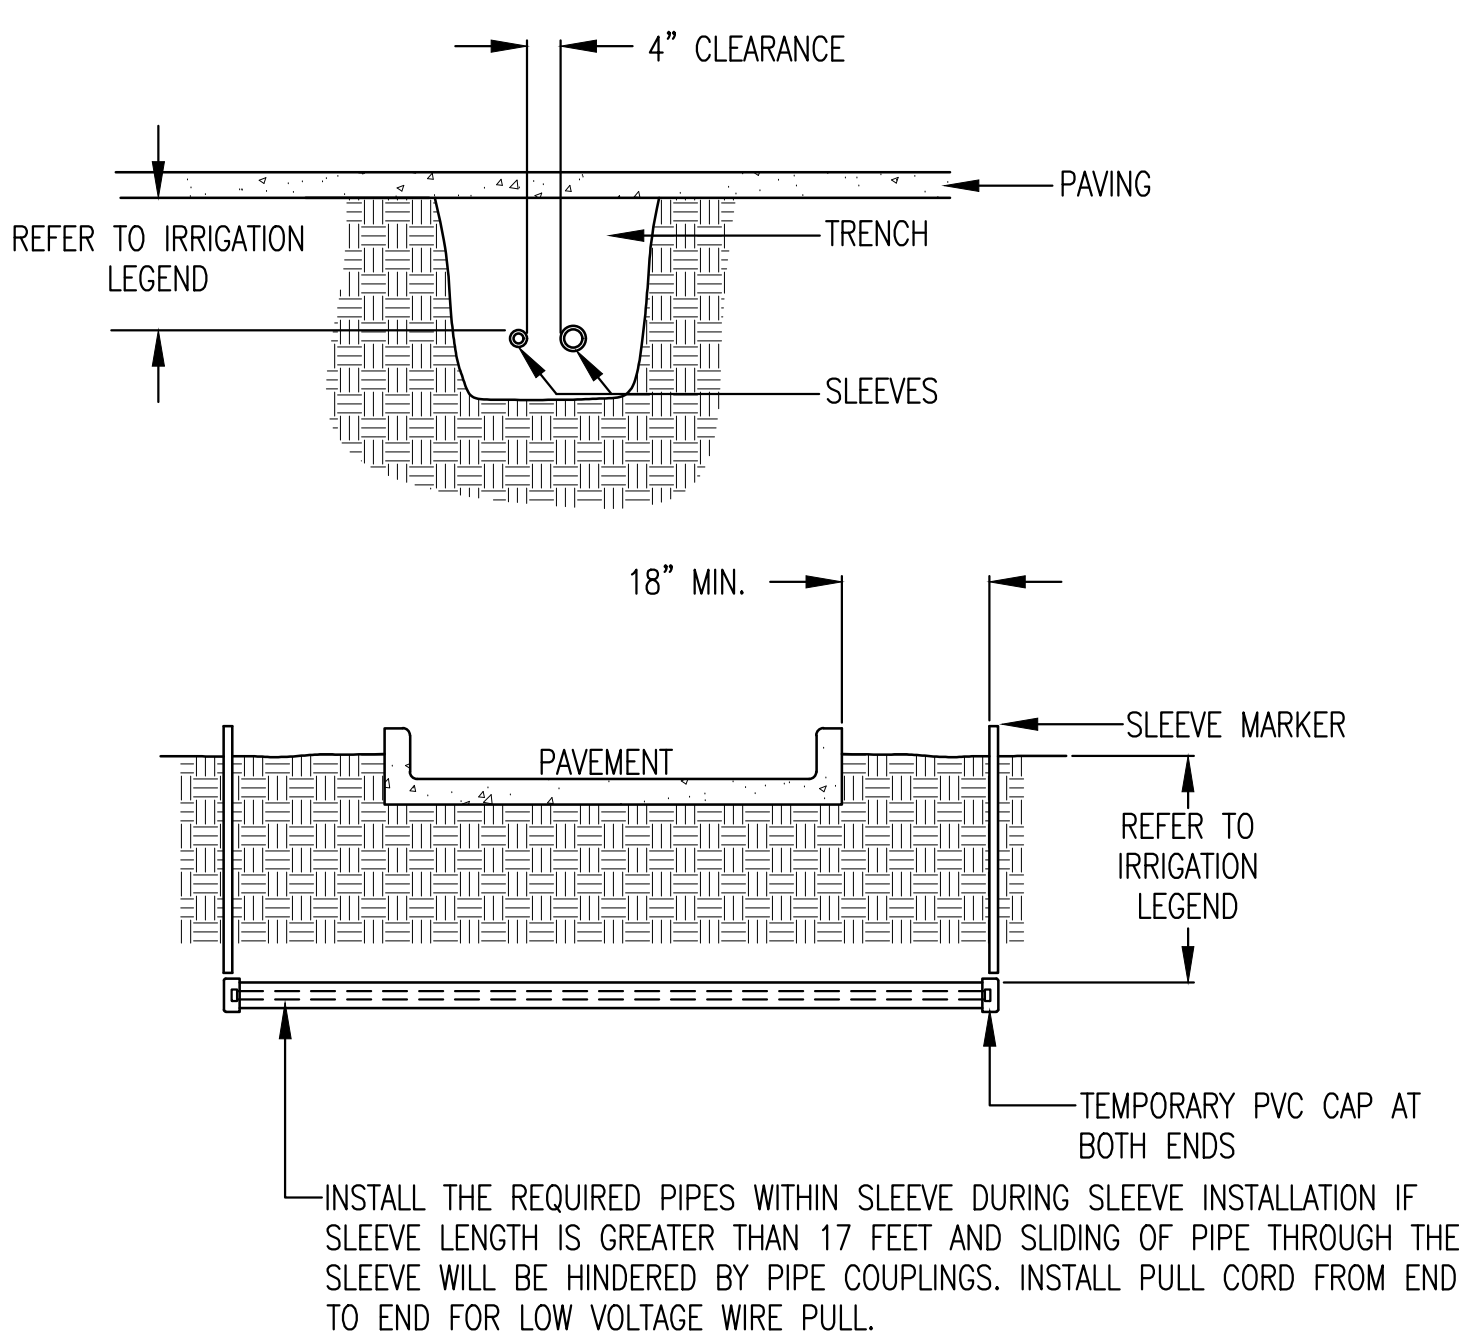


NOTES:

1. IRRIGATION SLEEVES TO BE PVC CLASS 200 OR SCH 40 PIPE. USE THE PIPE WITH THE THICKEST WALL DIMENSION.
2. JOINTS TO BE SOLVENT WELDED AND WATERTIGHT.
3. IF PIPING IS TO BE INSTALLED AFTER SLEEVING IS BACKFILLED, MARK SLEEVE LOCATION WITH A T. CHRISTY ENTERPRISES FIBERGLASS COMPOSITE MARKING POST, LABELED "IRRIGATION", EXPOSED AT GRADE, MODEL #ID-SF66-IRR.
4. MECHANICALLY TAMP BACKFILL TO 95% COMPACTION.
5. INSTALL SLEEVES LEVEL AND AFTER PIPE INSTALLATION, SEAL ENDS OF PIPE WITH GROUT TO PREVENT ROOT INTRUSION INTO THE SLEEVE.

3 SLEEVE INSTALLATION  
NOT TO SCALE

NON-POTABLE WATER ITEMS:

- R1. GREEN WELL WATER RISER MARKER - ATTACH TO FLEX RISER, USE T. CHRISTY ENTERPRISES RISER MARKER, MODEL #5200 WITH ADHESIVE BACKING.

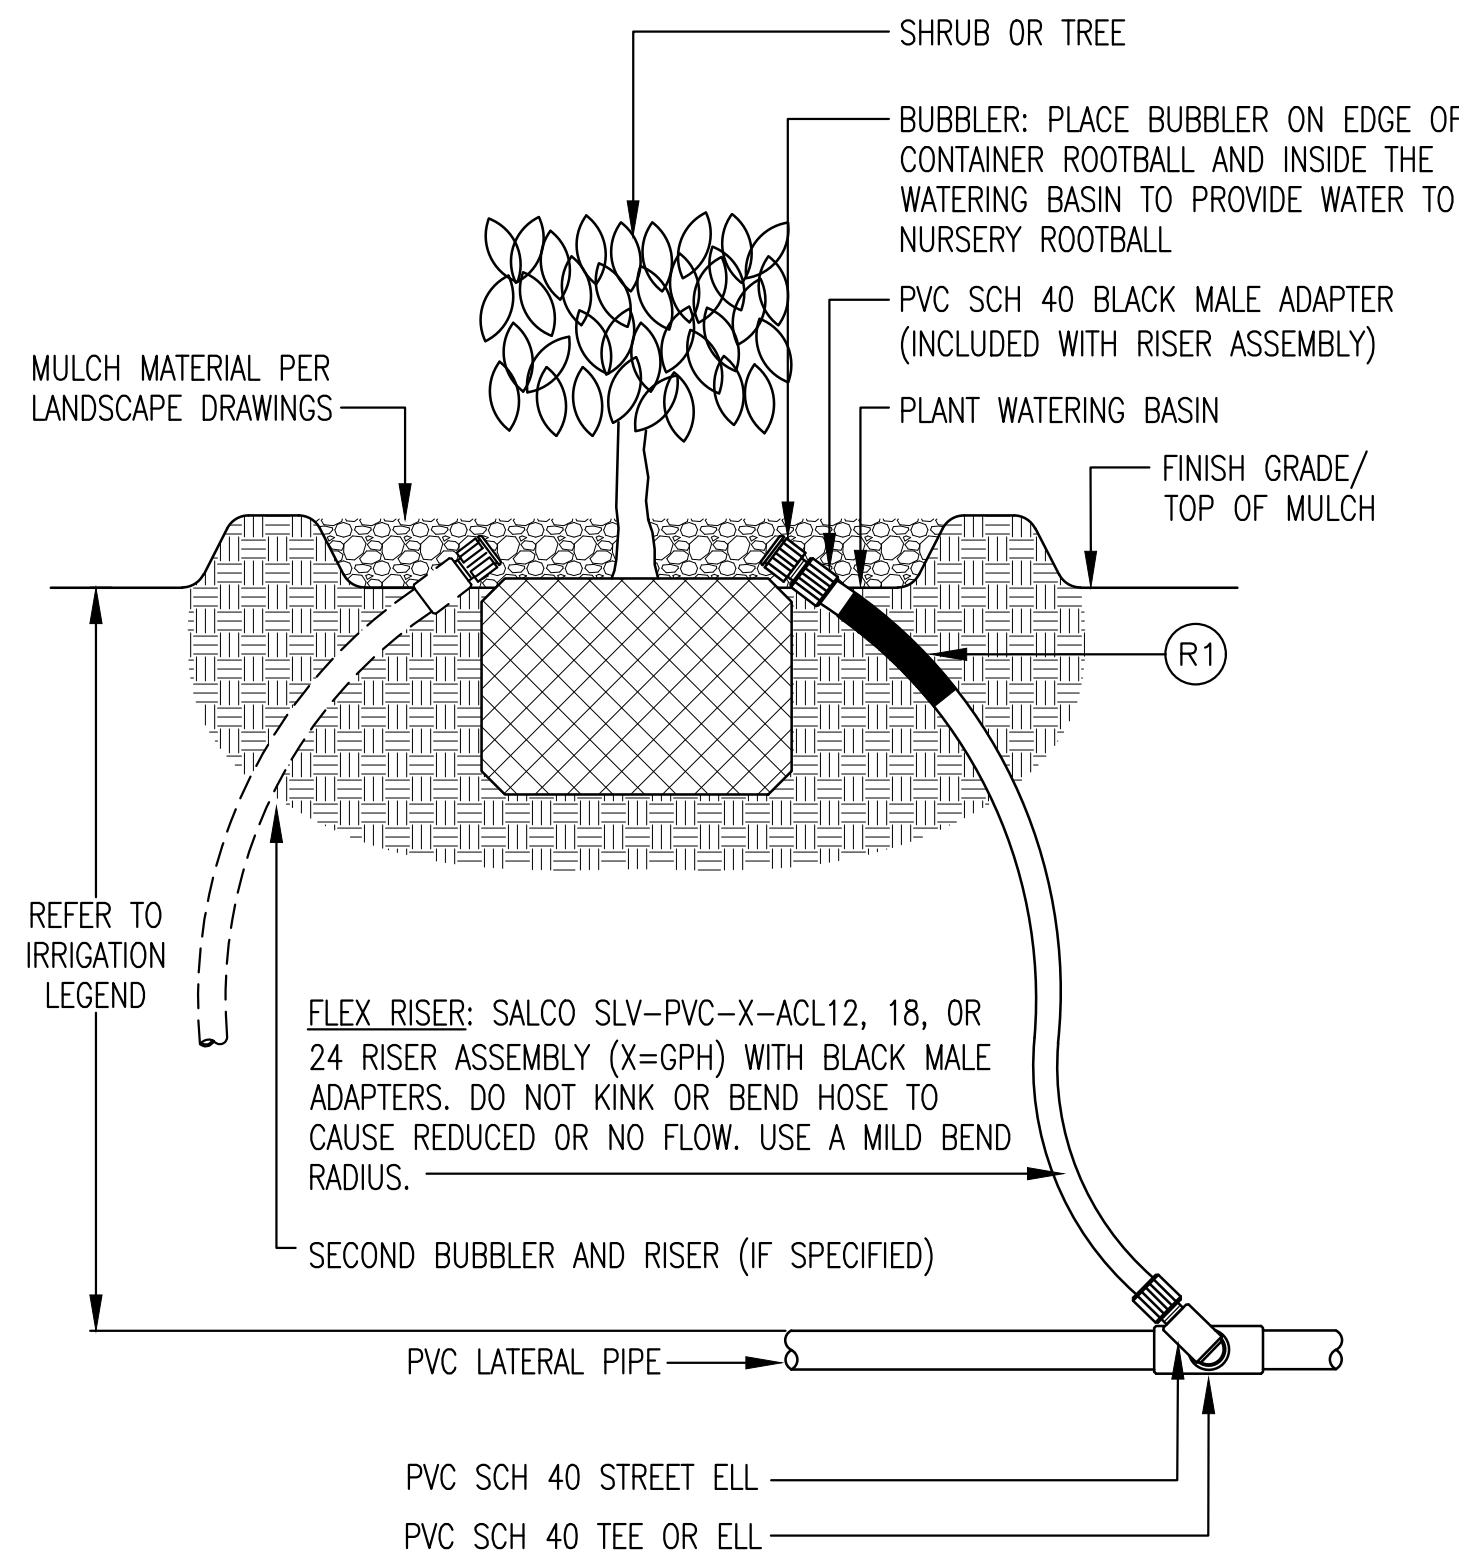

6 SHRUB OR TREE BUBBLER RISER  
NOT TO SCALE

**JDE**  
JAMES D. EDDY ASSOCIATES  
LANDSCAPE IRRIGATION ENGINEERS  
P.O. BOX 2291  
DANVILLE, CALIFORNIA 94526  
P:(925) 867-3339  
EMAIL: JDE@EDDYASSOCIATES.COM  
PLANNING-DESIGN-MANAGEMENT  
JDE PROJECT NO: 20037

IRRIGATION DESIGNER:  
*James D. Eddy*  
JAMES D. EDDY ASSOCIATES, DANVILLE, CALIFORNIA  
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**QUATTROCCHI KWOK  
ARCHITECTS**  
Main:  
636 Fifth Street, Santa Rosa, CA 95404  
East Bay:  
55 Harrison Street, Suite 525,  
Oakland, CA 94607  
(707) 576-0829

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1700 Socol Ave, Suite 23  
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**IRRIGATION  
DETAILS**



JDE

JAMES D. EDDY ASSOCIATES  
LANDSCAPE IRRIGATION ENGINEERS  
P.O. BOX 2291  
DANVILLE, CALIFORNIA 94526  
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## IRRIGATION SCHEDULES

BUBBLER IRRIGATION @ TREES – LOW WATER USE


MANUFACTURER: RAIN BIRD						TREE CANOPY(SQ.FT.): 19.6									
MODEL: RWS						SPECIES FACTOR(Kc): 0.3									
PSI: 30						MICROCLIMATE FACTOR(Kmc): 1									
GPM OF BUBBLER: 0.25						DENSITY FACTOR(Kd): 1									
NO. OF BUBBLERS: 1						IRRIGATION EFFICIENCY: 0.81									
GPM OF ALL BUBBLER(S): 0.25						SOIL INFILTRATION RATE(INCHES): 0.2									
TREE CANOPY(FT.): 5						YEAR 2 REDUCTION AMOUNT(%): 10									
	MONTH	JAN	FEB	MAR	APR	MAY	JUNE	JULY	AUG	SEP	OCT	NOV	DEC	TOTAL	
ADJUSTED ETO/MONTH(INCHES)	1.0	1.5	2.9	4.5	6.1	7.1	7.9	6.7	5.2	3.2	1.4	0.7		48.3	
ADJUSTED ETO/WEEK(INCHES)	0.2	0.3	0.7	1.0	1.4	1.6	1.8	1.5	1.2	0.7	0.3	0.2			
MINUTES PER WEEK	YEAR 1	5	7	13	19	26	30	33	28	22	14	6	3		
	YEAR 2	5	7	12	18	24	27	30	26	20	13	6	3		
DAYS PER WEEK	YEAR 1	1	1	2	2	3	3	3	3	3	2	1			
	YEAR 2	1	1	2	2	3	3	3	3	3	2	1			
MINUTES OF WATER PER DAY	YEAR 1	5	7	7	10	9	10	11	10	8	5	3	3		
	YEAR 2	5	7	7	9	9	9	10	9	8	5	3	3		
CYCLES PER DAY TO MEET SOIL INFILTRATION RATE	YEAR 1	2	2	2	3	3	3	3	3	2	2	1	1		
	YEAR 2	2	2	2	3	3	3	3	3	2	2	1	1		
MAX. RUN TIME (MINUTES) PER CYCLE	YEAR 1	3	4	4	4	3	4	4	4	4	3	3	3		
	YEAR 2	3	4	4	3	3	3	4	3	4	3	3	3		

BUBBLER IRRIGATION @ SHRUBS – LOW WATER USE

MANUFACTURER: RAIN BIRD						SHRUB CANOPY(SQ.FT.): 3.1									
MODEL: 1401						SPECIES FACTOR(Kc): 0.3									
PSI: 30						MICROCLIMATE FACTOR(Kmc): 1									
GPM OF BUBBLER: 0.25						DENSITY FACTOR(Kd): 1									
NUMBER OF BUBBLERS: 1						IRRIGATION EFFICIENCY: 0.81									
GPM OF ALL BUBBLER(S): 0.25						SOIL INFILTRATION RATE(INCHES): 0.2									
SHRUB CANOPY(FT.): 2						YEAR 2 REDUCTION AMOUNT(%): 10									
		MONTH	JAN	FEB	MAR	APR	MAY	JUNE	JULY	AUG	SEP	OCT	NOV	DEC	TOTAL
ETO/YEAR(INCHES)		1.0	1.5	2.9	4.5	6.1	7.1	7.9	6.7	5.2	3.2	1.4	0.7		48.3
ETO/MONTH(INCHES)		0.2	0.3	0.7	1.0	1.4	1.6	1.8	1.5	1.2	0.7	0.3	0.2		
MINUTES PER WEEK		YEAR 1	1	2	2	3	5	5	6	5	4	3	1	1	
		YEAR 2	1	2	2	3	5	5	6	5	4	3	1	1	
DAYS PER WEEK		YEAR 1	1	1	2	2	3	3	3	3	3	3	2	1	
		YEAR 2	1	1	2	2	3	3	3	3	3	3	2	1	
MINUTES OF WATER PER DAY		YEAR 1	1	2	1	2	2	2	2	2	2	1	1	1	
		YEAR 2	1	2	1	2	2	2	2	2	2	1	1	1	
CYCLES PER DAY TO MEET SOIL INFILTRATION RATE		YEAR 1	2	2	2	3	3	3	3	3	2	2	1	1	
		YEAR 2	2	2	2	3	3	3	3	3	2	2	1	1	
MAX. RUN TIME (MINUTES) PER CYCLE		YEAR 1	1	1	1	1	1	1	1	1	1	1	1	1	
		YEAR 2	1	1	1	1	1	1	1	1	1	1	1	1	

BUBBLER IRRIGATION @ SHRUBS – MEDIUM WATER USE

MANUFACTURER: RAIN BIRD						SHRUB CANOPY(SQ.FT.): 3.1								
MODEL: 1401						SPECIES FACTOR(Kg): 0.5								
PSI: N/A						MICROCLIMATE FACTOR(Kmc): 1								
GPM OF BUBBLER: 0.25						DENSITY FACTOR(Kd): 1								
NUMBER OF BUBBLERS: 1						IRRIGATION EFFICIENCY: 0.81								
GPM OF ALL BUBBLER(S): 0.25						SOIL INFILTRATION RATE(INCHES): 0.2								
SHRUB CANOPY(FT.): 2						YEAR 2 REDUCTION AMOUNT(%): 10								
	MONTH	JAN	FEB	MAR	APR	MAY	JUNE	JULY	AUG	SEP	OCT	NOV	DEC	TOTAL
ETO/YEAR(INCHES)	1.0	1.5	2.9	4.5	6.1	7.1	7.9	6.7	5.2	3.2	1.4	0.7		48.3
ETO/MONTH(INCHES)	0.2	0.3	0.7	1.0	1.4	1.6	1.8	1.5	1.2	0.7	0.3	0.2		
MINUTES PER WEEK	YEAR 1	2	2	4	5	7	8	9	8	6	4	2	1	
	YEAR 2	2	2	4	5	7	8	9	8	6	4	2	1	
DAYS PER WEEK	YEAR 1	1	1	2	2	3	3	3	3	3	3	2	1	
	YEAR 2	1	1	2	2	3	3	3	3	3	3	2	1	
MINUTES OF WATER PER DAY	YEAR 1	2	2	2	3	3	3	3	3	2	2	1	1	
	YEAR 2	2	2	2	3	3	3	3	3	2	2	1	1	
CYCLES PER DAY TO MEET SOIL INFILTRATION RATE	YEAR 1	2	2	2	3	3	3	3	3	2	2	1	1	
	YEAR 2	2	2	2	3	3	3	3	3	2	2	1	1	
MAX. RUN TIME (MINUTES) PER CYCLE	YEAR 1	1	1	1	1	1	1	1	1	1	1	1	1	
	YEAR 2	1	1	1	1	1	1	1	1	1	1	1	1	

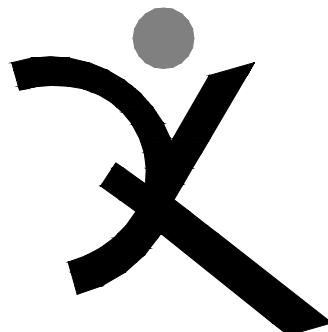

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ARCH PROJECT NO: 1869.00

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DRAWING SCALE: 1"=20'-0"

PTN: 61721-0068 FILE NO: 7-H4

BID DOCUMENT

APRIL 27, 2021


SHEET TITLE

IRRIGATION  
SCHEDULES

SHEET NUMBER

L3.4




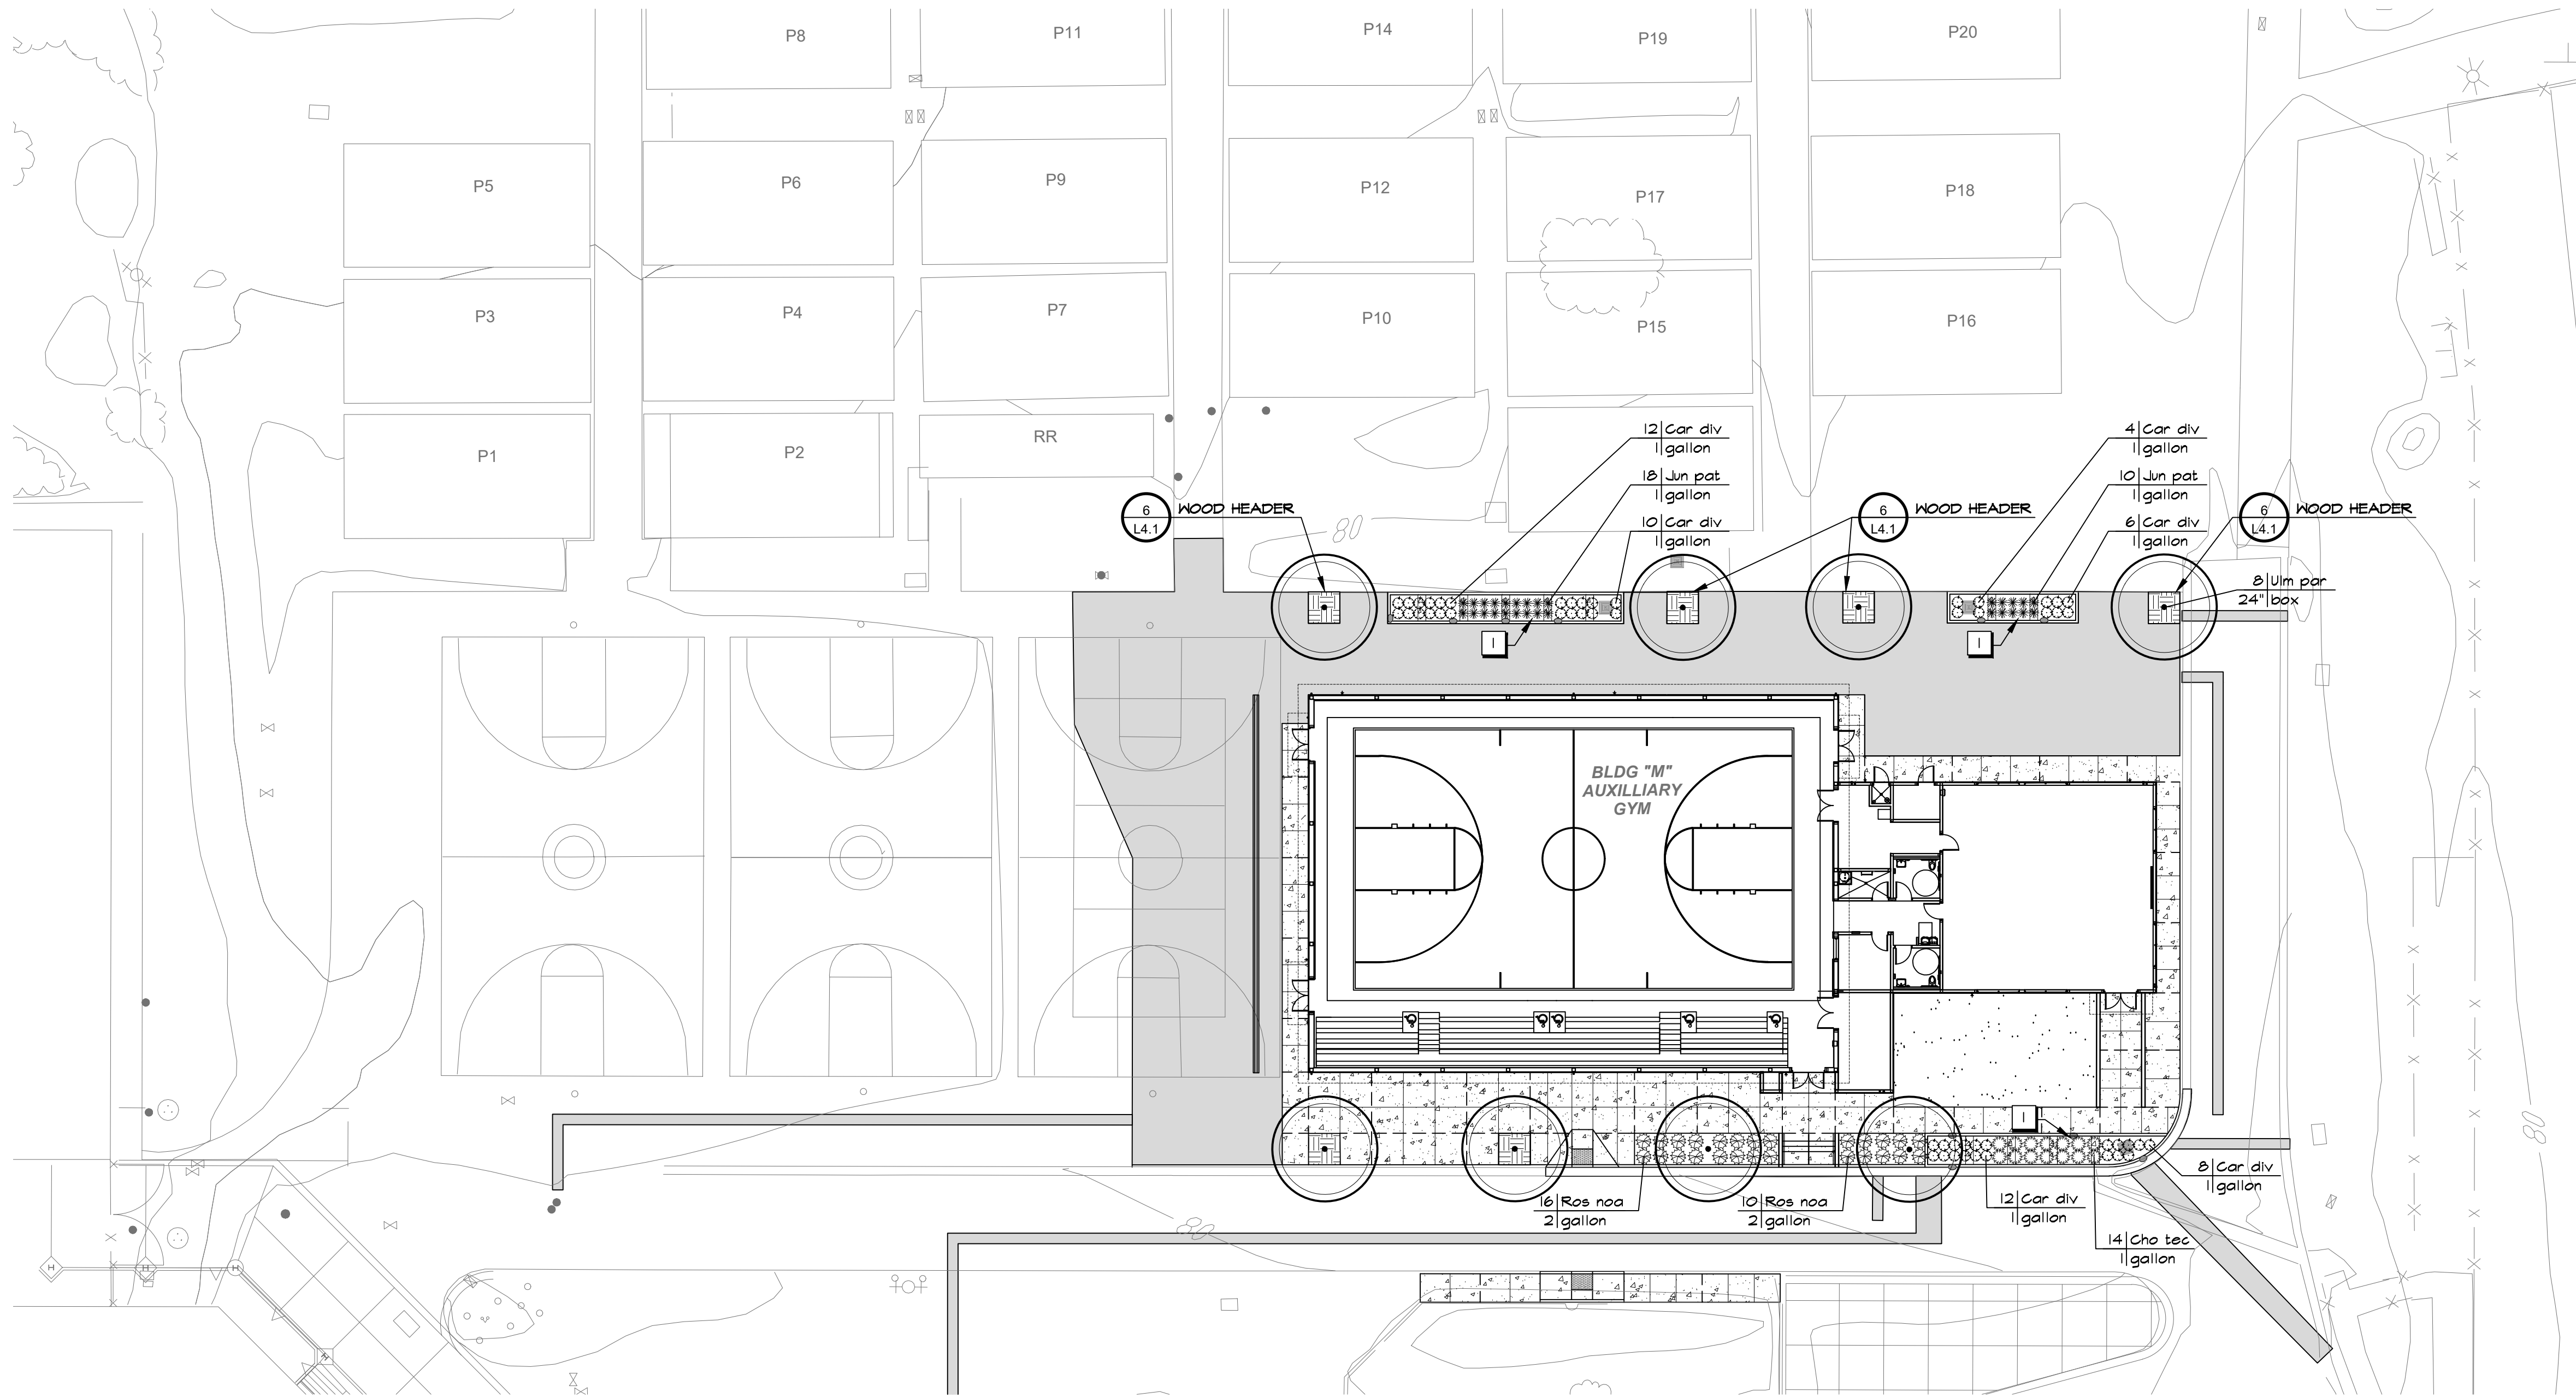





## KEY NOTES

1 Biofiltration Facilities. See Civil Drawings.

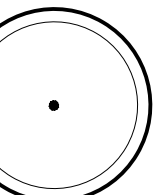
## PLANT LEGEND

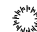SYMBOL	BOTANICAL NAME COMMON NAME		SIZE	WATER USE	QUANTITY
TREES					
	Ulm par	Ulmus parvifolia 'True Green' True Green Chinese Elm, Semievergreen	24" box	L	8
SHRUBS					
	Ros noa	Rosa 'Noaschnee' White Flower Carpet Rose	2 gallon	M	26
BIOFILTRATION FACILITIES					
	Car div	Carex divisa Berkeley sedge	1 gallon	L	52
	Cho tec	Chondropetalum tectorum Cape Rush	1 gallon	L	14
	Jun pat	Juncus patens California Gray Rush	1 gallon	L	28

## LANDSCAPE MATERIALS




Synthetic Turf. See Material and Detail Reference Plan.

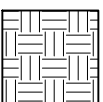

Landscape Mulch: Weed fabric and 3" thick mulch (shown graphically for areas not planted). All planting areas shall have weed fabric and 3" depth of mulch applied. See Planting Notes on L4.1 for mulch type.

Existing features and topographic information have been taken from a Survey provided by CBS, dated September 17, 2020. GSM landscape architects, inc. assumes no liability, real or alleged, regarding the accuracy of existing features or topographic information shown.

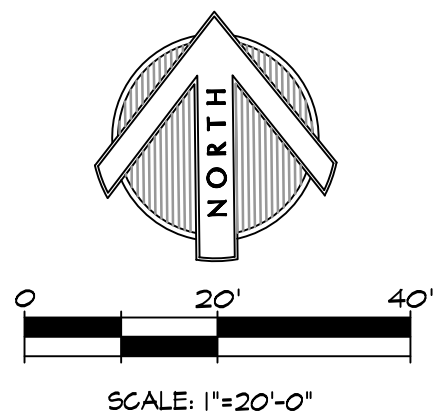

QUATTROCCHI KWOK  
ARCHITECTS  
Main:  
636 Fifth Street, Santa Rosa, CA 95404  
East Bay:  
55 Harrison Street, Suite 525,  
Oakland, CA 94607  
(707) 576-0829

GSM landscape architects, inc.  
1700 Sonoma Ave. Suite 23  
Napa, CA 94559  
707-255-4630  
www.gsmmainc.com



## FREEDOM HIGH SCHOOL

## NEW AUXILIARY GYMNASIUM

1050 NEROLY RD,  
OAKLEY, CA 94561

## LIBERTY UNION HIGH SCHOOL DISTRICT

REVISIONS	

DSA APP NO. 01-119278  
ARCH PROJECT NO. 1869.00  
DRAWN BY: BTI, HDJ  
DRAWING SCALE: 1"=20'-0"  
PTN: 61721-0068 FILE NO: 7-H4

## BID DOCUMENT

APRIL 27, 2021

SHEET TITLE

## PLANTING PLAN

SHEET NUMBER

# L4.0



1. Prior to commencement of planting, the Contractor shall verify locations of all underground utilities.
2. Contractor shall adjust all plant material around electrical utilities, valve boxes, etc., as required in the field.
3. All landscape grades shall be smooth and feathered in appearance.
4. Irrigation system shall be fully operational prior to planting. Contractor shall thoroughly water all plants immediately after planting.
5. All trees shall be staked and installed per planting details. All trees shall be of adequate trunk caliper to stand without support.
6. Installing Contractor shall verify existing grade in the field prior to planting. Finished surfaces shall be uniform and smooth. Finished grade of planting and bark mulch areas shall be flush with top of edging, pavement and walks.
7. Soil for all exposed soil and planting areas except sod and bioretention areas shall receive weed fabric and a 3" minimum depth of bark mulch. Bark mulch shall be Eco-Mini Natural Mulch, as available through EcoMulch, 5010 Pacheco Blvd., Martinez, (425) 228-1673. Bioretention areas shall receive 3" minimum depth of the compost used in the bioretreatment soil mix.
8. All trees planted within 5' of adjacent paving, curbing, hardscape, water meters, joint trenches, etc., shall receive Deep Root Barrier UB 24-2 (24" depth x 10' min. length) as manufactured by Deep Root Partners (800) 458-7668, or approved equal.
9. No plant material shall be substituted without prior written consent from the Landscape Architect.
10. Contractor shall be responsible for the pre-ordering of all plant material after the Notice to Proceed. Photographs for all plants shall be submitted to the Landscape Architect prior to placing order.
11. All plant material shall be certified by the Agricultural Commissioner inspection program for freedom from the glassy winged sharpshooter or other pests identified by the Agricultural Commissioner. The Agricultural Commissioner's office shall be notified of all impending deliveries of live plants with points of origin outside of the County so that inspection can be arranged.
12. All plants of the same type and container size shall be matched in height and width.
13. The Plant Legend is provided for convenience only, not accurate bidding purposes. Graphic depiction of plant material shall take precedence over stated quantities. Contractor shall notify the Architect to obtain clarification if there are discrepancies.

The following organic amendments, soil amendments and fertilizer rates and quantities shall be used for big basis only. Contractor shall arrange and pay for soil fertility testing by an accredited soils laboratory of existing site after thorough grading operations are complete, and shall amend the soils, according to said laboratory's recommendations. The soils recommendations shall be considered a part of these contract documents. The soils report must provide the following information:


1. Soil permeability rate in inches per hour.
2. Soil texture test.
3. Cation exchange capacity.
4. Soil fertility, including test for nitrogen, potassium, phosphorus, pH, organic matter and specific conductance (electrical conductivity).
5. Recommendation for amendments to the planting area soil.

B. Topsoil: All landscape areas shall have a minimum 8" depth of topsoil with greater depths as required for planting work. Contractor shall provide topsoil which is fertile and friable, possessing characteristics of representative productive soils on the site. It shall not contain toxic substances which may be harmful to plant growth. When herbicide contamination is suspected then a radish/rye grass growth trial must be performed. Consult with the District prior to decision to test. It shall be uniformly textured and free of all objectionable foreign materials, oil or chemicals which may be injurious to plant growth. The topsoil shall possess a pH factor between 5.5 and 7.5, a sodium adsorption ratio (SAR) of less than 2, a boron concentration of the saturation extract of less than 1 ppm, and salinity of the saturation extract at 25 degrees C, of less than 4.0 millimhos per centimeter. If required to import topsoil, Contractor shall obtain topsoil from naturally well-drained sites where topsoil occurs in a depth of not less than four inches (4"); do not obtain from bogs or marshes.

C. Organic Amendment: Nitrified fir bark having a minimum organic content of 94% and a nitrogen content of 0.8% minimum to 1.2% maximum on a dry weight basis. Fir bark shall be shredded to pass a one quarter inch (1/4") mesh screen. Incorporate organic amendment and fertilizer into the soil to a minimum depth of six inches (6") at a minimum rate of six cubic yards (6 cu yd) per one thousand square feet (1,000 sf) or per specific amendment recommendations from the soils report.

D. Fertilizer: Fertilizer shall be a commercial inorganic fertilizer in the granular or pelleted form. Fertilizer shall be delivered to the site in containers labeled in accordance with the applicable State of California regulations, bearing the warranty of the producer or the grade furnished, and shall be uniform in composition, dry and free-flowing.

1. Turf, Shrubs and Vines:
  - a. 6N-20P-20K, and 16-6-6, pelleted type.
  - b. Sulphate - sulphur
  - c. Lime for pH adjustment of moderately acid soil
  - d. Starting one (1) month after planting, on a monthly basis, 21N-0P-0K Ammonium sulfate. 5 lbs. per 1,000 square feet.
2. Trees:
  - a. 21 gram 20N-10P-5K slow release fertilizer tablets as manufactured by Agriform. Apply according to manufacturer's instructions.
  - b. After planting: 21N-0P-0K Ammonium sulfate 5lbs. per 1,000 square feet.

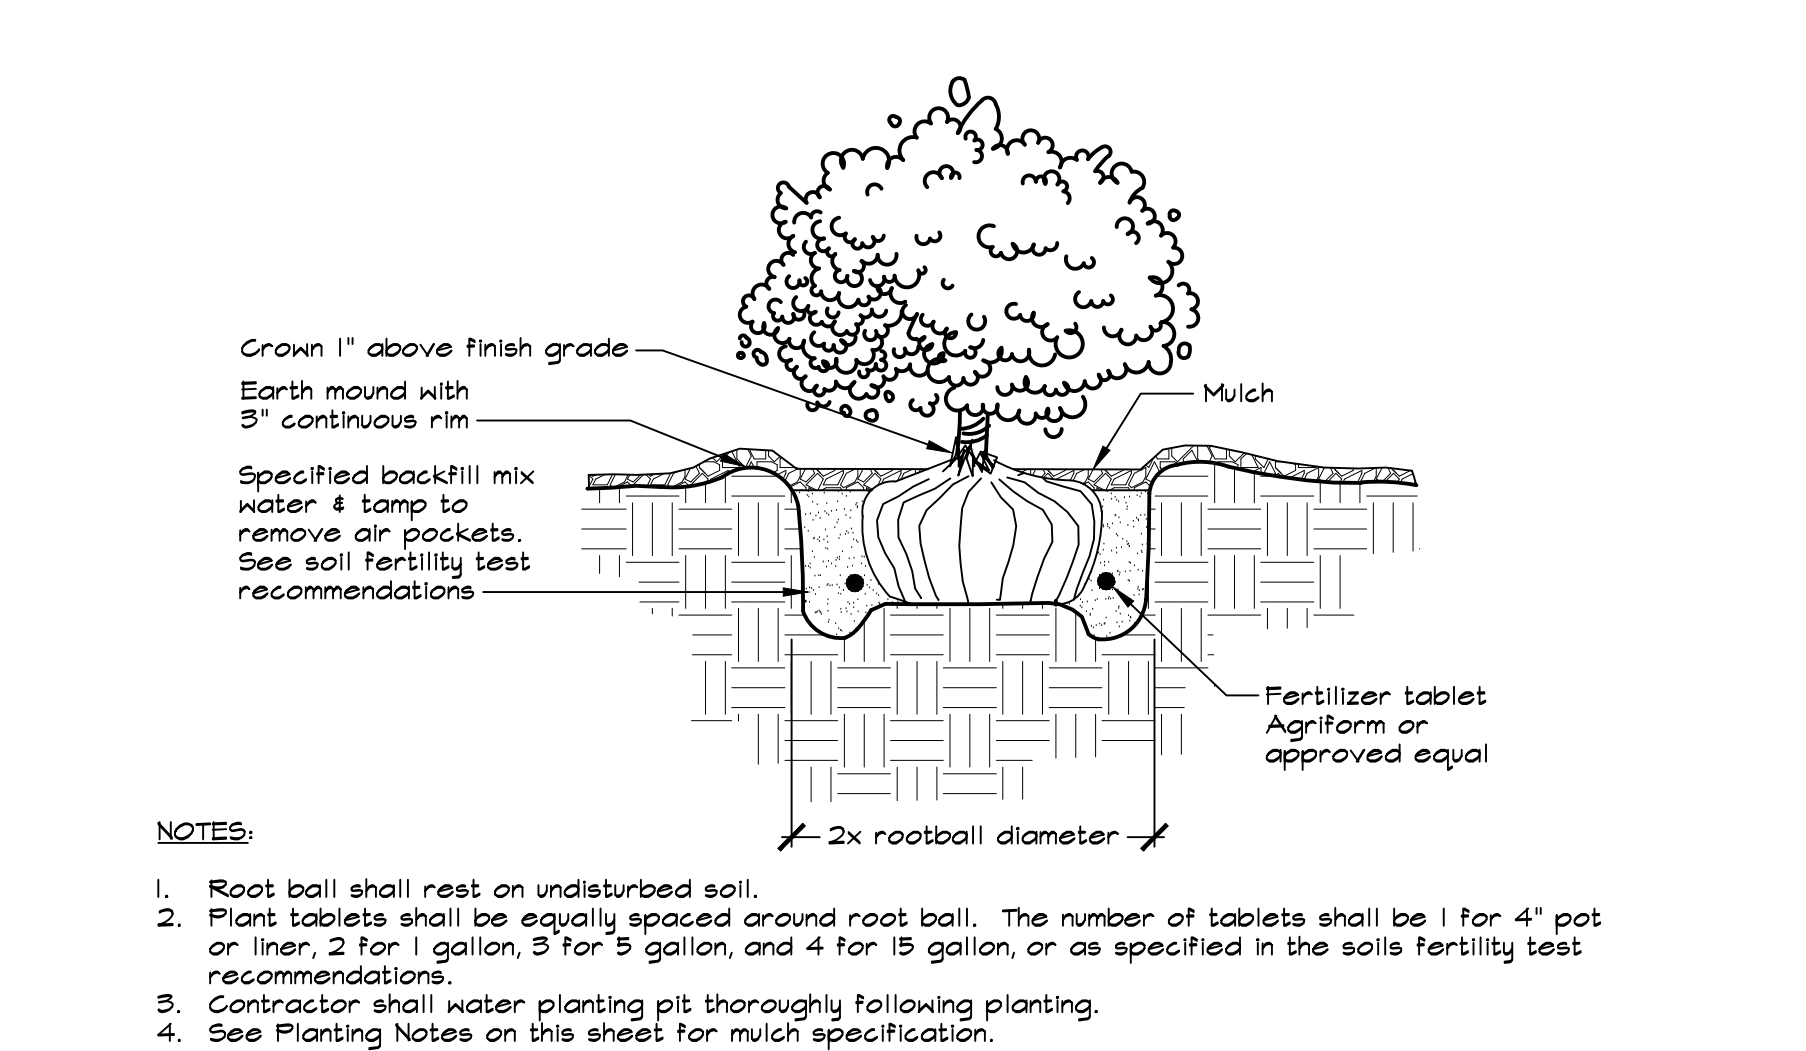

Prevailing Wind →

Tree, as specified on Planting Plan

Tree Ties, typ. - 30" Rubber tree straps model #R030, available from Horizon, or approved equal

Secure tree 6" to 12" above lowest point necessary to keep tree upright, and top of stake cut off no more than 3" above the highest tie

3" High, continuous watering basin

2x root ball width

Mulch

Tree Stakes, typ. - (2) 3" poplar cone, minimum 12' in length. Quantity, diameter and length shall be increased as necessary to securely support the tree in an upright manner

Deep root control barrier where trees are planted within 8' of adjacent hardscape, water meters, joint trenches, etc.

Native soil


See soils fertility test for backfill mix specification

Fertilizer tablet Agriform or approved equal

**NOTES:**

1. Grading shall provide for natural runoff of water without low spots or pockets.
2. See Planting Notes on this sheet for mulch specification.

---

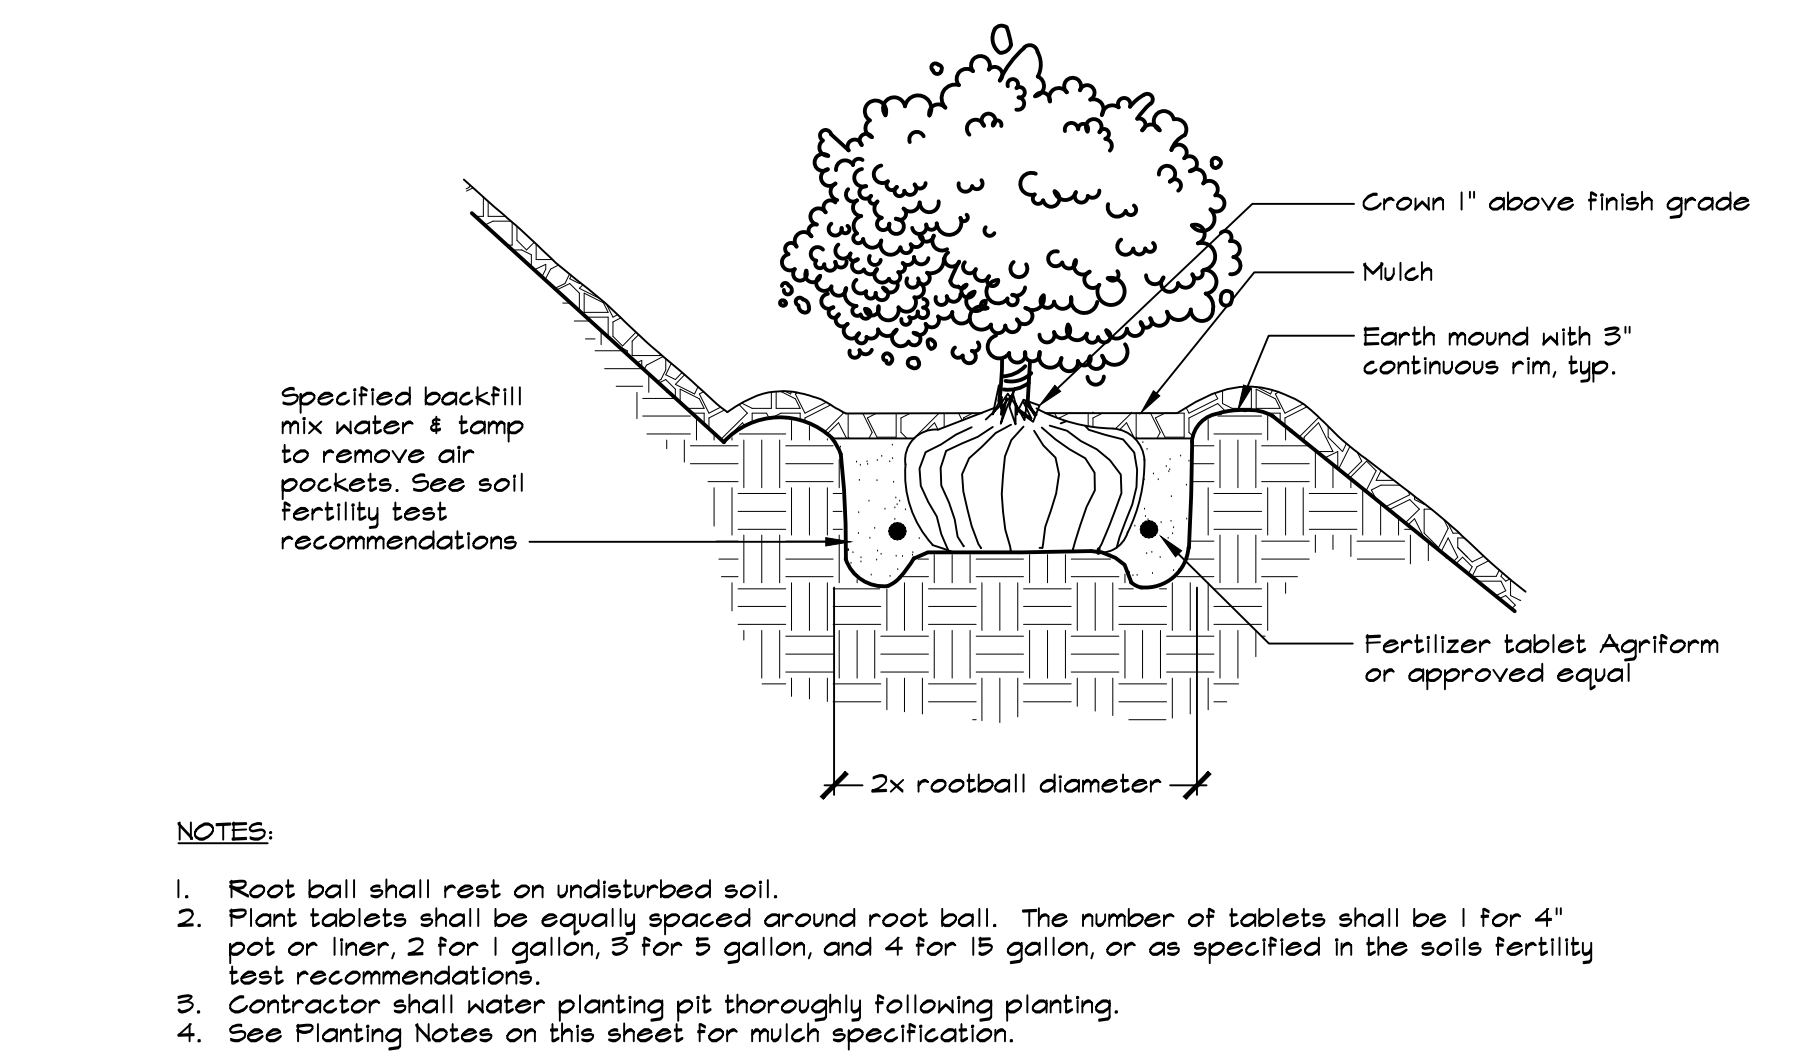

**SECTION**

**PLAN**

Finish grade. See Material and Detail Reference Plan for adjacent conditions, typ.

2 1/2" Long galvanized screw. 3 per stake

2"x4"x10" Stake. Contractor shall fabricate from 2"x4" Redwood

Redwood header

Finish grade. See Material and Detail Reference Plan for adjacent conditions, typ.

3" overlap, min.

Redwood header - 2"x4" at straight sections, 3-ply benderboard at curved sections with joints staggered by a minimum of 12"

2"x4"x10" Redwood stake

2 1/2" Long galvanized screw. Install 3 per stake

**NOTE:**

1. Wood header and stakes shall be Redwood Construction Heart or better, PC 8000X88 89A9.

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1050 NEROLY RD,  
OAKLEY, CA 94561

[illegible]

DSA APP NO. 01-119278

ARCH PROJECT NO: 1869.00

DRAWN BY: BTI, HDJ

**DRAWING SCALE:** 1"=20'-0"

PIN: 61721-0068 FILE NO: 7-114


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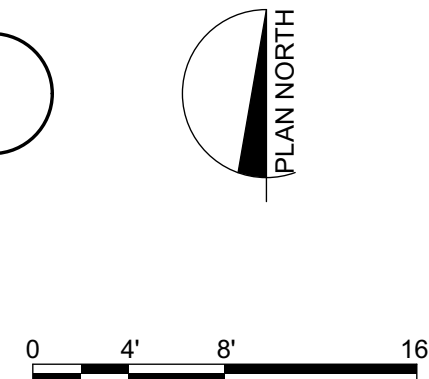
SHEET NUMBER

## L4.1





FLOOR PLAN 1  
1/8" = 1'-0"

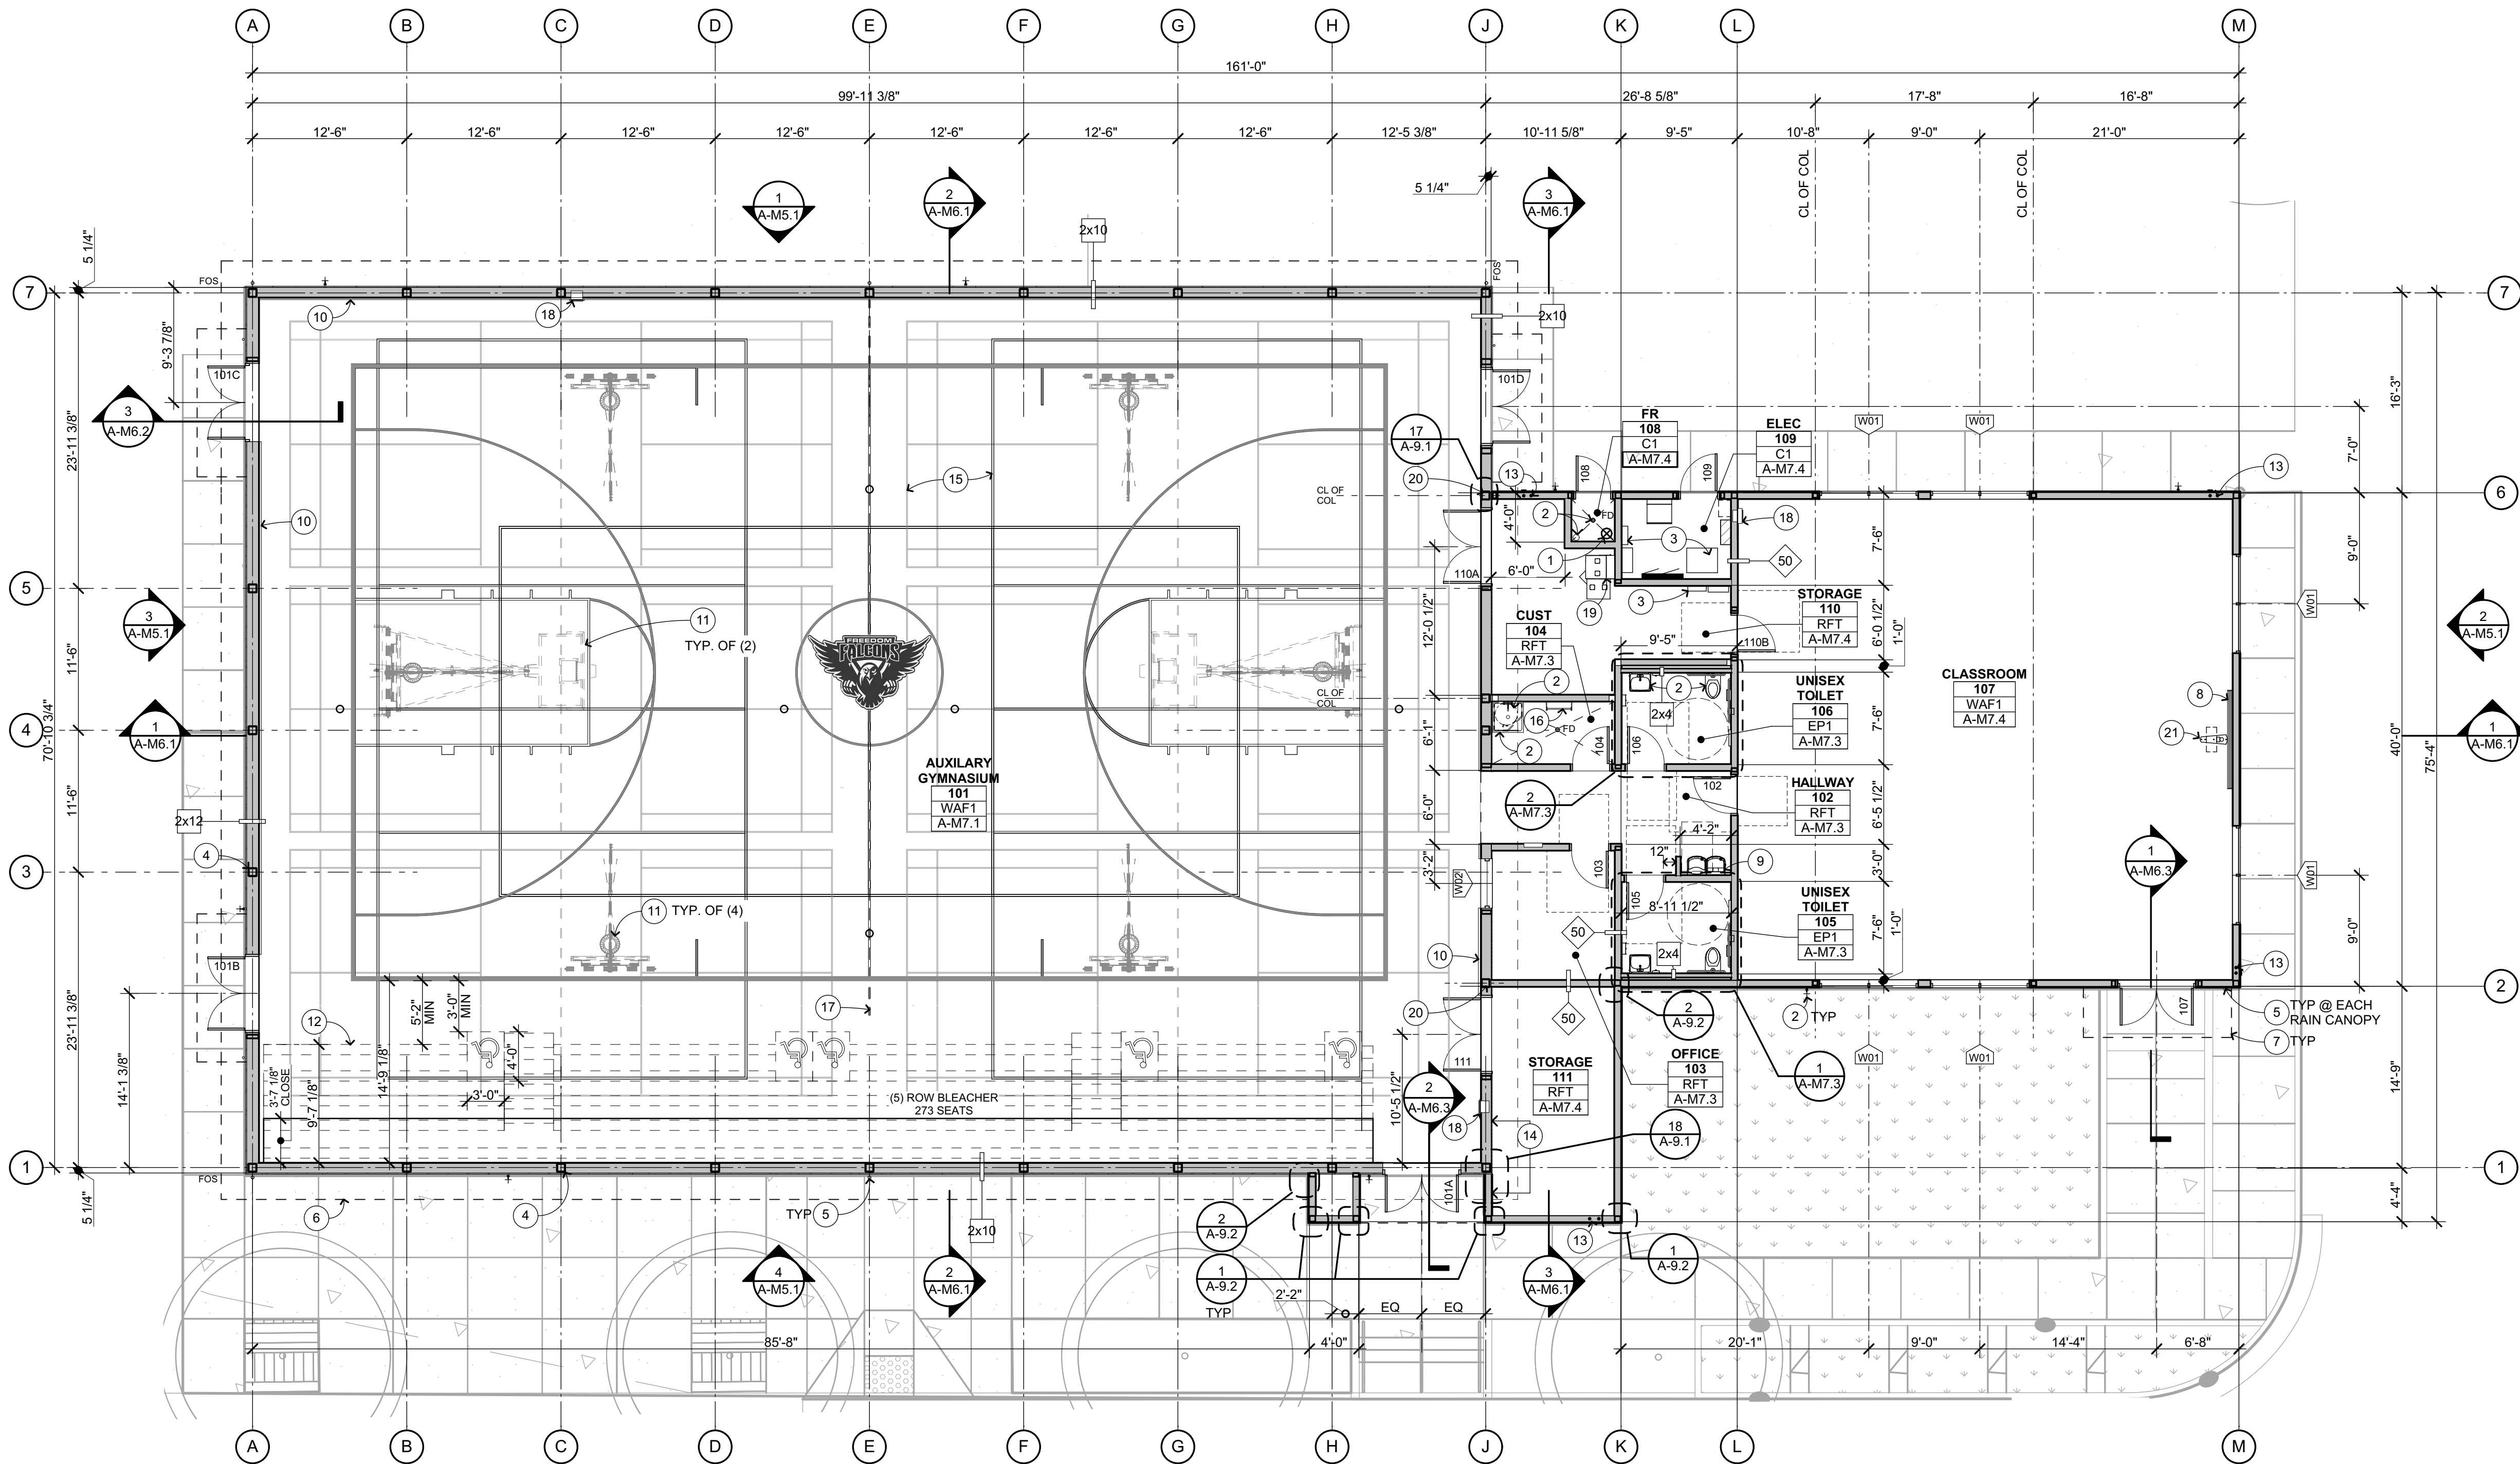

### FLOOR PLAN KEYNOTES

- 1 FIRE SPRINKLER RISER, S.P.D. & S.F.D.
- 2 PLUMBING ITEM / FIXTURE, S.P.D.
- 3 ELECTRICAL ITEM, S.E.D.
- 4 STRUCTURAL ITEM, S.S.D.
- 5 RAIN WATER LEADER S.C.D.
- 6 LINE OF ROOF, SEE ROOF PLAN
- 7 LINE OF RAIN CANOPY ABOVE
- 8 MARKER BOARD
- 9 ACCESSIBLE HIGH/LOW DRINKING FOUNTAIN WITH BOTTLE FILLER, S.P.D.
- 10 6'-0" WALL PADS, SEE INTERIOR ELEVATIONS
- 11 MOTORIZED RETRACTABLE BASKETBALL EQUIPMENT ABOVE. FOR SUPPORT S.S.D.; FOR POWER S.E.D.
- 12 MOTORIZED TELESCOPIC BLEACHERS, SEE BLEACHER DRAWINGS. FOR POWER PROVISION, S.E.D.
- 13 ROOF DRAINS, S.P.D.; S.C.D.
- 14 FLUSH INTERIOR FINISH
- 15 SPORTS GAME STRIPING, SEE STRIPING PLAN
- 16 ROOF ACCESS LADDER
- 17 MOTORIZED DIVIDER CURTAIN, S.S.D. FOR SUPPORT
- 18 SEMI-RECESSED FIRE CABINET AND EXTINGUISHER
- 19 AUDIO VISUAL EQUIPMENT, S.A.V.D.
- 20 CENTER LINE OF COLUMN IS TO CENTER LINE OF PERPENDICULAR WALL
- 21 SHORT THROW PROJECTOR, PROVIDE BLKG

### FLOOR FINISH CODES

- WAF1 CUSHIONED WOOD ATHLETIC FLOOR  
EP1 FLUID APPLIED FLOORING  
RFT RESILIENT FLOOR TILE  
C1 SEALED CONCRETE

FOR TYPICAL FLOORING TRANSITION SEE


### FLOOR PLAN GENERAL NOTES

1. EXTERIOR CONCRETE FLATWORK SHALL HAVE A MAXIMUM SLOPE OF 1:20, U.O.N.; EXTERIOR DOOR LANDINGS SHALL SLOPE 1/4" PER FOOT FOR 60" PERPENDICULAR TO DOOR FACE, MAXIMUM FOR DRAINAGE. CONCRETE SHALL SLOPE MINIMUM 1/8" PER FOOT AWAY FROM BUILDINGS. S.C.D.
2. CONCRETE WALKS, S.C.D.; S.L.D.
3. S.C.D. FOR FINISHED FLOOR ELEVATIONS. SLAB DEPRESSIONS S.S.D. FOR ELEVATIONS RELATIVE TO THE REST OF THE SITE, REFER TO CIVIL ENGINEERING DRAWINGS.
4. REFER TO CIVIL ENGINEERING DRAWINGS AND SITE PLAN FOR SITE FEATURES NOT OTHERWISE INDICATED.
5. REFER TO ARCHITECTURAL GRAPHICS DRAWINGS FOR SIGNAGE NOT SHOWN.
6. ALL INTERIOR WALL FRAMING AND GYP.BD. EXTEND TO UNDERSIDE OF ROOF/FLOOR STRUCTURE ABOVE, U.O.N.

### WALL TYPE LEGEND

- S.S.D. FOR WOOD FRAMING SIZES FOR ALL BEARING WALLS. ALL OTHER WALLS ARE 2X6 WOOD STUDS U.O.N.
- WOOD FRAMING - NON RATED  
ACOUSTIC RATING (STC)  
WOOD STUD SIZE

### KEYPLAN

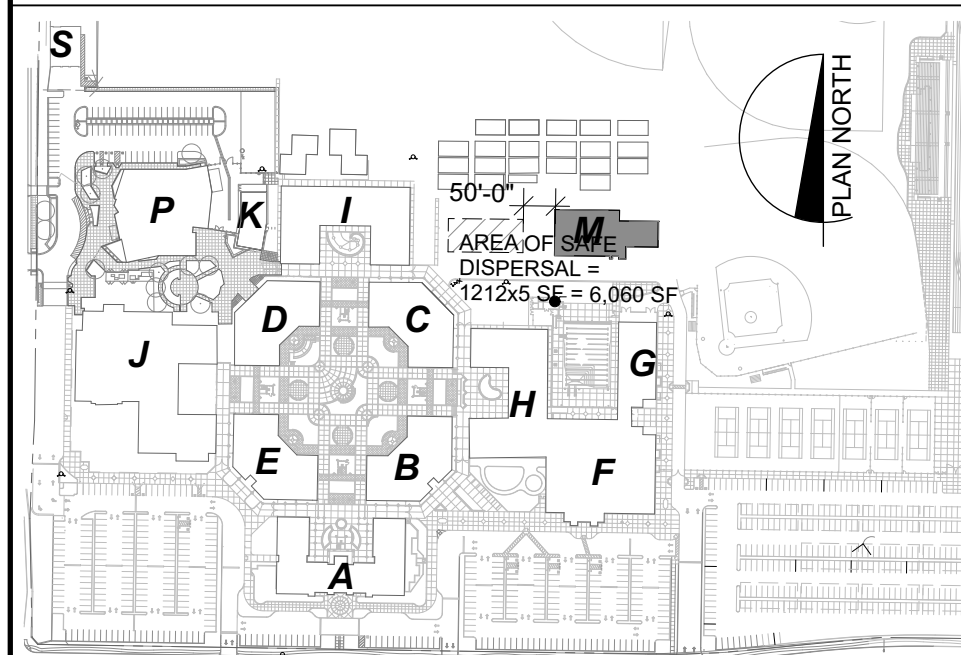

QUATTROCCHI KWOK  
ARCHITECTS  
Main:  
636 Fifth Street, Santa Rosa, CA 95404  
East Bay:  
55 Harrison Street, Suite 525,  
Oakland, CA 94607  
(707) 576-0829  
LICENSED ARCHITECT  
JIM THEISS  
LICENSE # C22643  
EXP JUNE 30, 2021  
STATE OF CALIFORNIA  
SIGNED: MAY 5, 2021

### FREEDOM HIGH SCHOOL

### NEW AUXILIARY GYMNASIUM

1050 NEROLY RD,  
OAKLEY, CA 94561

### LIBERTY UNION HIGH SCHOOL DISTRICT

DSA APP NO. 01-119278

ARCH PROJECT NO: 1869.00

DRAWN BY: GRD

DRAWING SCALE: 1/8" = 1'-0"

PTN: 61721-78 FILE NO: 7-H4

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APRIL 27, 2021

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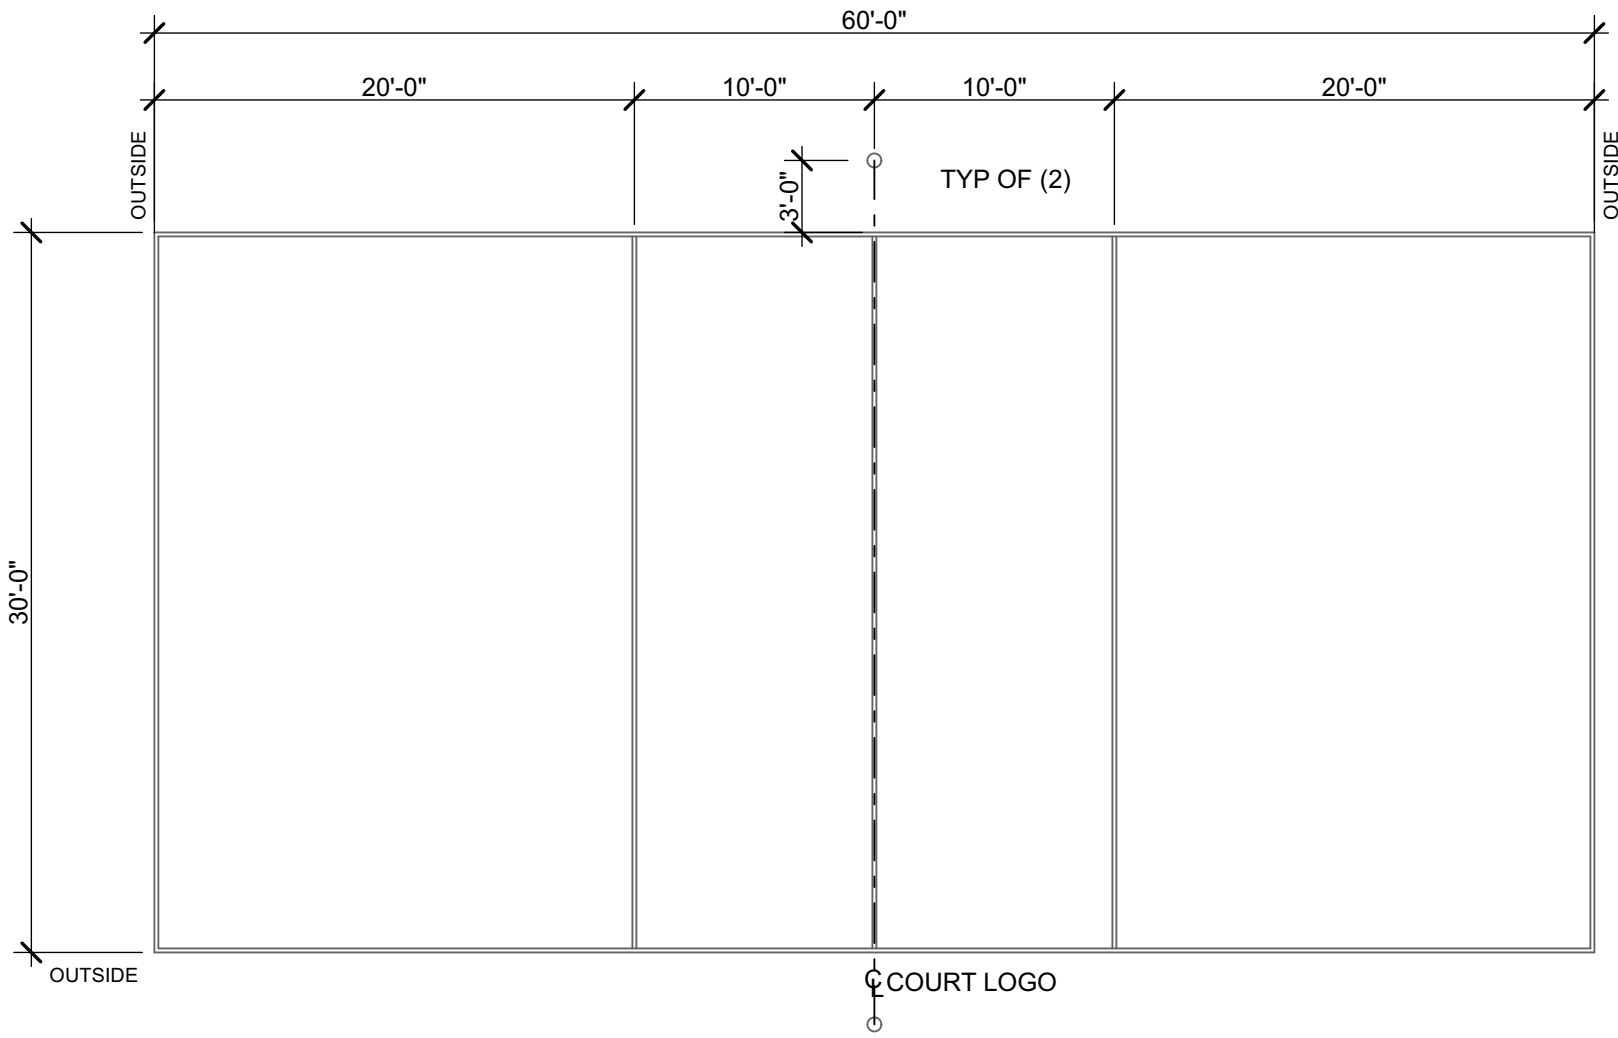
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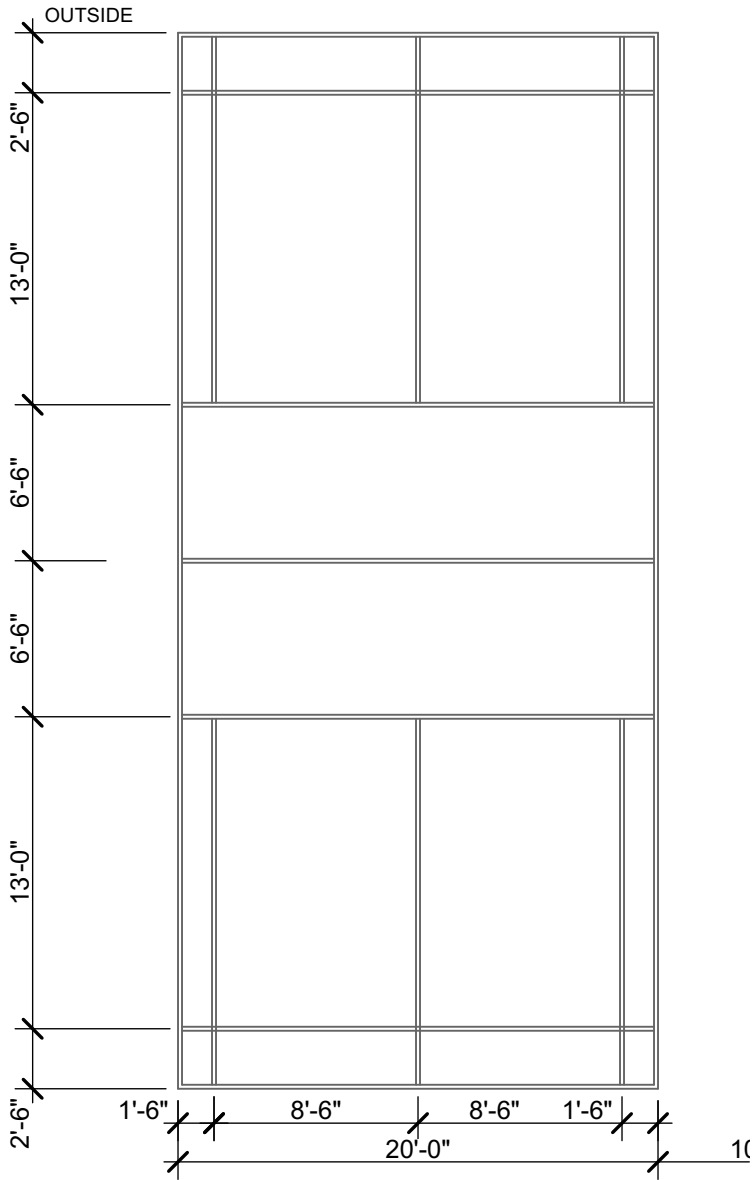
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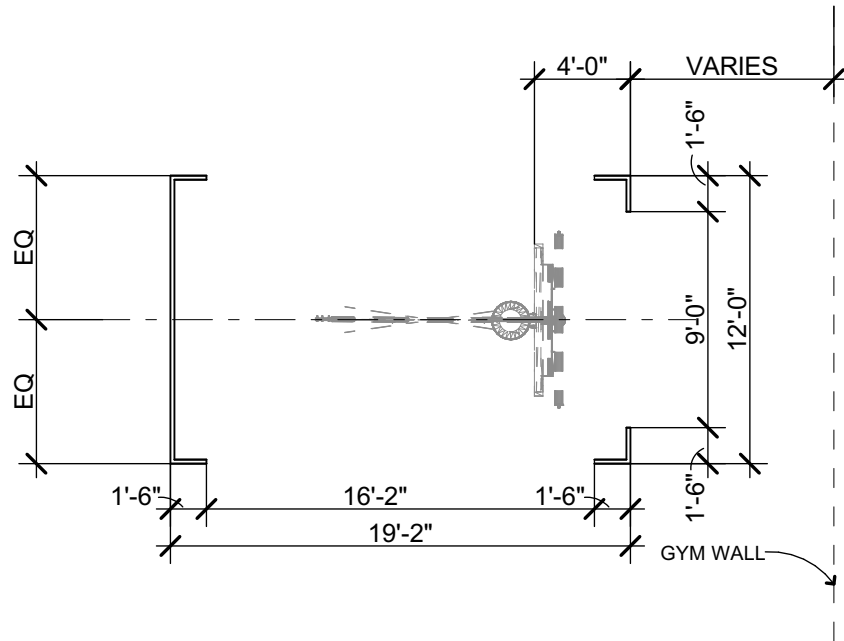
**VOLLEYBALL COURT LINE MARKINGS** 3  
1/8" = 1'-0"




**BADMITTON COURT LINE MARKINGS** 4  
1/8" = 1'-0"




**SCHOOL LOGO** 6  
1/4" = 1'-0"



**PRACTICE BASKETBALL COURT MARKINGS** 5  
1/8" = 1'-0"

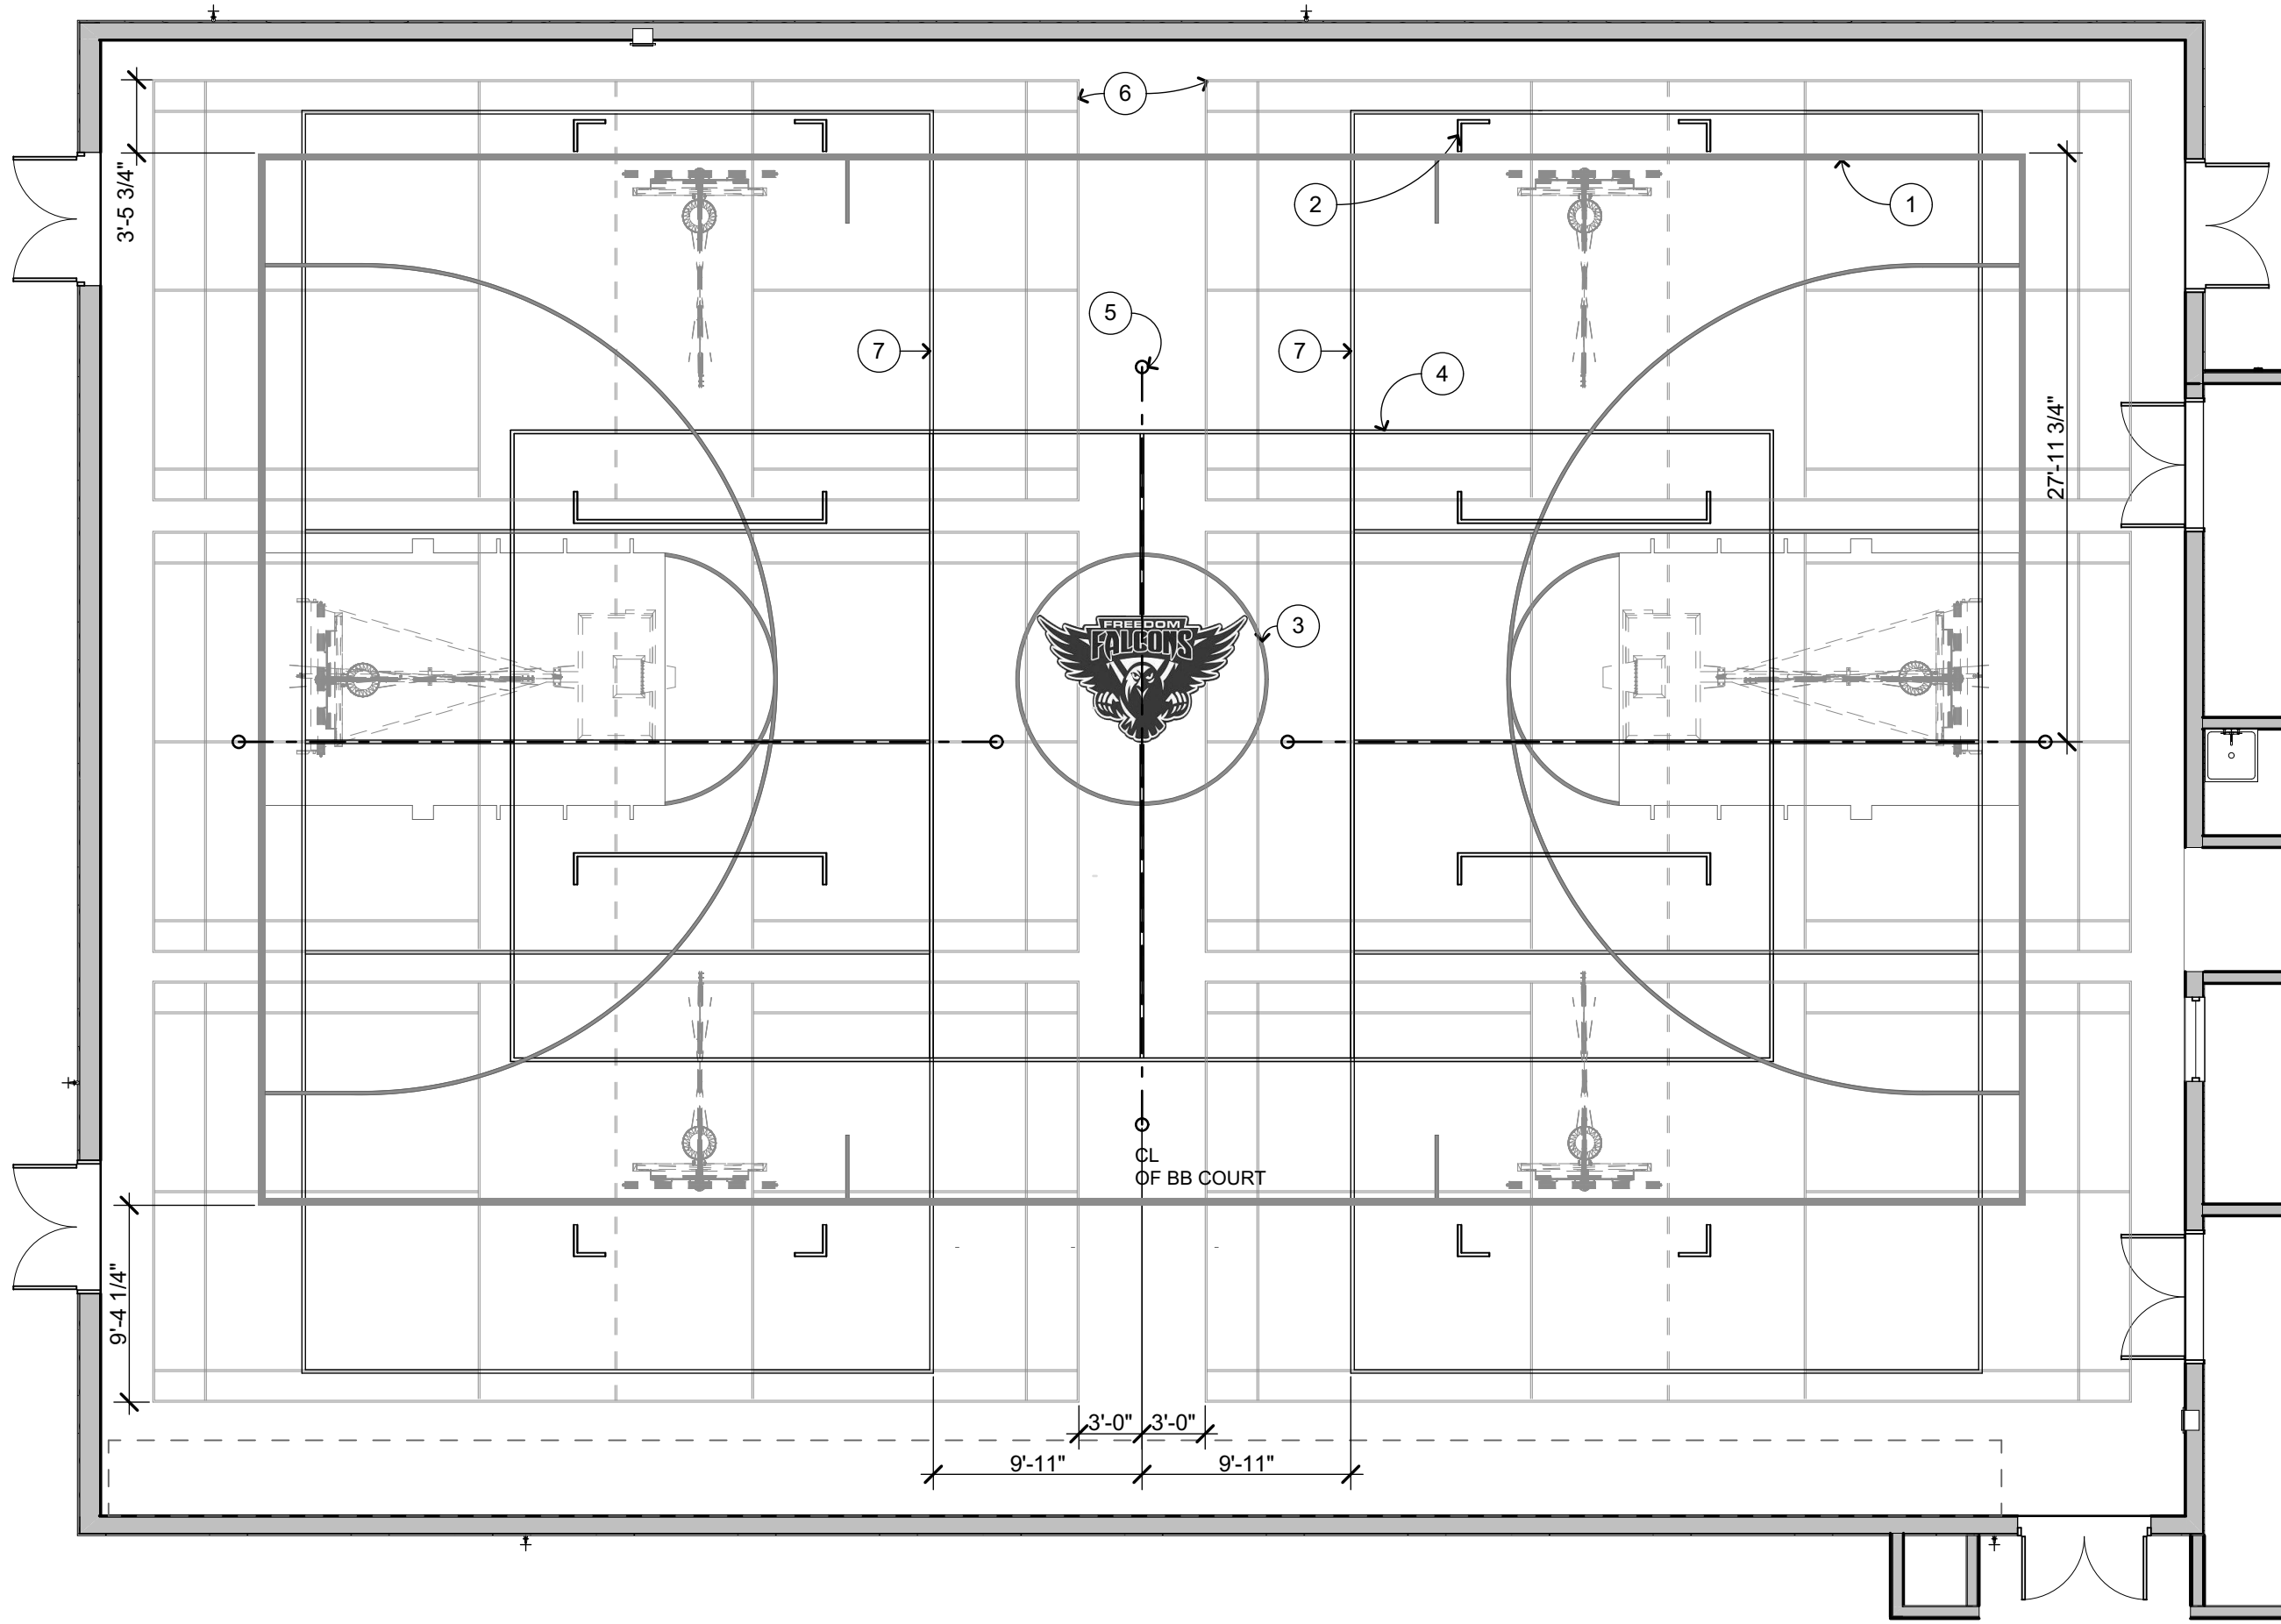

**GAME COURTS COMPOSITE STRIPING PLAN** 1  
1/8" = 1'-0"

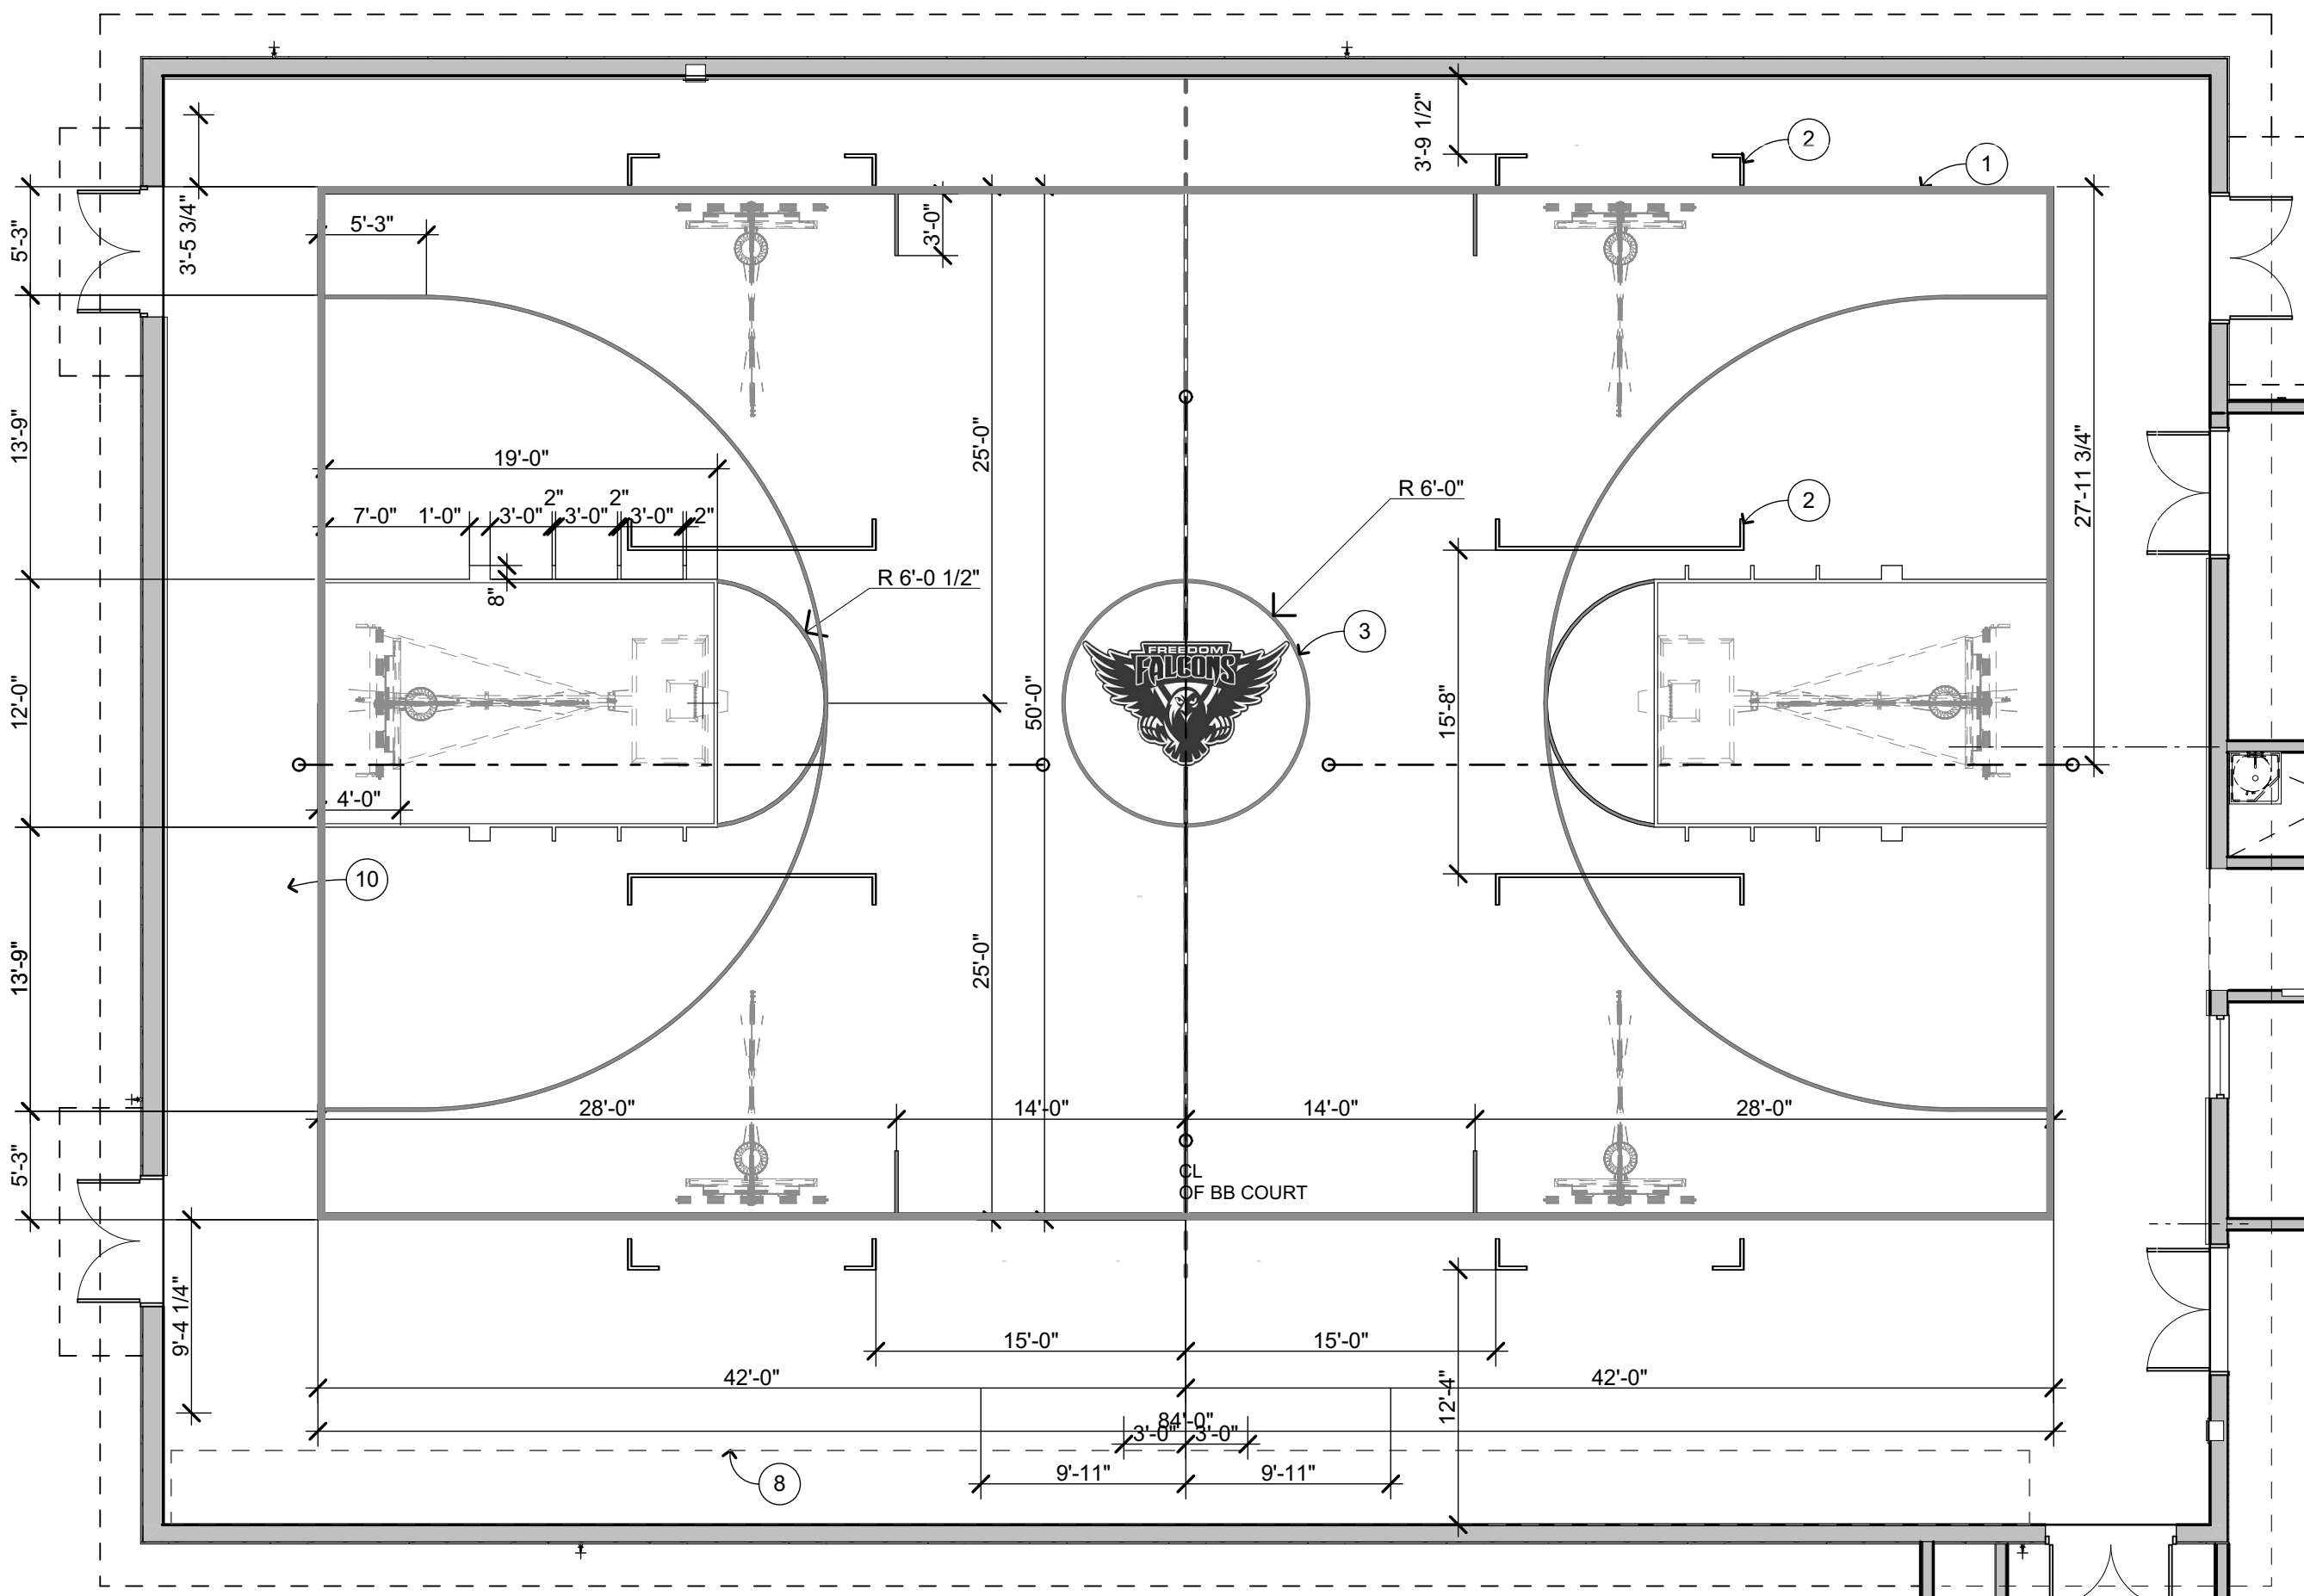

**BASKETBALL COURT LINE MARKINGS** 2  
1/8" = 1'-0"

#### STRIPING PLAN KEYNOTES

- 1 MAIN BASKETBALL COURT.
- 2 PRACTICE BASKETBALL COURTS (4).
- 3 SCHOOL LOGO, SEE
- 4 MAIN VOLLEYBALL COURT.
- 5 VOLLEYBALL POLE FLOOR SLEEVES (6)
- 6 BADMINTON COURT
- 7 PRACTICE VOLLEYBALL COURT (2)
- 8 BLEACHERS IN RETRACTED POSITION

#### GENERAL NOTES

1. VERIFY ALL STRIPING COLORS WITH DISTRICT PRIOR TO INSTALL.
2. ALL DIMENSIONS ARE TO THE PLAYING SIDE OF THE STRIPE UNLESS OTHERWISE NOTED.
3. BASKETBALL AND VOLLEYBALL STRIPES ARE 2" WIDE UNLESS OTHERWISE NOTED.
4. BADMINTON STRIPES ARE 1" WIDE.
5. CONTRACTOR TO PROVIDE VOLLEYBALL AND BADMINTON EQUIPMENT FOR NUMBER AND CONFIGURATION OF COURTS INDICATED.


#### STRIPING MATRIX

THE STRIPING FOR A COURT LOWER ON THE MATRIX SHALL BREAK FOR THE STRIPING FOR A COURT HIGHER ON THE MATRIX WITH EXCEPTIONS AS NOTED.

COURT	COLOR	NOTES
MAIN BASKETBALL	BLACK	
MAIN VOLLEYBALL	TBD	1
PRACTICE VOLLEYBALL	TBD	1
BADMINTON	TBD	1
PRACTICE BASKETBALL	TBD	1

NOTE:  
1. WHEN THE PRACTICE OR MAIN VOLLEYBALL COURT LINES OR THE PRACTICE BASKETBALL LINES CROSS THE MAIN BASKETBALL BORDER, THE BASKETBALL BORDER SHALL BE A SHADE LIGHTER SO THAT THE LINES CAN BE FOLLOWED THROUGH THE BORDERS. THE LINES SHALL RESUME THEIR ORIGINAL COLOR ON EITHER SIDE OF THE BASKETBALL BORDER.

#### KEYPLAN

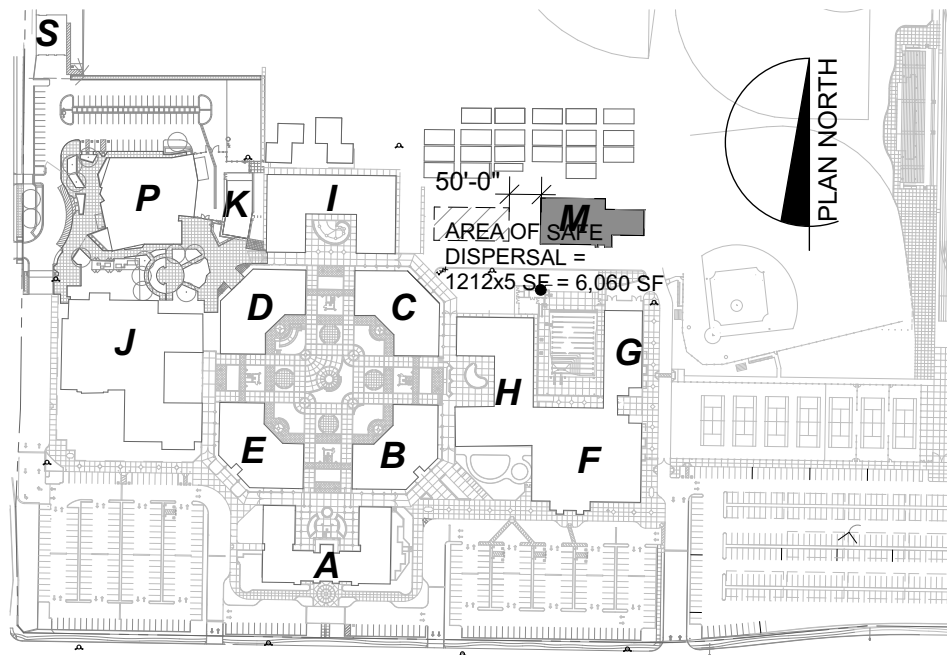

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Main:  
636 Fifth Street, Santa Rosa, CA 95404  
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DRAWING SCALE:

PTN: 61721-78 FILE NO: 7-H4

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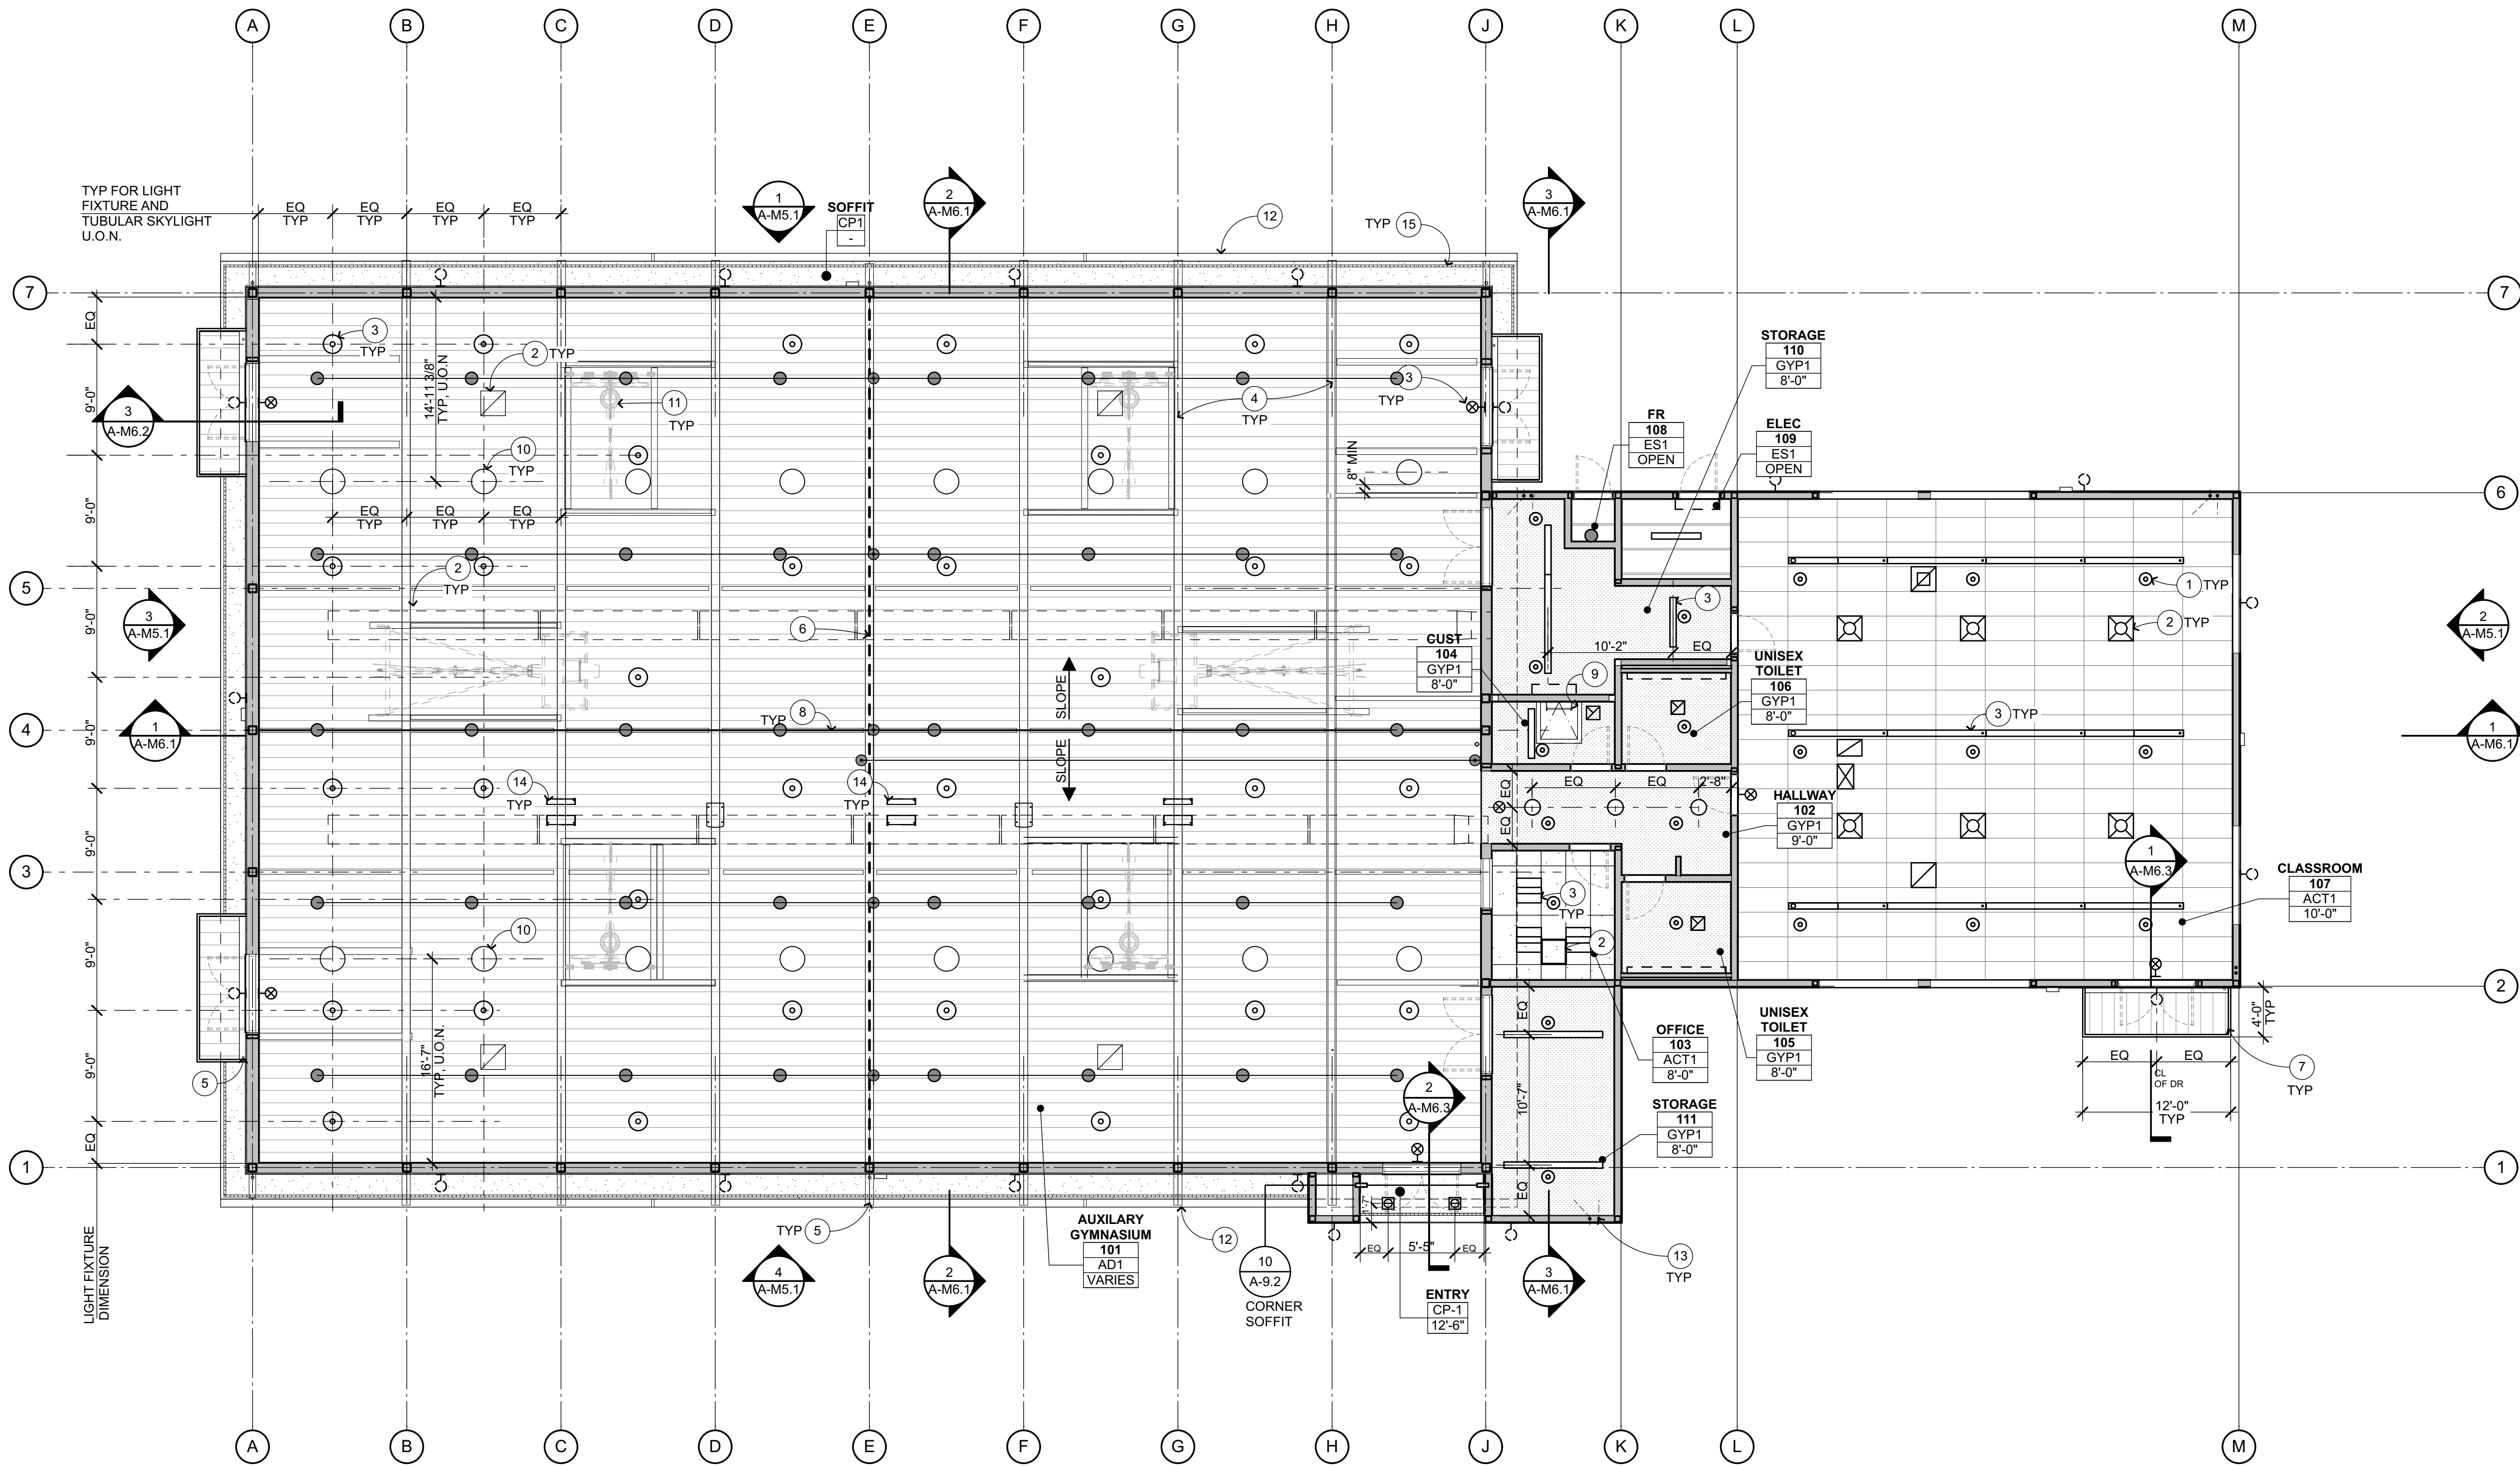
SHEET TITLE

**COMPOSITE COURT STRIPING PLAN**

SHEET NUMBER

**A-M2.2**





REFLECTED CEILING PLAN 1  
1/8" = 1'-0"

REFLECTED CEILING PLAN KEYNOTES

- 1 FIRE PROTECTION ITEM, S.F.P.D.
- 2 MECHANICAL ITEM, S.M.D.
- 3 ELECTRICAL ITEM, S.E.D.
- 4 STRUCTURAL ITEM, S.S.D.
- 5 RAIN WATER LEADER
- 6 MOTORIZED DIVIDER CURTAIN, S.S.D.
- 7 RAIN CANOPY
- 8 ROOF RIDGE
- 9 ROOF ACCESS HATCH
- 10 TUBULAR SKYLIGHT
- 11 MOTORIZED RETRACTABLE BASKETBALL EQUIPMENT ABOVE. FOR SUPPORT S.S.D.; FOR POWER S.E.D.
- 12 GUTTER
- 13 ROOF DRAINS ABOVE CLG, S.P.D; S.C.D.
- 14 AUDIO VISUAL EQUIPMENT, S.AV.D.
- 15 1" SOFFIT VENT

REFLECTED CEILING PLAN GENERAL NOTES

1. NOTES & SYMBOLS ARE TO APPLY TO ALL AREAS OF SIMILAR GRAPHIC REPRESENTATION. SUCH INDICATIONS MAY BE LIMITED TO PROMOTE CLARITY OR AVOID REDUNDANCY. NO LIMITATION OF APPLICATION SHALL BE CONSTRUED WITHOUT SPECIFIC NOTATION.
2. PENDANT LIGHT FIXTURE LOCATION DIMENSIONS ARE NOMINAL. VERIFY IN FIELD TO MAINTAIN 45" SWING CLEARANCES TO FIXED ELEMENTS.
3. S.E.D. FOR HORNS, SPEAKERS, PULL STATIONS, LIGHT FIXTURES AND OTHER FEATURES NOT OTHERWISE SHOWN.
4. S.E.D. FOR EXIT SIGNS & EMERGENCY LIGHTING CONDITIONS.
5. S.M.D. FOR PIPING, REGISTERS & VENTS NOT OTHERWISE SHOWN. MECHANICAL DUCT LOCATION DIMENSIONS ARE NOMINAL. VERIFY IN FIELD TO MAINTAIN CLEARANCES TO FIXED ELEMENTS.
6. CBC TABLE 601- ROOFS AND THEIR MEMBERS OTHER THAN THE STRUCTURAL FRAME MAY BE OF UNPROTECTED NON-COMBUSTIBLE MATERIALS WHEN EVERY PART OF ROOF FRAMING INCLUDING THE STRUCTURAL FRAME IS 20 FEET OR MORE ABOVE THE FLOOR IMMEDIATELY BELOW.
7. COORDINATE ACCESS PANEL LOCATIONS WITH MECHANICAL.

REFLECTED CEILING PLAN LEGEND AND CODE


FOR PAINT FINISHES SEE SEC. 099123

ROOM NAME	ROOM #	CL-XX	X-XX
CL-XX			
X-XX			

- |      |                                                                   |
|------|-------------------------------------------------------------------|
| GYP1 | GYPSUM BOARD O/ FRAMING, S.S.D.                                   |
| ACT1 | 2'x4' SUSPENDED CEILING SYSTEM W/ ACOUSTIC TILE, SEE FINISH CODES |
| CP1  | EXTERIOR CEMENT PLASTER W/ CONTROL JOINTS AS SHOWN                |
| AD1  | ACOUSTICAL METAL ROOF DECK S.S.D.                                 |
| ES1  | EXPOSED STRUCTURE                                                 |

- DOORS SHOWN DASHED INDICATE DOOR BELOW
- ELECTRICAL ITEMS, S.E.D.
- MECHANICAL ITEMS, S.M.D.
- FIRE SPRINKLERS, S.F.P.D.

KEYPLAN

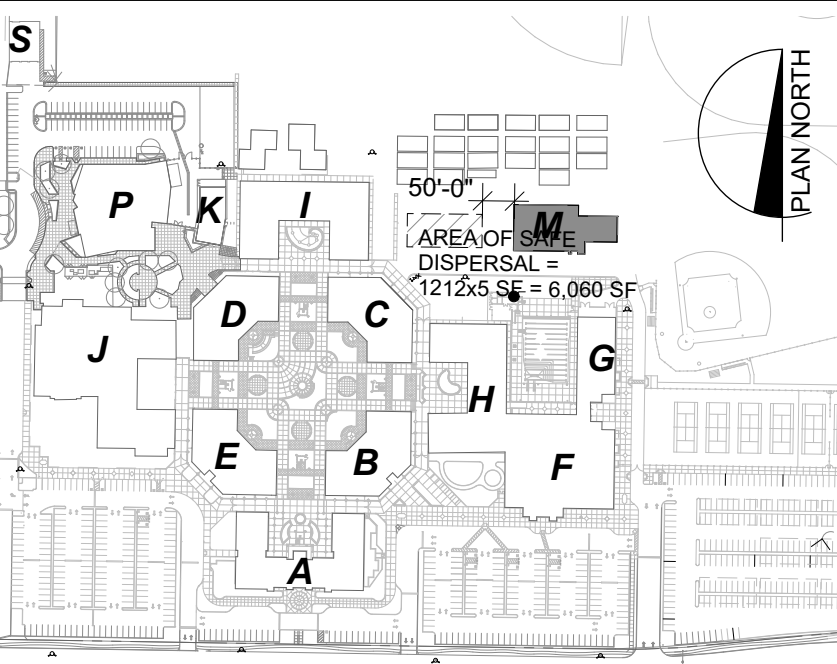

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SHEET TITLE


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SHEET NUMBER


**A-M3.1**



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ROOF PLAN 1  
1/8" = 1'-0"

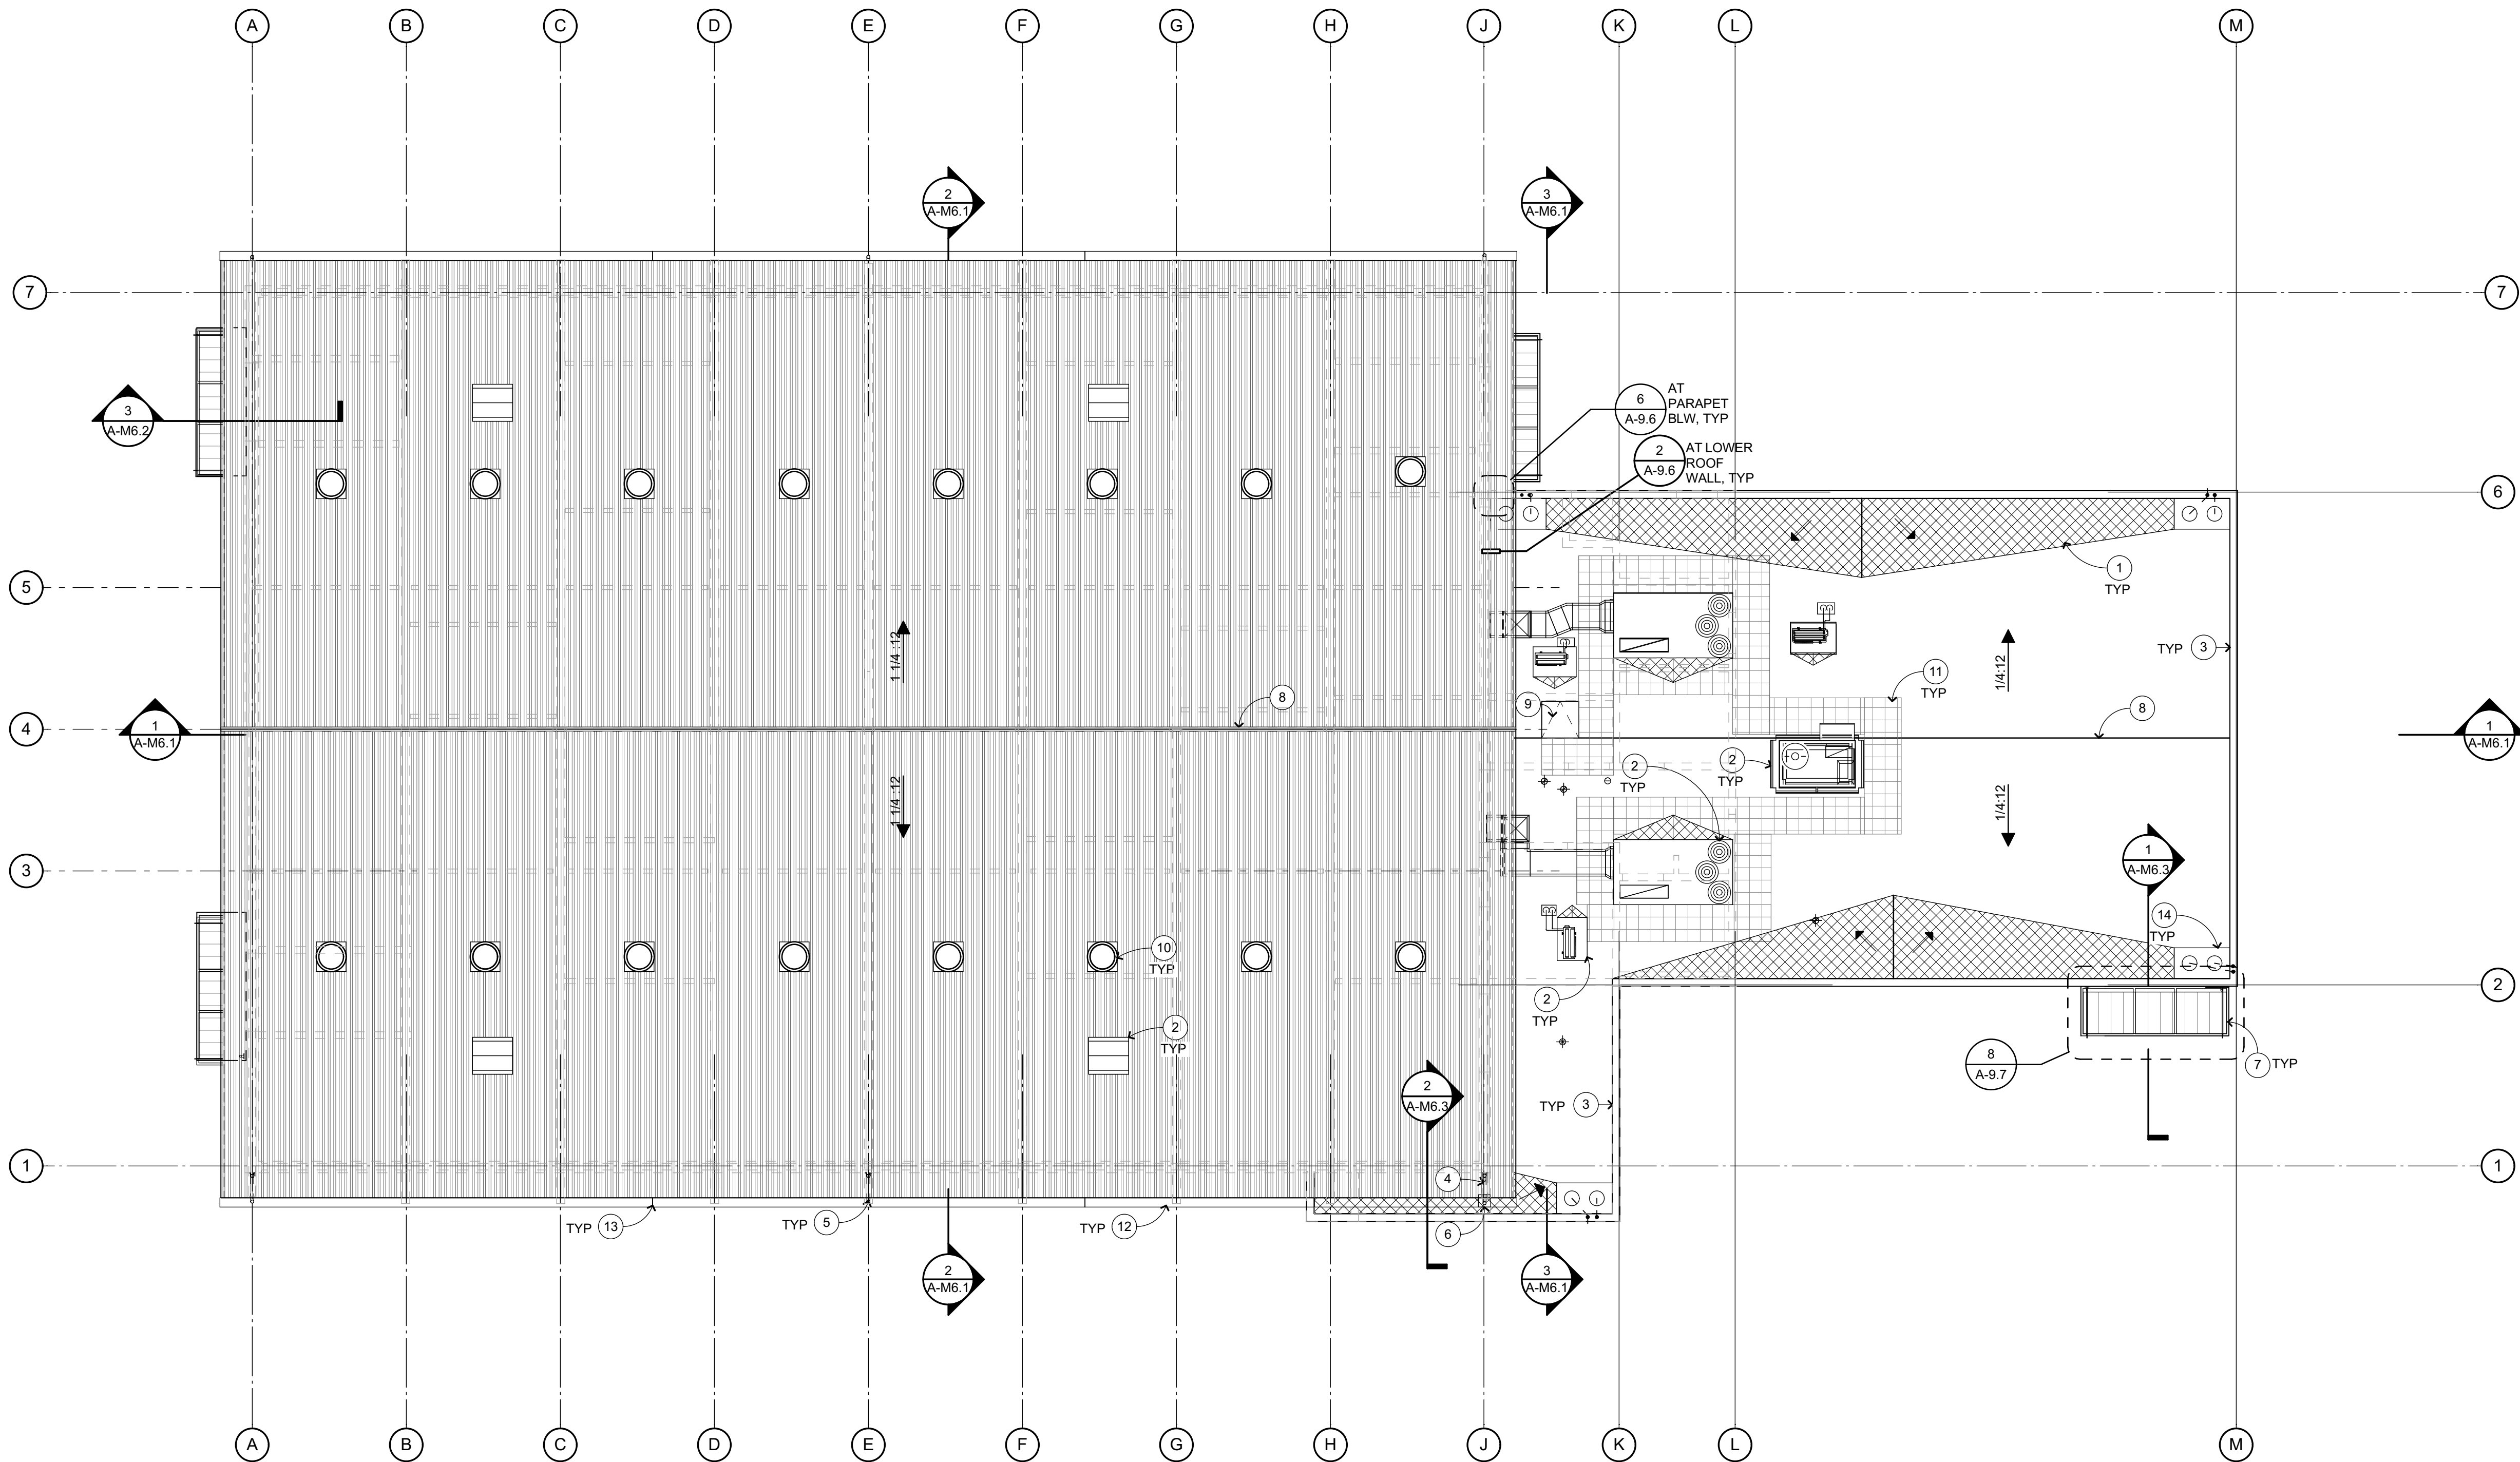

ROOF PLAN KEYNOTES

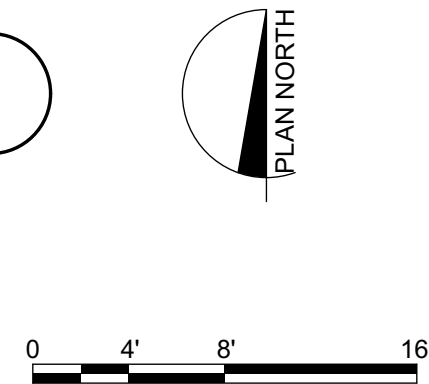- 1 CRICKET
- 2 MECHANICAL ITEM S.M.D., AT MTL ROOF: FLASHING TO BE ETCHED, PRIMED AND PAINTED TO MATCH THE ROOF. SEE DETAILS
- 3 PARAPET WALL, SEE DETAIL
- 4 RAINWATER LEADER, DISCHARGE TO LOWER ROOF, SEE
- 5 RAIN WATER LEADER, SEE DETAIL
- 6 SPLASH PAN, SEE DETAIL
- 7 RAIN CANOPY AT LOW ROOF
- 8 ROOF RIDGE
- 9 ROOF ACCESS HATCH, SEE DETAIL
- 10 21" DIA TUBULAR SKYLIGHT, FLASHING TO BE ETCHED, PRIMED AND PAINTED TO MATCH THE ROOF, SEE DETAIL
- 11 WALK PADS
- 12 GUTTER, SEE DETAIL
- 13 GUTTER EXPANSION JT, SEE DETAIL
- 14 ROOF DRAIN, S.P.D. AND SEE DETAIL


ROOF PLAN GENERAL NOTES

1. LOCATE ALL METAL ROOF PENETRATIONS IN THE CENTER OF THE PAN. DO NOT INTERRUPT STANDING SEAMS.
2. MINIMUM THICKNESS OF RIGID INSULATION TO BE 1" AT LOW POINT OF ROOF. SLOPE MIN. 1/4": 12" TO DRAIN. ALL RIGID INSULATION OVERLAID WITH WITH 1/2" COVER BOARD.
3. ALL ROOFING TO BE CLASS A.
4. REFER TO MECHANICAL AND ELECTRICAL DRAWINGS FOR ROOF PENETRATION LOCATIONS NOT OTHERWISE INDICATED, TYPICAL.
5. MECHANICAL UNIT MOUNTING CURBS PER
6. MECHANICAL OR PLUMBING VENT FLASHING BOOTS, SEE
7. CONDUIT ROOF PENETRATION FLASHING
8. MECHANICAL DUCT THRU WALL FLASHING

ROOF PLAN LEGEND

- +0'-0" DIMENSION INDICATING TOP OF ROOF LEVEL. SEE DETAILS FOR TOP OF ROOF LOCATION WITHIN ASSEMBLY
- BUILT UP ROOF SYSTEM
- CRICKET FRAMING, 1/2" PER FOOT MIN SLOPE
- STANDING SEAM METAL ROOF
- WALLS AND STRUCTURE BELOW
- 3'-0" WIDE WALK PADS

KEYPLAN

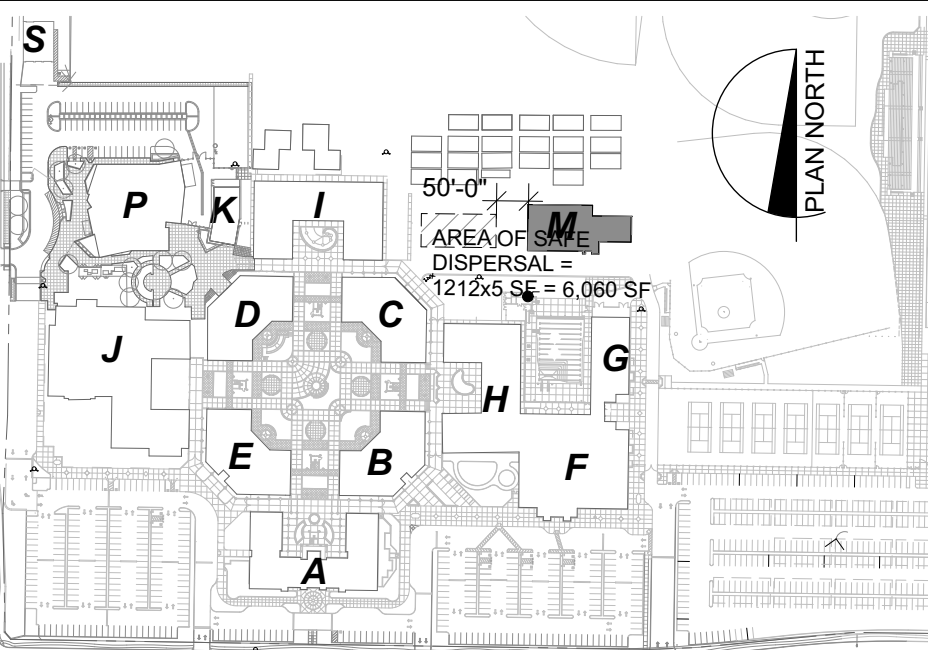

**QUATTROCCHI KWOK ARCHITECTS**

**Main:**  
636 Fifth Street, Santa Rosa, CA 95404

**East Bay:**  
55 Harrison Street, Suite 525,  
Oakland, CA 94607  
(707) 576-0829

**LICENSED ARCHITECT**  
JIM THEISS  
LICENSE # C22643  
EXP JUNE 30, 2021  
STATE OF CALIFORNIA

SIGNED: MAY 5, 2021

**FREEDOM HIGH SCHOOL**

**NEW AUXILIARY GYMNASIUM**

1050 NEROLY RD,  
OAKLEY, CA 94561

**LIBERTY UNION HIGH SCHOOL DISTRICT**

DSA APP NO. 01-119278

ARCH PROJECT NO. 1869.00

DRAWN BY: GRD

DRAWING SCALE: 1/8" = 1'-0"

PTN: 61721-78 FILE NO: 7-H4

**BID DOCUMENT**

APRIL 27, 2021

SHEET TITLE


**ROOF PLAN**

SHEET NUMBER

**A-M4.1**



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#### EXTERIOR ELEVATION KEYNOTES

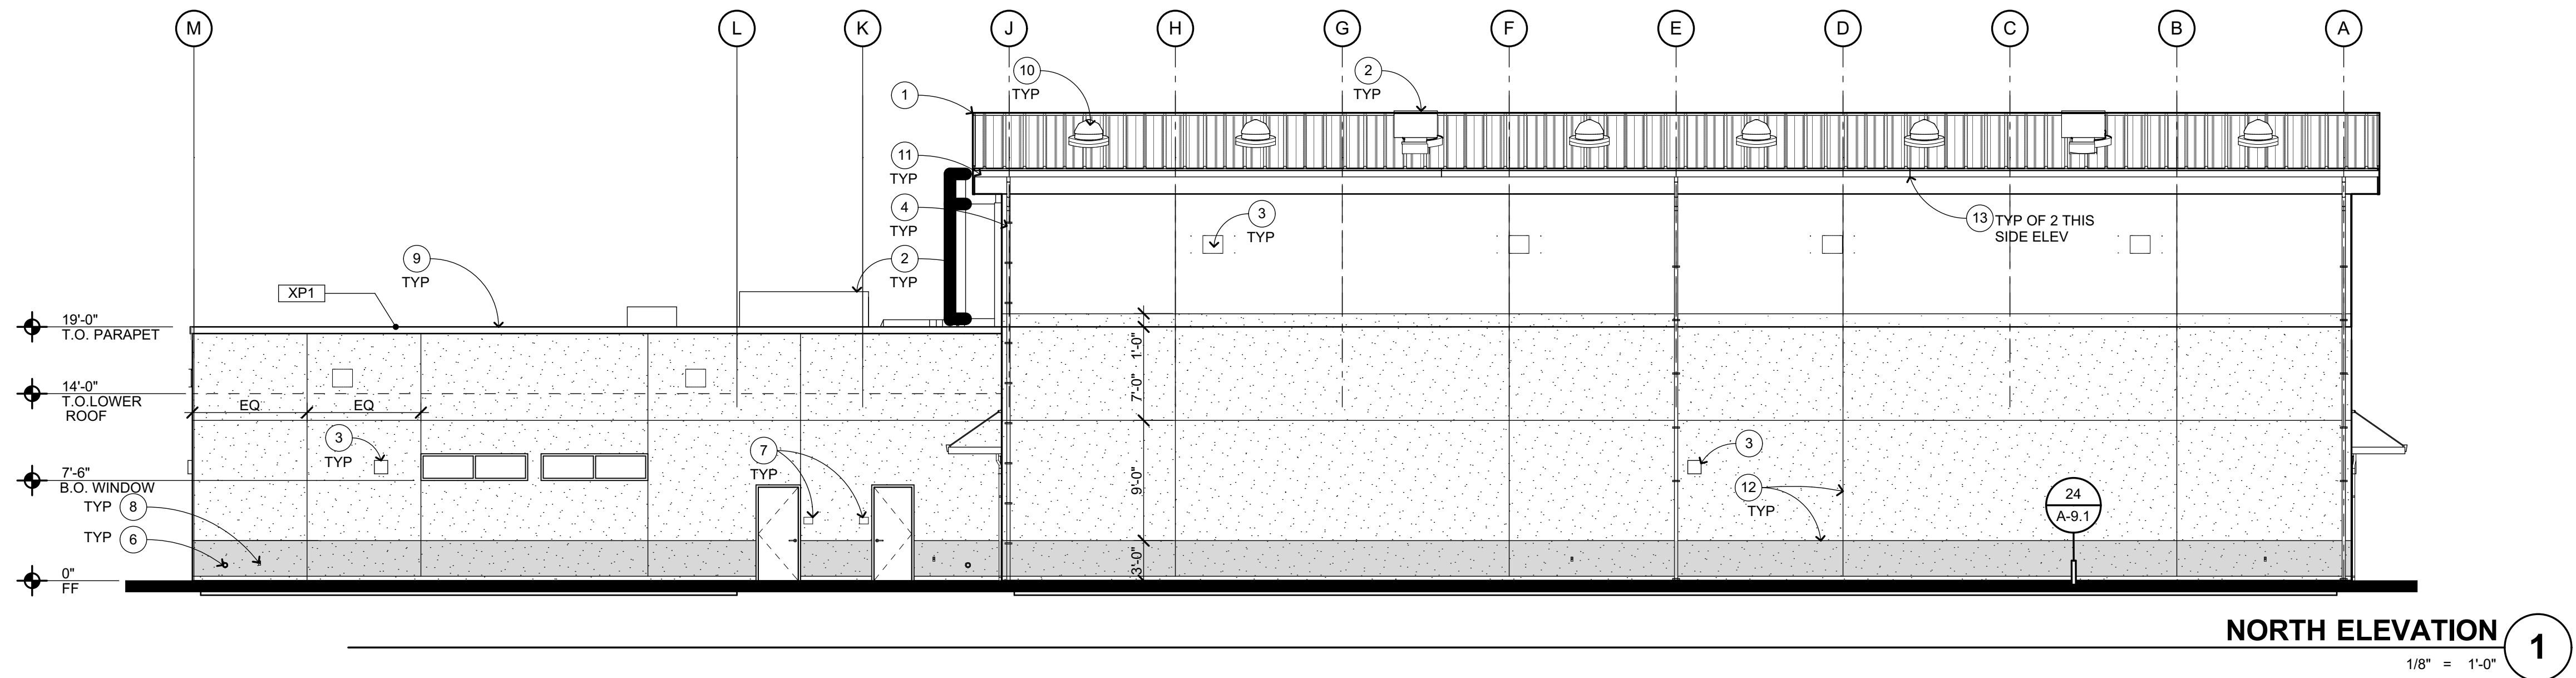- 1 STANDING SEAM MTL ROOF ASSEMBLY
- 2 MECHANICAL ITEM, S.M.D.
- 3 LIGHT FIXTURE, S.E.D.
- 4 RAIN WATER LEADER, SEE DETAILS
- 5 RAIN CANOPY, SEE DETAIL
- 6 OVERFLOW LEADER NOZZLE, S.P.D. AND DETAIL
- 7 SIGNAGE, SEE ARCH GRAPHIC PLAN
- 8 PLUMBING ITEM, S.P.D.
- 9 PARAPET WALL W/ METAL COPING
- 10 TUBULAR SKYLIGHT, FLASHING TO BE ETCHED, PRIMED AND PAINTED TO MATCH THE ROOF
- 11 GUTTER
- 12 CONTROL JOINTS
- 13 GUTTER SEISMIC JOINT
- 14 BUILDING ID SIGN "N" TO MATCH (E) CAMPUS




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3. PROVIDE OPENING FLASHINGS AT ALL WINDOWS, DOORS, LOUVERS AND SIMILAR WALL OPENINGS PER
4. PROVIDE CEMENT PLASTER CONTROL JOINTS AS INDICATED AND AS FOLLOWS: PROVIDE CONTROL JOINTS SO THAT THE MAXIMUM DISTANCE BETWEEN JOINTS, VERTICALLY OR HORIZONTALLY DOES NOT EXCEED 12'-0". ALL CEMENT PLASTER "PANELS" SHALL BE DEFINED BY FOUR STRAIGHT AND UNINTERRUPTED EDGES; PROVIDE JOINTS AS REQUIRED TO AVOID INSIDE CORNERS IN ANY INDIVIDUAL PANEL.
5. REFER TO MECHANICAL DRAWINGS FOR REGISTERS AND VENTS NOT OTHERWISE SHOWN.
6. REFER TO ELECTRICAL DRAWINGS FOR HORNS, SPEAKERS, PULL STATIONS AND OTHER FEATURES NOT OTHERWISE SHOWN.
7. FOR PAINT FINISHES, SEE SEC. 099113 EXTERIOR PAINTING

#### EXTERIOR ELEVATION LEGEND

PLASTER CONTROL JOINT, TYP	
CEMENT PLASTER	XP1
CEMENT PLASTER	XP2
CEMENT PLASTER	XP4
FBC1 FIBER CEMENT SIDING	XP3
EXTERIOR PAINT COLOR*	
XP1 - SW TONY TAUPE	
XP2 - SW VIRTUAL TAUPE	
XP3 - MATCH (E) FREEDOM PURPLE	
XP4 - MATCH (E) FREEDOM BLUE	
RELATIVE ELEVATION DIMENSION FROM FINISH FLOOR	

#### KEYPLAN

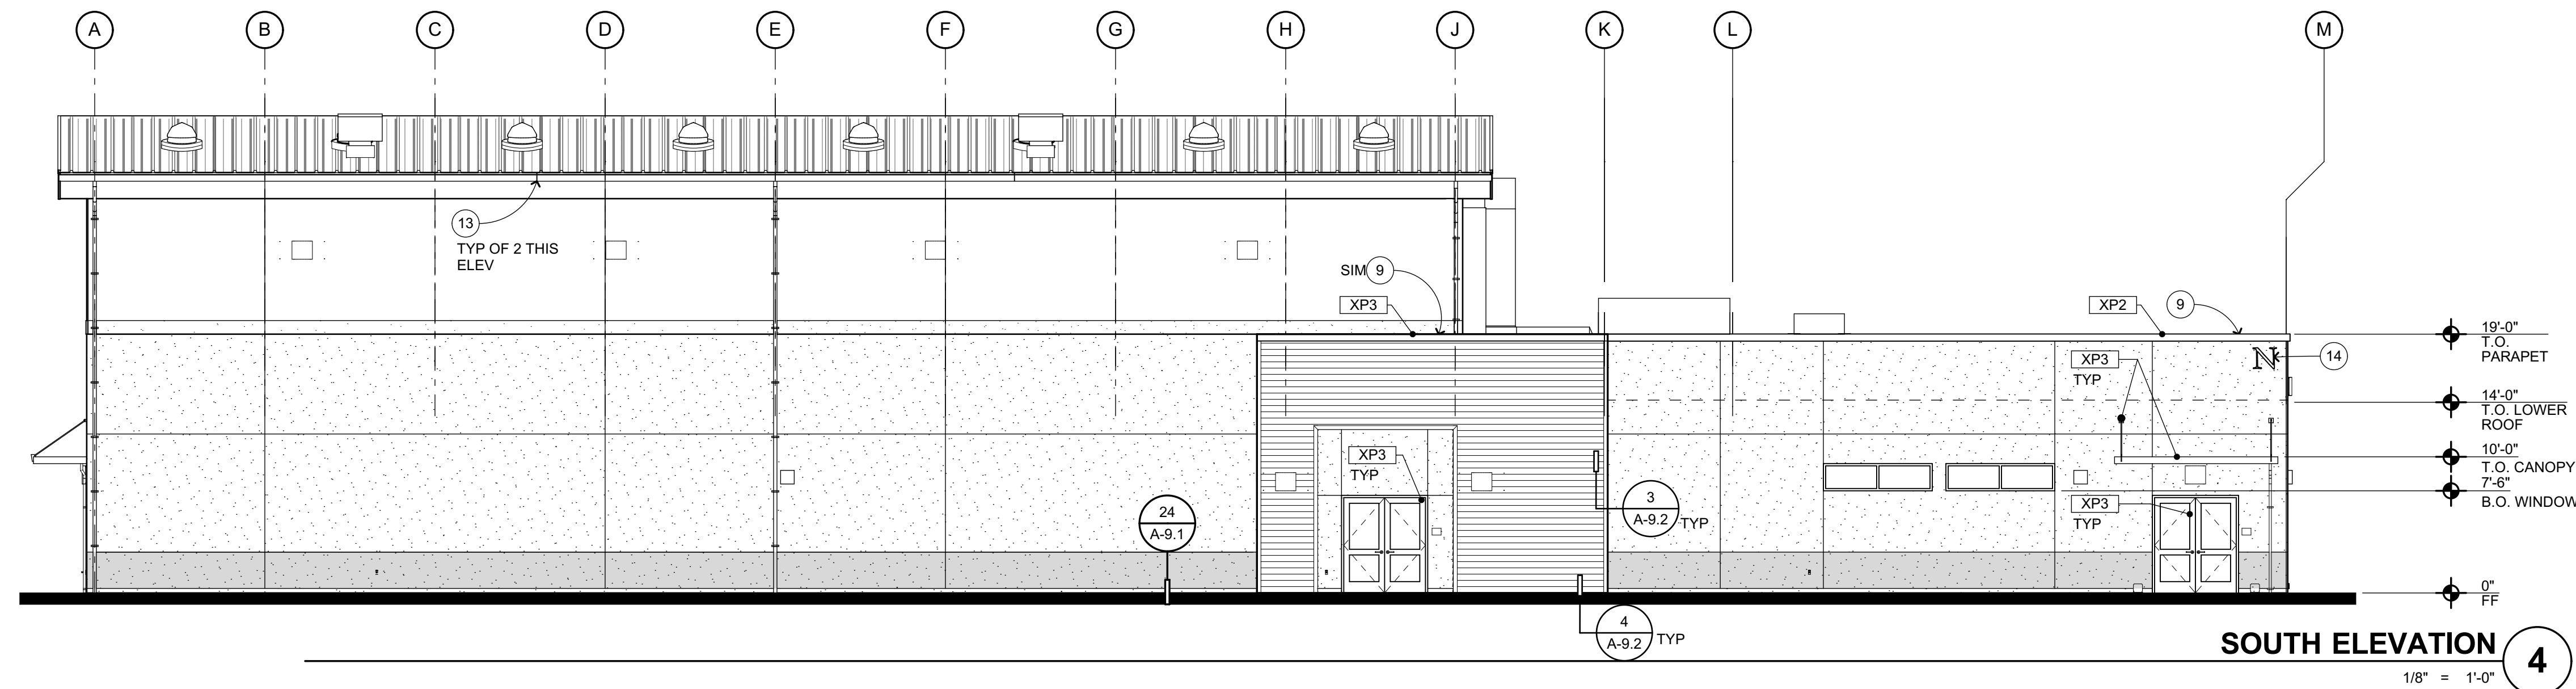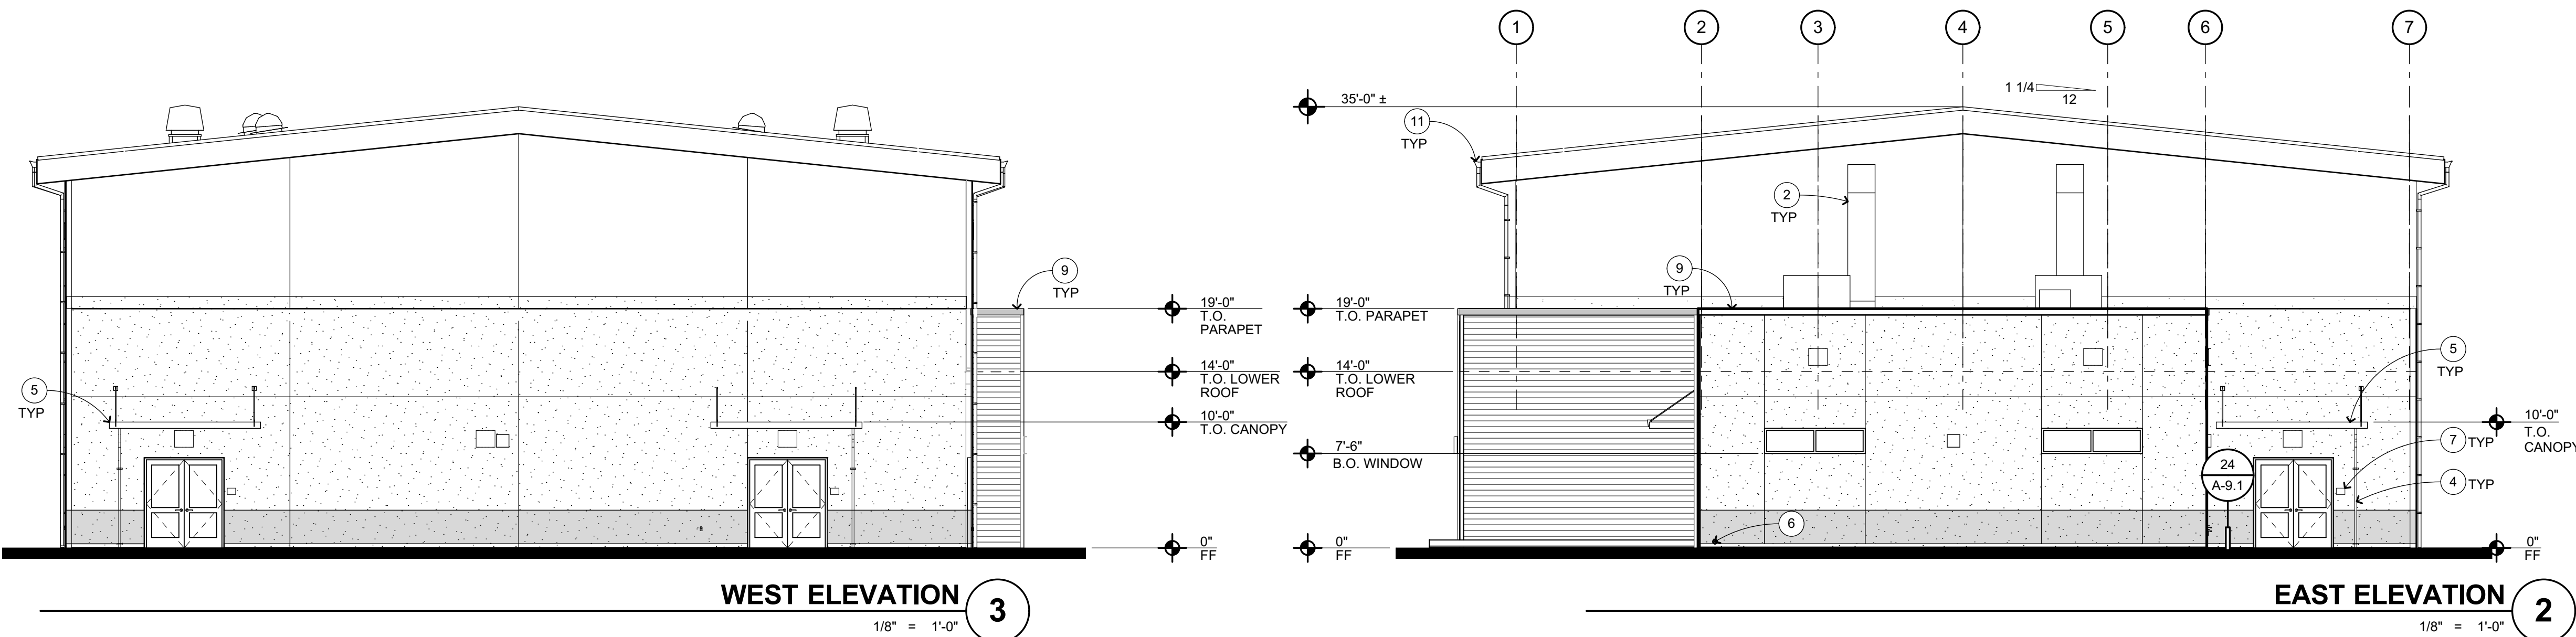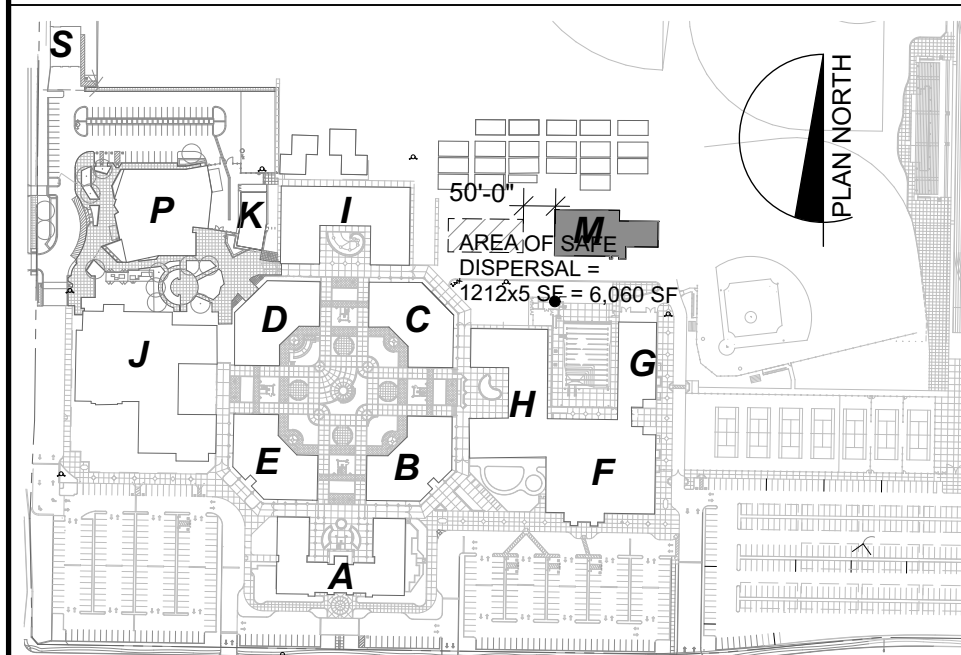

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ARCH PROJECT NO. 1869.00  
DRAWN BY: GRD  
DRAWING SCALE: 1/8" = 1'-0"  
PTN: 61721-78 FILE NO: 7-H4

#### BID DOCUMENT

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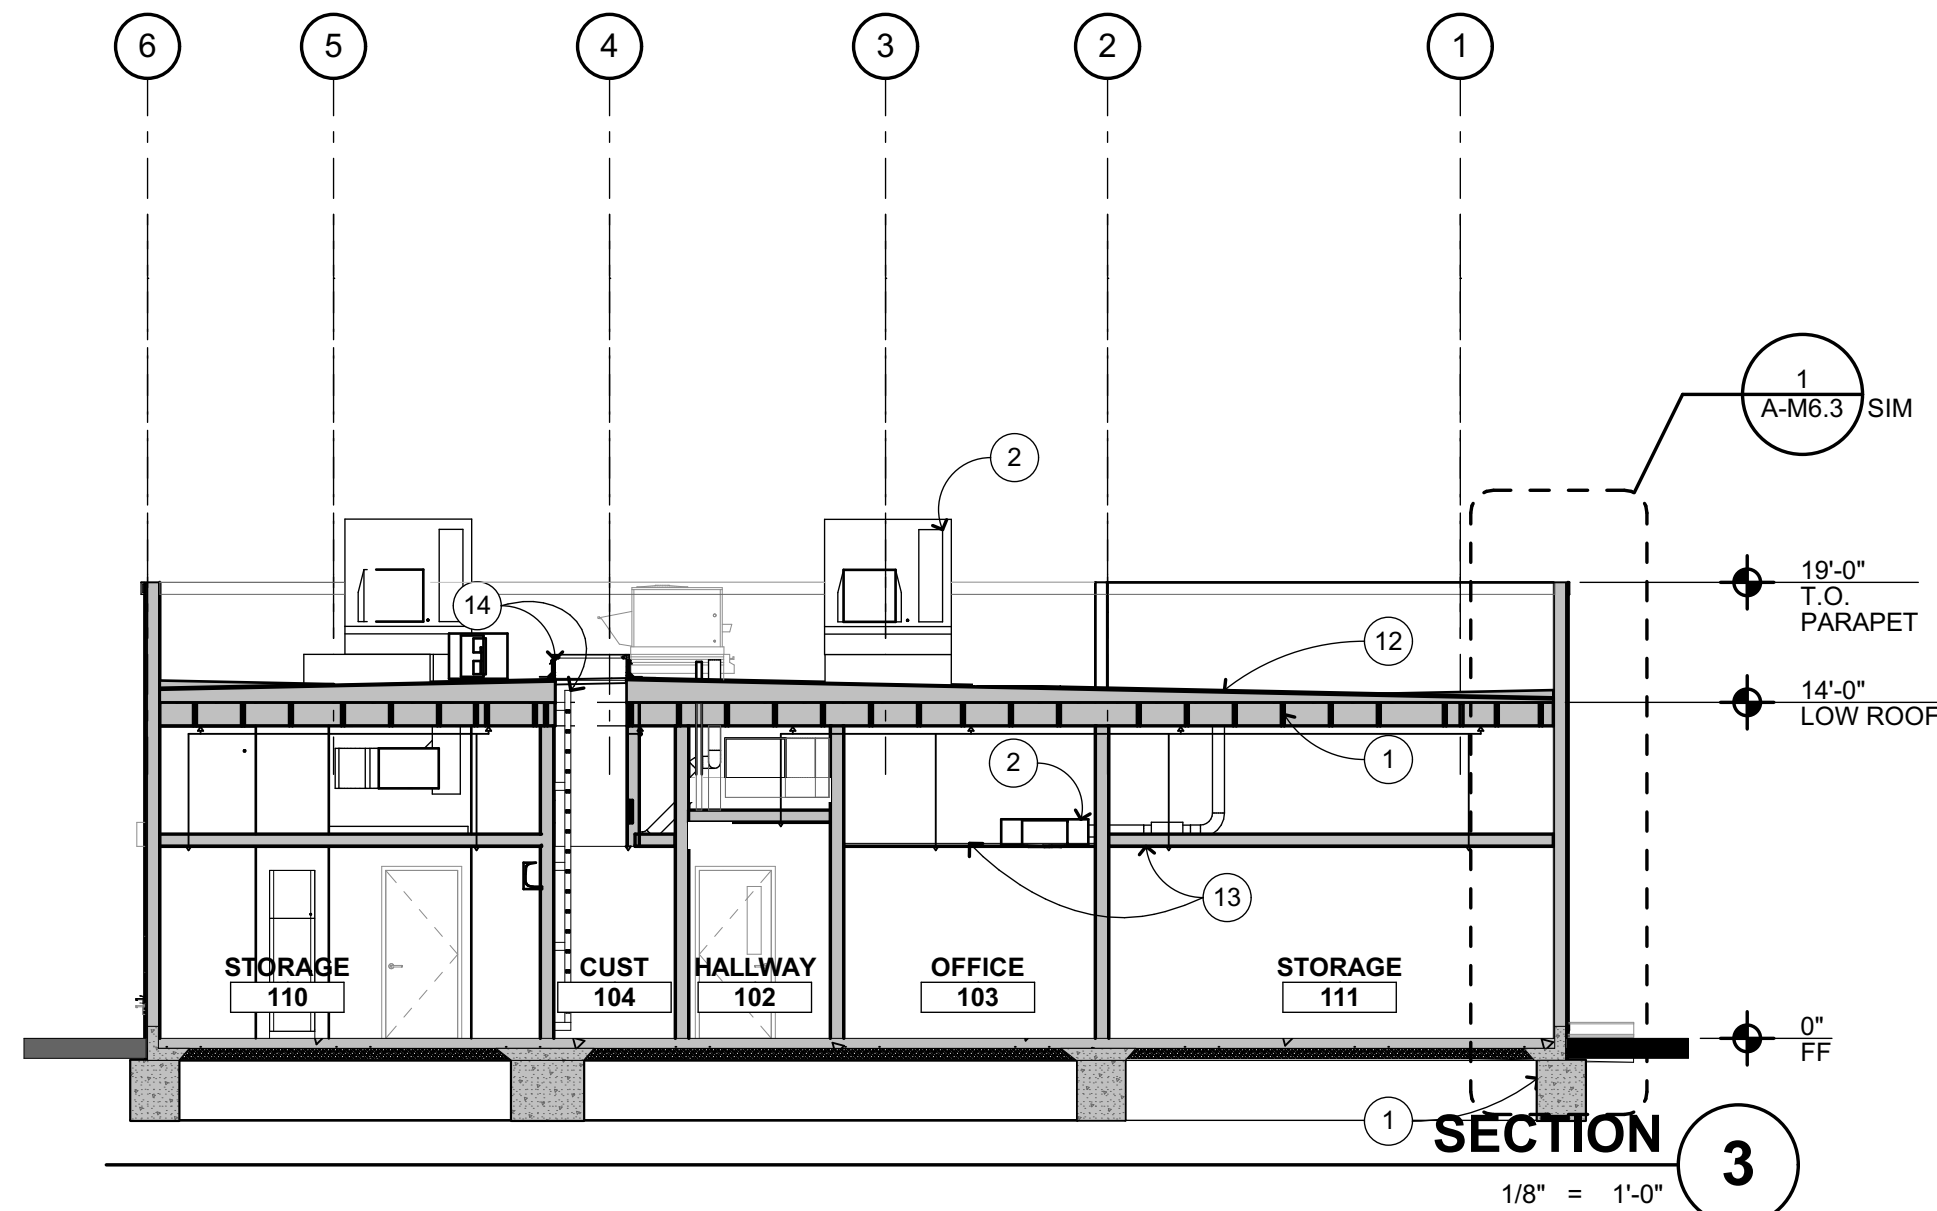
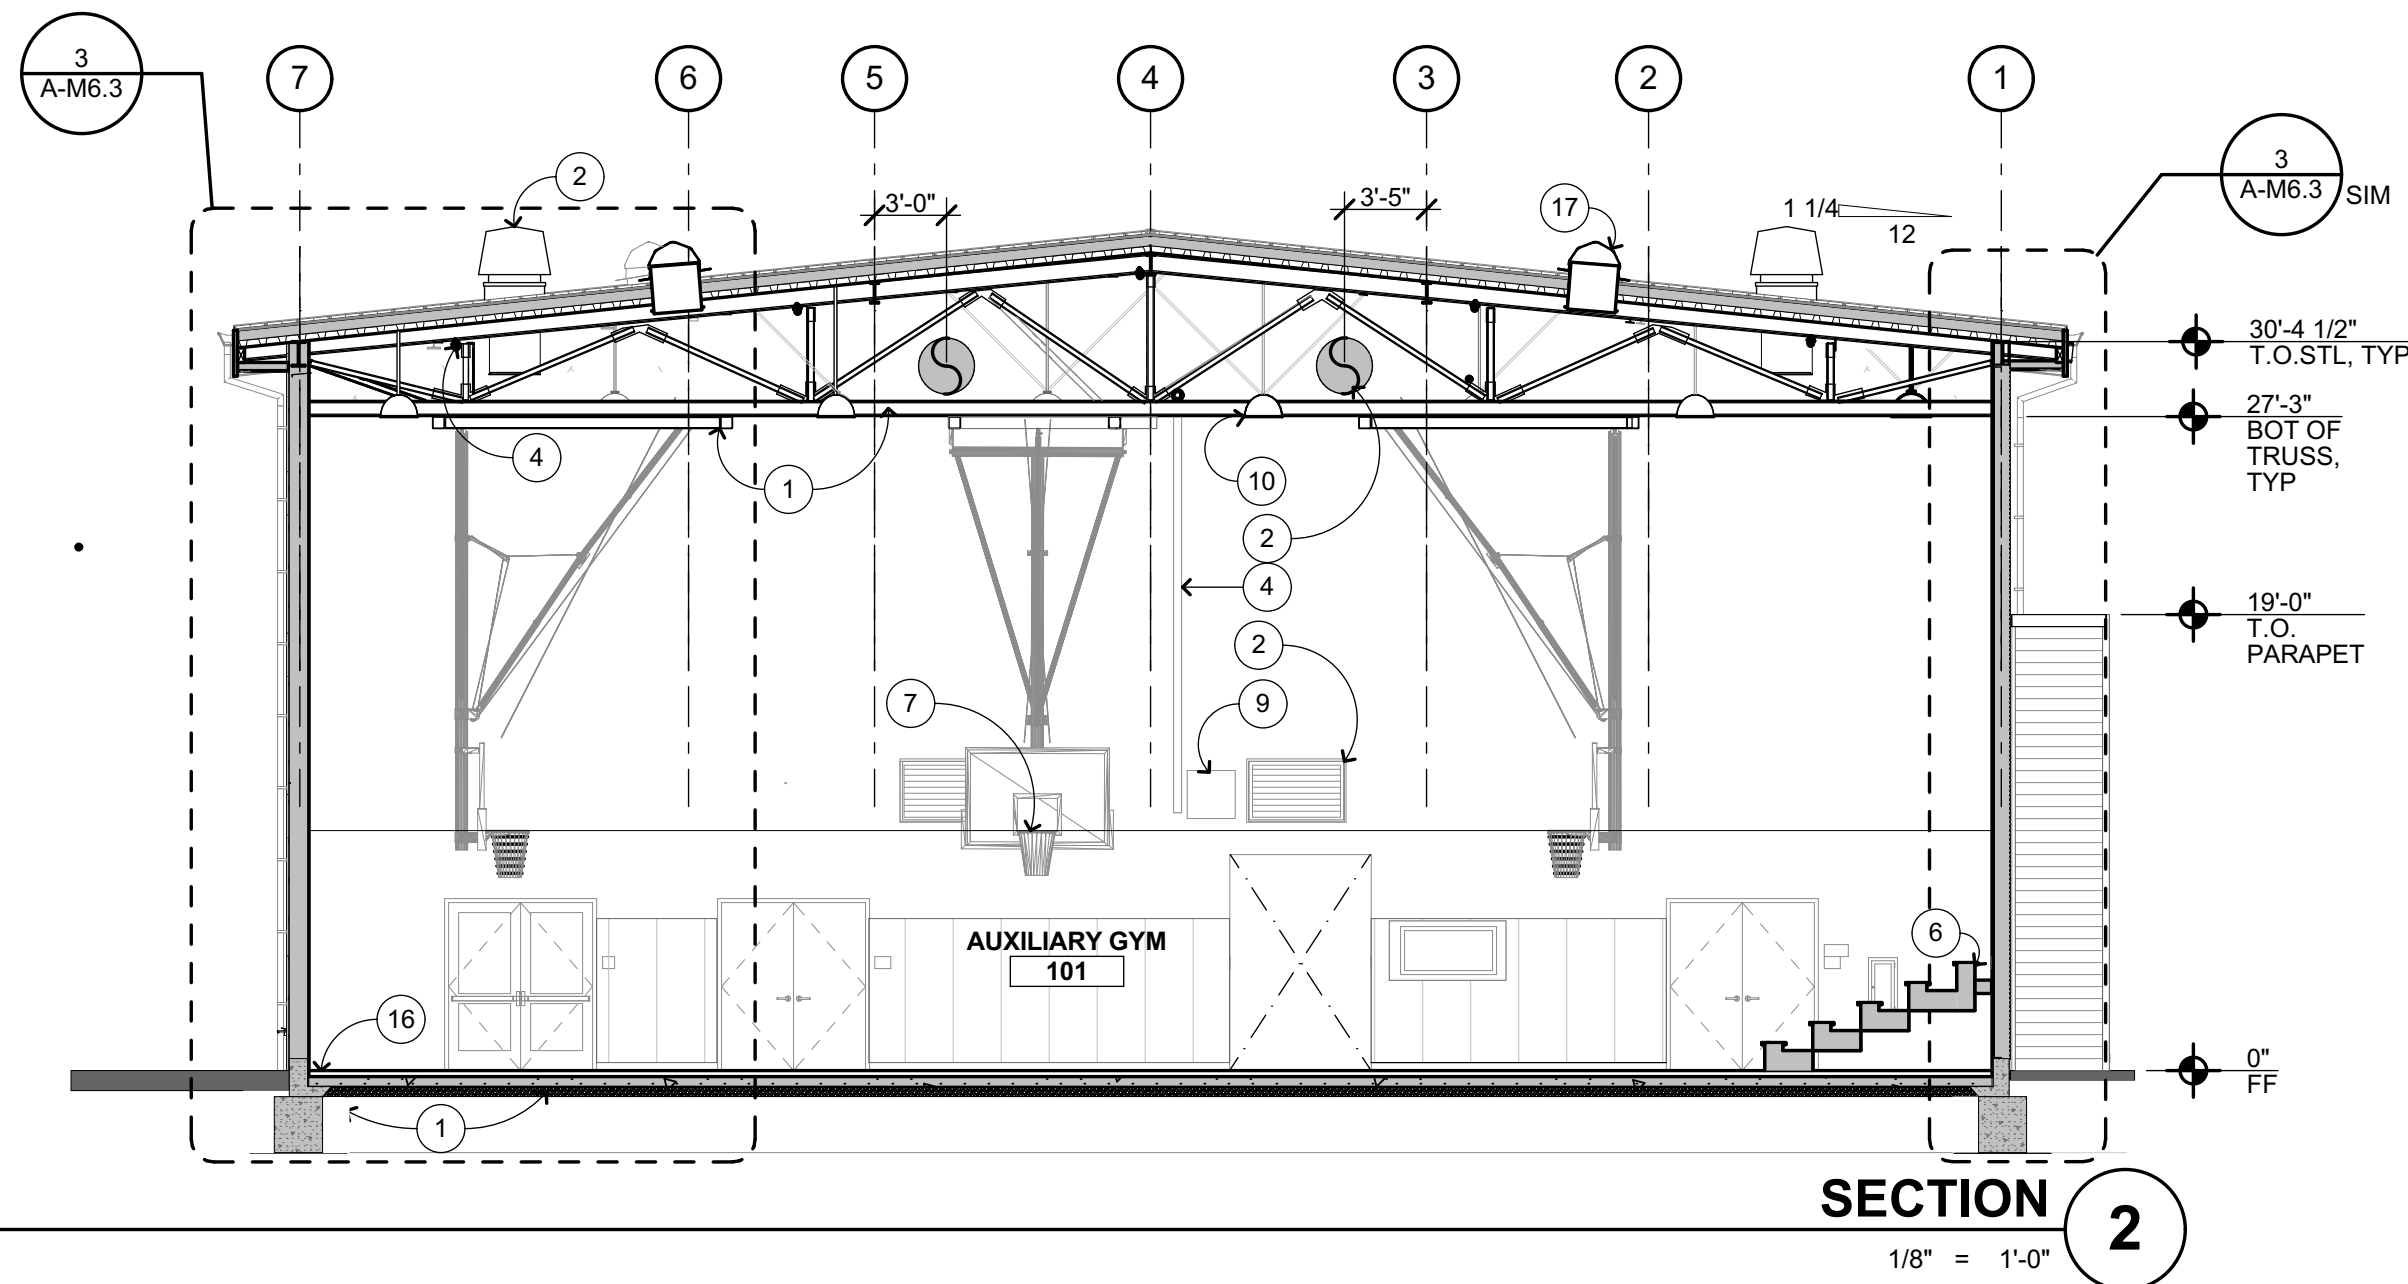
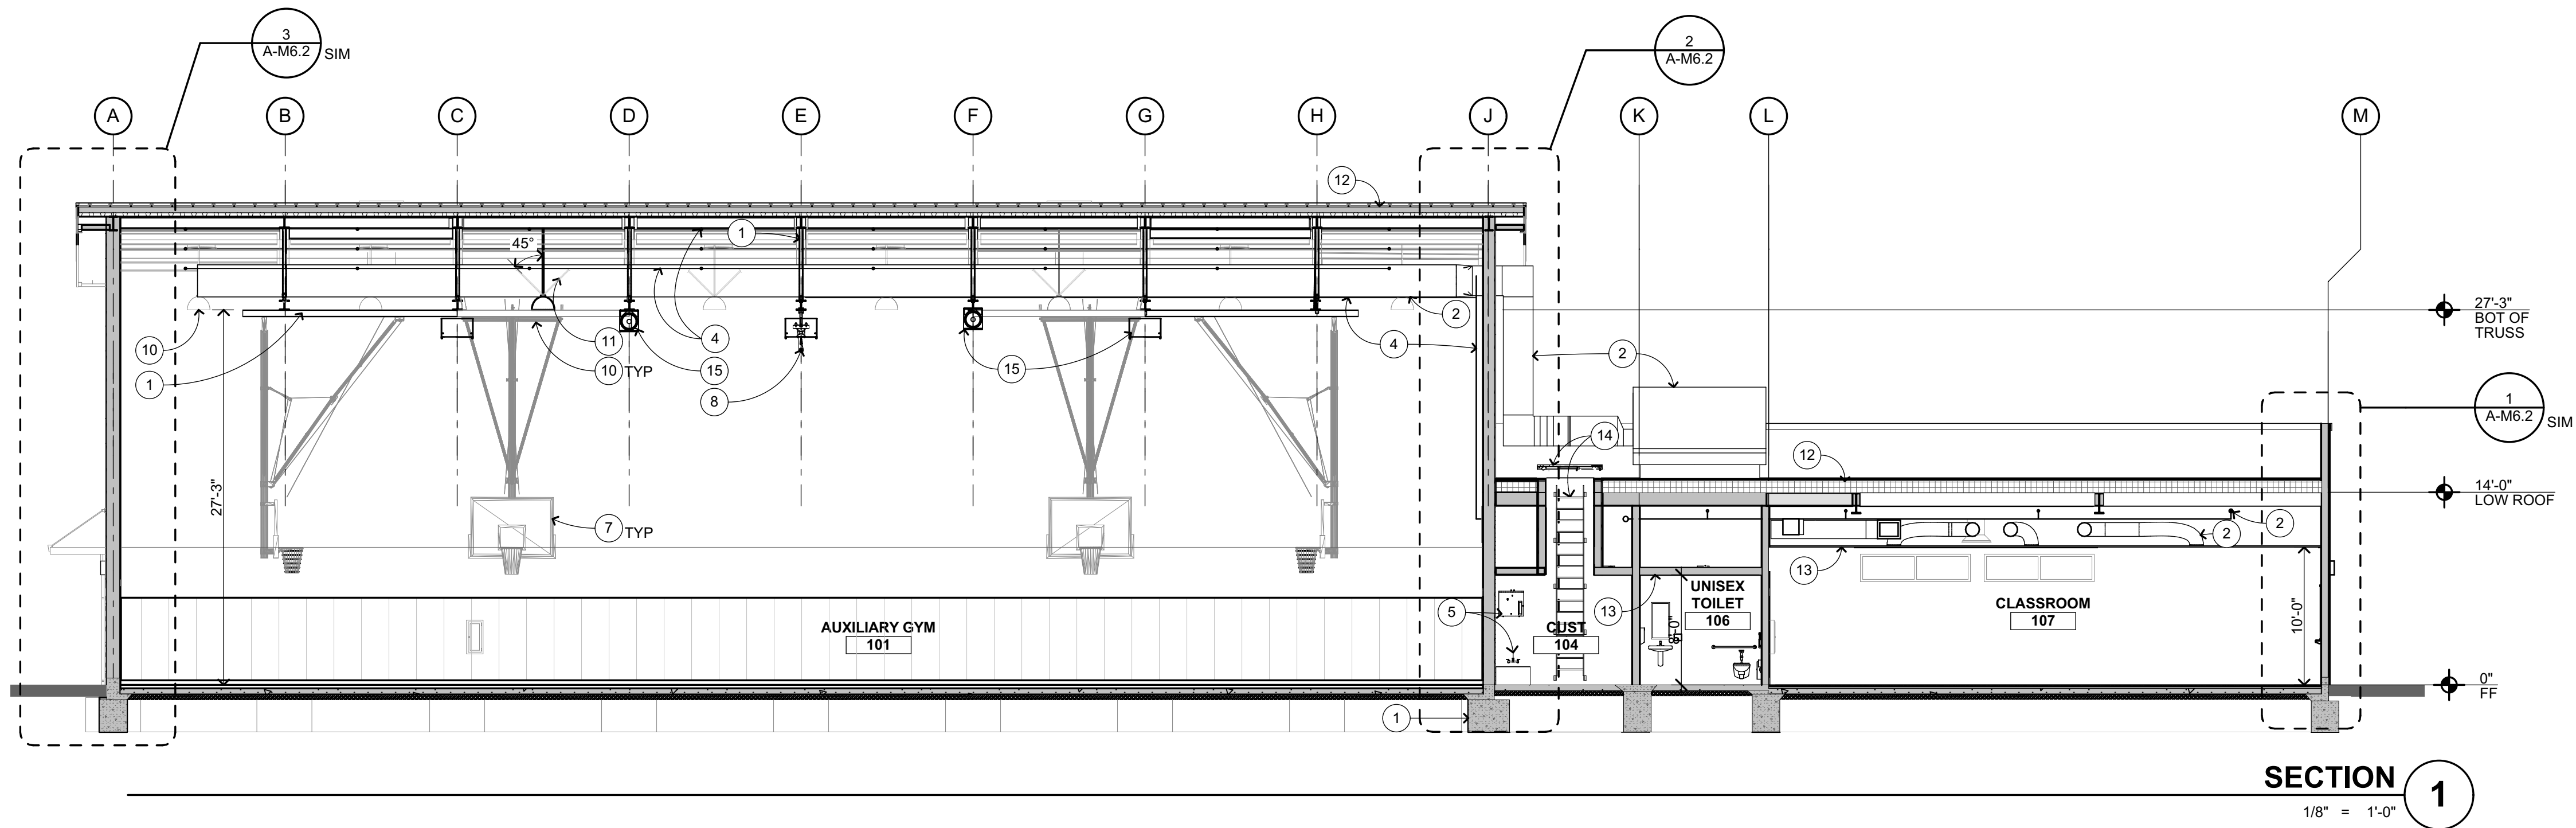
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#### EXTERIOR ELEVATIONS

SHEET NUMBER

**A-M5.1**





## SECTION KEYNOTES

NOT ALL KEYNOTES MAY APPLY TO THIS SHEET



- 1 STRUCTURAL FRAMING, S.S.D.
- 2 MECHANICAL ITEM, S.M.D.
- 3 ELECTRICAL ITEM, S.E.D.
- 4 FIRE PROTECTION ITEM, S.F.P.D.
- 5 PLUMBING ITEM, S.P.D.
- 6 MOTORIZED TELESCOPIC BLEACHERS
- 7 MOTORIZED RETRACTABLE BASKETBALL EQUIPMENT ABOVE, S.E.D.
- 8 MOTORIZED DIVIDER CURTAIN, S.S.D. FOR SUPPORT
- 9 ELECTRONIC SPORTS DEVICE
- 10 LIGHT FIXTURE, S.E.D.
- 11 BRACING WIRE, S.E.D.
- 12 ROOF ASSEMBLY, SEE ROOF PLAN
- 13 CEILING, SEE RCP
- 14 ROOF ACCESS LADDER AND HATCH
- 15 AUDIO VISUAL ITEM, S.A.V.D.
- 16 DEPRESSED SLAB AT GYM
- 17 TUBULAR SKYLIGHTS

## SECTION GENERAL NOTES


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3. PROVIDE OPENING FLASHINGS AT ALL WINDOWS, DOORS, LOUVERS AND SIMILAR WALL OPENINGS
4. PROVIDE FIRESTOPPING AT CONCEALED SPACES, INCLUDING BETWEEN STAIR STRINGERS & BETWEEN STUDS WITH STAIR RUN, FURRED SPACES, CEILING/FLOOR LEVELS AND 10'-0" INTERVALS ALONG LENGTHS OF WALL, SOFFITS, DROP CEILINGS, AND COVE CEILINGS PER CBC 718.
5. REFER TO INTERIOR ELEVATIONS FOR WALL FINISHES AND INFORMATION NOT SHOWN, TYPICAL.
6. REFER TO FLOOR PLAN FOR FLOOR FINISHES, TYPICAL.
7. REFER TO REFLECTED CEILING PLAN FOR CEILING FINISHES, TYPICAL.
8. REFER TO MECHANICAL DRAWINGS FOR REGISTERS AND VENTS NOT OTHERWISE SHOWN.
9. REFER TO ELECTRICAL DRAWINGS FOR HORNS, SPEAKERS, PULL STATIONS AND OTHER FEATURES NOT OTHERWISE SHOWN.

RELATIVE ELEVATION DIMENSION FROM FINISH FLOOR

## KEYPLAN

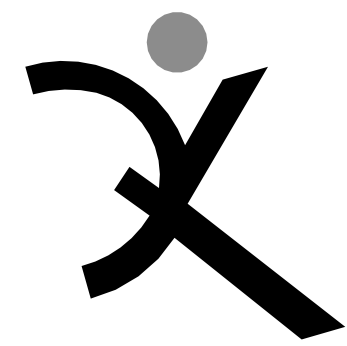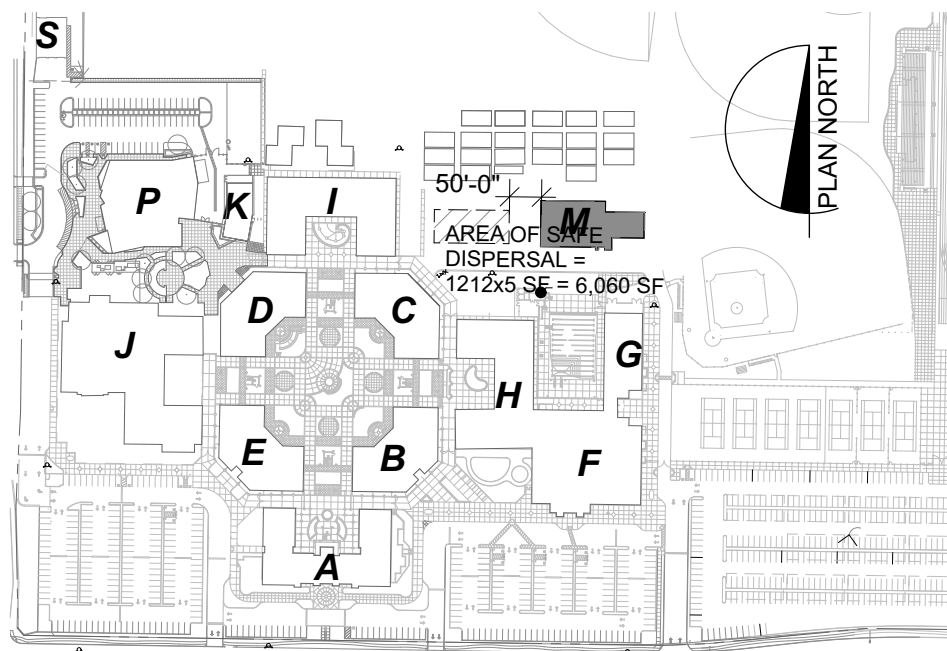

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Main:  
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ARCH PROJECT NO: 1869.00

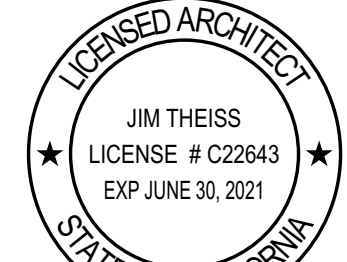DRAWN BY: GRD

DRAWING SCALE: 1/8" = 1'-0"

PTN: 61721-78 FILE NO: 7-H4

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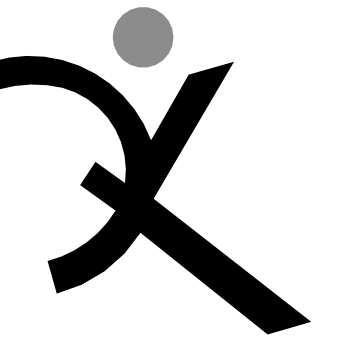
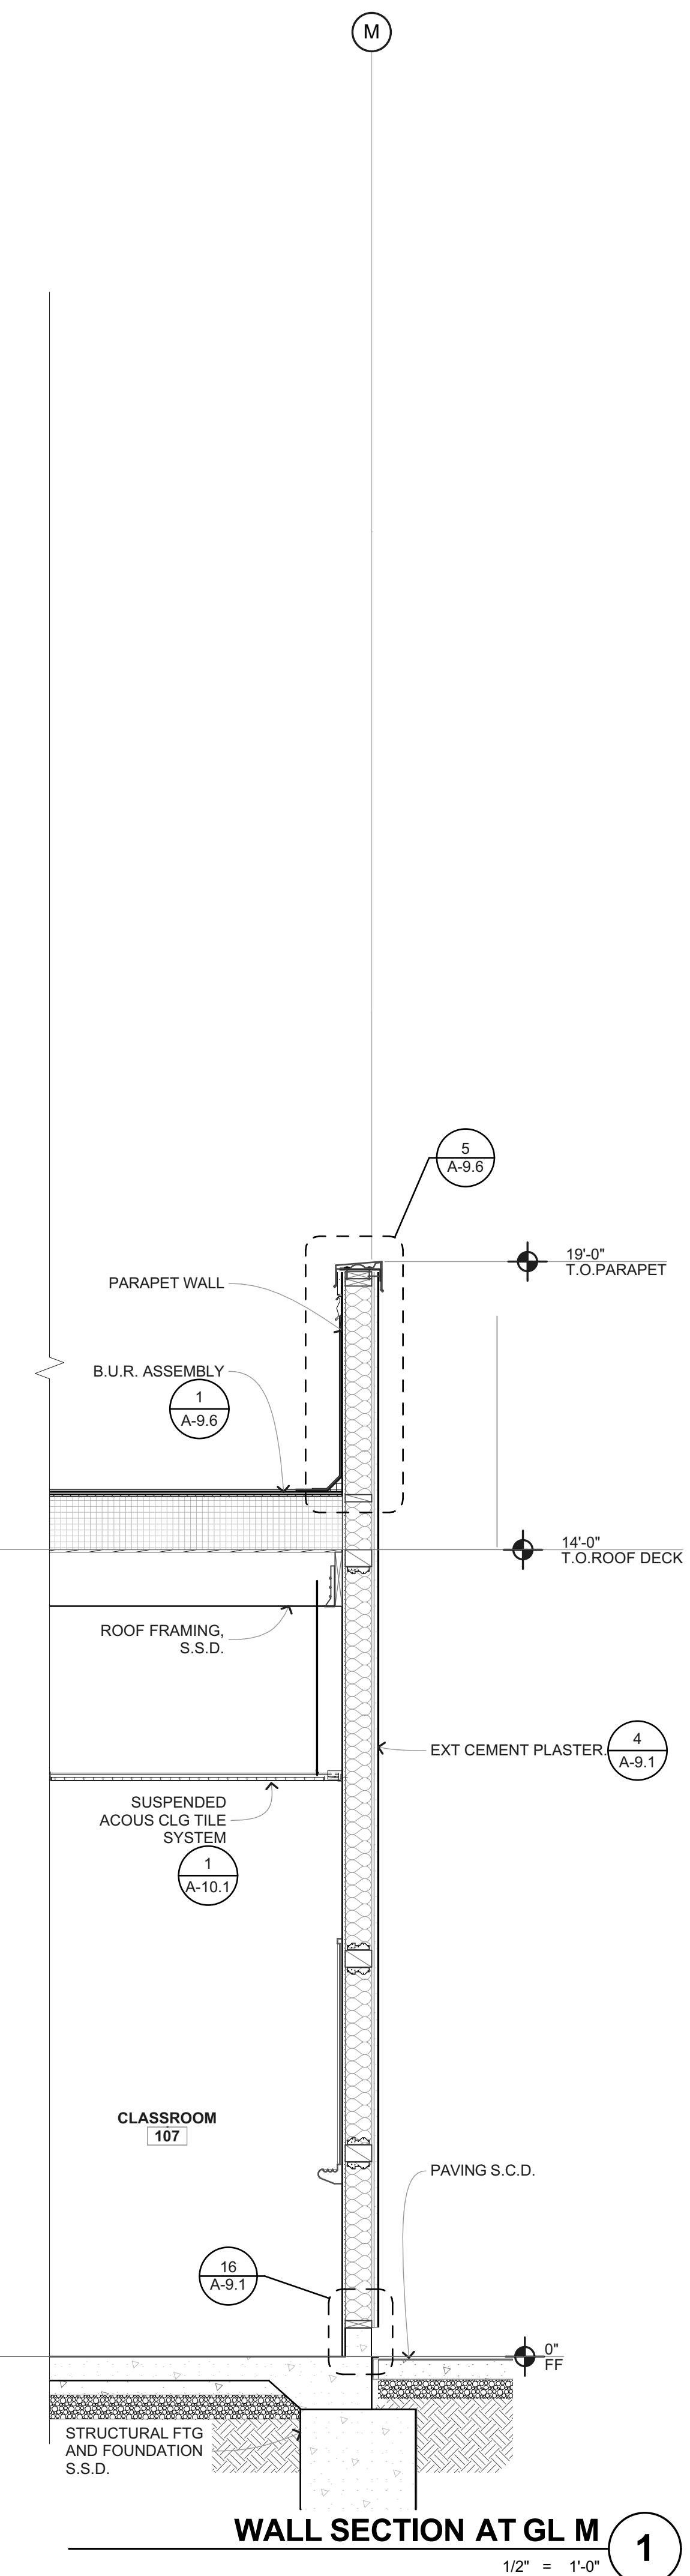
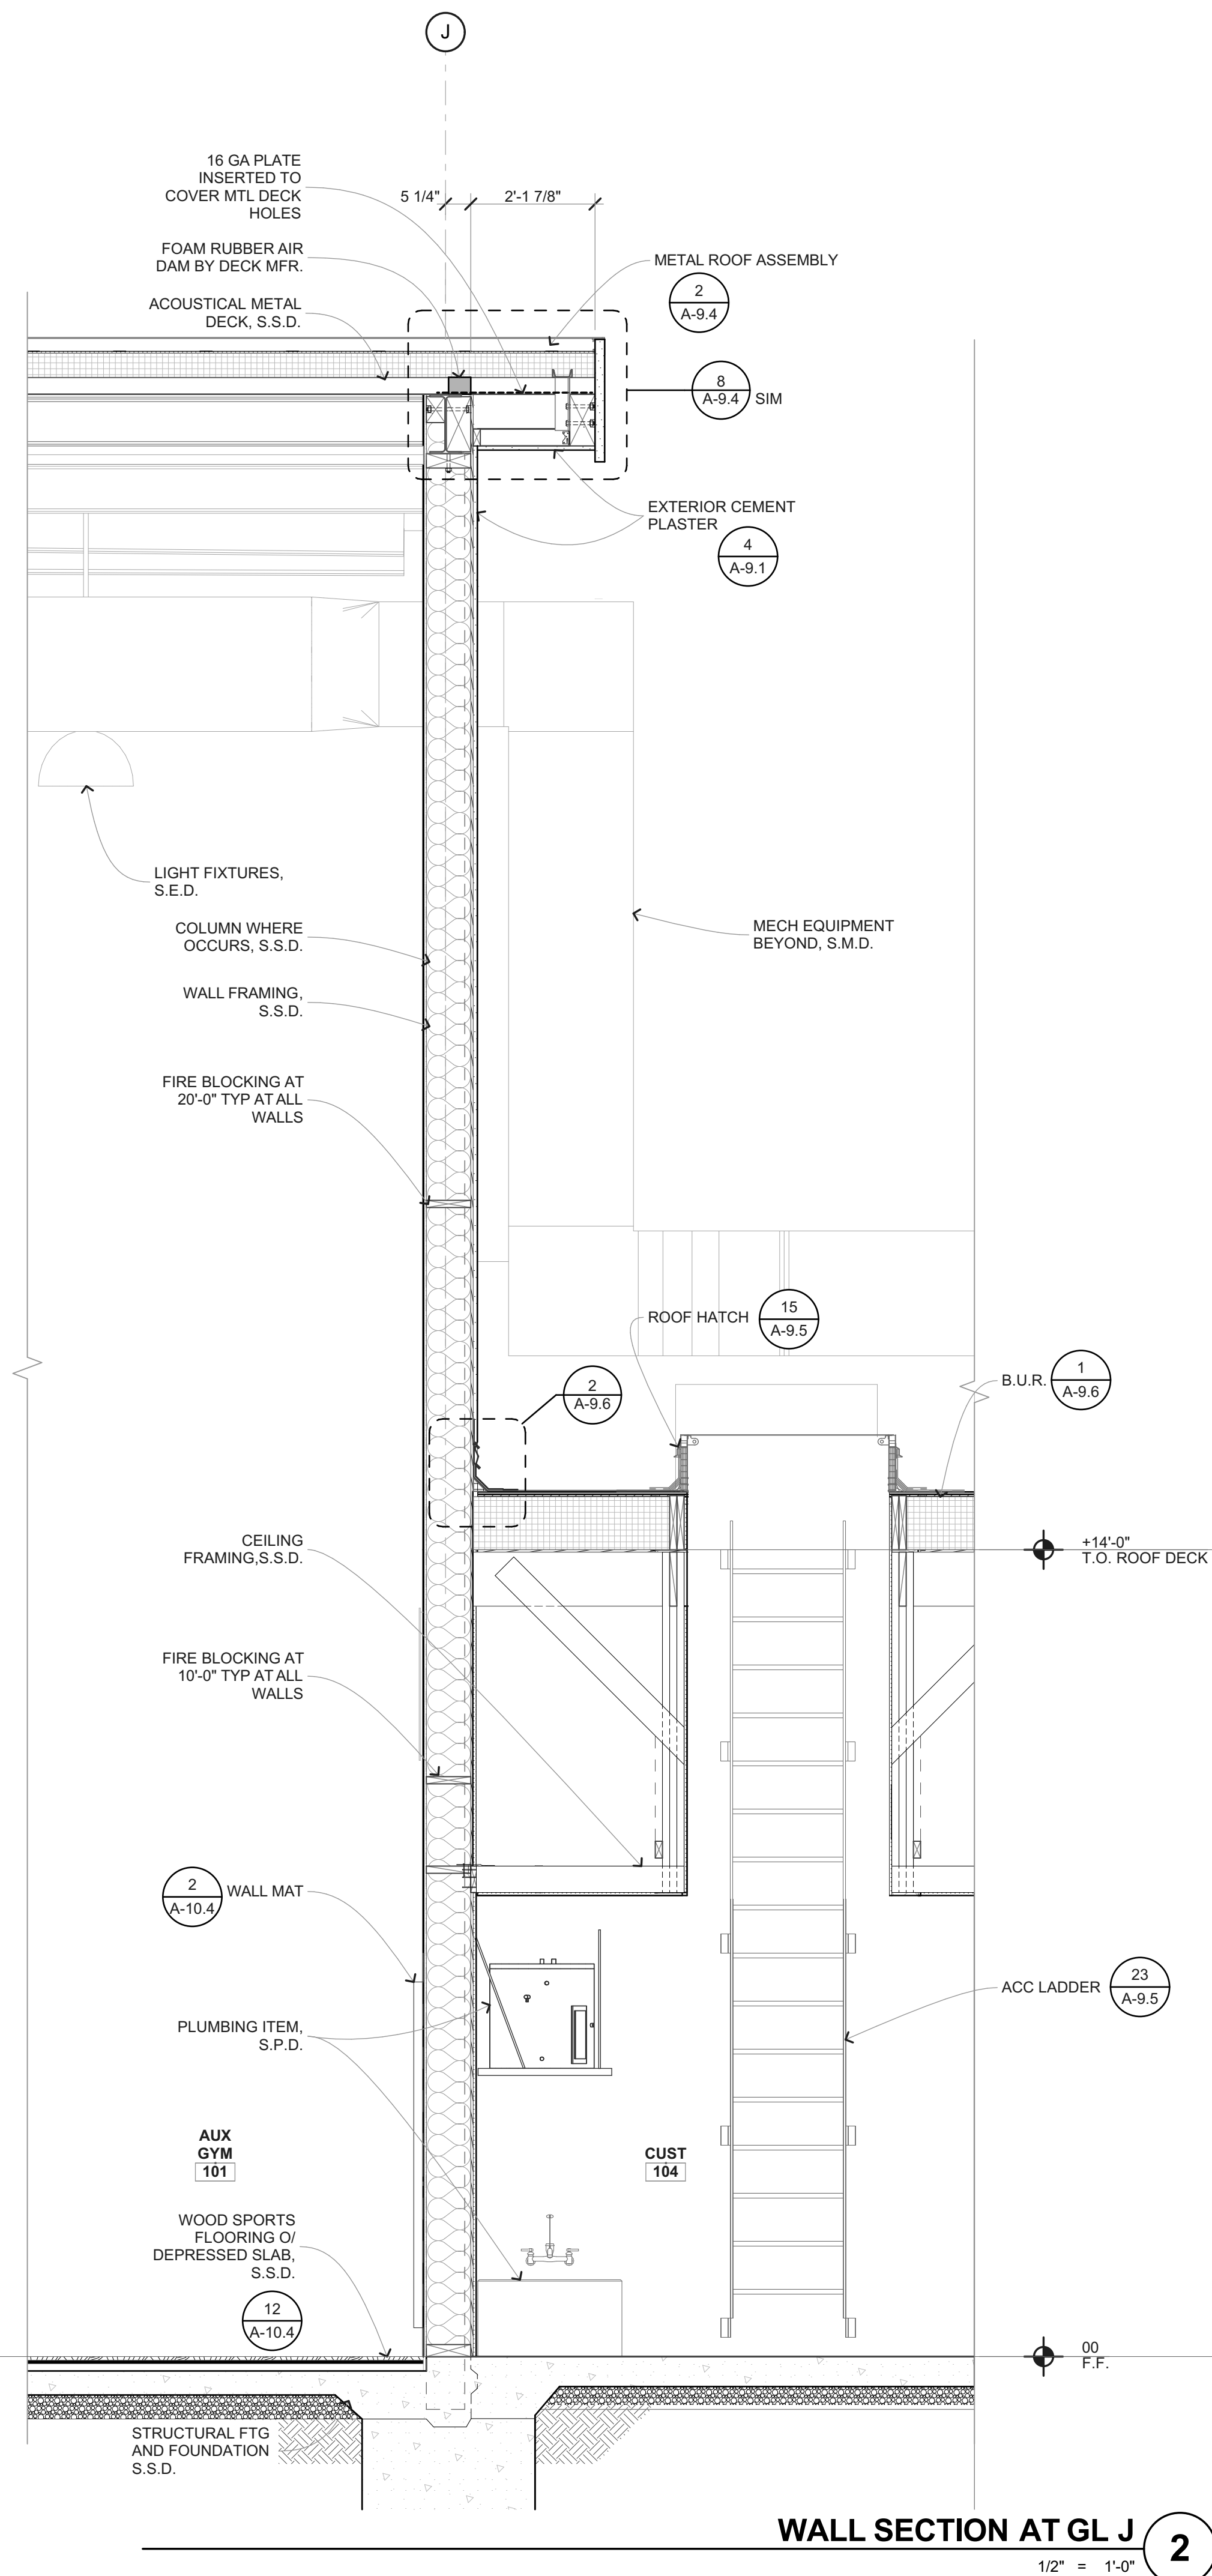
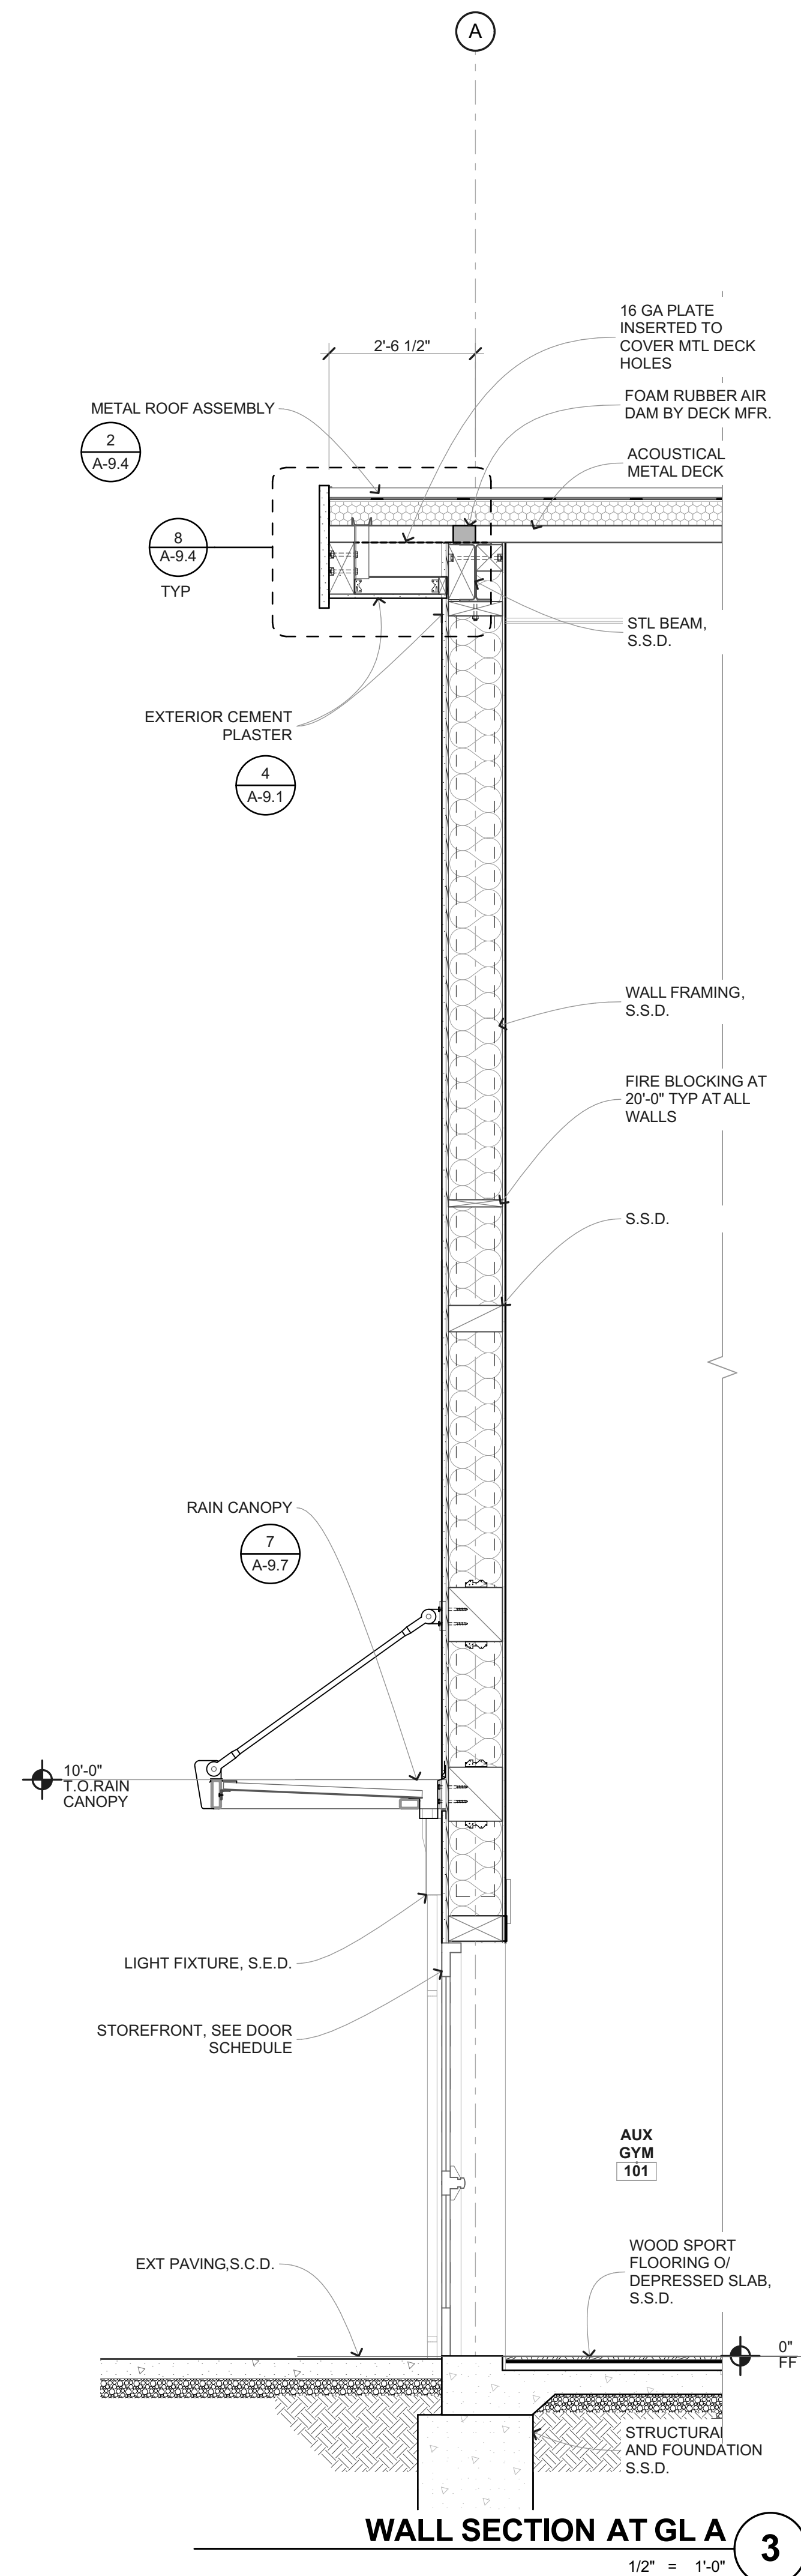
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SHEET NUMBER

# A-M6.1



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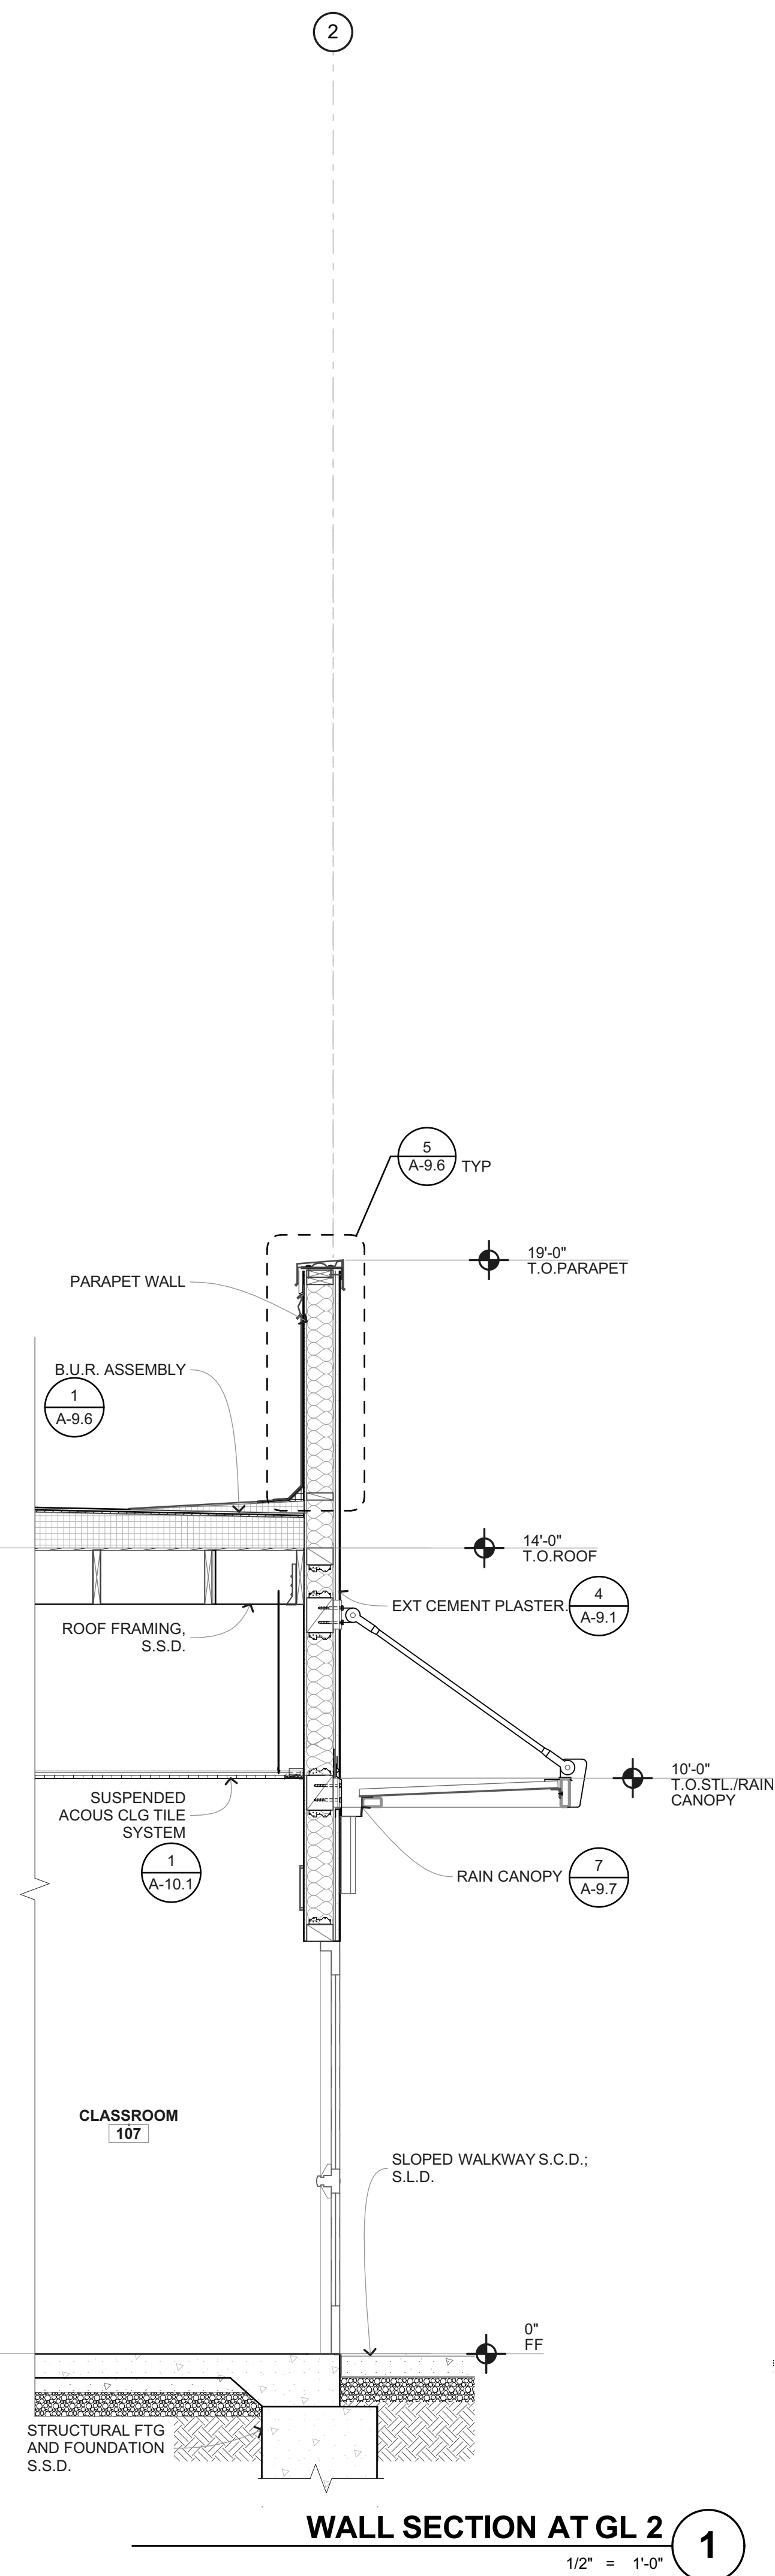
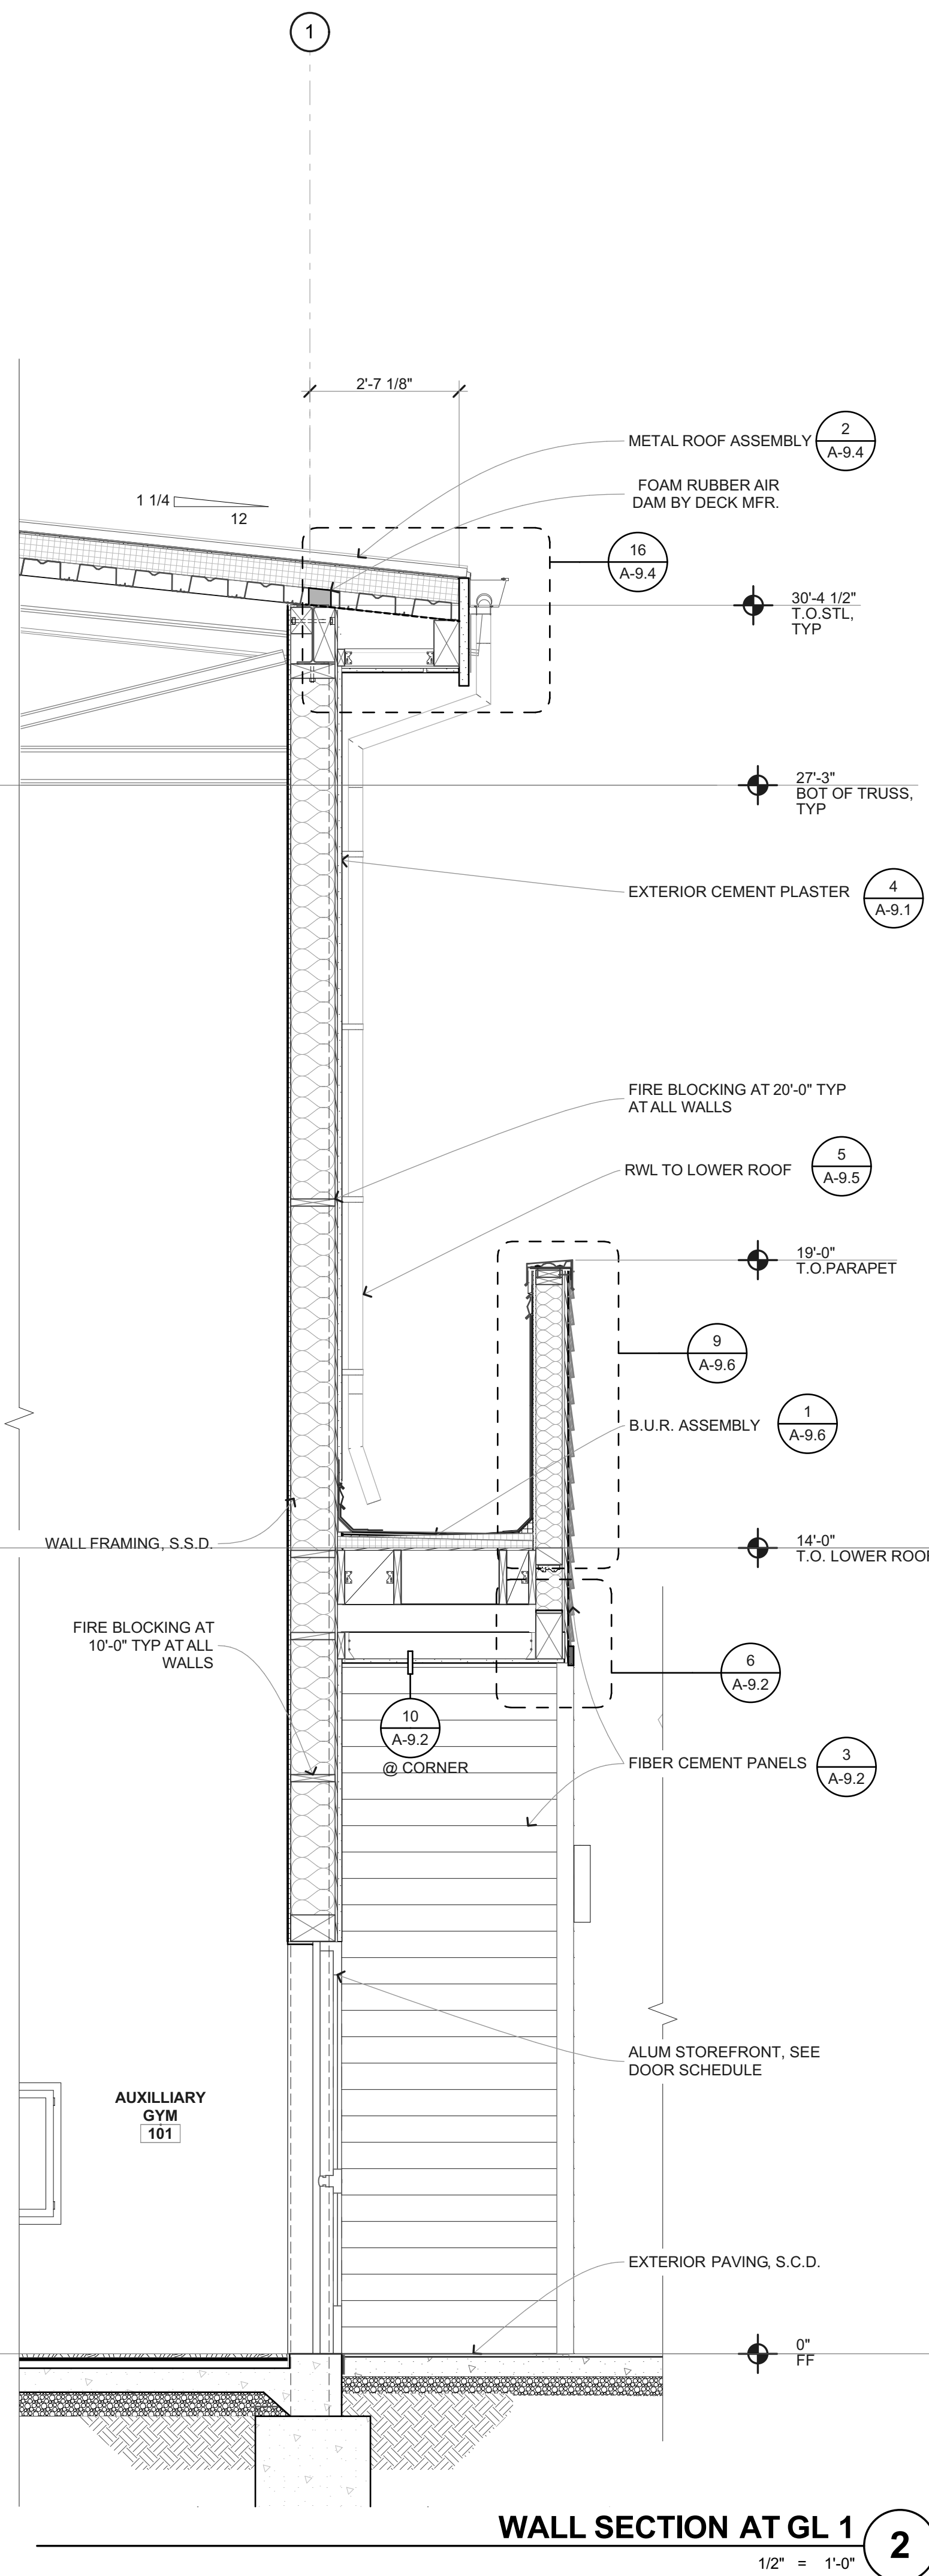
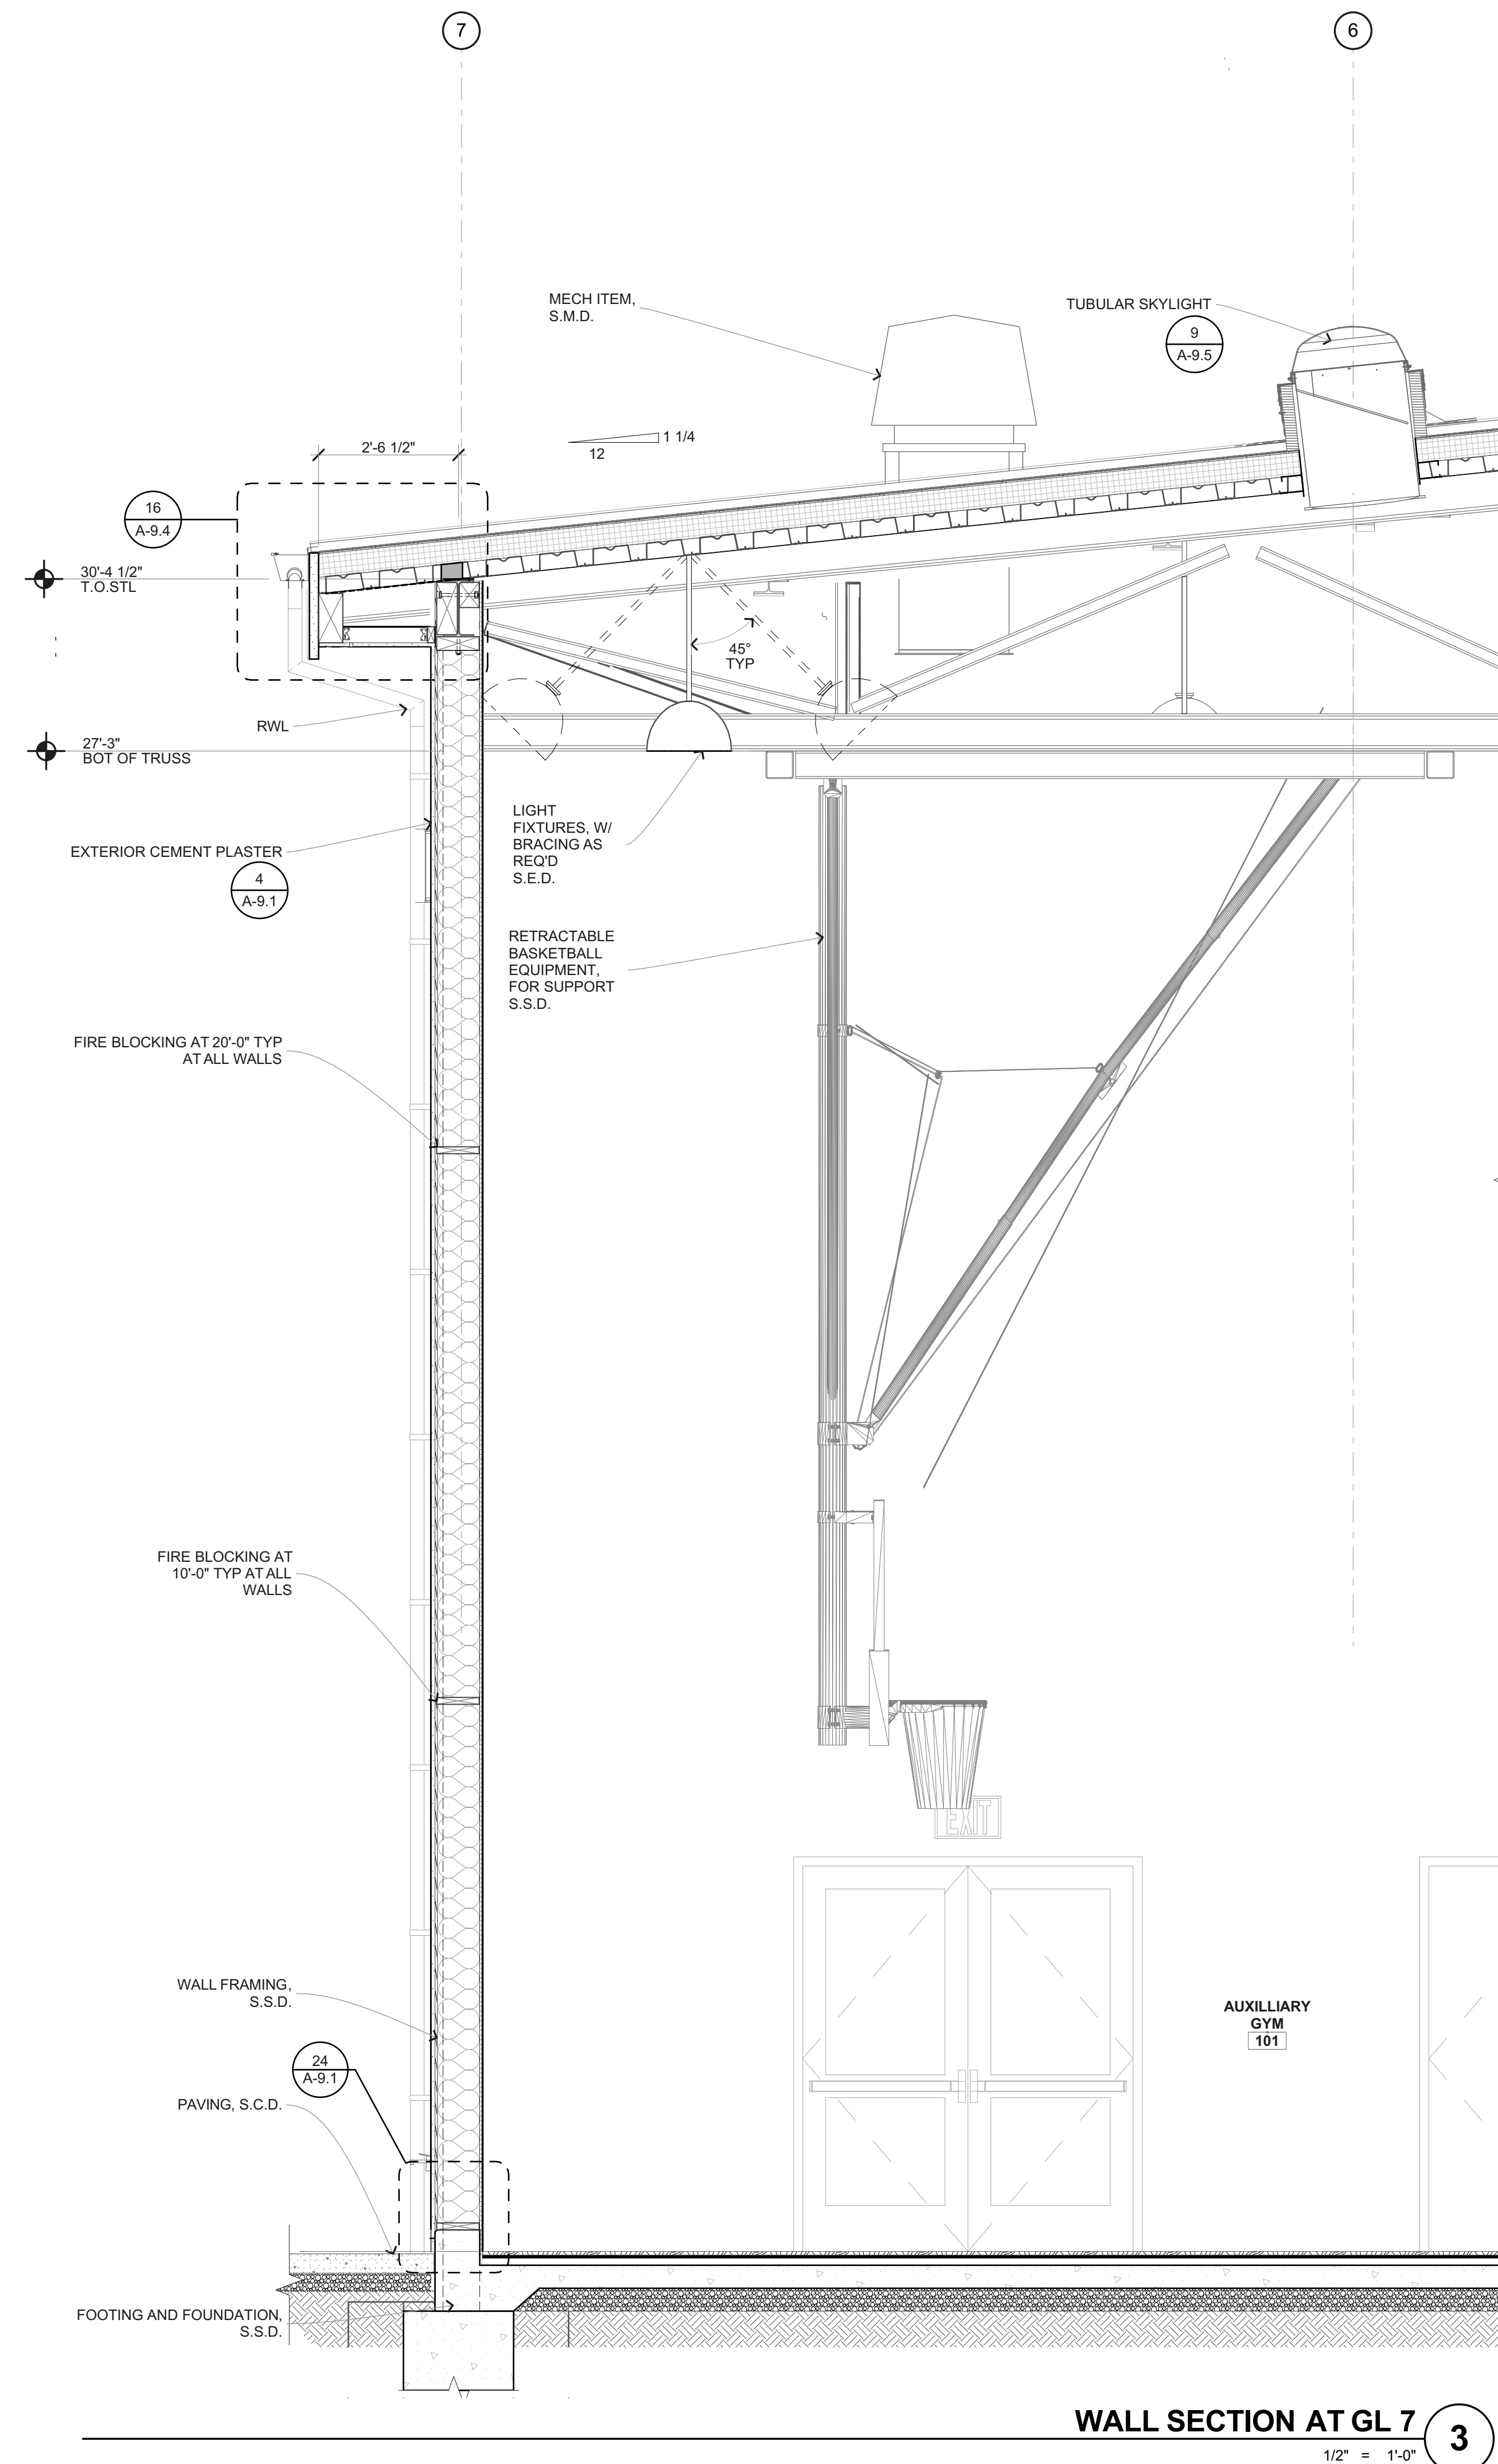
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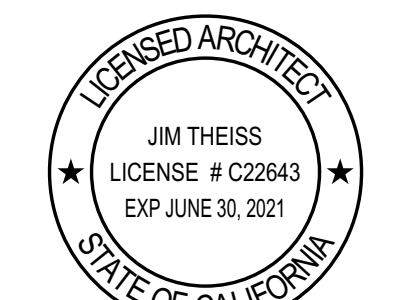


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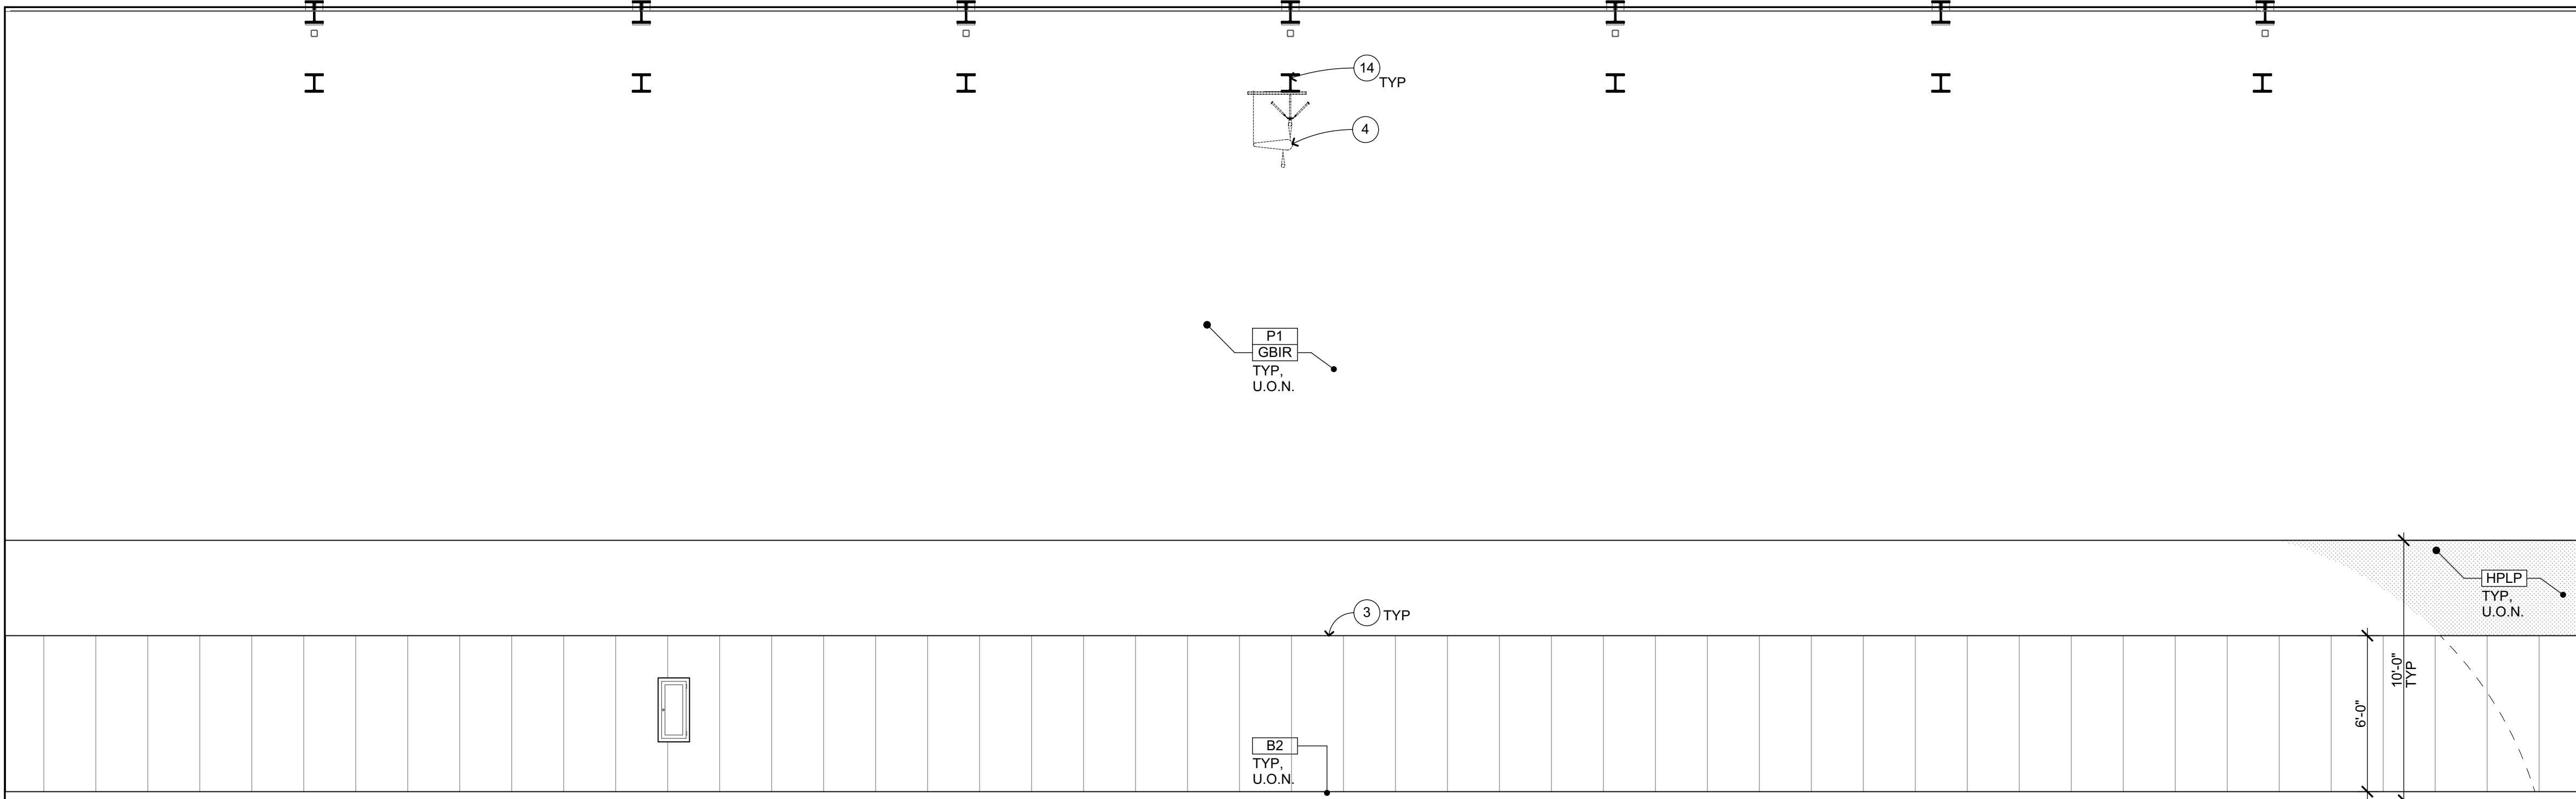
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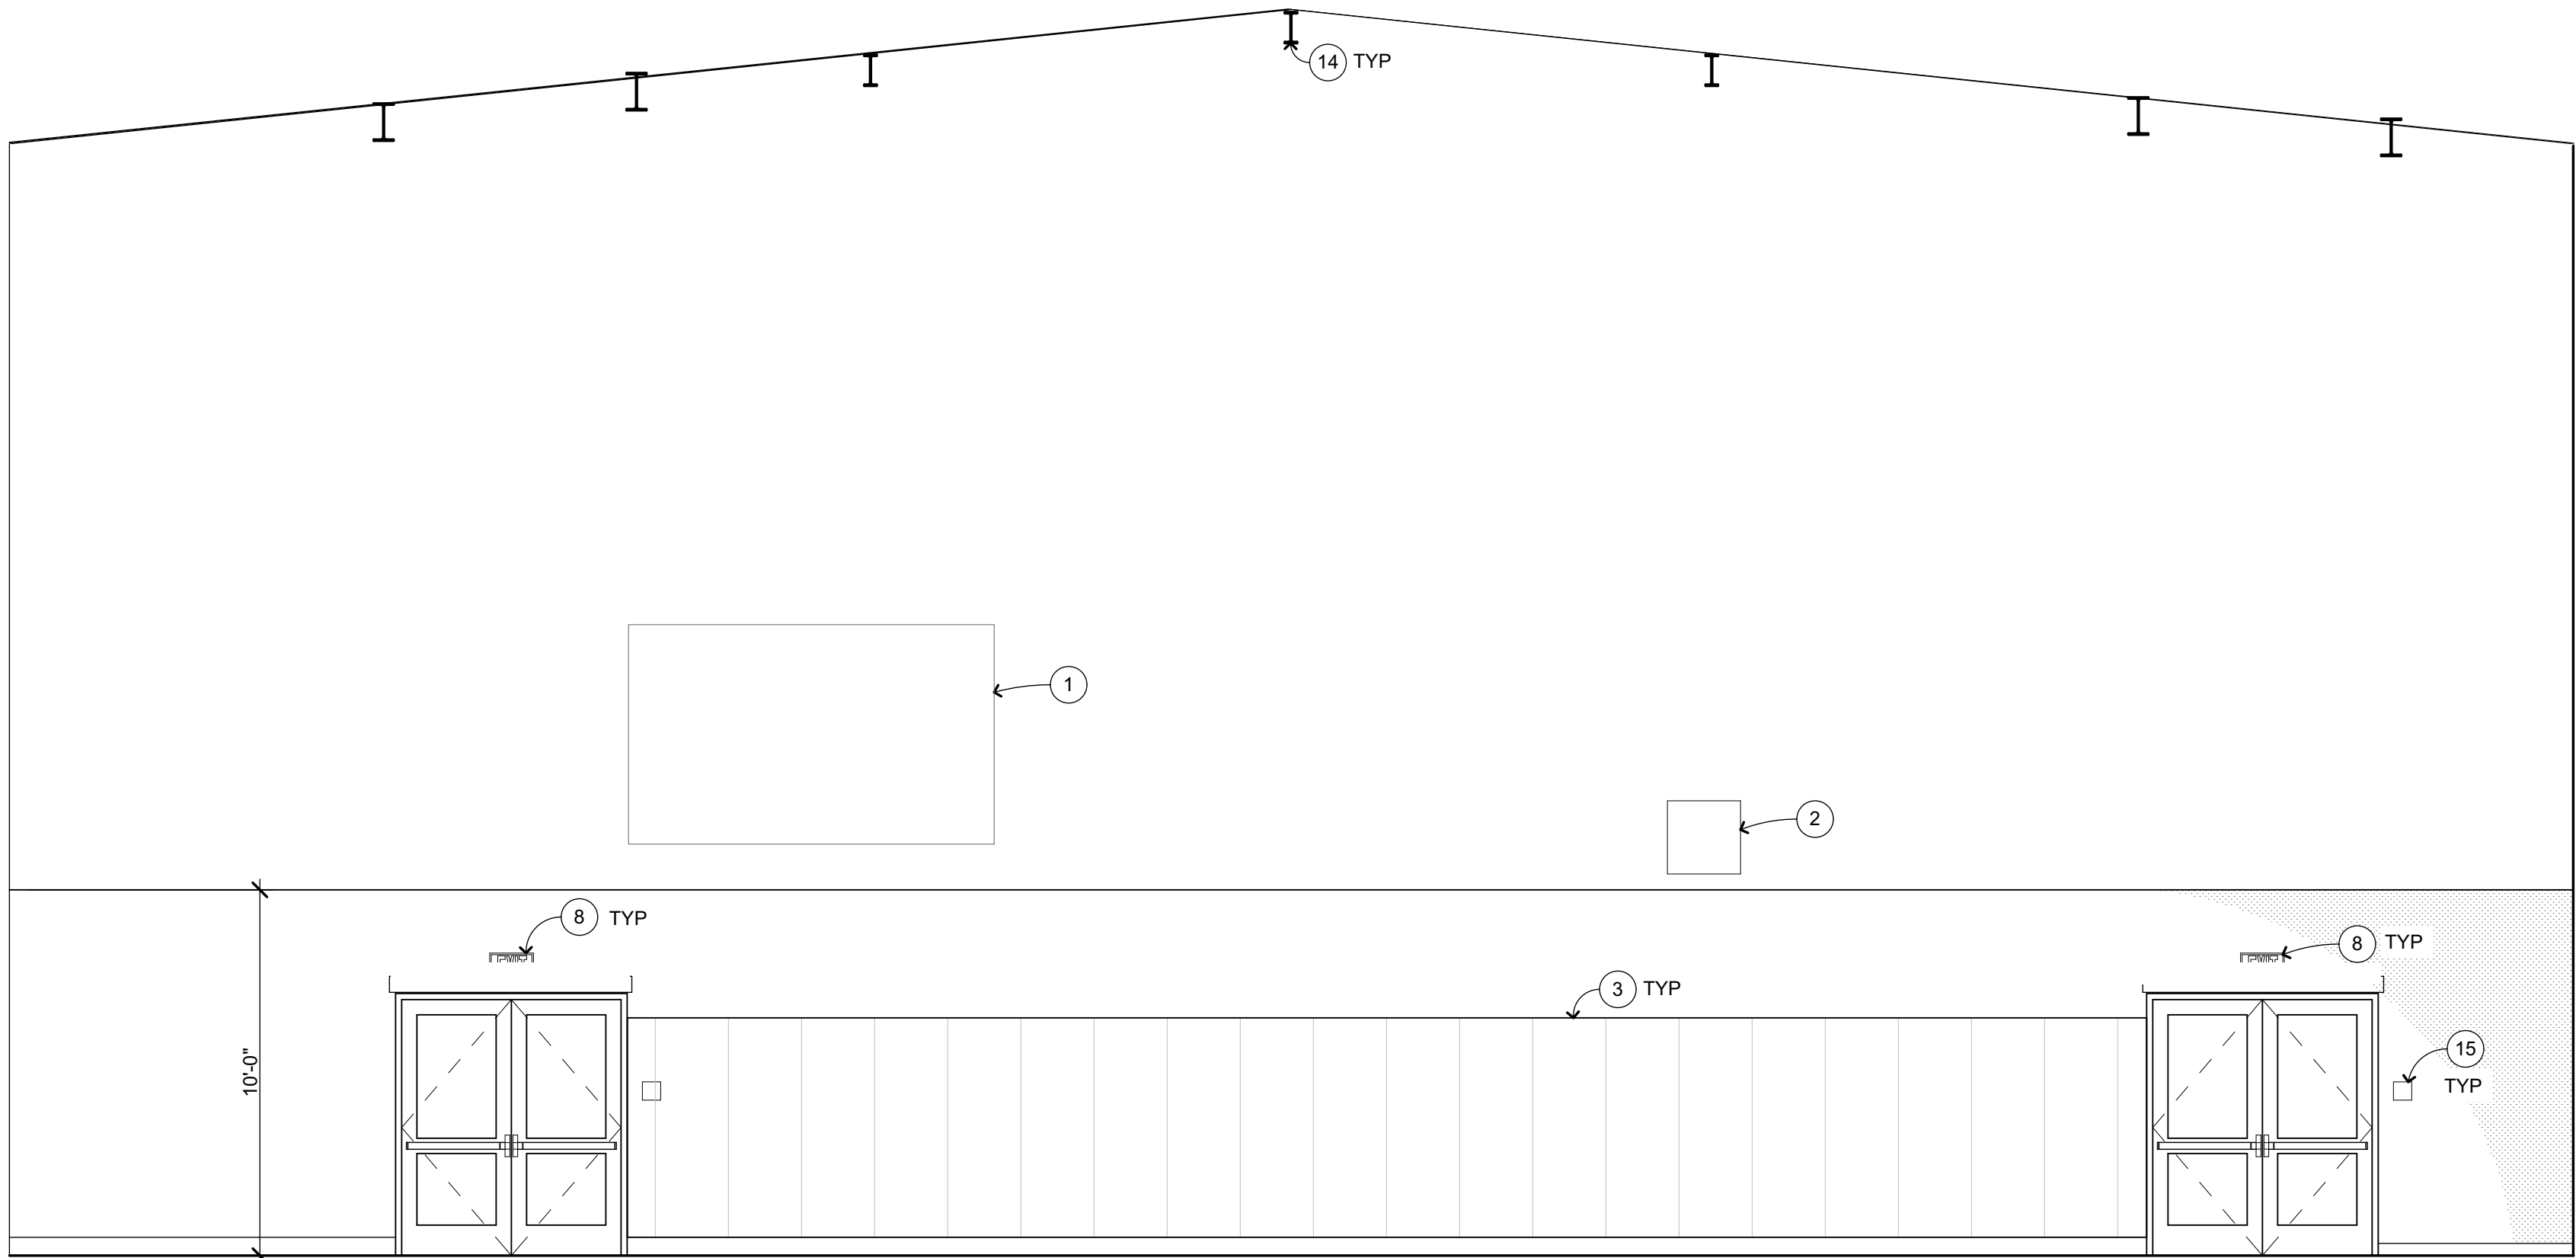
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NORTH



WEST

AUXILIARY GYMNASIUM

101

1/4" = 1'-0"

A-M2.1

### INTERIOR ELEVATION KEYNOTES

NOT ALL KEYNOTES MAY APPLY TO THIS SHEET

- SCOREBOARD, PROVIDE BLKG PER
- SHOT CLOCK
- WALL PADS, SEE DETAIL
- MOTORIZED DIVIDER CURTAIN, S.S.D. FOR SUPPORT
- MOTORIZED TELESCOPIC BLEACHERS
- MECHANICAL ITEM, S.M.D.
- SEMI-RECESSED FIRE CABINET AND EXTINGUISHER, SEE
- ELECTRICAL ITEM, S.E.D.
- MARKER BOARD
- PLUMBING ITEM, S.P.D.
- SHORT THROW PROJECTOR, PROVIDE BLKG
- AV RACK, SEE AV DRAWINGS
- ROOF ACCESS LADDER
- TRUSS/BEAM/JOIST (PAINTED), S.S.D.
- SIGNAGE, SEE DETAIL
- WING WALL


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- REFER TO MECHANICAL DRAWINGS FOR REGISTERS AND VENTS NOT OTHERWISE SHOWN.
- REFER TO ELECTRICAL DRAWINGS FOR HORNS, SPEAKERS, PULL STATIONS AND OTHER FEATURES NOT OTHERWISE SHOWN.
- TYPICAL MOUNTING HEIGHTS OF ACCESSIBLE ELEMENTS AT ACCESSIBLE FIXTURES
- FLOORING & BASE SHALL EXTEND UNDER ACCESSIBLE SINK/LAVATORY BASE CABINETS TO THE WALL. HOT WATER AND DRAINPIPES ACCESSIBLE UNDER LAVATORIES SHALL BE INSULATED OR OTHERWISE COVERED. THERE SHALL BE NO SHARP OR ABRASIVE SURFACES UNDER LAVATORIES.
- PROVIDE SOLID BLOCKING FOR CABINET, ACCESSORY, OR EQUIPMENT MOUNTING

### WALL AND BASE FINISH CODES

FOR PAINT FINISHES SEE SEC. 099123 INTERIOR PAINTING, ALL GYP BD TO BE TYPE 'X'			
P1	PAINT 1	WP1	FRP PANEL O/ MOISTURE
P2	PAINT 2		RESISTANT GYP BD
AP1	ACOUSTICAL WALL PANELS	PLY1	3/4" MDO FIRE RATE PLYWOOD
		HPLP	HIGH PRESSURE LAMINATED
GBMR	GYP BD - MOISTURE		PANEL
	RESISTANT	CG1	CORNER GUARDS
GBIR	GYP BD - IMPACT RESISTANT		
WT1	WALL TILE - DALTILE 0100	B1	4" RESILIENT BASE
	WHITE		(COVERED AT RESILIENT
WT2	WALL TILE - DALTILE X114	B2	TILE FLOORING)
	DESSERT GRAY		
WT3	WALL TILE - DALTILE RED OR	B2	4" RESILIENT BASE -
	BLUE (TBD)	EB1	VENTED
			EPOXY COVE BASE

### KEYPLAN

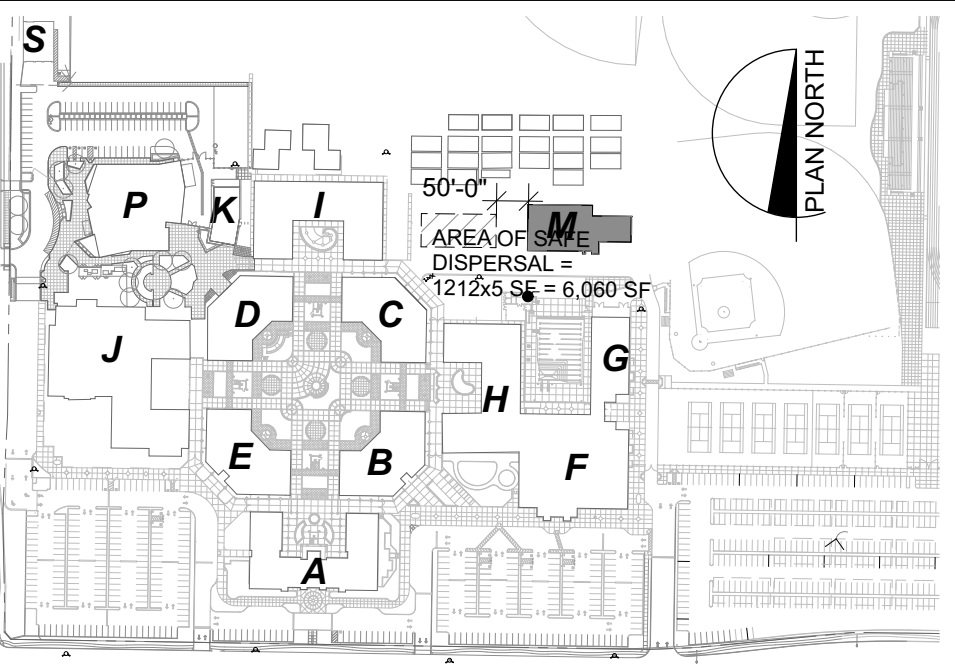

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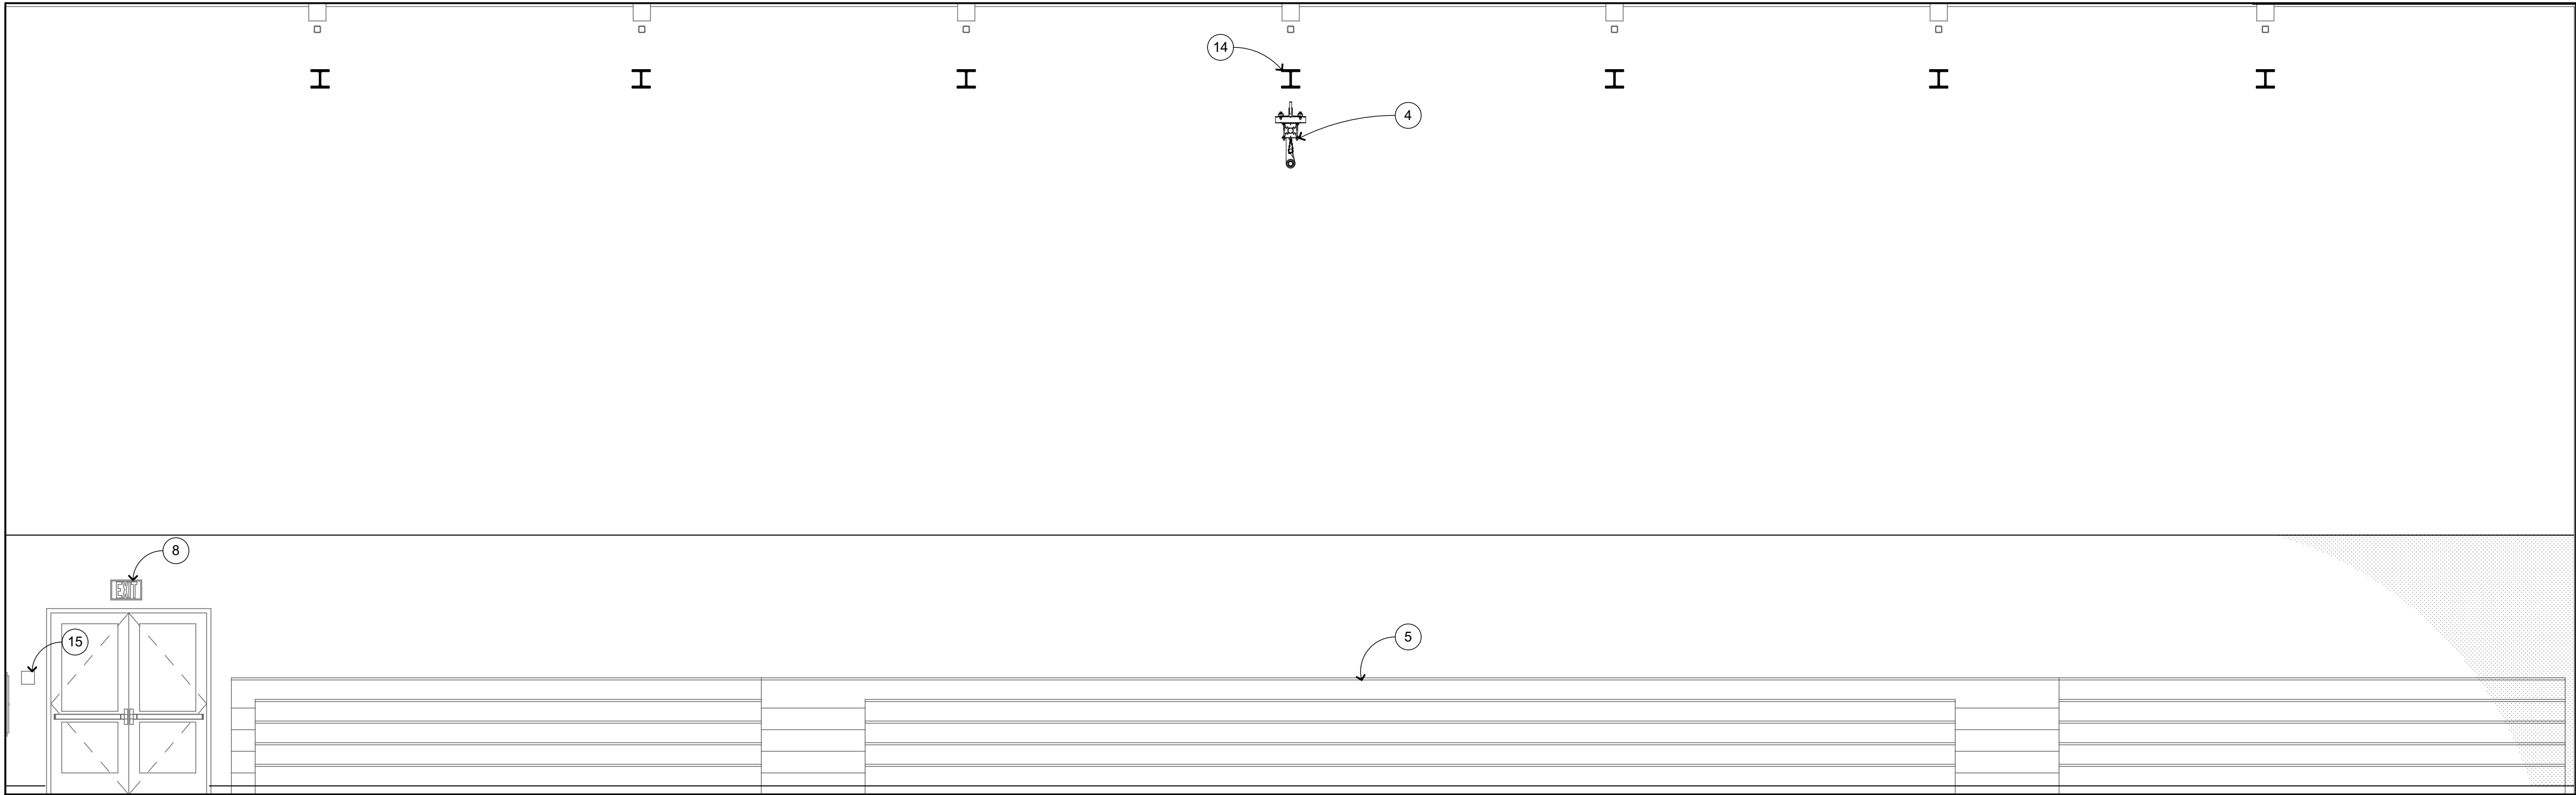
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INTERIOR  
ELEVATIONS


SHEET NUMBER

A-M7.1





SOUTH

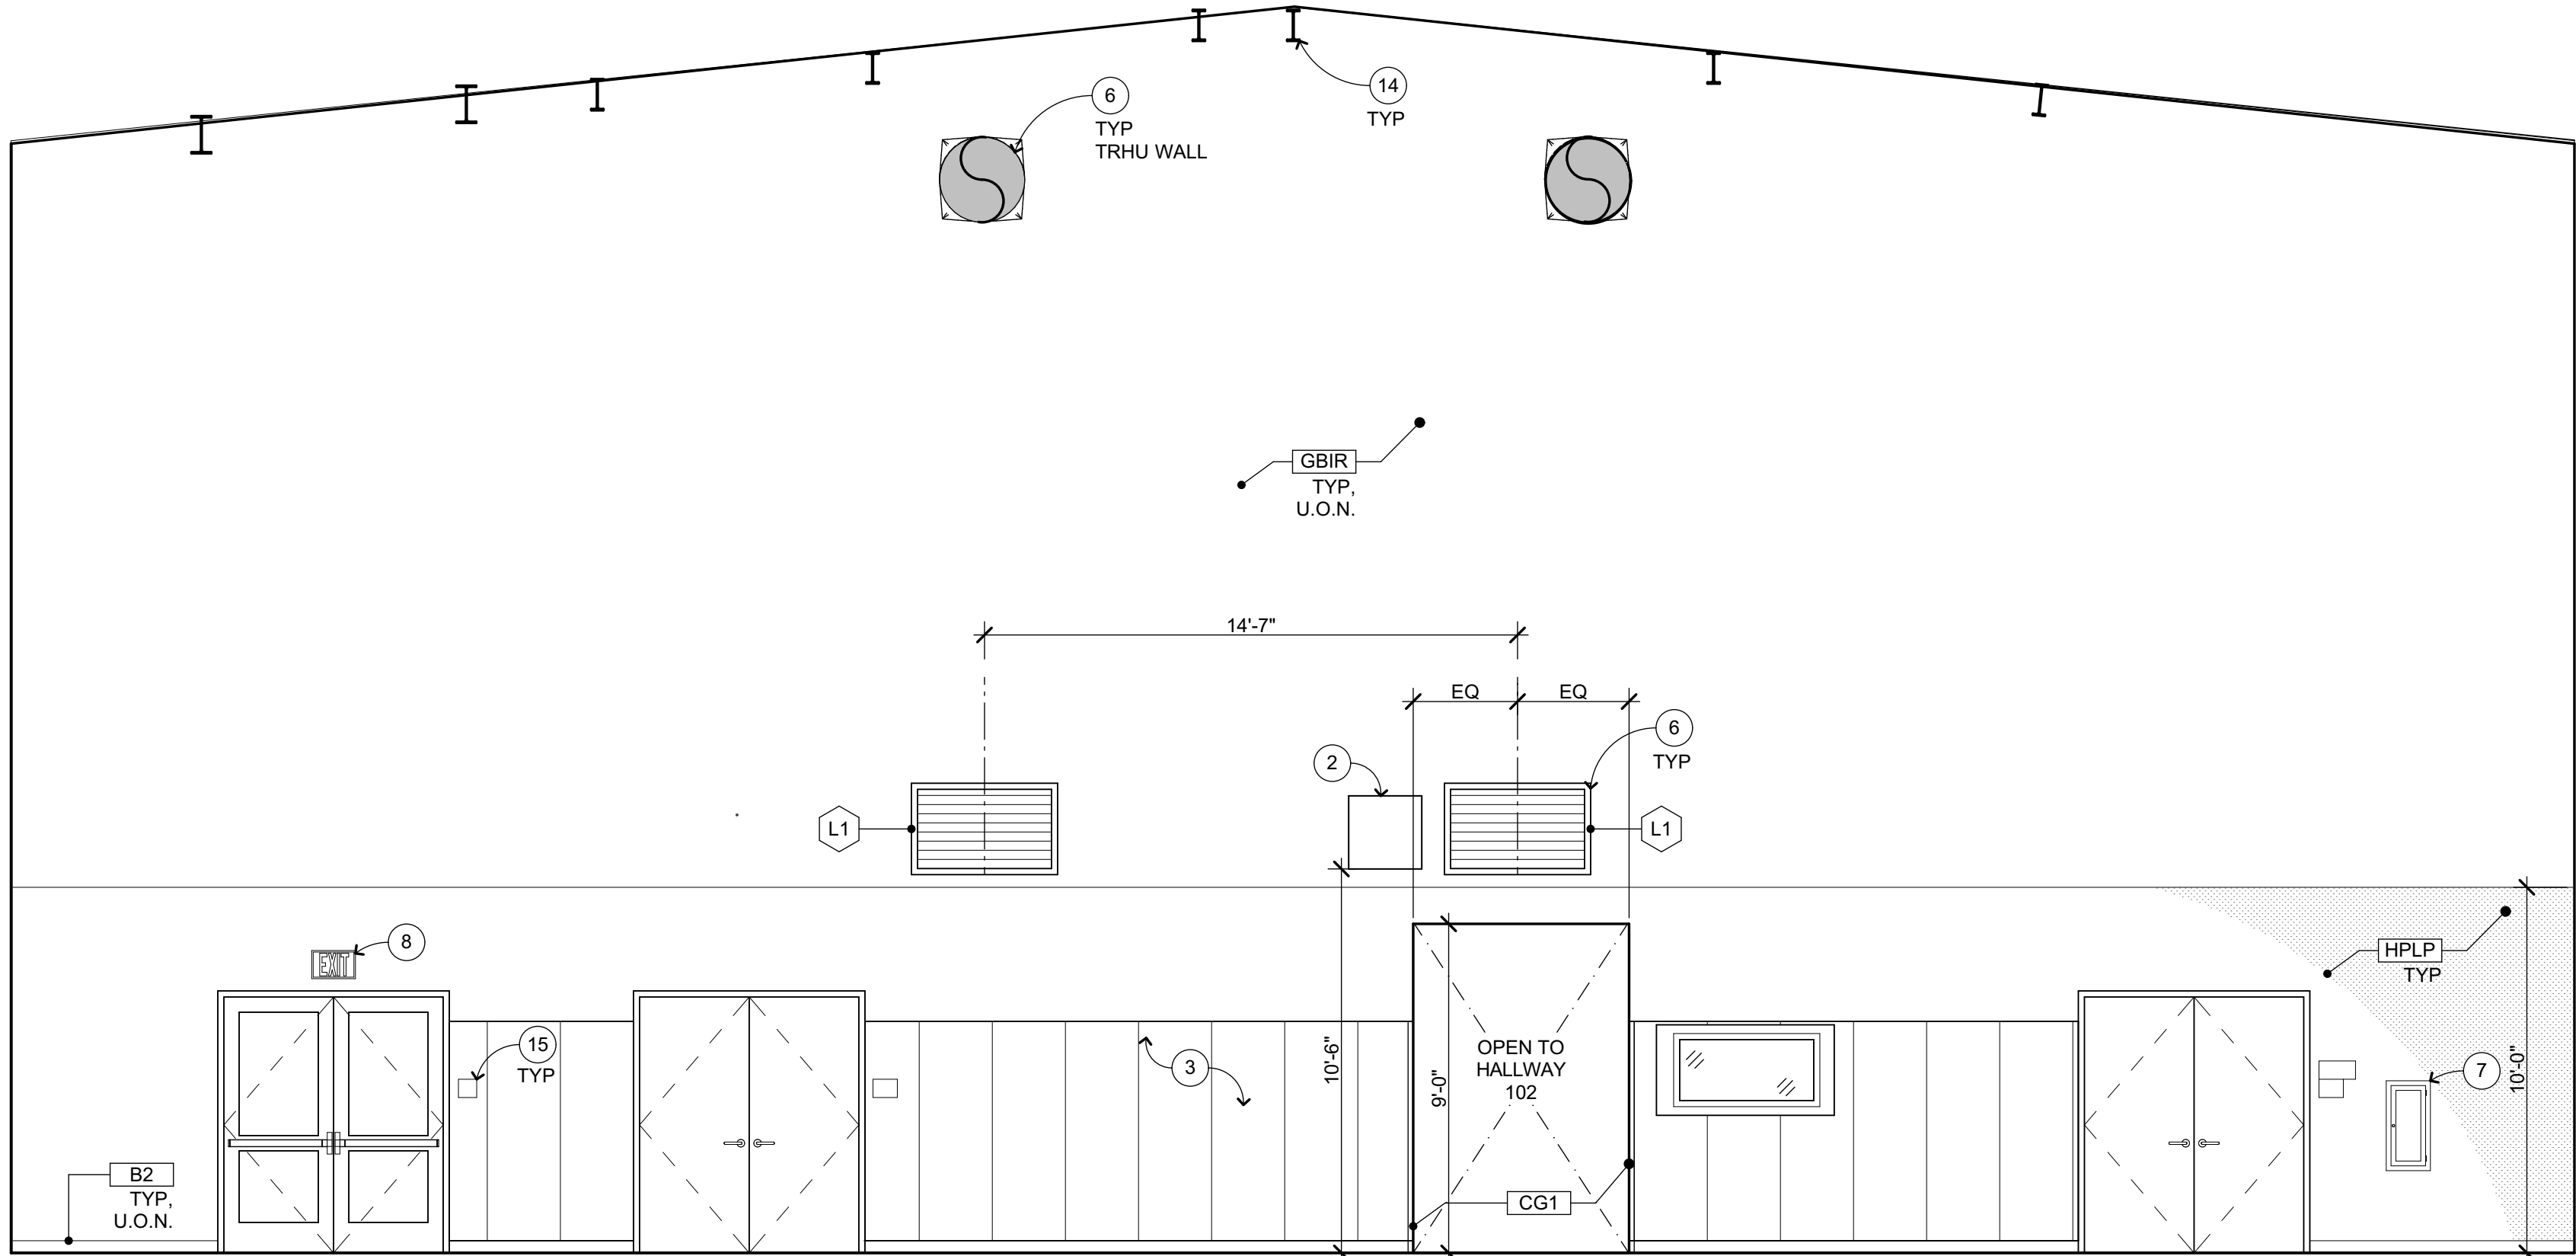

EAST

AUXILIARY GYMNASIUM

101

1/4" = 1'-0"

A-M2.1

### INTERIOR ELEVATION KEYNOTES

NOT ALL KEYNOTES MAY APPLY TO THIS SHEET

- SCOREBOARD, PROVIDE BLKG PER
- SHOT CLOCK
- WALL PADS, SEE DETAIL
- MOTORIZED DIVIDER CURTAIN, S.S.D. FOR SUPPORT
- MOTORIZED TELESCOPIC BLEACHERS
- MECHANICAL ITEM, S.M.D.
- SEMI-RECESSED FIRE CABINET AND EXTINGUISHER, SEE
- ELECTRICAL ITEM, S.E.D.
- MARKER BOARD
- PLUMBING ITEM, S.P.D.
- SHORT THROW PROJECTOR, PROVIDE BLKG
- AV RACK, SEE AV DRAWINGS
- ROOF ACCESS LADDER
- TRUSS/BEAM/JOIST (PAINTED), S.S.D.
- SIGNAGE, SEE DETAIL
- WING WALL



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- PROVIDE SOLID BLOCKING FOR CABINET, ACCESSORY, OR EQUIPMENT MOUNTING

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GBMR	GYP BD - MOISTURE	CG1	CORNER GUARDS
	RESISTANT		
GBIR	GYP BD - IMPACT RESISTANT		
WT1	WALL TILE - DALTILE 0100	B1	4" RESILIENT BASE (COVERED AT RESILIENT TILE FLOORING)
WT2	WALL TILE - DALTILE X114	B2	4" RESILIENT BASE - VENTED
WT3	WALL TILE - DALTILE RED OR BLUE (TBD)	EB1	EPOXY COVE BASE

### KEYPLAN



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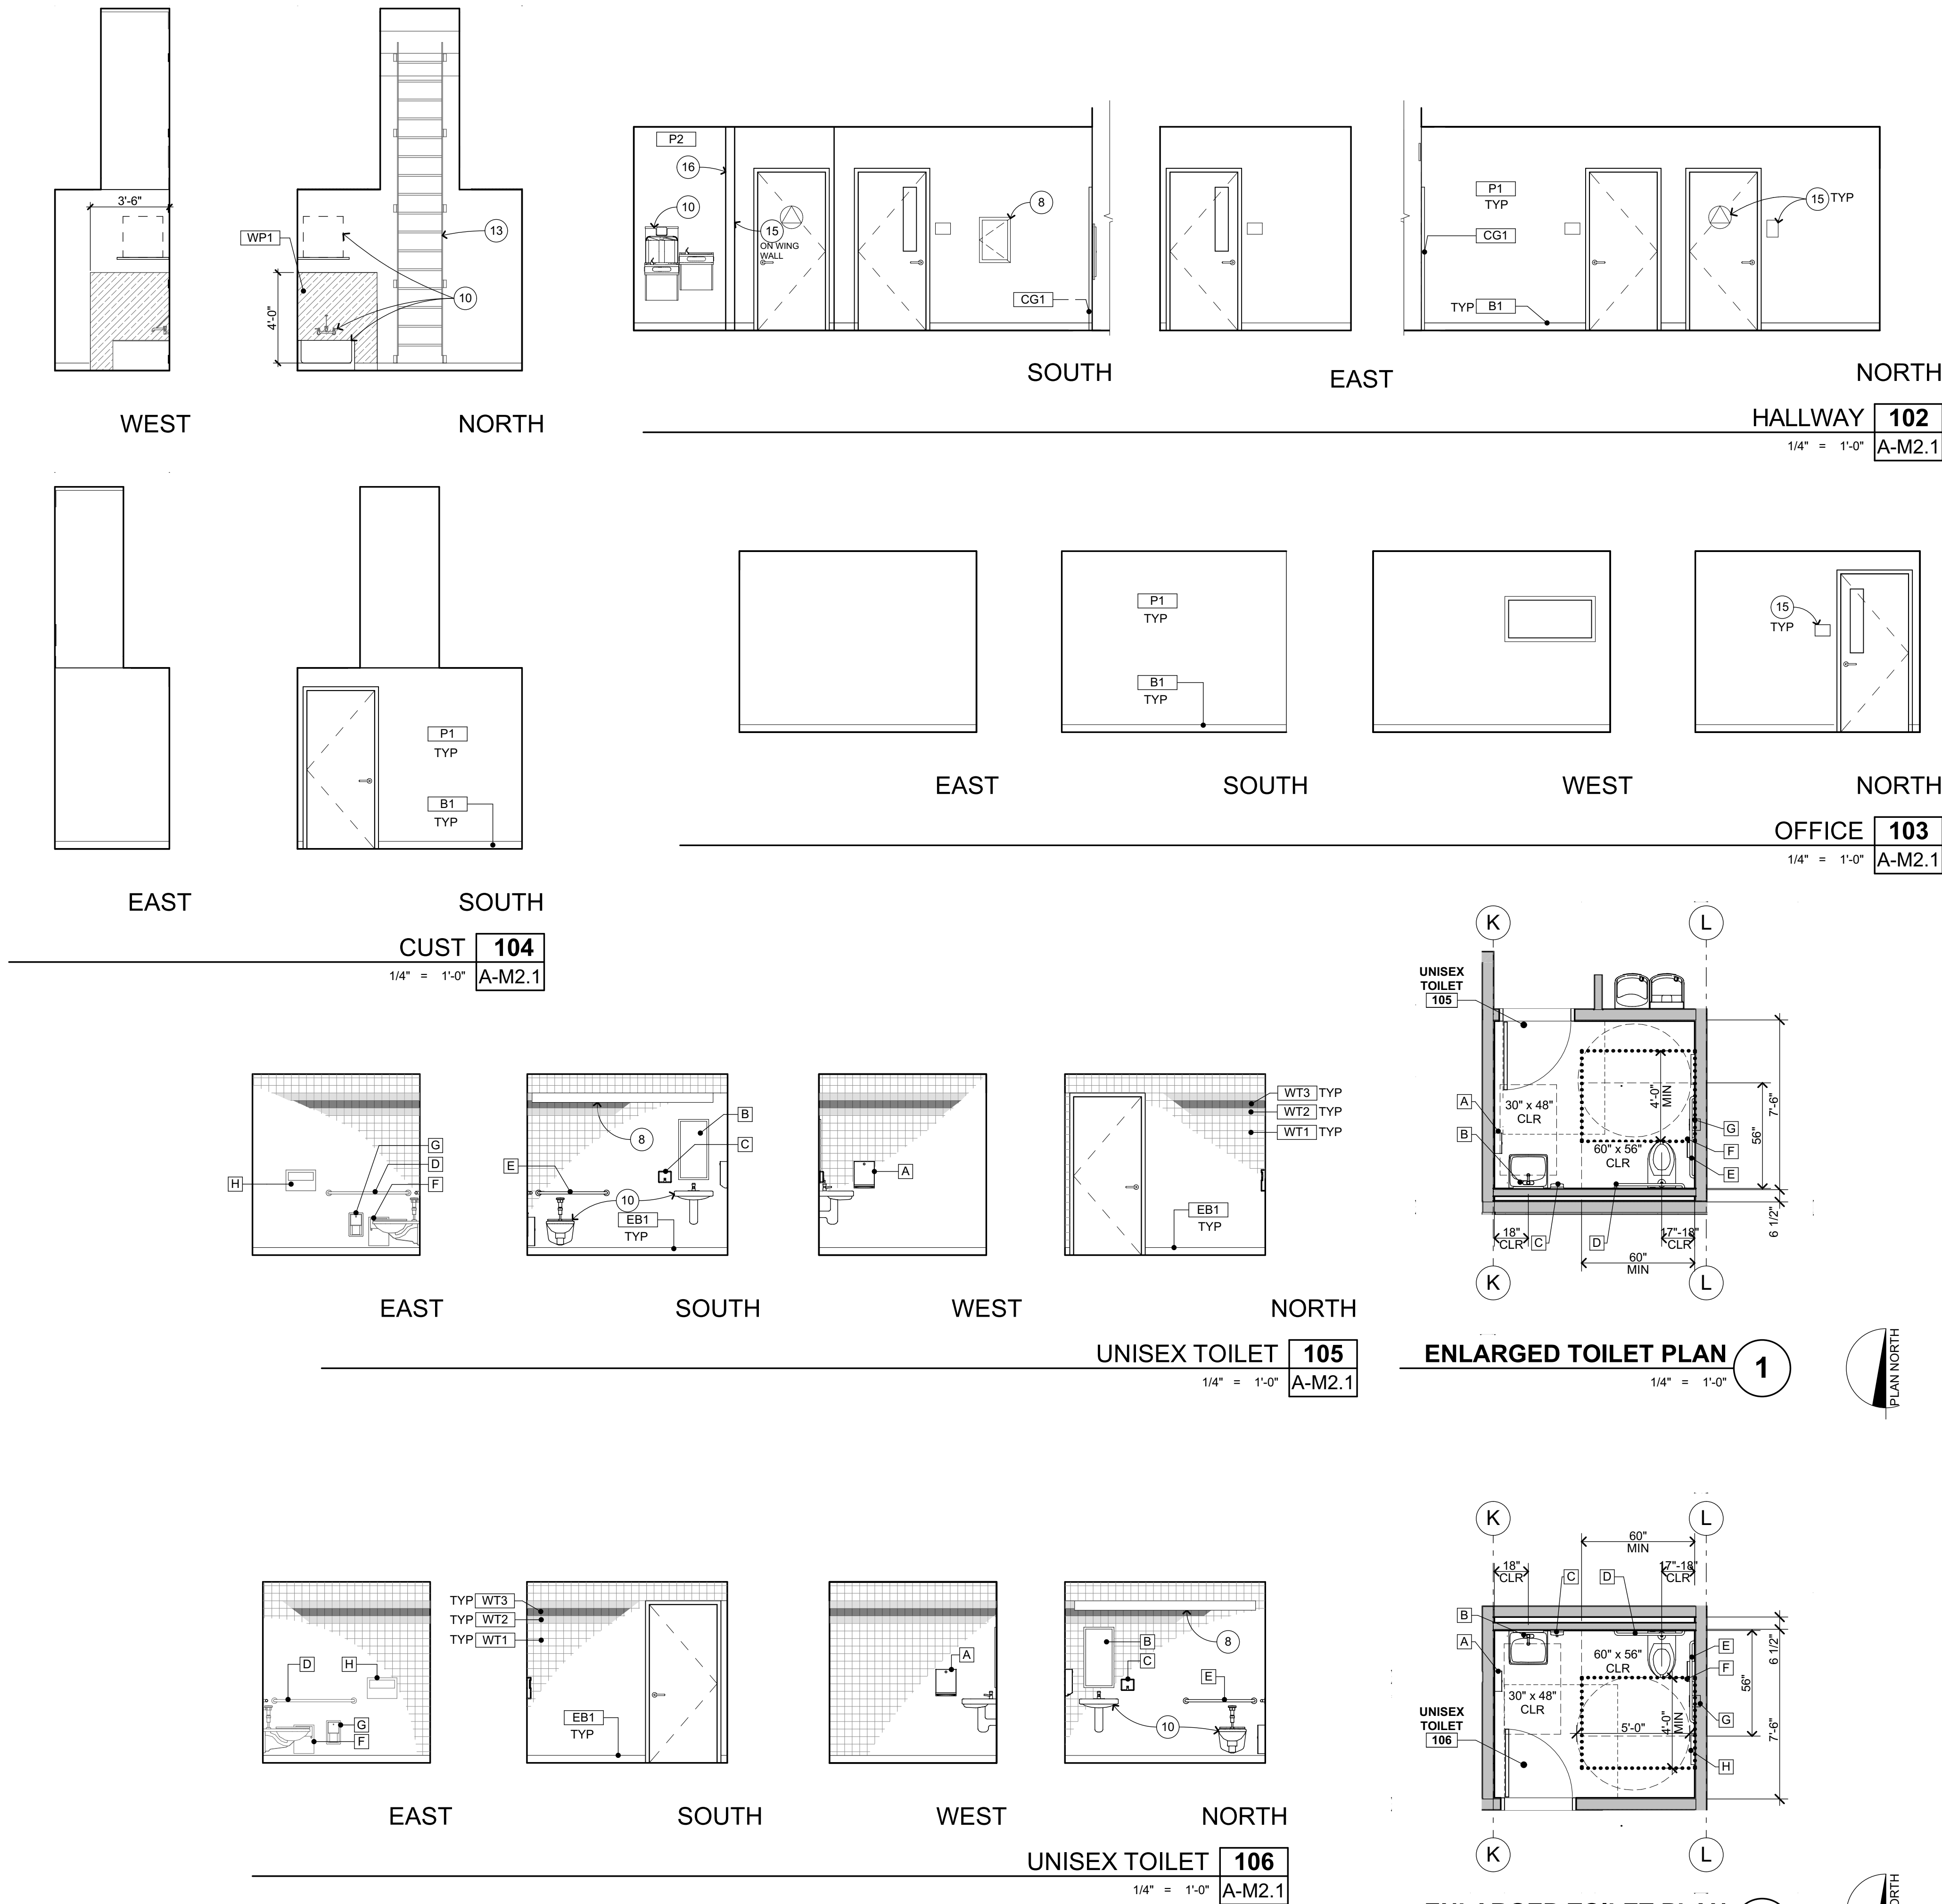
INTERIOR  
ELEVATIONS

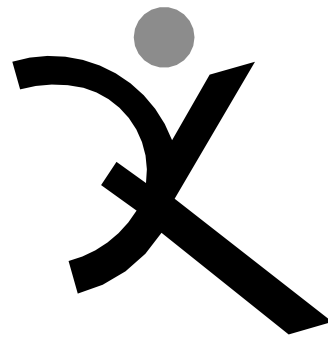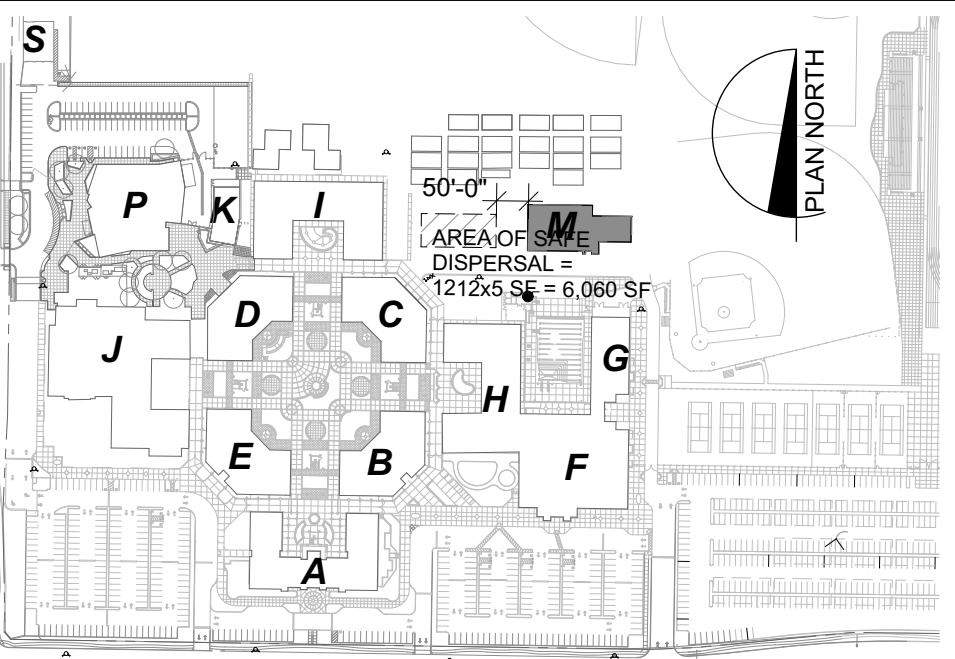SHEET NUMBER

A-M7.2



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## INTERIOR ELEVATION KEYNOTES

- NOT ALL KEYNOTES MAY APPLY TO THIS SHEET
- SCOREBOARD, PROVIDE BLKG PER 1 A-10.3
  - SHOT CLOCK 1 A-10.4
  - WALL PADS, SEE DETAIL 2 A-10.4
  - MOTORIZED DIVIDER CURTAIN, S.S.D. FOR SUPPORT
  - MOTORIZED TELESCOPIC BLEACHERS
  - MECHANICAL ITEM, S.M.D.
  - SEMI-RECESSED FIRE CABINET AND EXTINGUISHER, SEE 9 A-10.3
  - ELECTRICAL ITEM, S.E.D.
  - MARKER BOARD
  - PLUMBING ITEM, S.P.D.
  - SHORT THROW PROJECTOR, PROVIDE BLKG
  - AV RACK, SEE AV DRAWINGS
  - ROOF ACCESS LADDER
  - TRUSS/BEAM/JOIST (PAINTED), S.S.D.
  - SIGNAGE, SEE DETAIL 1 AG-2.1
  - WING WALL

## INTERIOR ELEVATION GENERAL NOTES

- NOTES AND SYMBOLS ARE TO APPLY AT ALL AREAS OF SIMILAR GRAPHIC REPRESENTATION. SUCH INDICATIONS MAY BE LIMITED TO PROMOTE CLARITY OR AVOID REDUNDANCY. NO LIMITATION OF APPLICATION SHALL BE CONSTRUED WITHOUT SPECIFIC NOTATION.
- REFER TO MECHANICAL DRAWINGS FOR REGISTERS AND VENTS NOT OTHERWISE SHOWN.
- REFER TO ELECTRICAL DRAWINGS FOR HORNS, SPEAKERS, PULL STATIONS AND OTHER FEATURES NOT OTHERWISE SHOWN.
- TYPICAL MOUNTING HEIGHTS OF ACCESSIBLE ELEMENTS AT ACCESSIBLE FIXTURES 4 A-10.3
- FLOORING & BASE SHALL EXTEND UNDER ACCESSIBLE SINK/LAVATORY BASE CABINETS TO THE WALL. HOT WATER AND DRAINPIPS ACCESSIBLE UNDER LAVATORIES SHALL BE INSULATED OR OTHERWISE COVERED. THERE SHALL BE NO SHARP OR ABRASIVE SURFACES UNDER LAVATORIES.
- PROVIDE SOLID BLOCKING FOR CABINET, ACCESSORY, OR EQUIPMENT MOUNTING 1 A-10.3

## WALL AND BASE FINISH CODES


- FOR PAINT FINISHES SEE SEC. 099123 INTERIOR PAINTING, ALL GYP BD TO BE TYPE 'X'
- |      |                                       |      |                                                        |
|------|---------------------------------------|------|--------------------------------------------------------|
| P1   | PAINT 1                               | WP1  | FRP PANEL O/ MOISTURE RESISTANT GYP BD                 |
| P2   | PAINT 2                               | PLY1 | 3/4" MDO FIRE RATE PLYWOOD                             |
| AP1  | ACOUSTICAL WALL PANELS                | HPLP | HIGH PRESSURE LAMINATED PANEL                          |
| GBMR | GYP BD - MOISTURE RESISTANT           | CG1  | CORNER GUARDS                                          |
| GBIR | GYP BD - IMPACT RESISTANT             | B1   | 4" RESILIENT BASE (COVERED AT RESILIENT TILE FLOORING) |
| WT1  | WALL TILE - DALTILE 0100 WHITE        | B2   | 4" RESILIENT BASE - VENTED                             |
| WT2  | WALL TILE - DALTILE X114 DESSERT GRAY | EB1  | EPOXY COVE BASE                                        |
| WT3  | WALL TILE - DALTILE RED OR BLUE (TBD) |      |                                                        |

## TOILET ROOM ACCESSORY SCHEDULE

- |   |                                              |   |        |
|---|----------------------------------------------|---|--------|
| A | PAPER TOWEL DISPENSER, SURFACE MOUNTED       | 2 | A-10.3 |
| B | MIRROR W/ SHELF (TYP), FOR ATTACHMENT SEE    |   |        |
| C | SOAP DISPENSER, SURFACE MOUNTED              |   |        |
| D | 36" GRAB BAR, FOR ATTACHMENT SEE             | 5 | A-10.3 |
| E | 42" GRAB BAR, FOR ATTACHMENT SEE             | 6 | A-10.3 |
| F | SANITARY NAPKIN RECEPTACLE, SURFACE MOUNTED  |   |        |
| G | TOILET PAPER DISPENSER, SURFACE MOUNTED      |   |        |
| H | TOILET SEAT COVER DISPENSER, SURFACE MOUNTED |   |        |
| I | WASTE RECEPTACLE, N.I.C.                     |   |        |

NOTE:  
FOR TYPICAL ACCESSIBLE ACCESSORY MOUNTING HEIGHTS AND LOCATIONS, SEE 4 A-10.3

## KEYPLAN

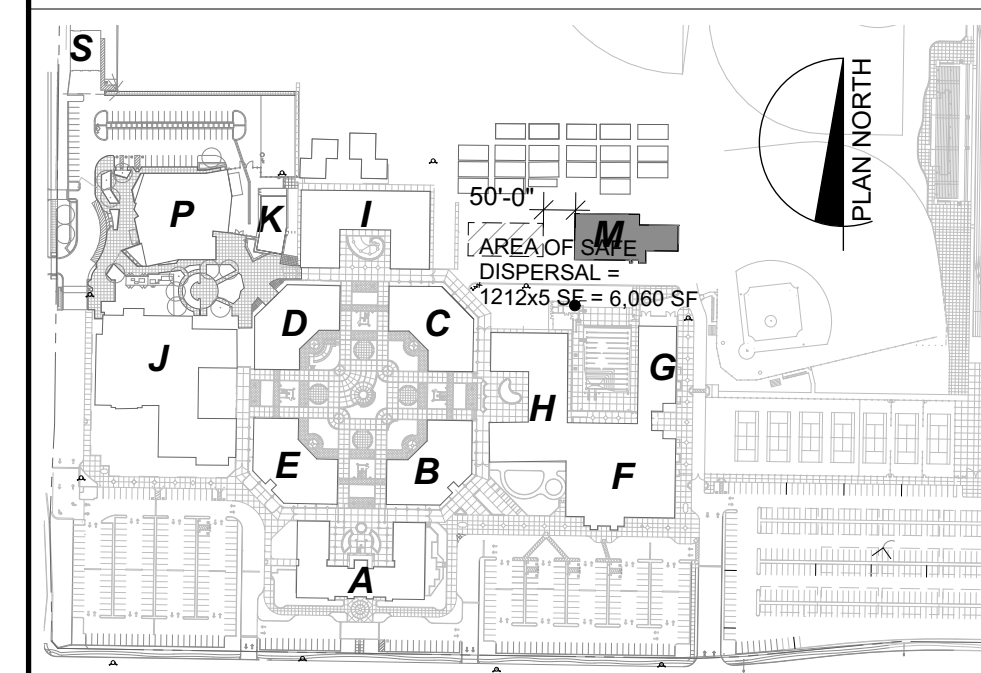

**QUATTROCCHI KWOK ARCHITECTS**  
Main:  
636 Fifth Street, Santa Rosa, CA 95404  
East Bay:  
55 Harrison Street, Suite 525, Oakland, CA 94607  
(707) 576-0829

**LICENSED ARCHITECT**  
JIM THEISS  
LICENSE # C22643  
EXP JUNE 30, 2021  
STATE OF CALIFORNIA  
SIGNED: MAY 5, 2021

**FREEDOM HIGH SCHOOL**

**NEW AUXILIARY GYMNASIUM**

1050 NEROLY RD,  
OAKLEY, CA 94561

**LIBERTY UNION HIGH SCHOOL DISTRICT**

DSA APP NO. 01-119278

ARCH PROJECT NO. 1869.00

DRAWN BY: GRD

DRAWING SCALE: 1/4" = 1'-0"

PTN: 61721-78 FILE NO: 7-H4

**BID DOCUMENT**

APRIL 27, 2021

SHEET TITLE


**INTERIOR ELEVATIONS**

SHEET NUMBER


**A-M7.3**




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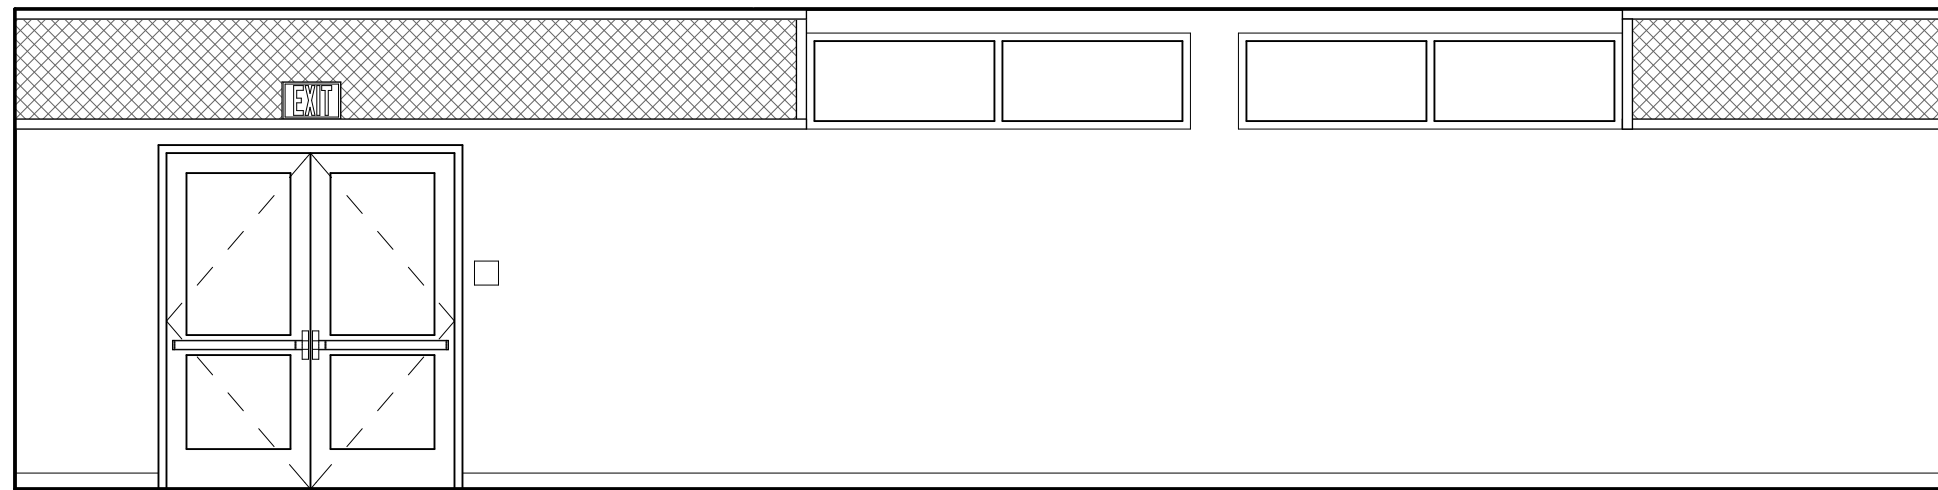
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NORTH

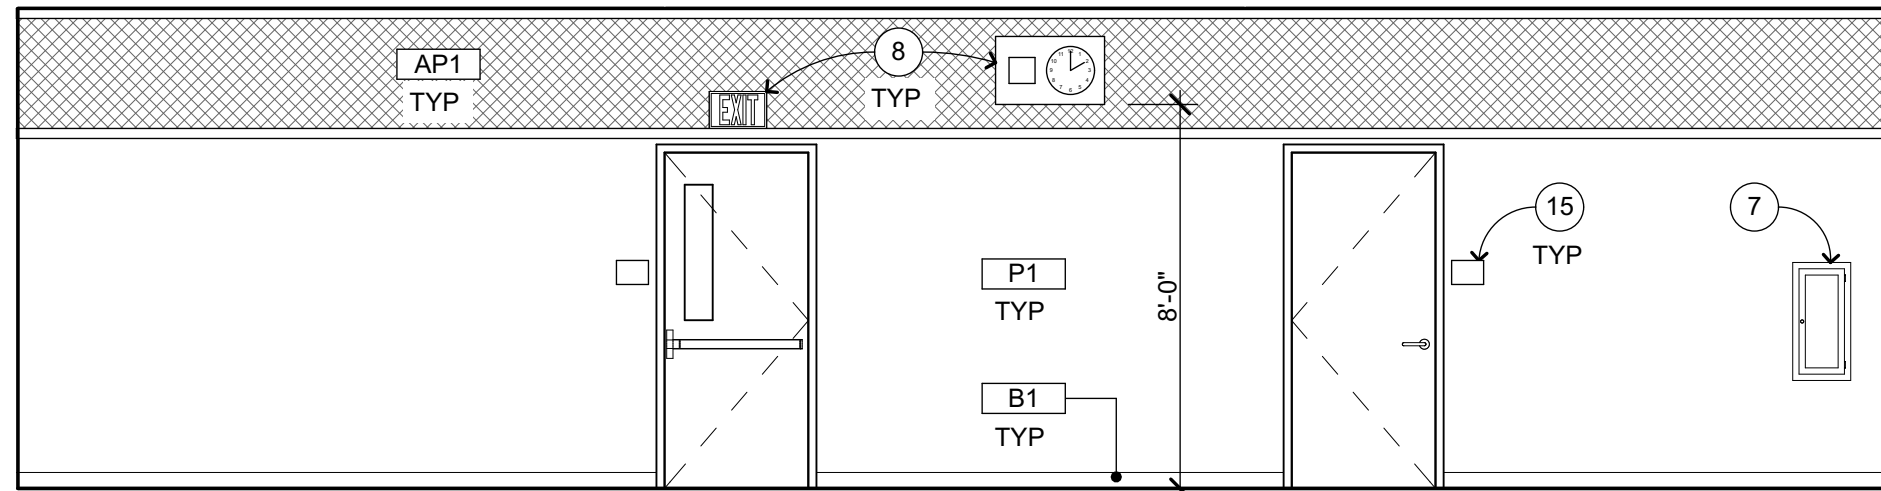


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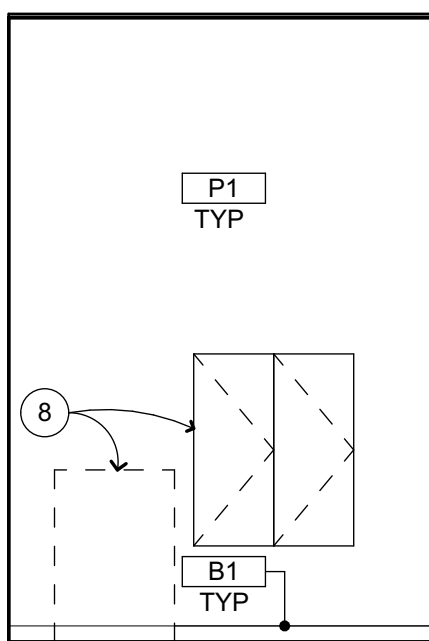

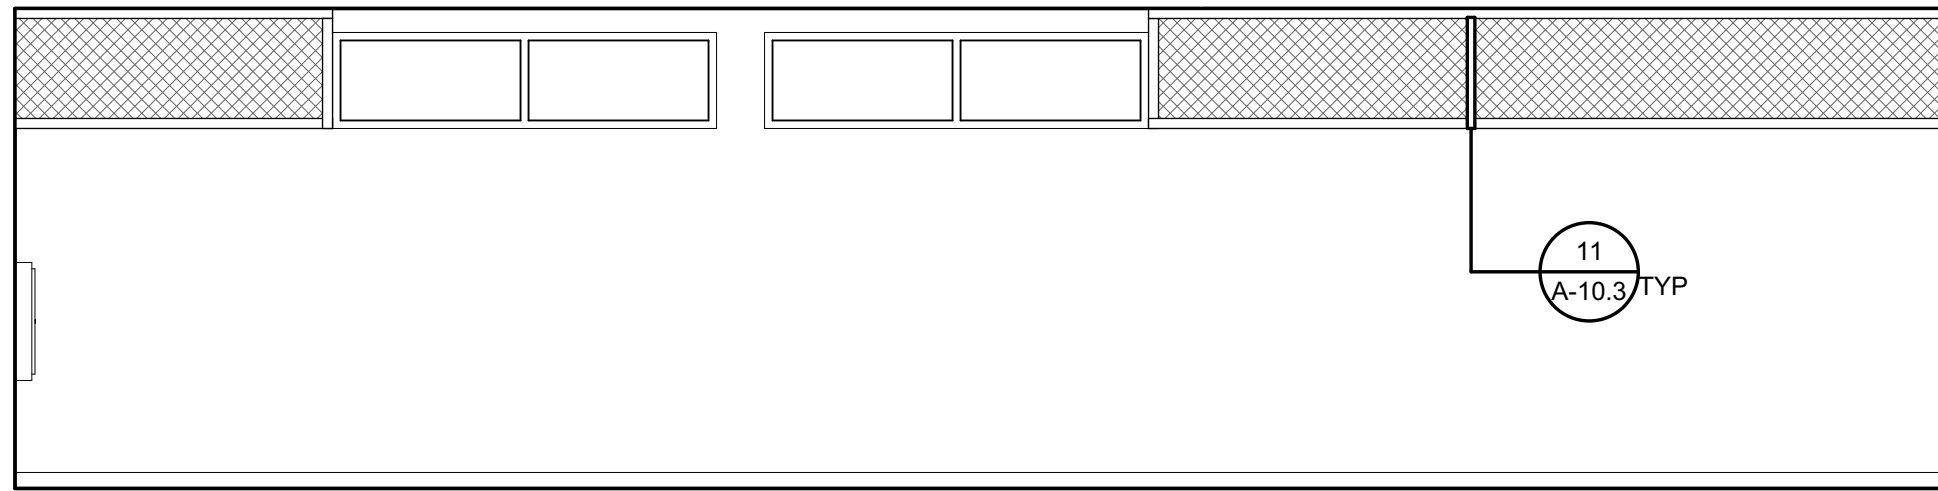
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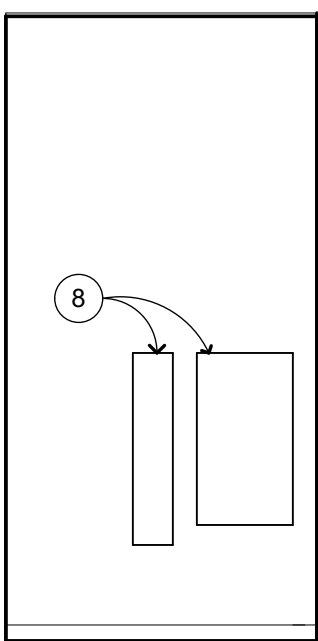
CLASSROOM **107**  
1/4" = 1'-0" A-M2.1

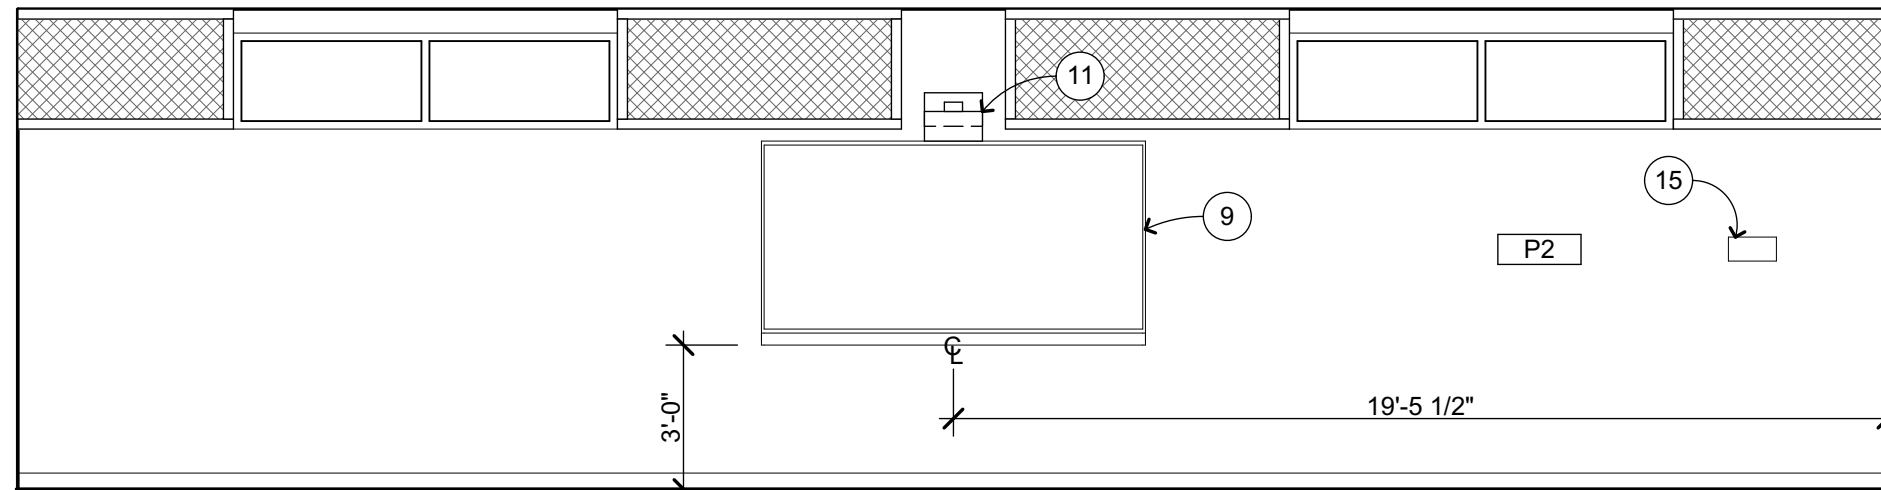


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SOUTH

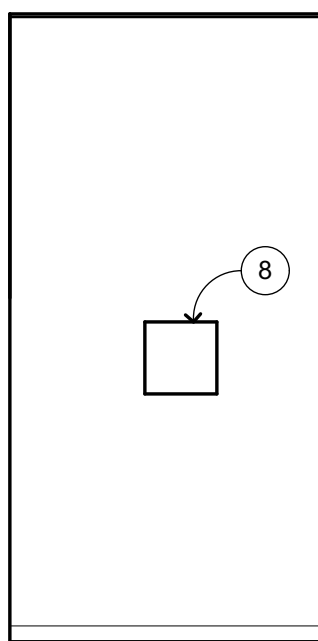


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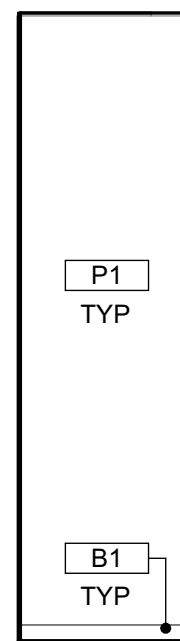


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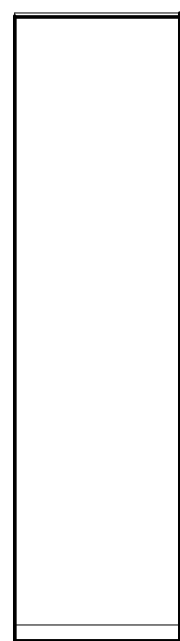
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1/4" = 1'-0" A-M2.1

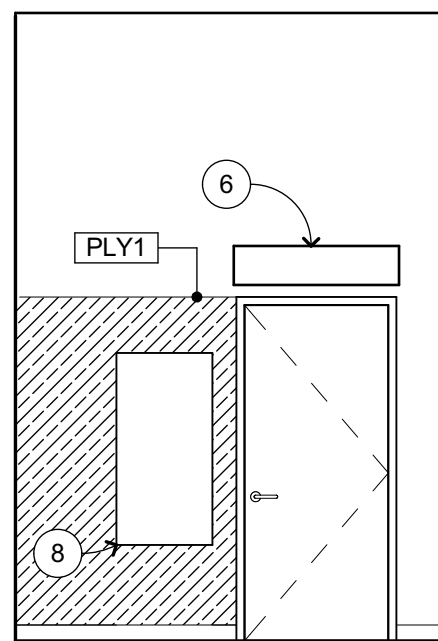


EAST

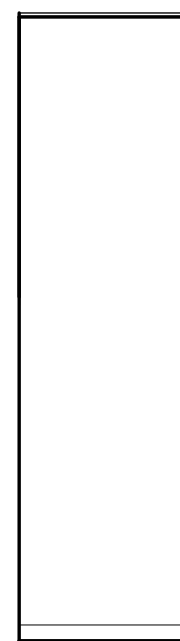

SOUTH




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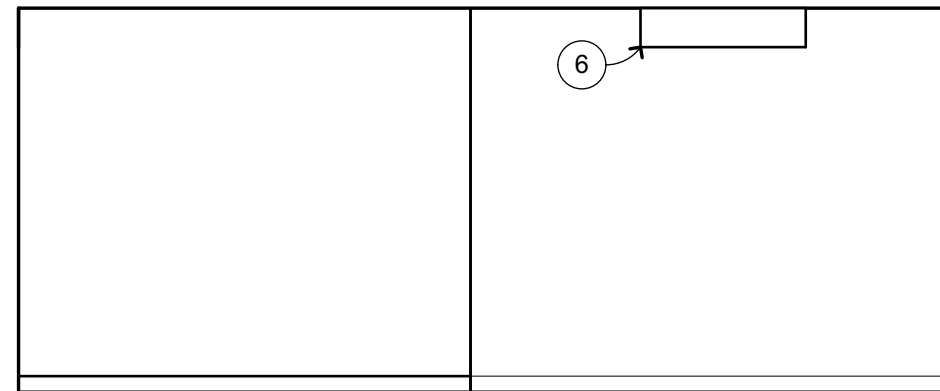

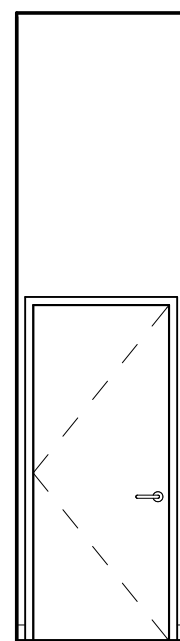
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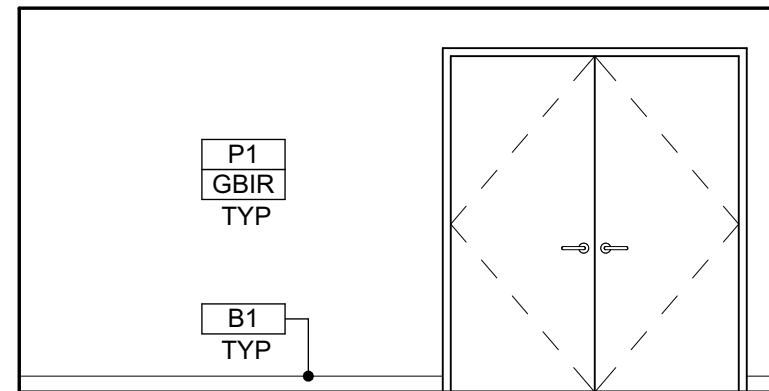
FIRE RISER **108**  
1/4" = 1'-0" A-M2.1




EAST

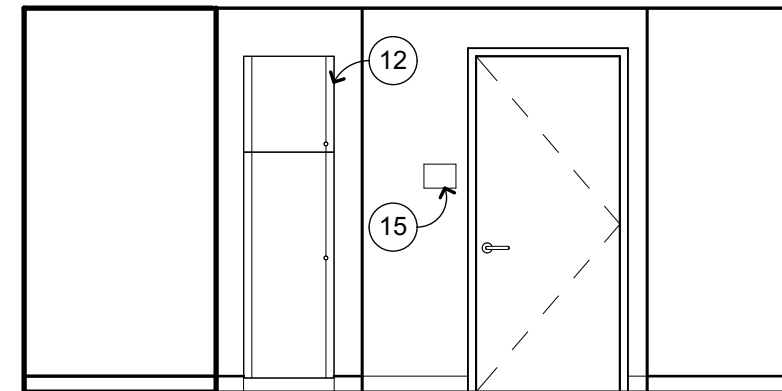

SOUTH



WEST

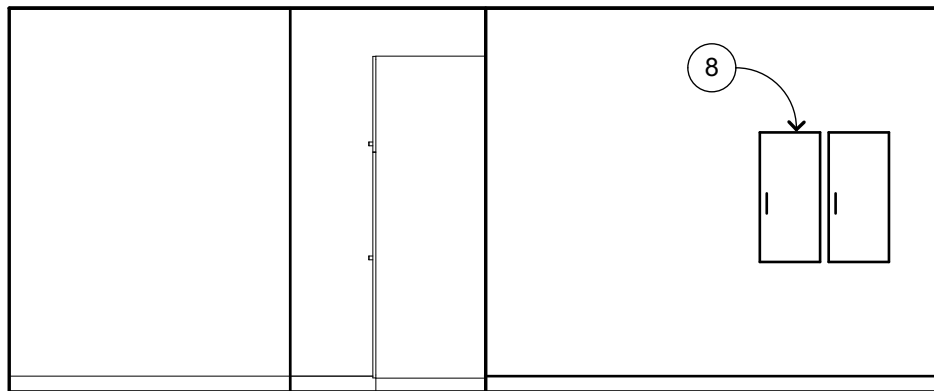


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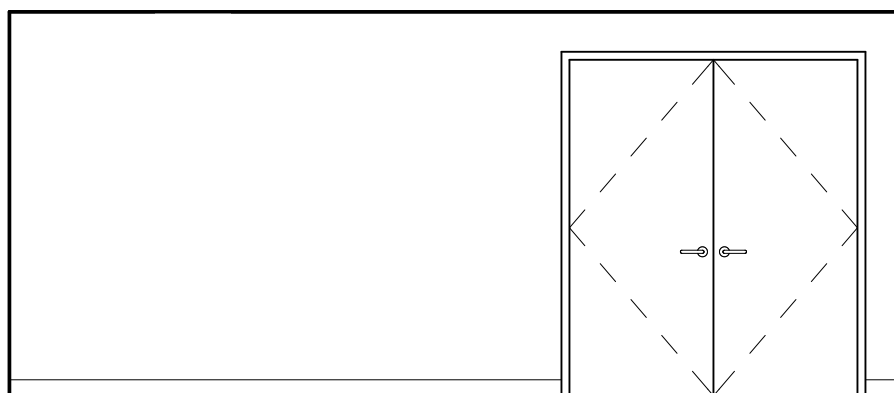
STORAGE **110**  
1/4" = 1'-0" A-M2.1



EAST

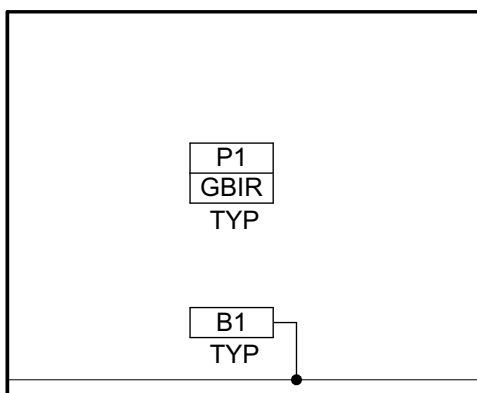

SOUTH



WEST



NORTH

STORAGE **111**  
1/4" = 1'-0" A-M2.1

## INTERIOR ELEVATION KEYNOTES

NOT ALL KEYNOTES MAY APPLY TO THIS SHEET

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- MOTORIZED TELESCOPIC BLEACHERS
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- SHORT THROW PROJECTOR, PROVIDE BLKG
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- ROOF ACCESS LADDER
- TRUSS/BEAM/JOIST (PAINTED), S.S.D.
- SIGNAGE, SEE DETAIL **1** AG-2.1
- WING WALL

## INTERIOR ELEVATION GENERAL NOTES


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## WALL AND BASE FINISH CODES

FOR PAINT FINISHES SEE SEC. 099123 INTERIOR PAINTING, ALL GYP BD TO BE TYPE 'X'

P1	PAINT 1	WP1	FRP PANEL O/ MOISTURE RESISTANT GYP BD
P2	PAINT 2		3/4" MDO FIRE RATE PLYWOOD
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GBMR	GYP BD - MOISTURE RESISTANT	CG1	CORNER GUARDS
GBIR	GYP BD - IMPACT RESISTANT		
WT1	WALL TILE - DAL TILE 0100 WHITE	B1	4" RESILIENT BASE (COVERED AT RESILIENT TILE FLOORING)
WT2	WALL TILE - DAL TILE X114 DESSERT GRAY	B2	4" RESILIENT BASE - VENTED
WT3	WALL TILE - DAL TILE RED OR BLUE (TBD)	EB1	EPOXY COVE BASE
		<b>13</b> <b>13</b> A-10.3	

## KEYPLAN

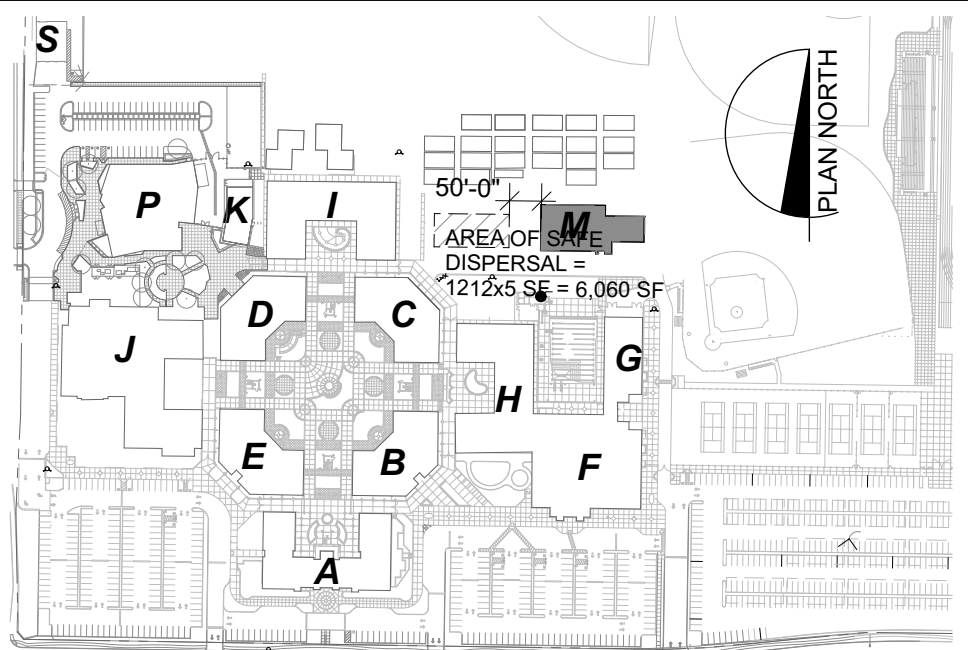

FREEDOM  
HIGH SCHOOL

NEW AUXILIARY  
GYMNASIUM

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OAKLEY, CA 94561

LIBERTY UNION  
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DSA APP NO. 01-119278

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DRAWN BY: GRD

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BID DOCUMENT

APRIL 27, 2021

SHEET TITLE

INTERIOR  
ELEVATIONS

SHEET NUMBER

**A-M7.4**






















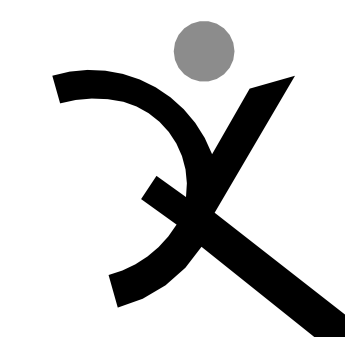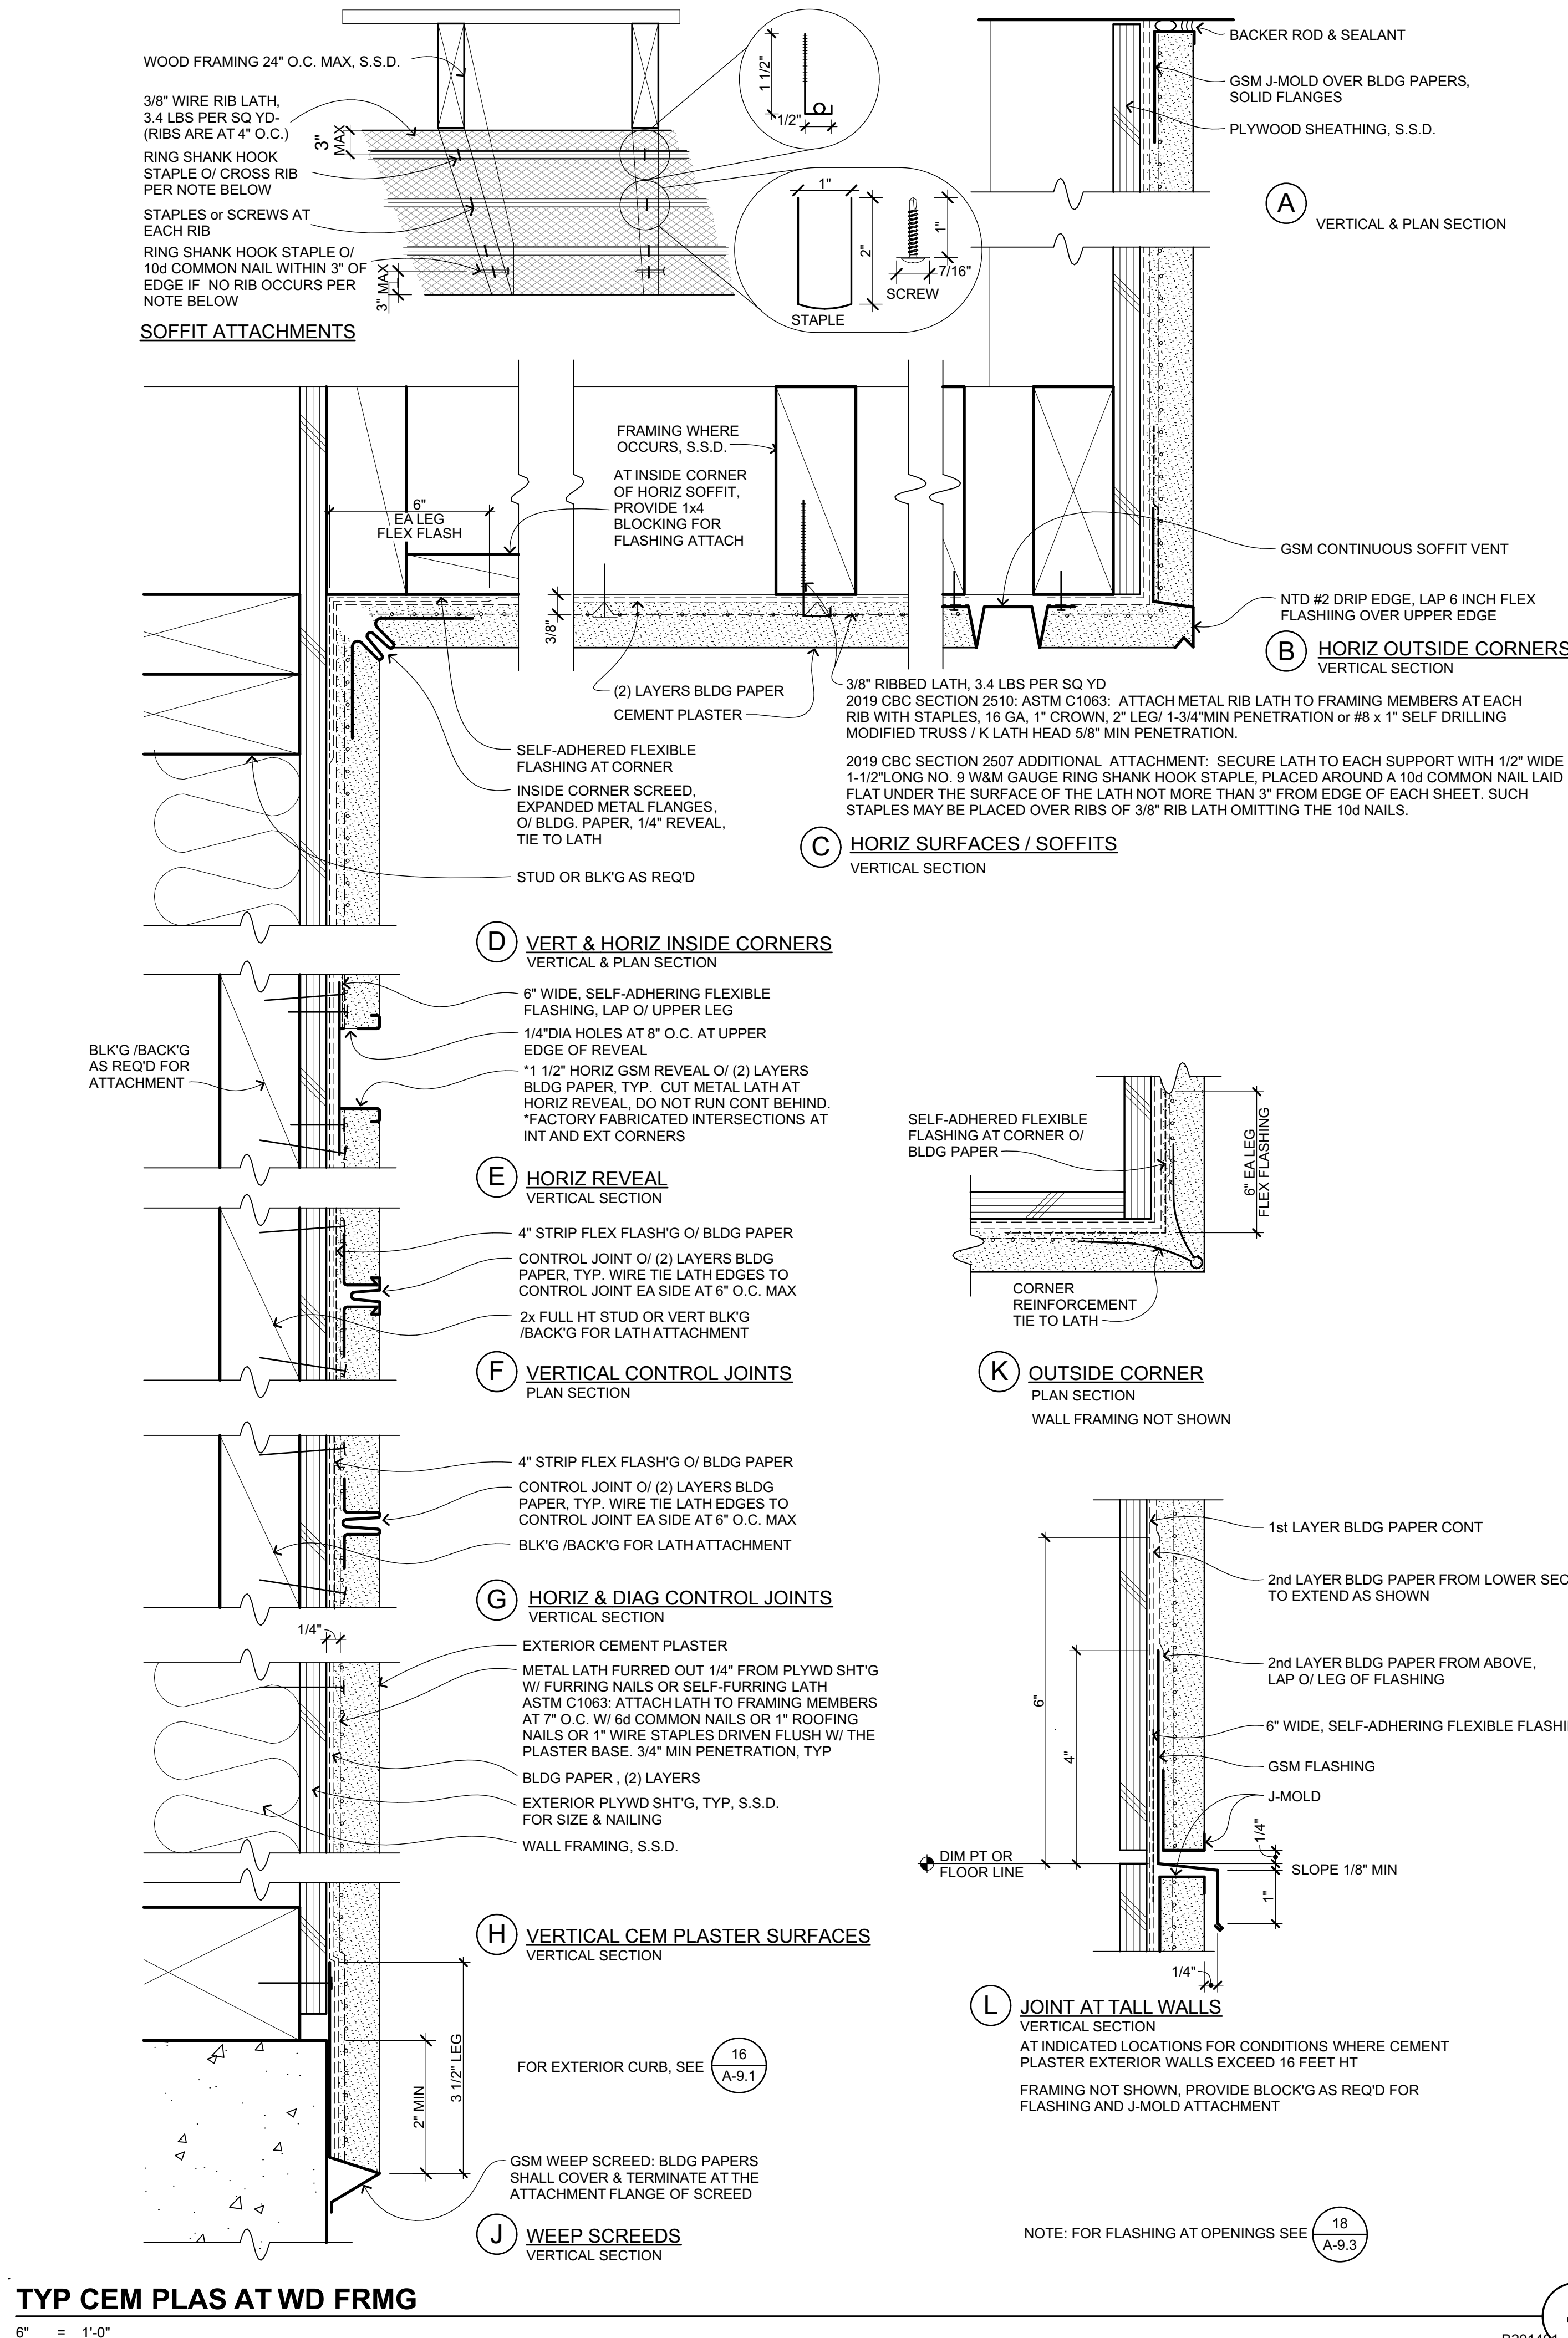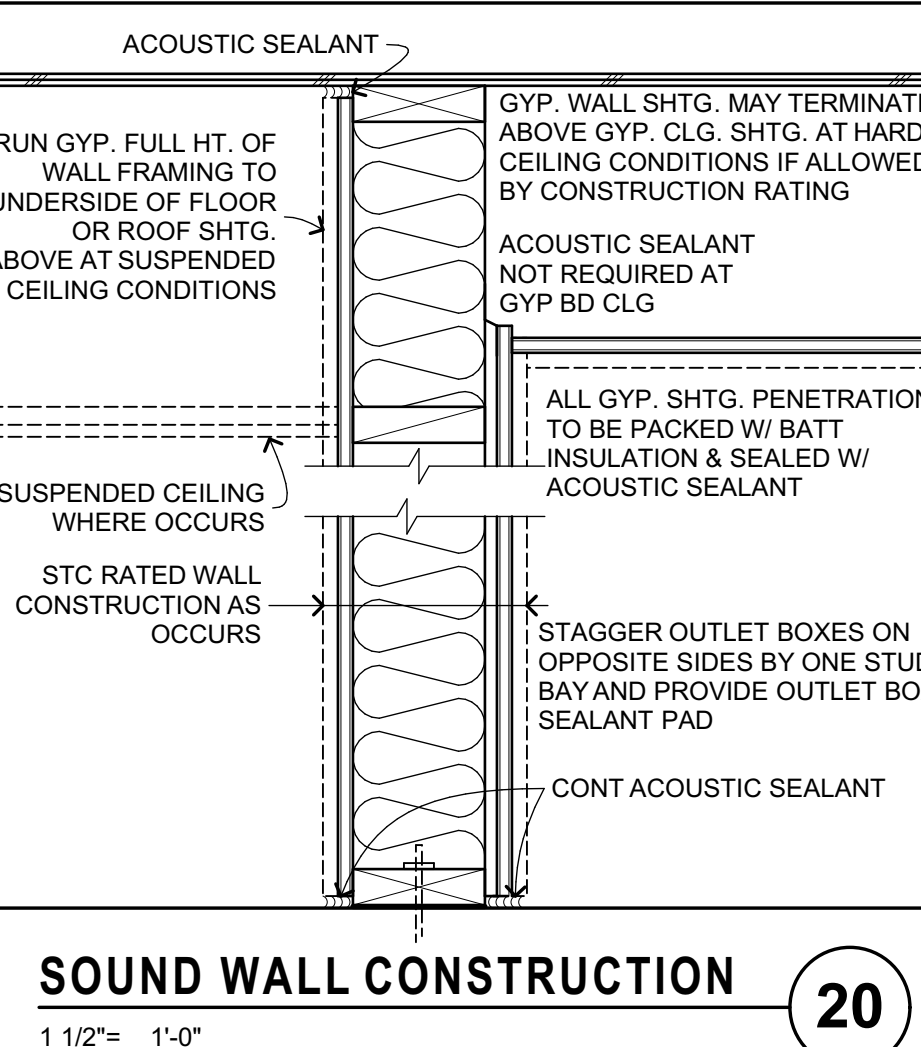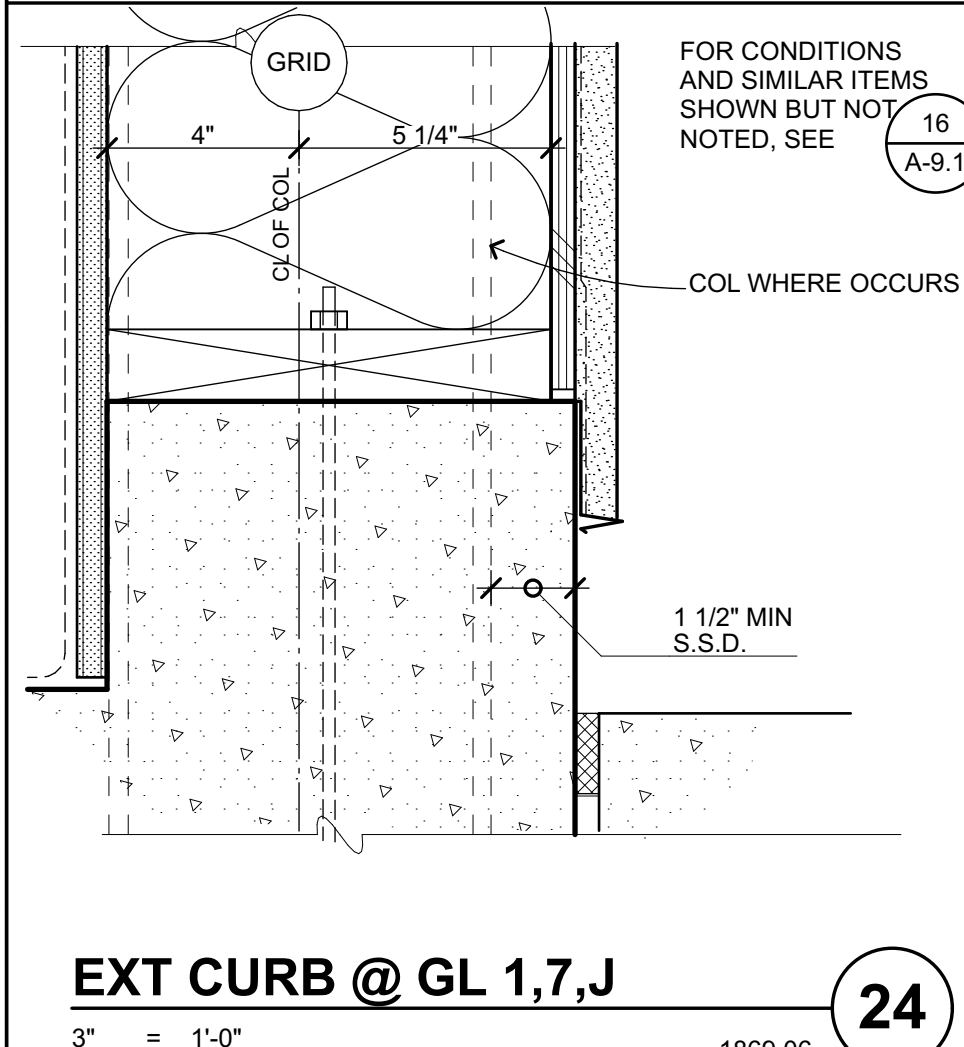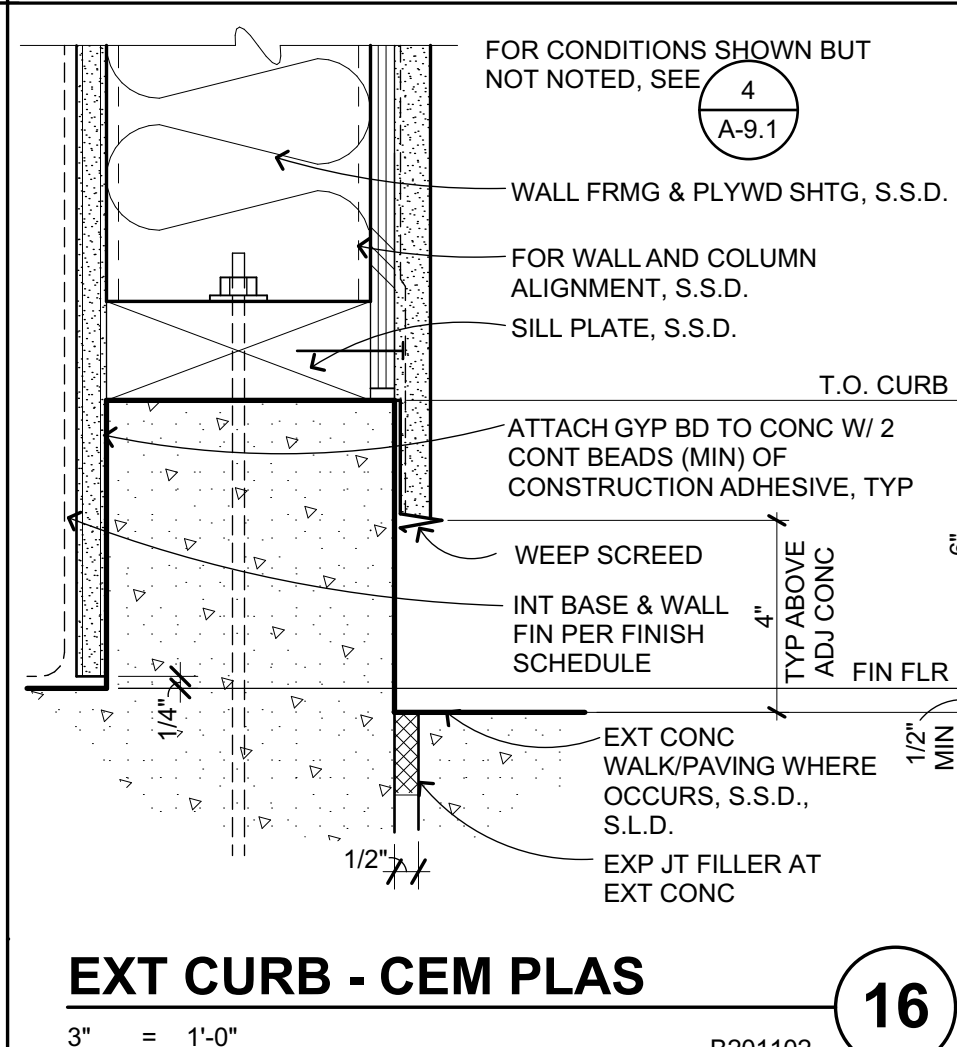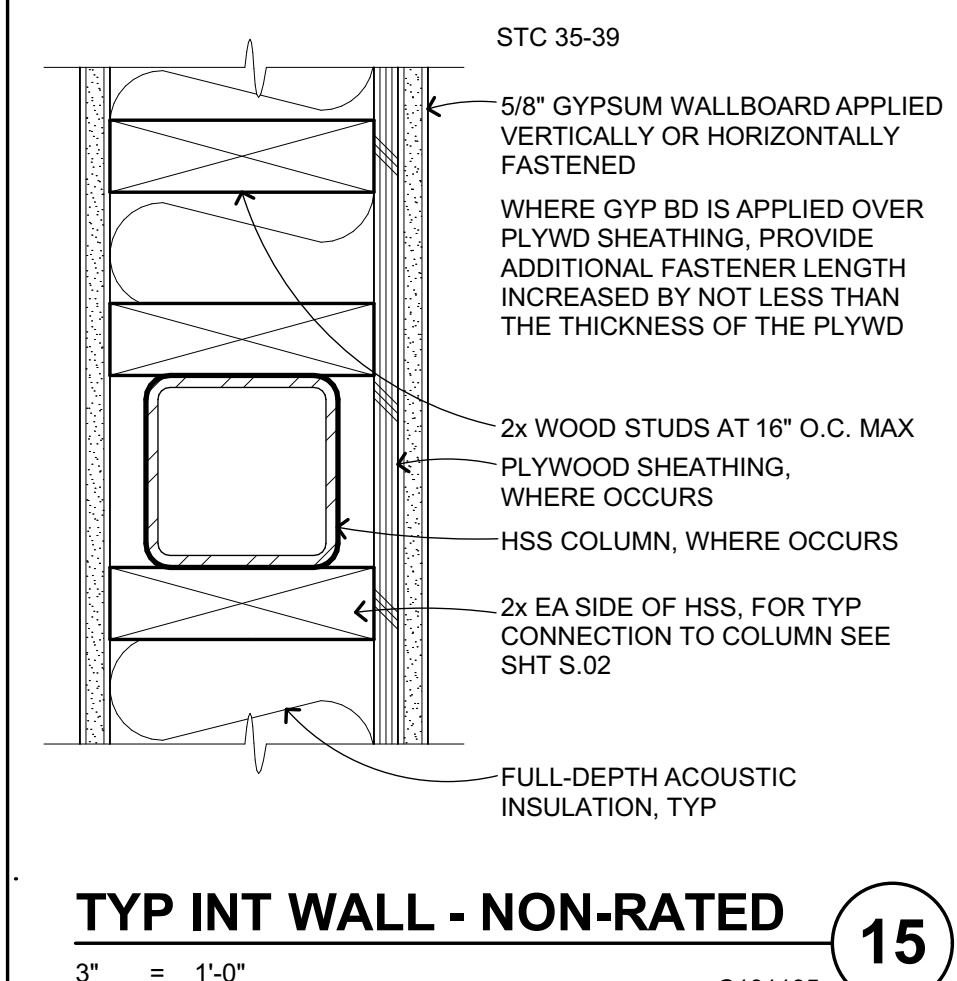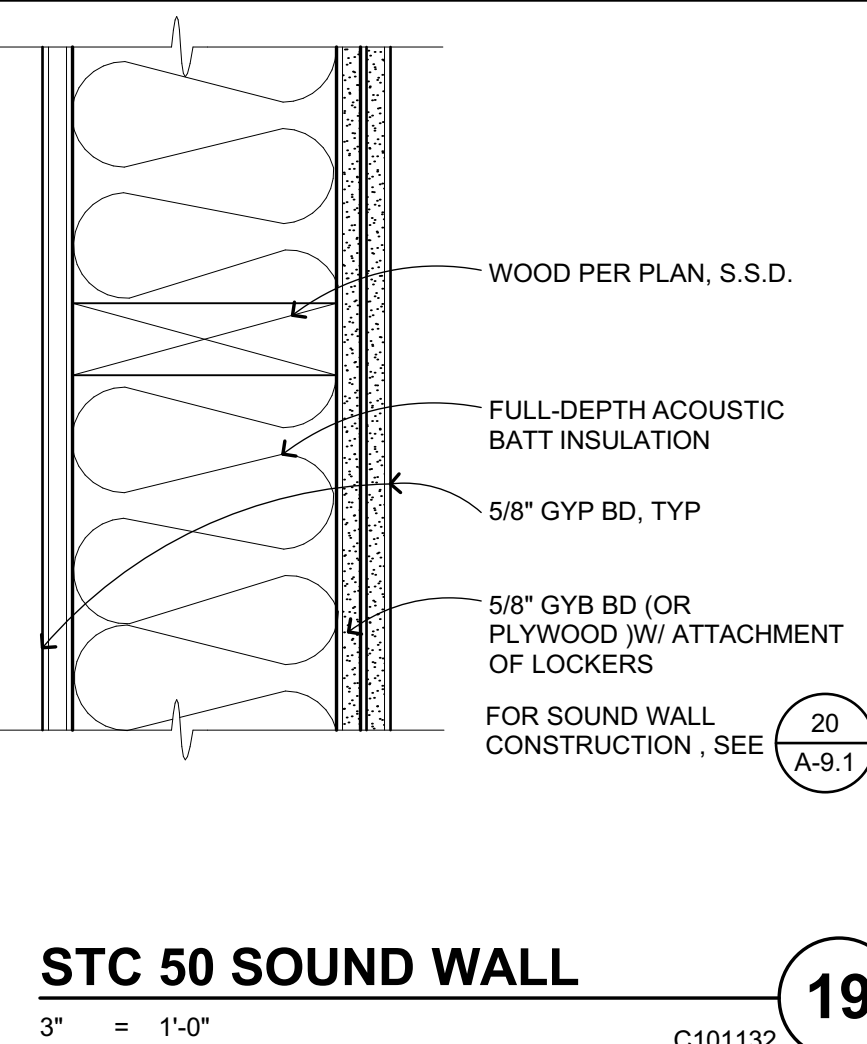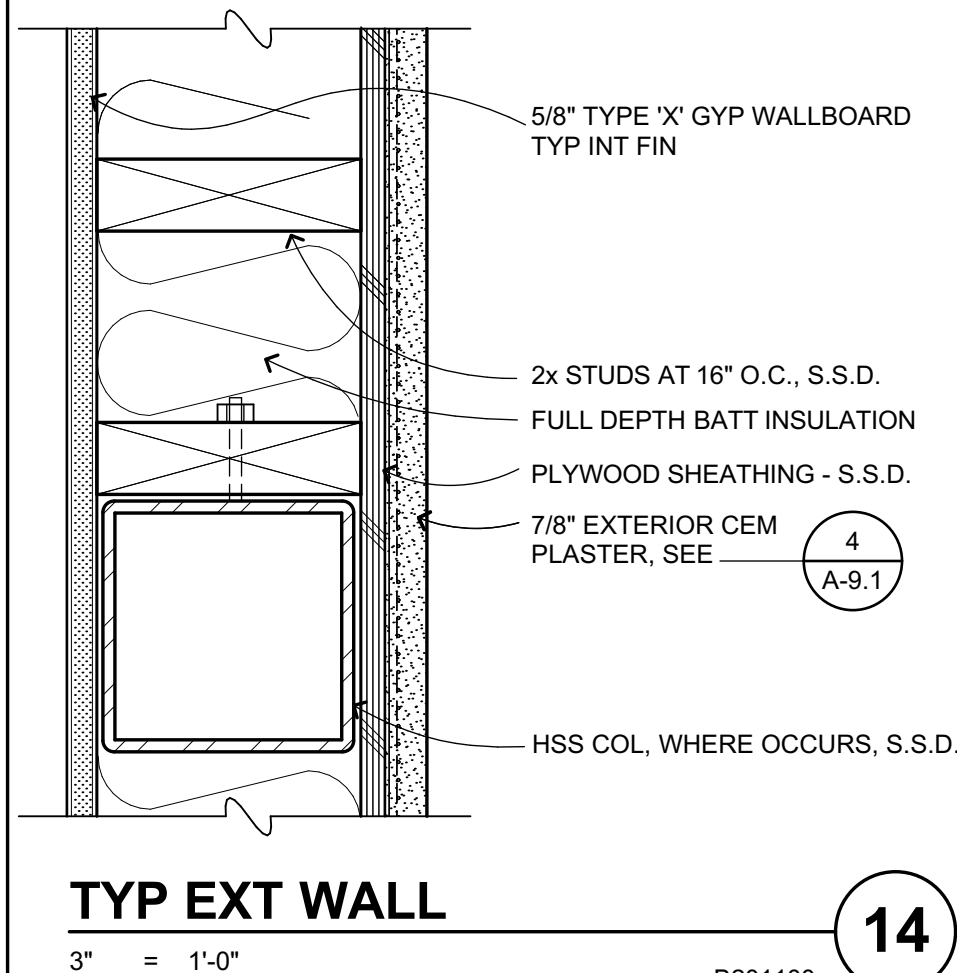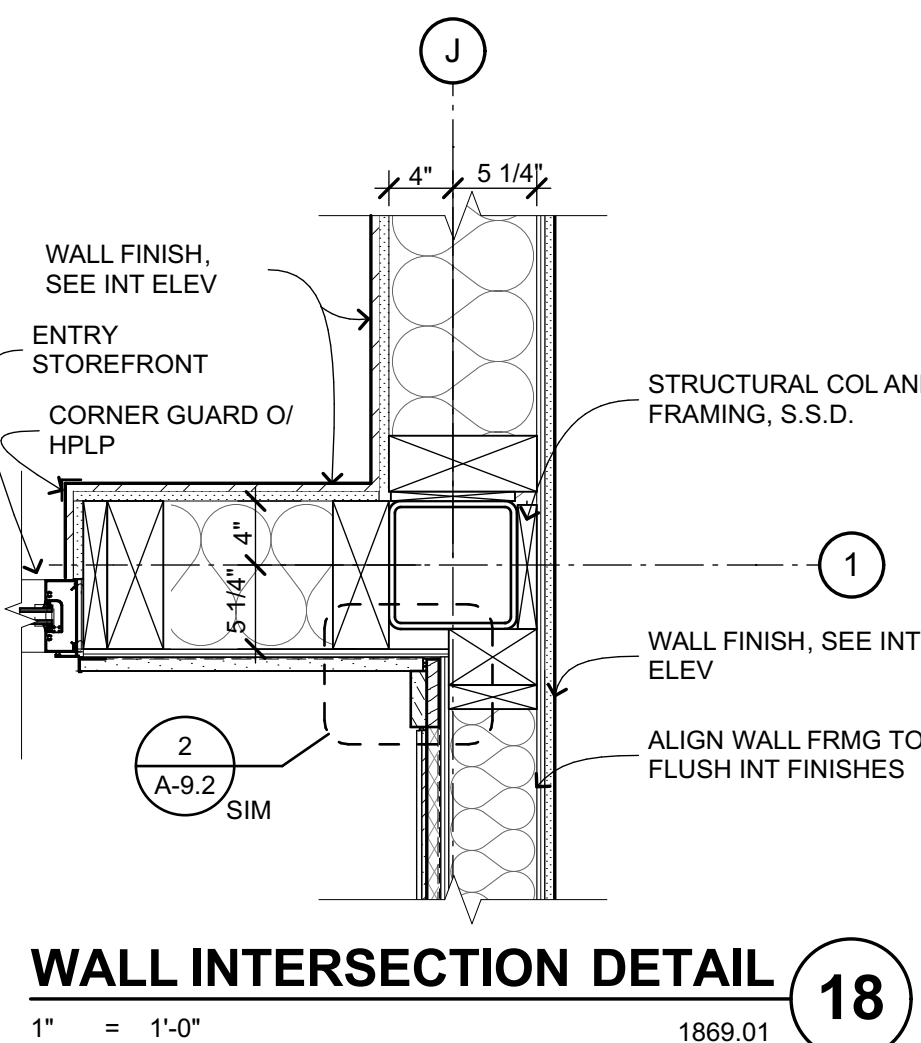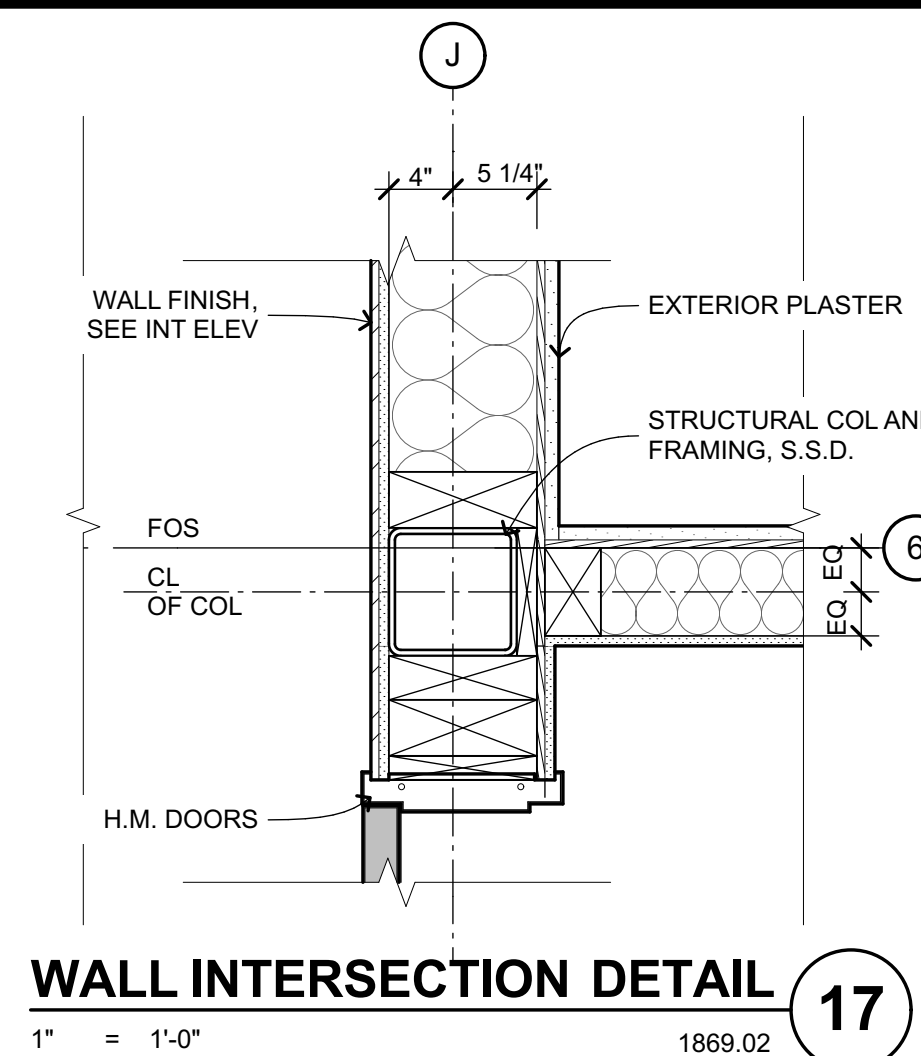

**Main:**  
636 Fifth Street, Santa Rosa, CA 95404

**East Bay:**  
55 Harrison Street, Suite 525,  
Oakland, CA 94607  
(707) 576-0829

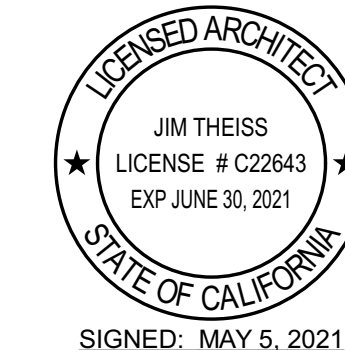

**FREEDOM  
HIGH SCHOOL**

## NEW AUXILIARY GYMNASIUM

1050 NEROLY RD,  
OAKLEY, CA 94561

LIBERTY UNION  
HIGH SCHOOL  
DISTRICT


DSA APP NO. 01-119278

ARCH PROJECT NO: 1869.00

DRAWN BY: _____ PAGE _____

DRAWING SCALE: AS NOTED

PTN: 61721-78 FILE NO: 7-H4

## BID DOCUMENT

APRIL 27, 2021








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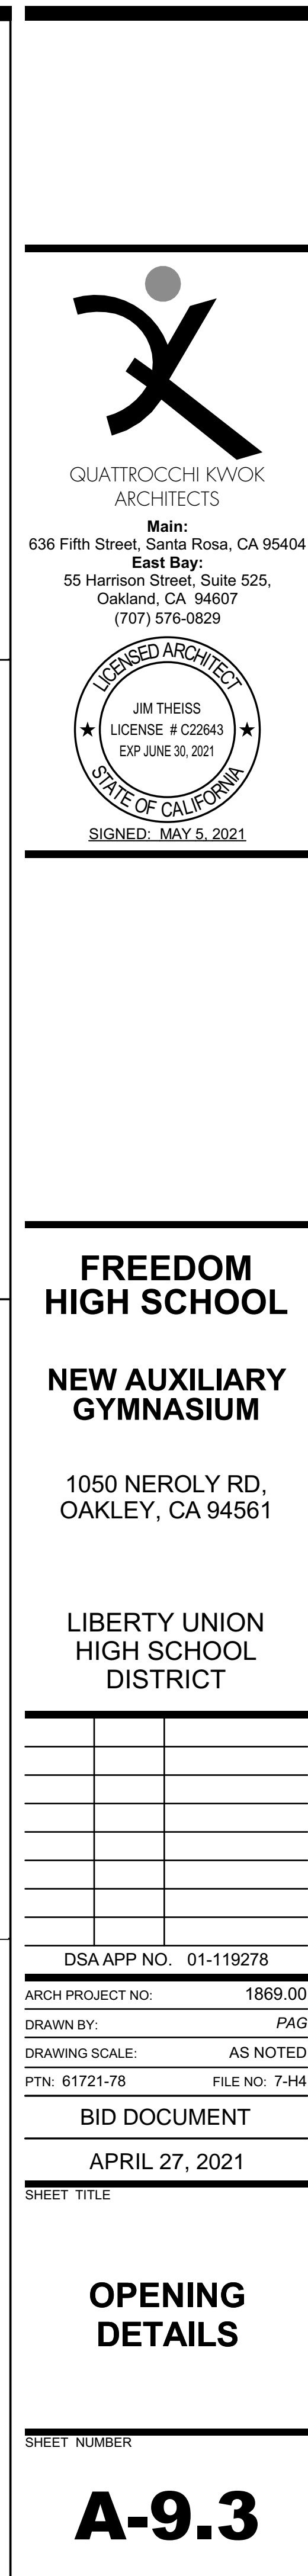
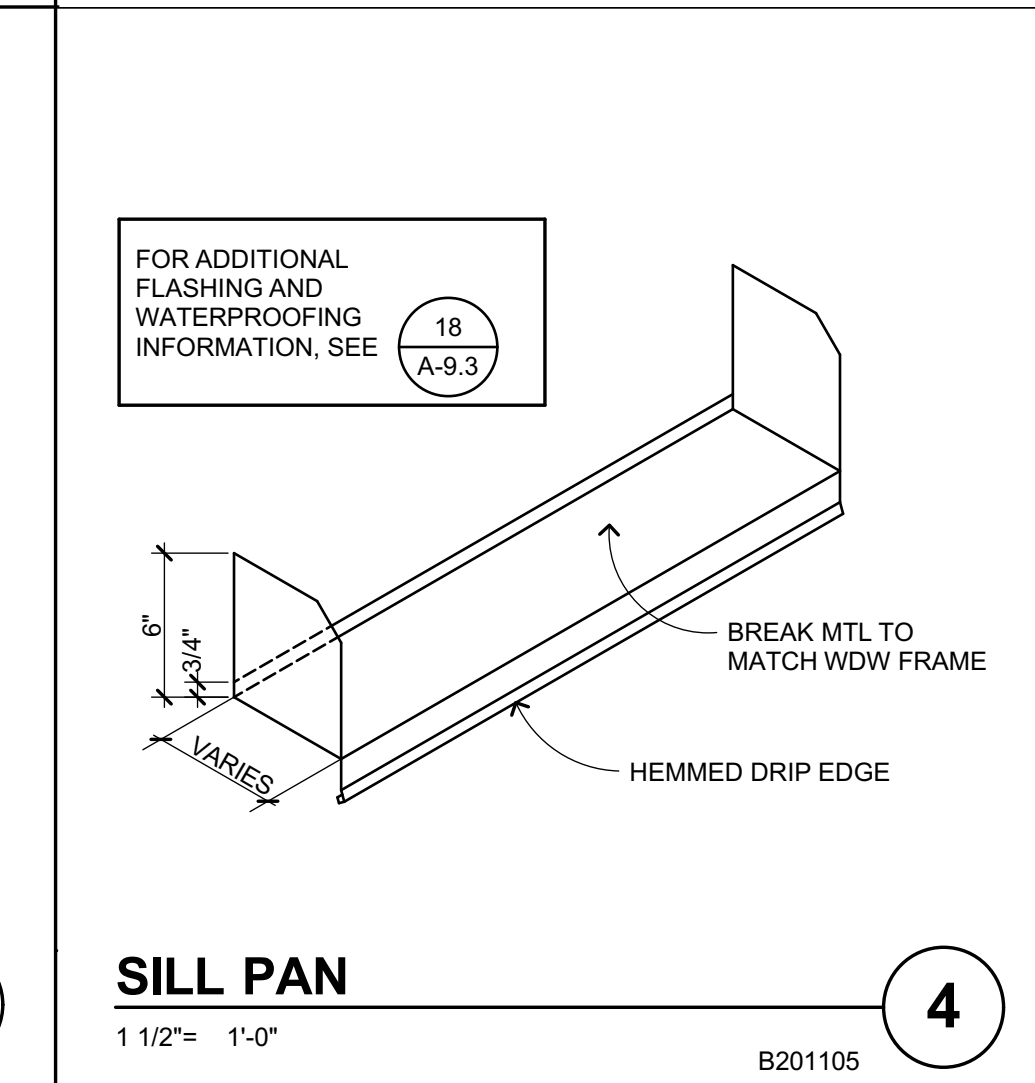
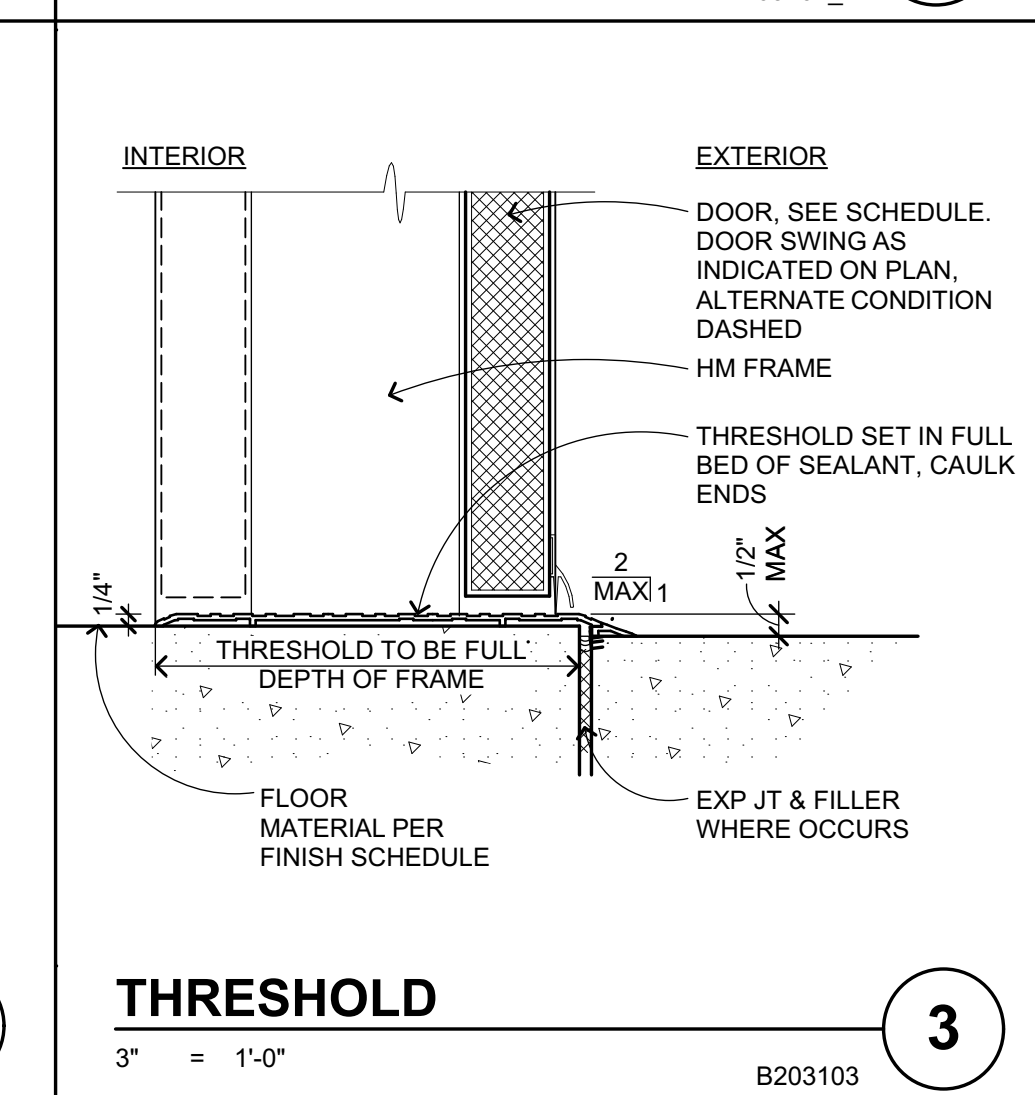
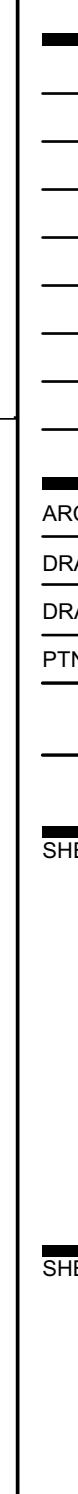
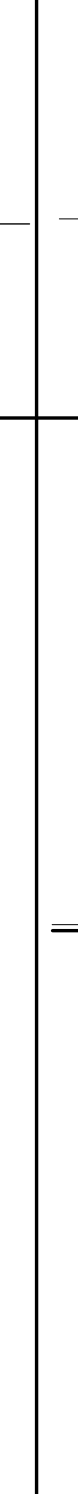
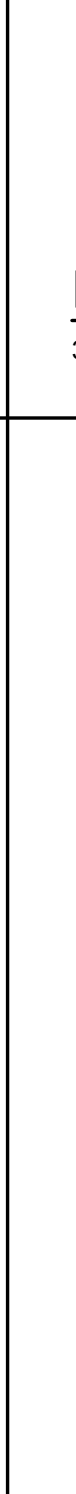
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## A-9.1









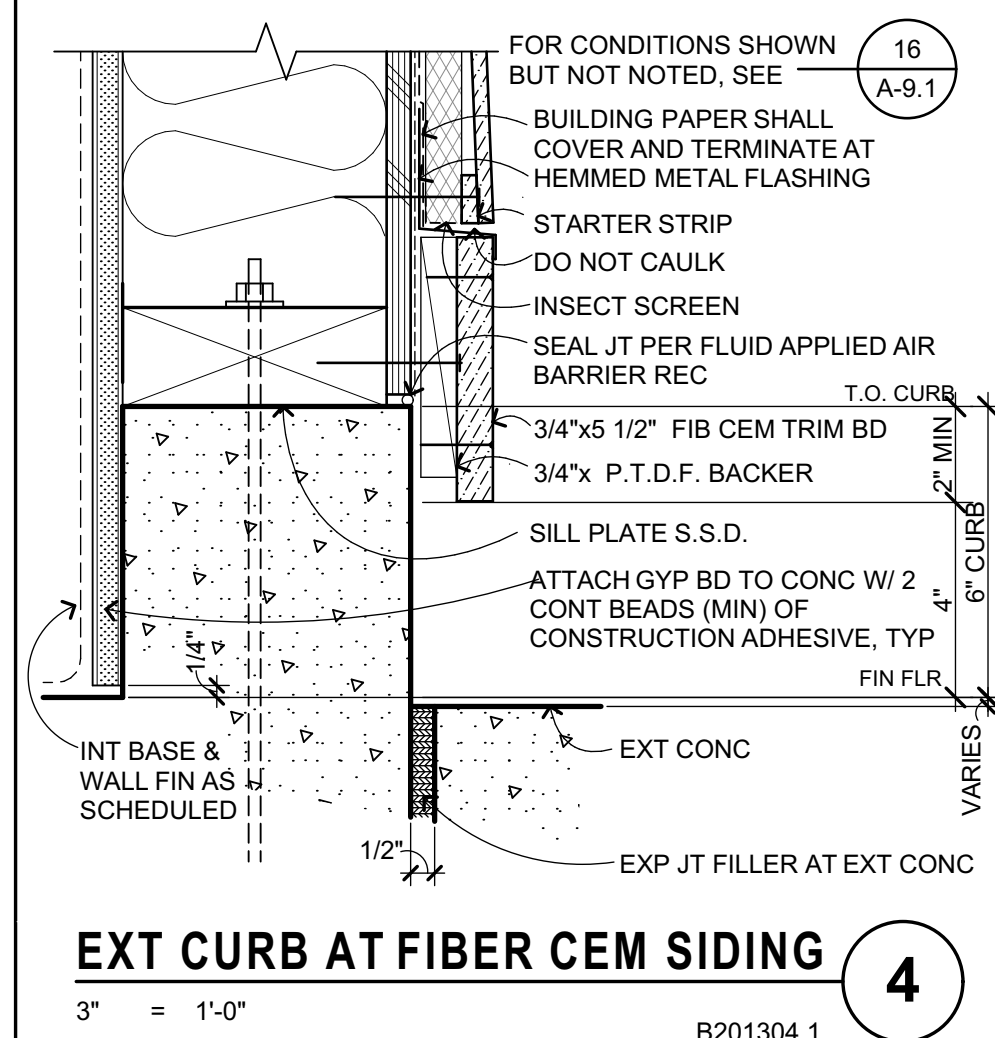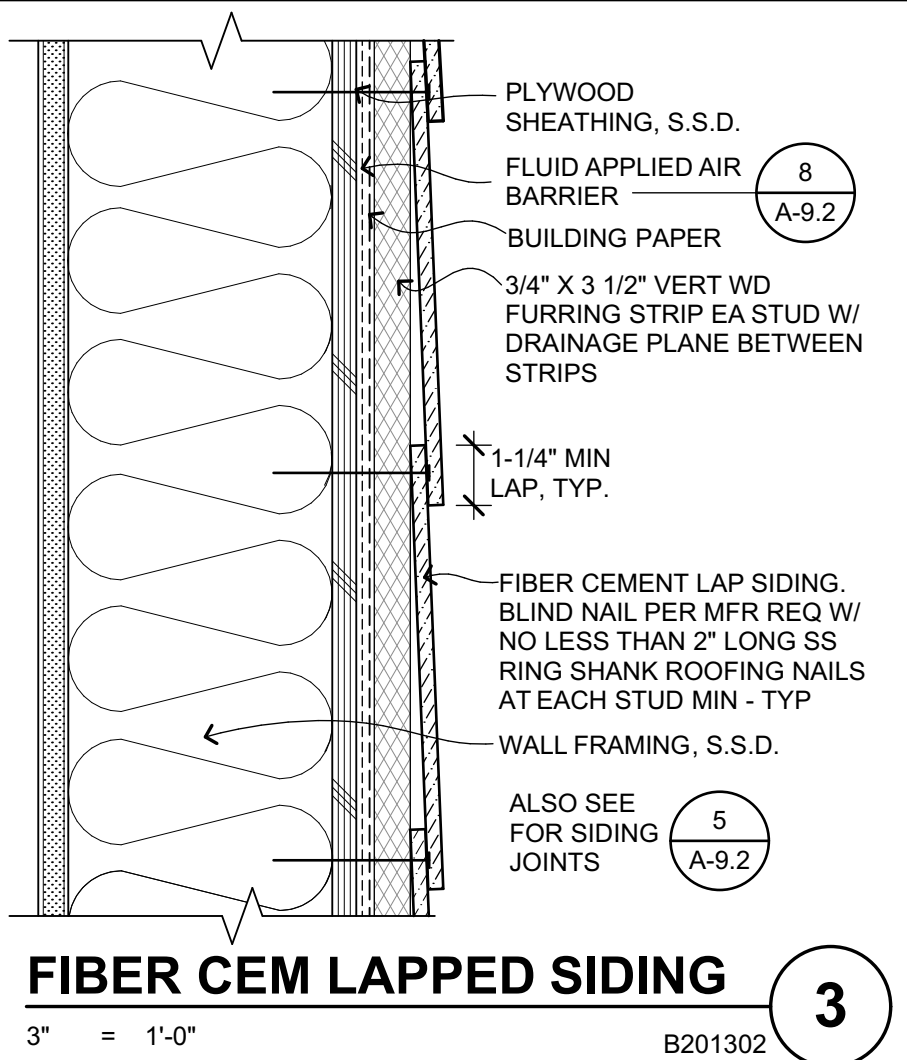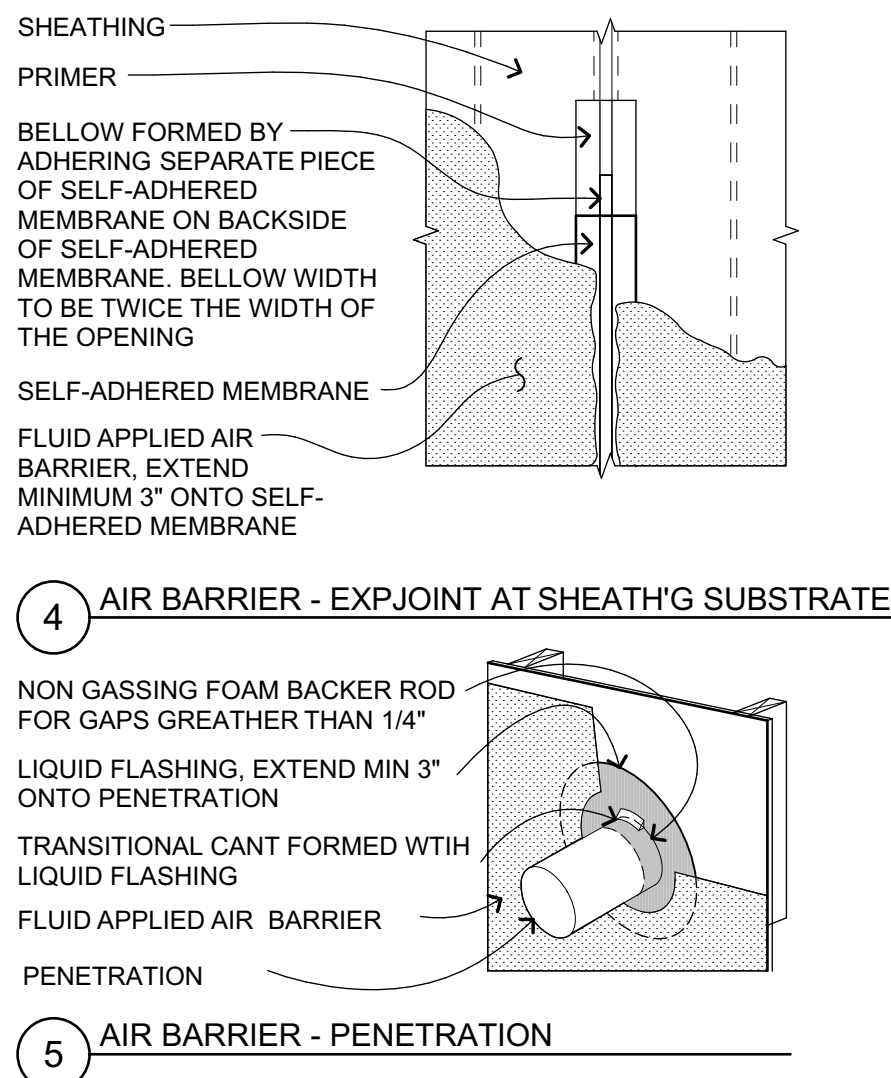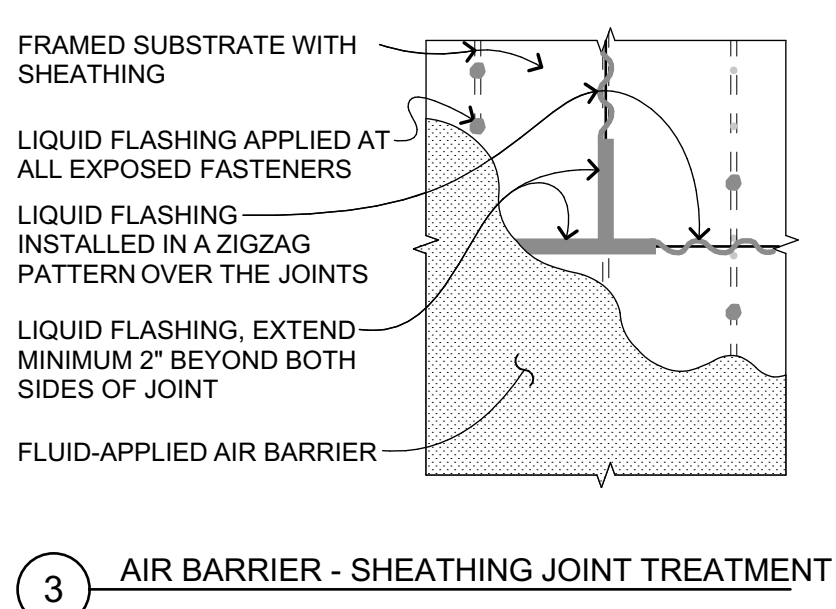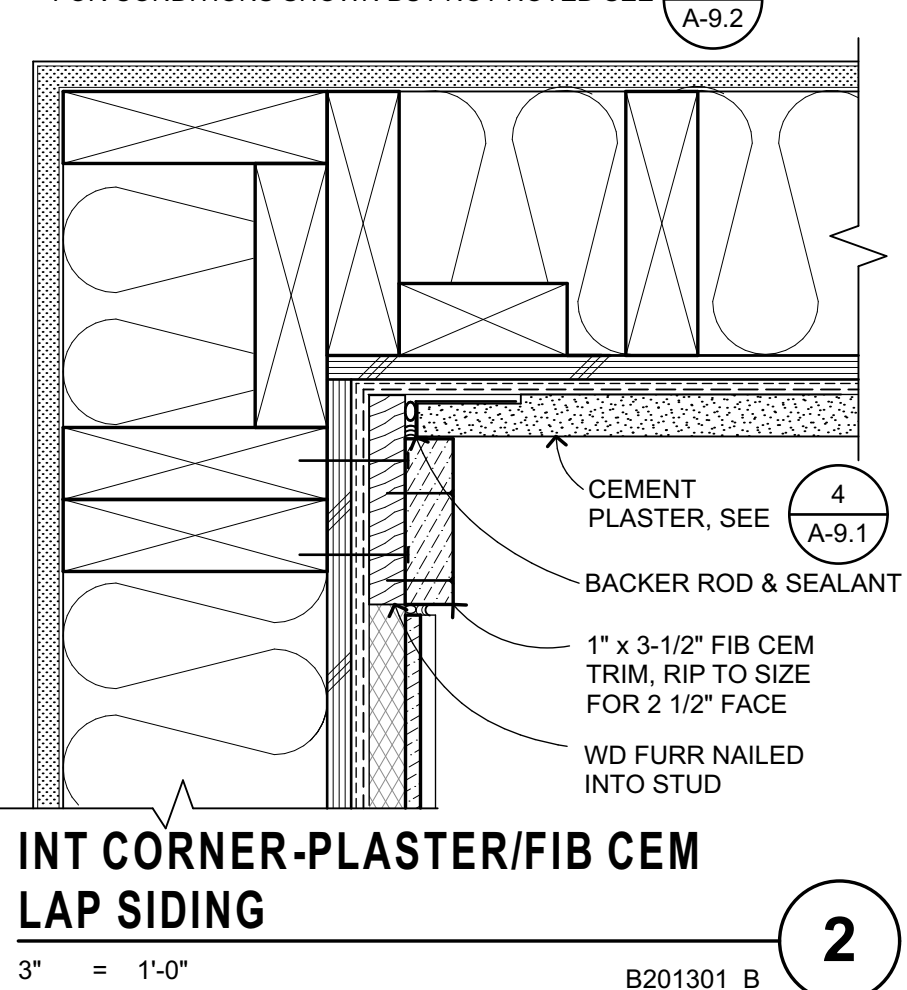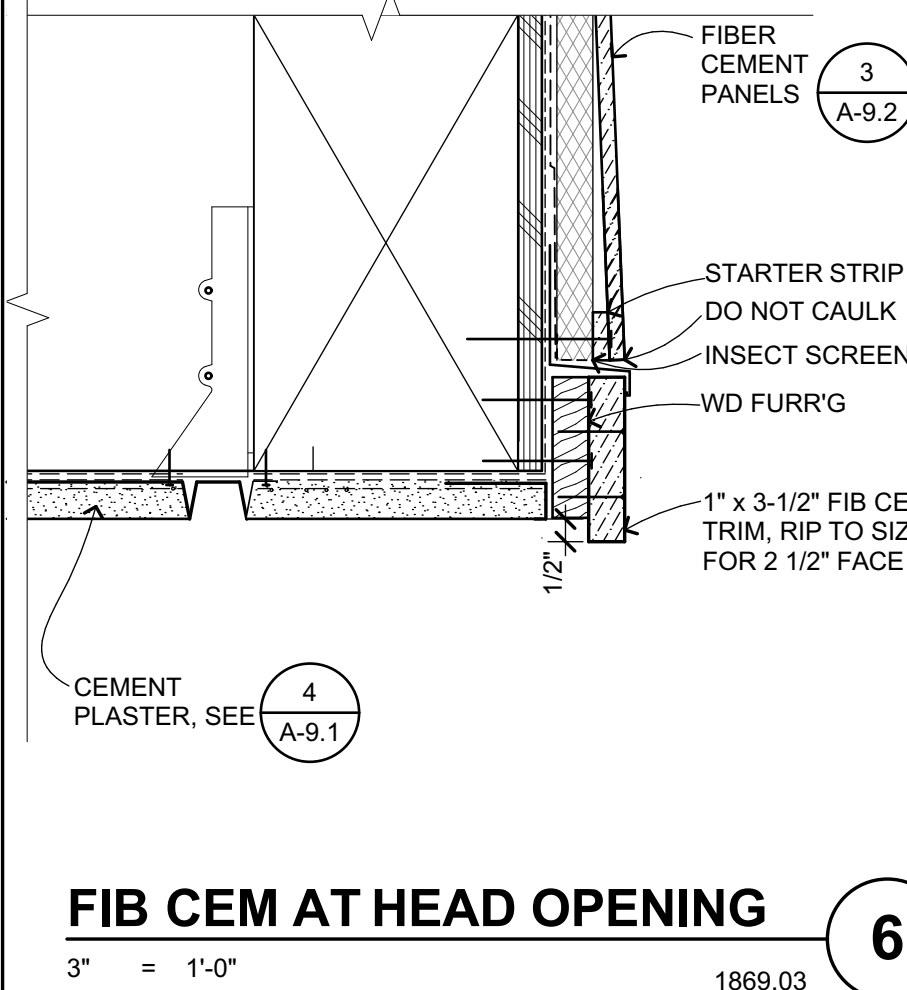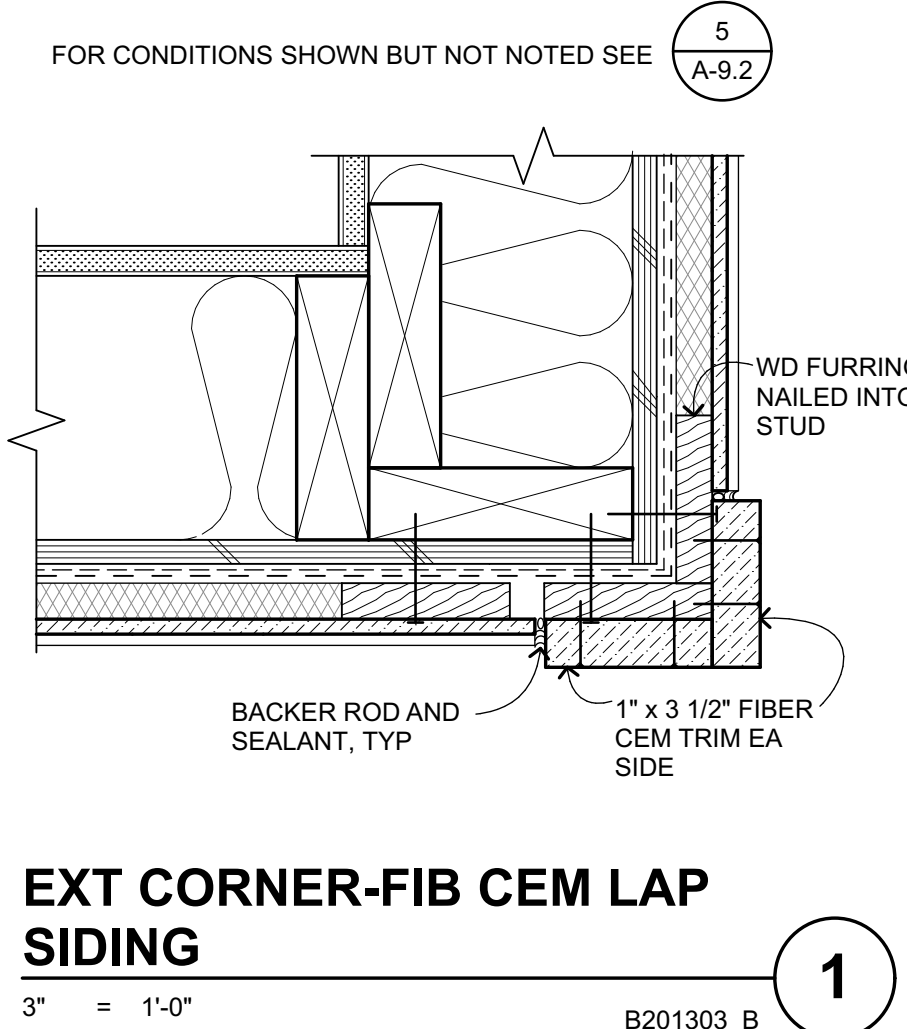




















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QUATTROCCHI KWOK  
ARCHITECTS

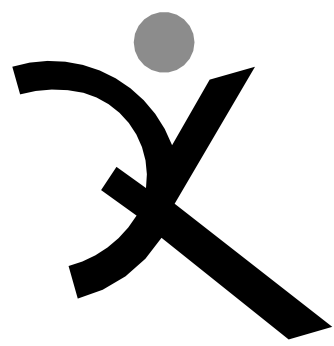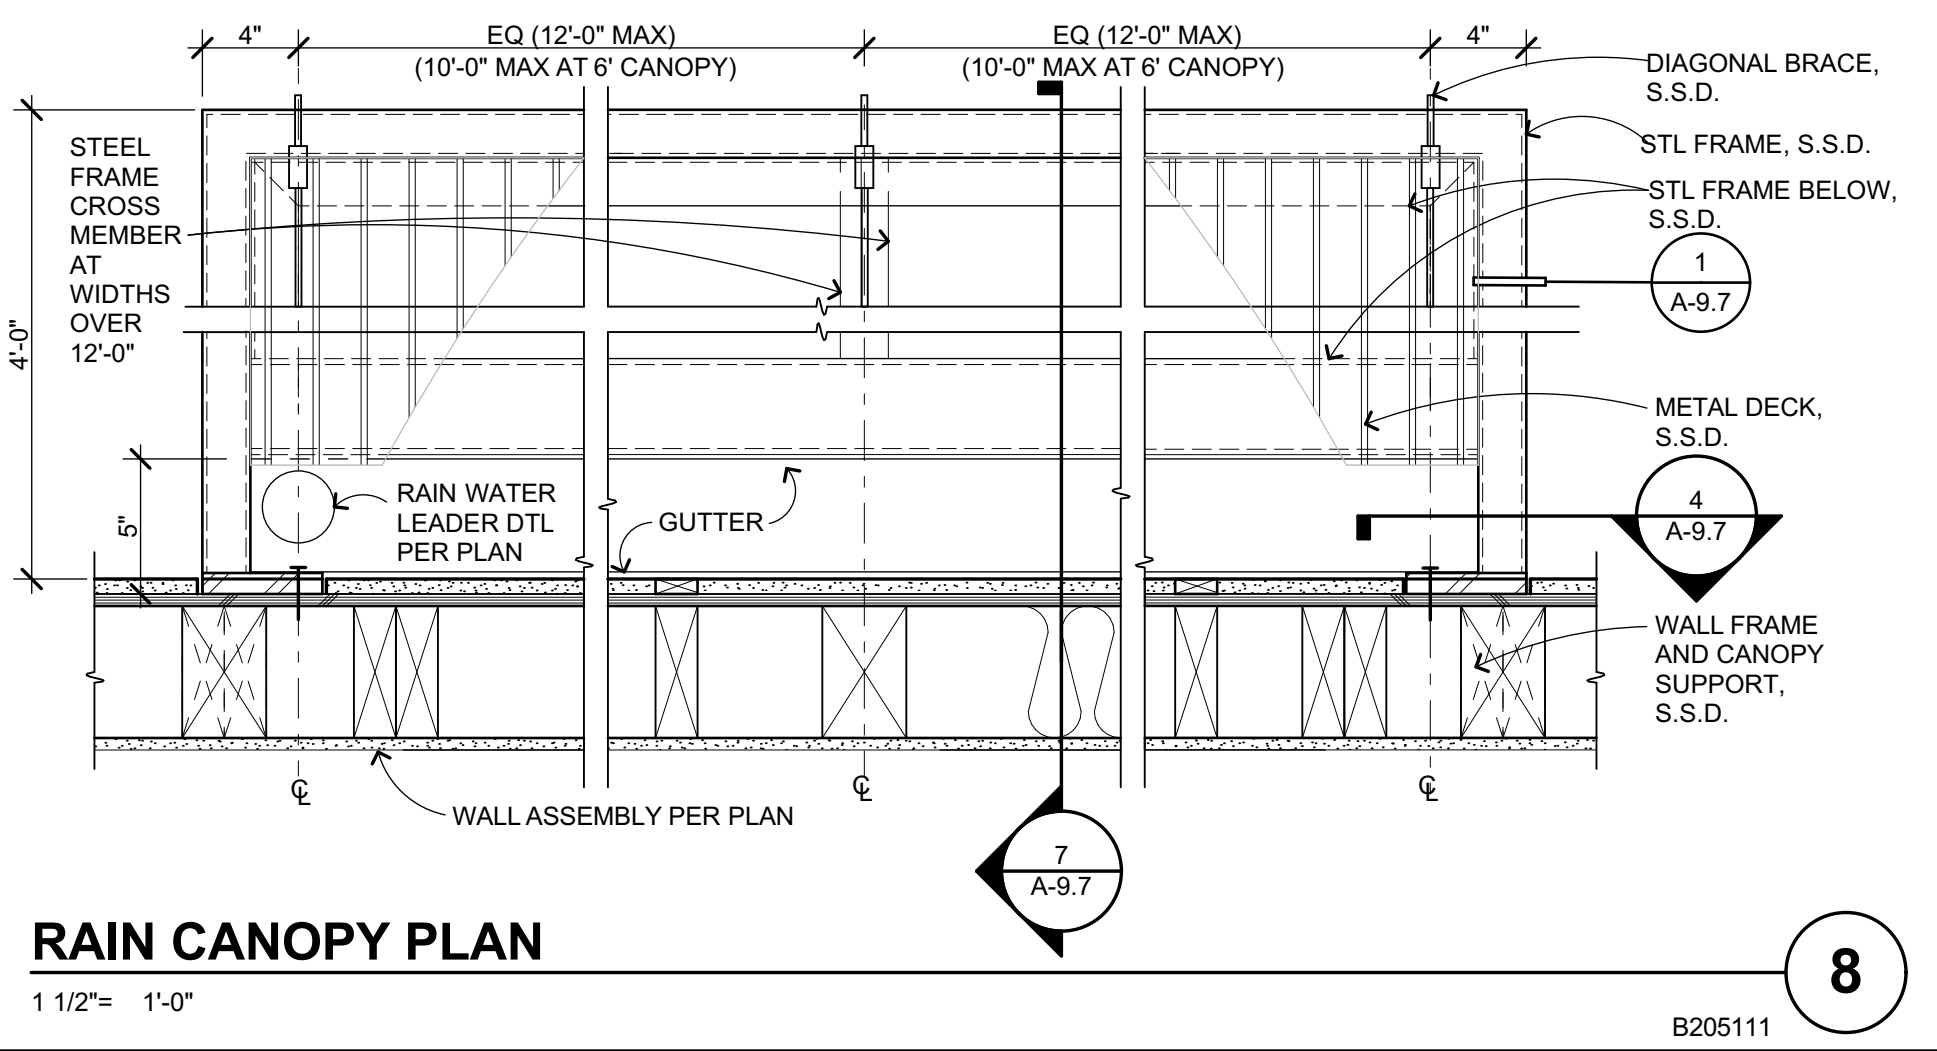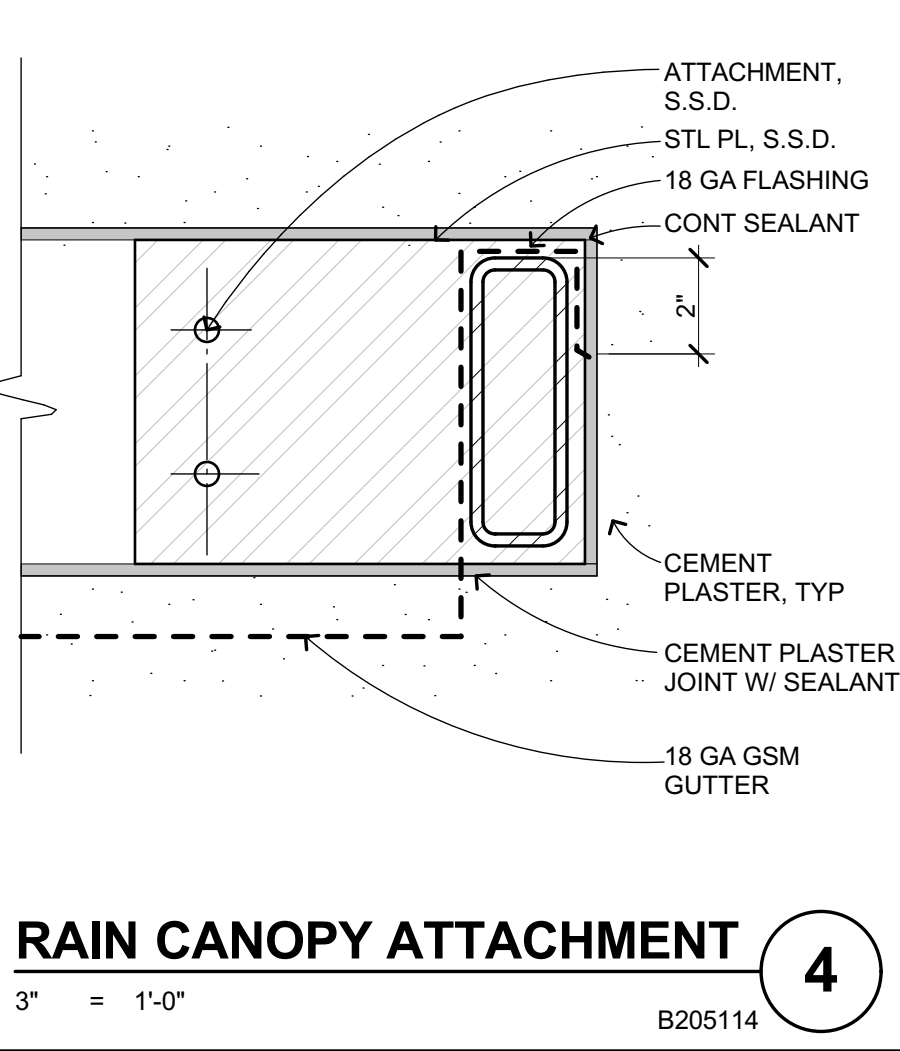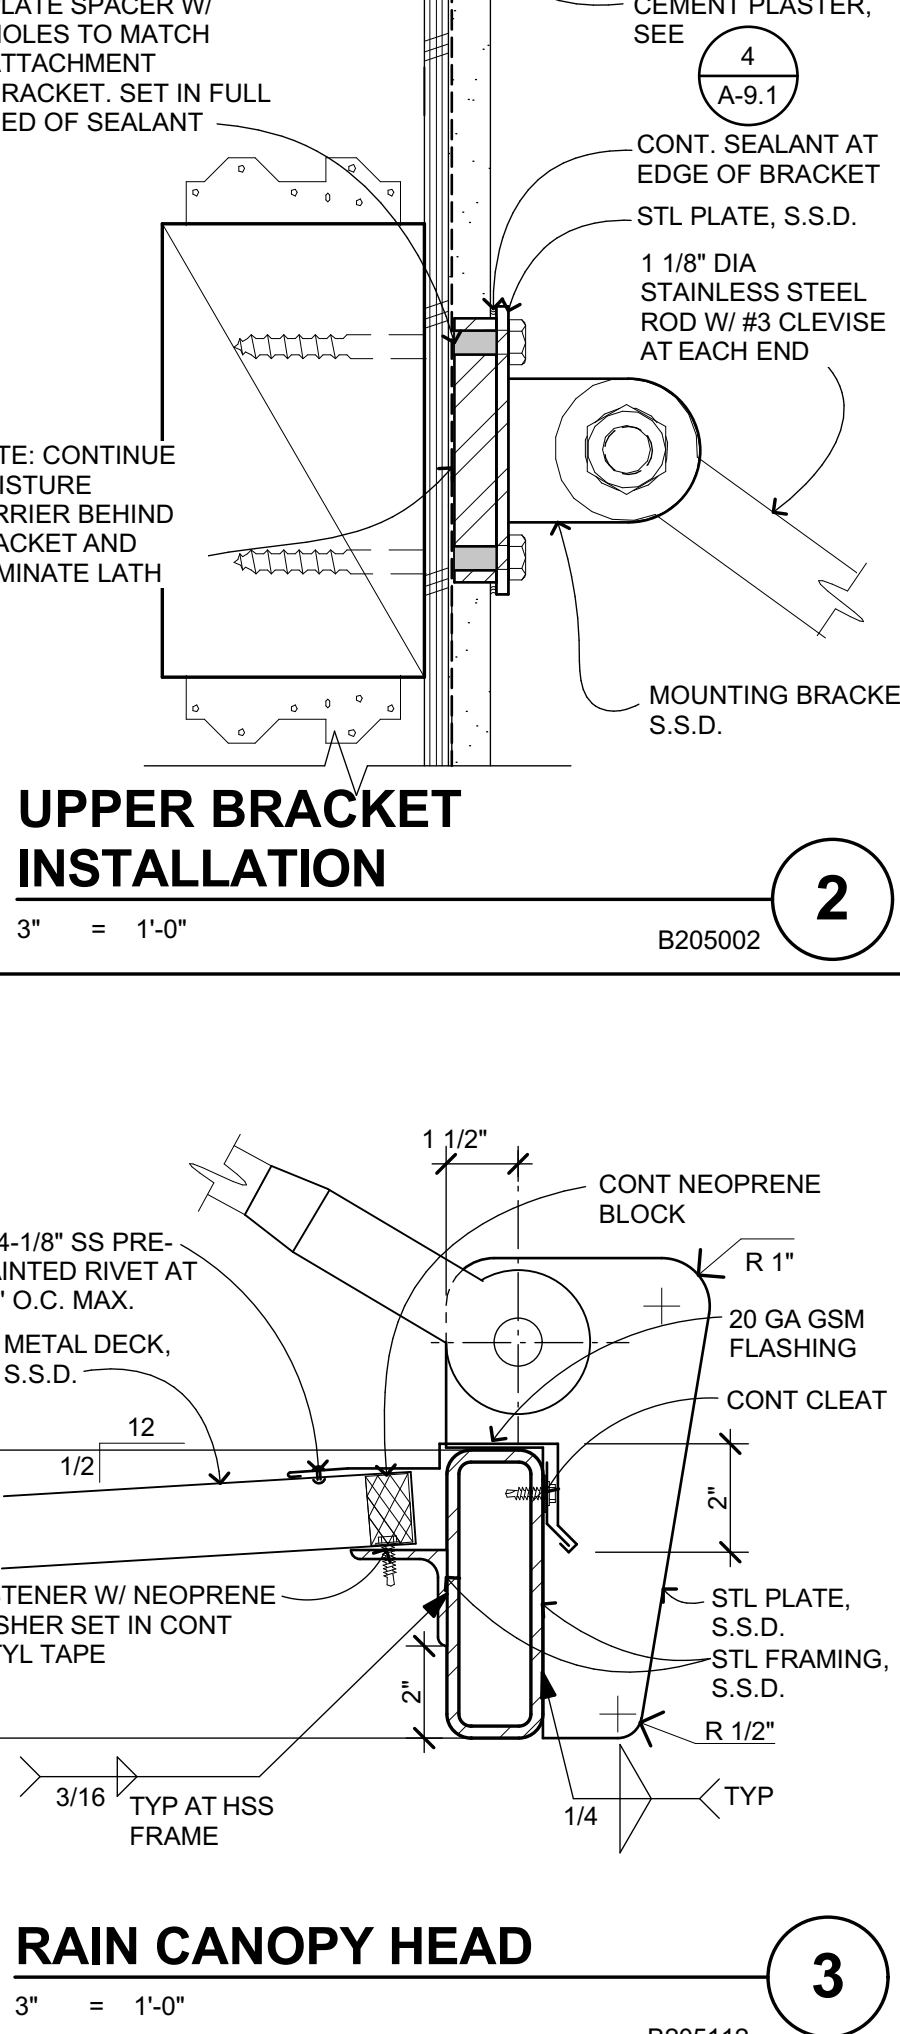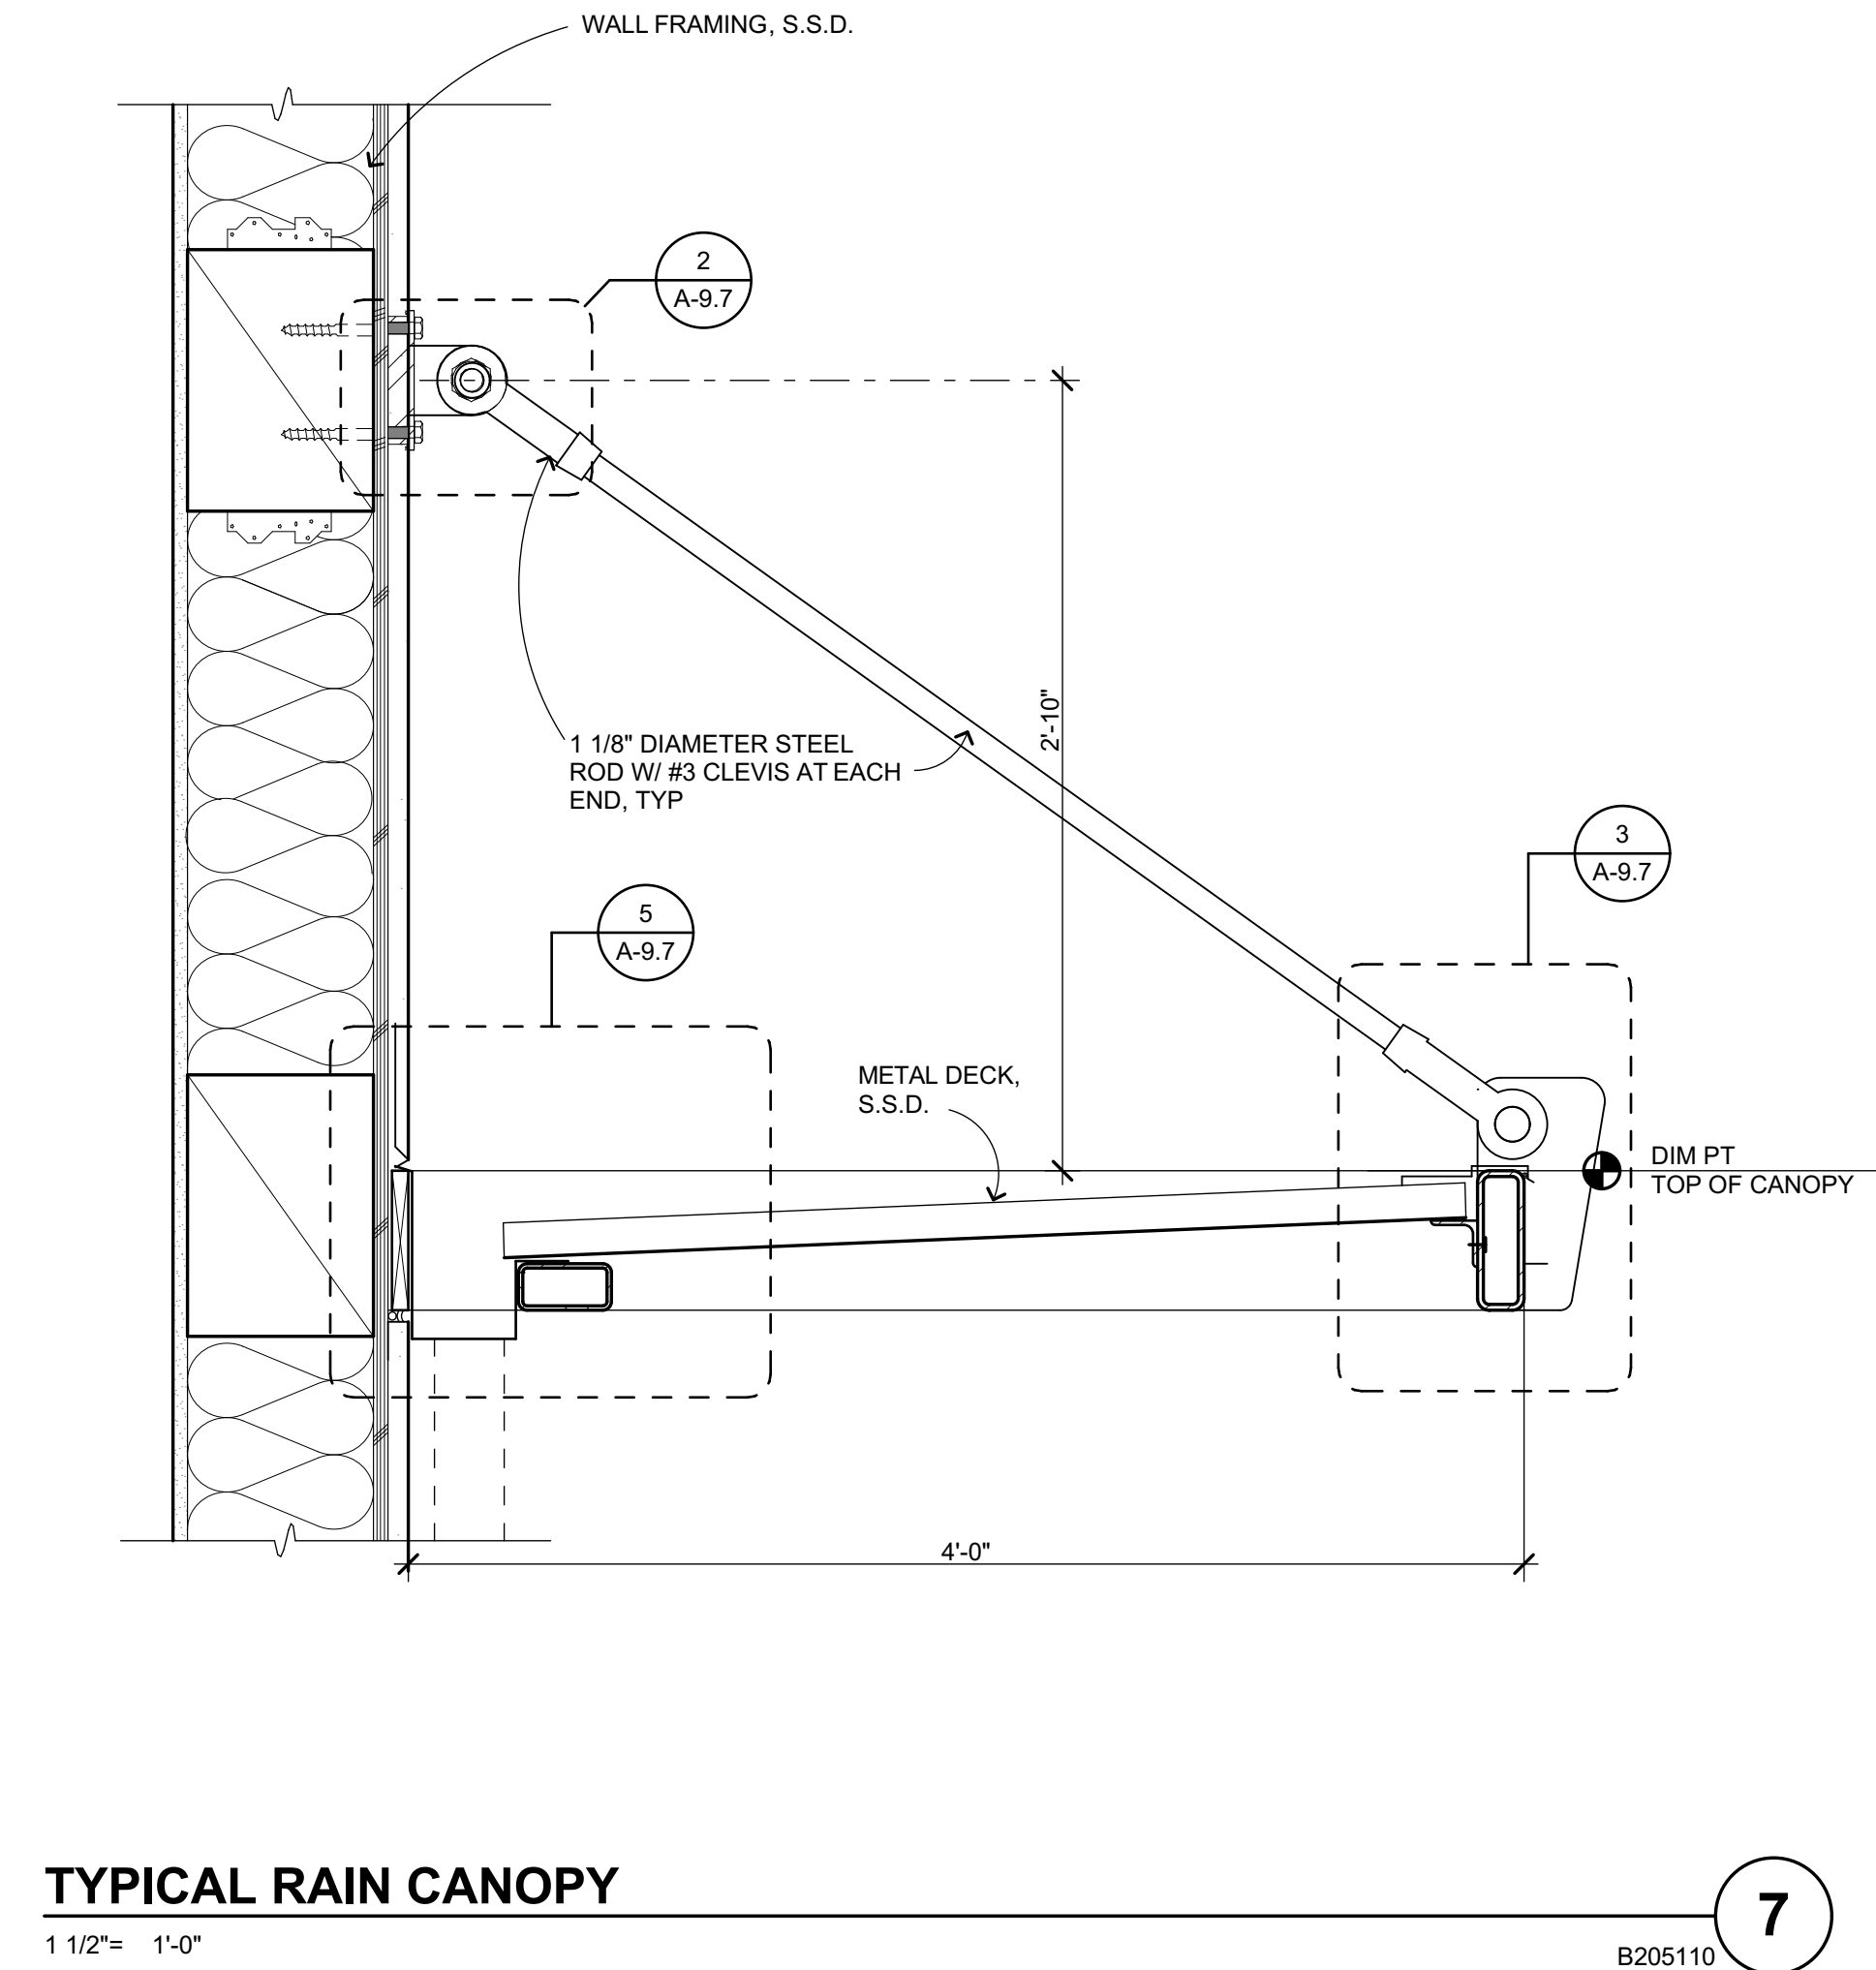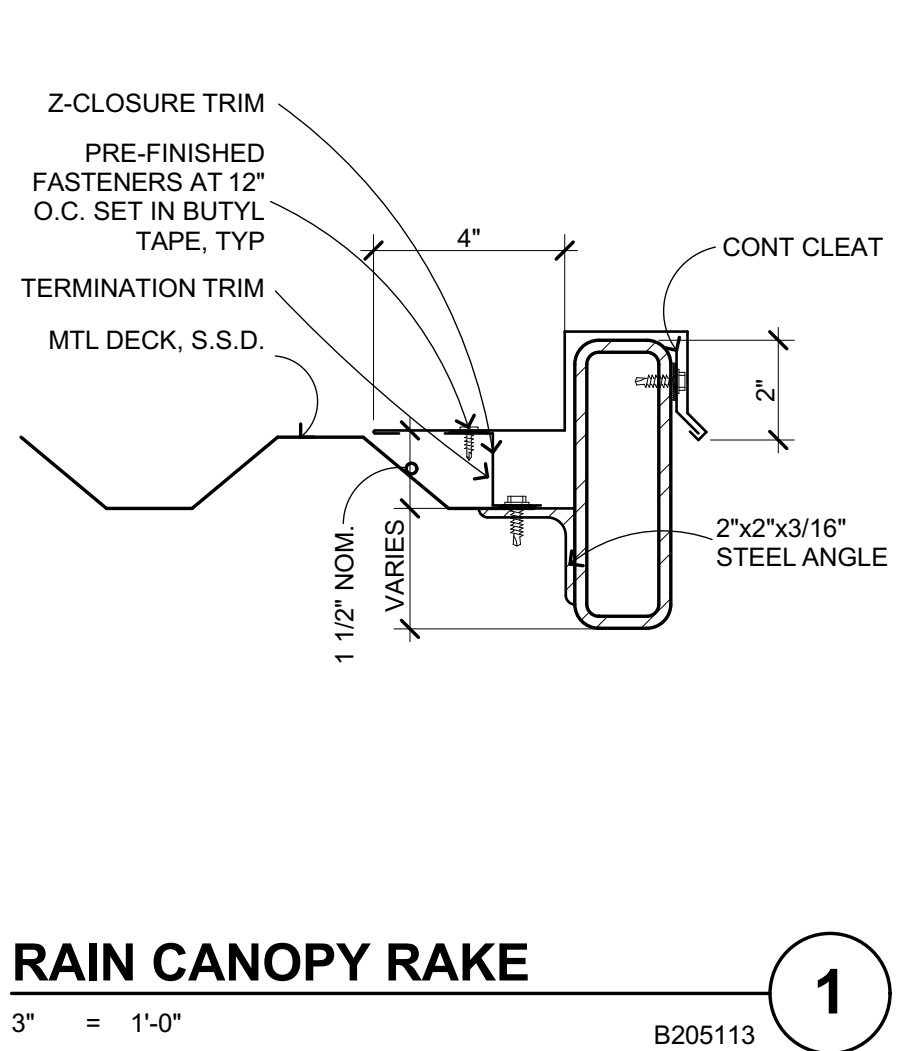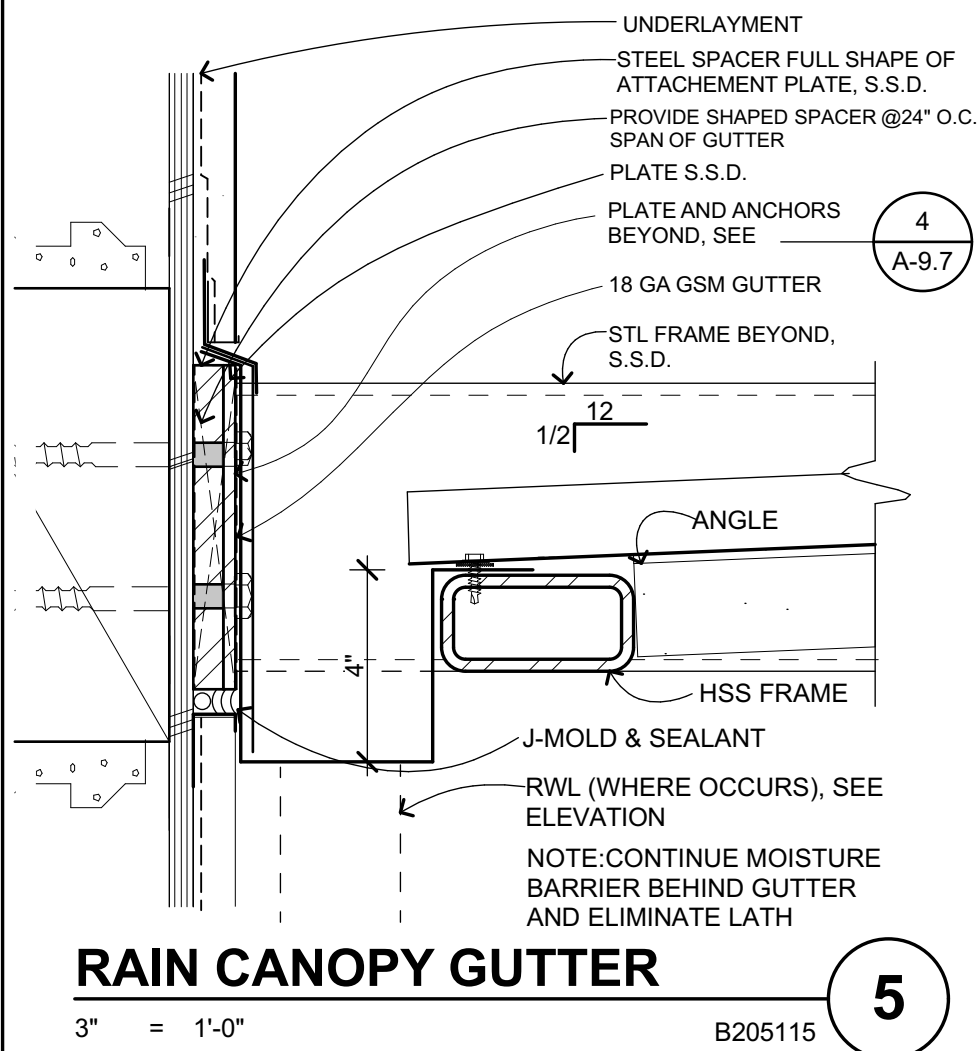**Main:**  
636 Fifth Street, Santa Rosa, CA 95404  
**East Bay:**  
55 Harrison Street, Suite 525,  
Oakland, CA 94607  
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**FREEDOM  
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DSA APP NO. 01-119278

ARCH PROJECT NO: 1869.00  
DRAWN BY: PAG  
DRAWING SCALE: AS NOTED  
PTN: 61721-78 FILE NO: 7-H4

BID DOCUMENT  
APRIL 27, 2021  
SHEET TITLE

**RAIN CANOPY  
DETAILS**

SHEET NUMBER


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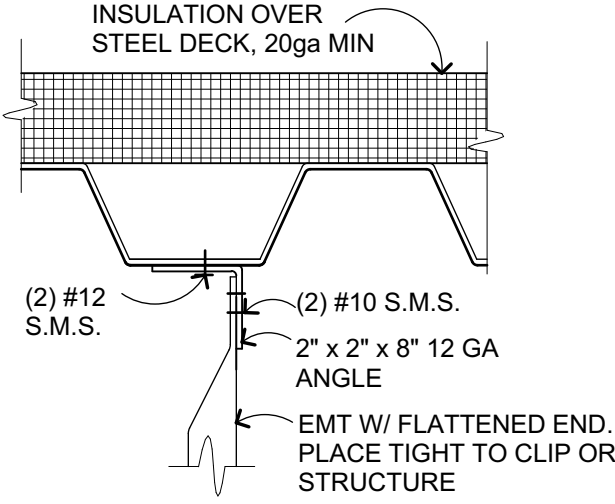




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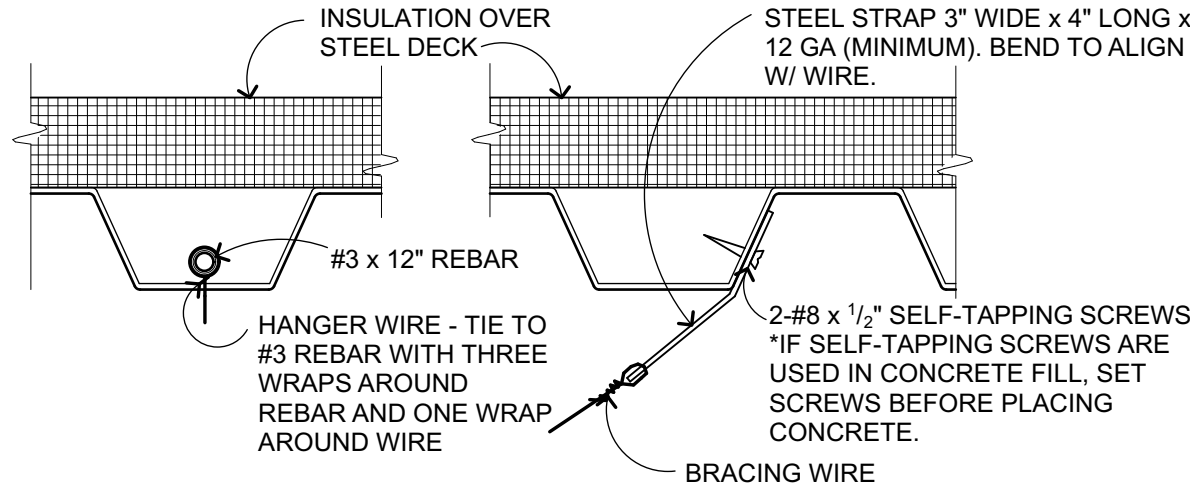
A COMPRESSION STRUT (EMT) DSA IR 25.2-13 FIGURE 3.20 OPTION 1




STEEL DECK W/ INSULATION DSA IR 25.2-13 FIGURE 5.20 OPTION 1

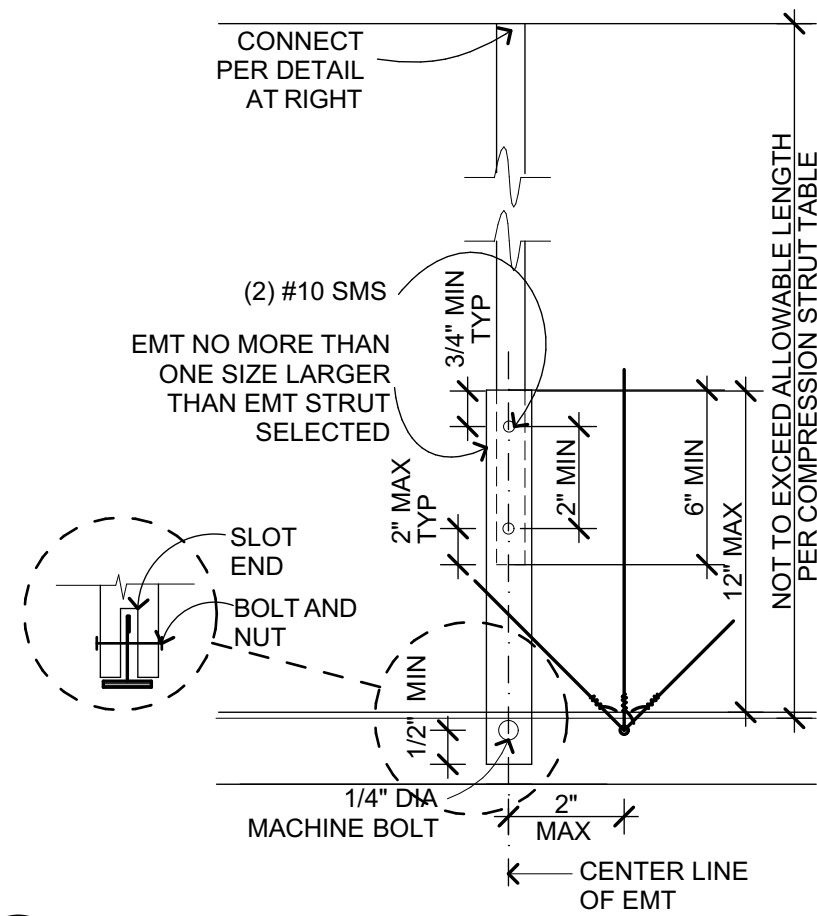FOR COMPRESSION STRUT SIZING SEE

4
A-10.1



B STEEL DECK W/ INSULATION 20 GA MIN DECK DSA IR 25.2-13 FIGURE 4.20

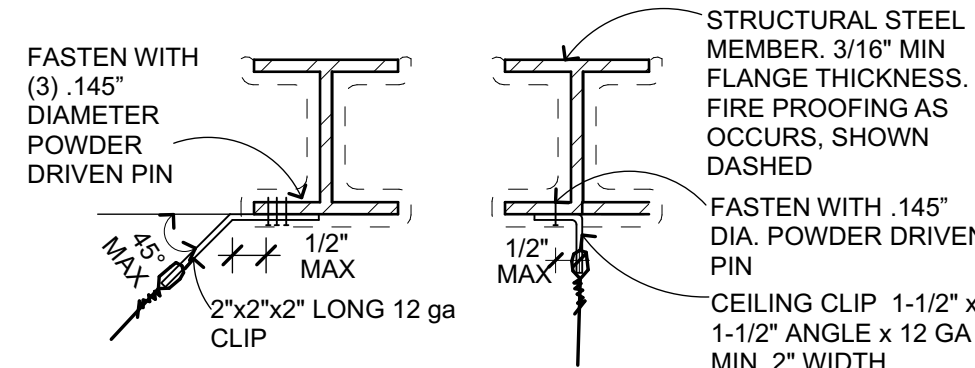

SPLAYED BRACING WIRE DSA IR 25.2-13 FIGURE 4.33

VERTICAL HANGER WIRE DSA IR 25.2-13 FIGURE 4.23


E AT STEEL BEAM NO PIN IS TO BE INSTALLED IN THE PROTECTED ZONE OF ANY STEEL MEMBER

SUSPENDED ACOUSTIC CEILING - MTL DECK

3" = 1'-0"

C303207


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DSA IR 25-2.13 FIGURE 5.21 OPTIONS 1 & 2

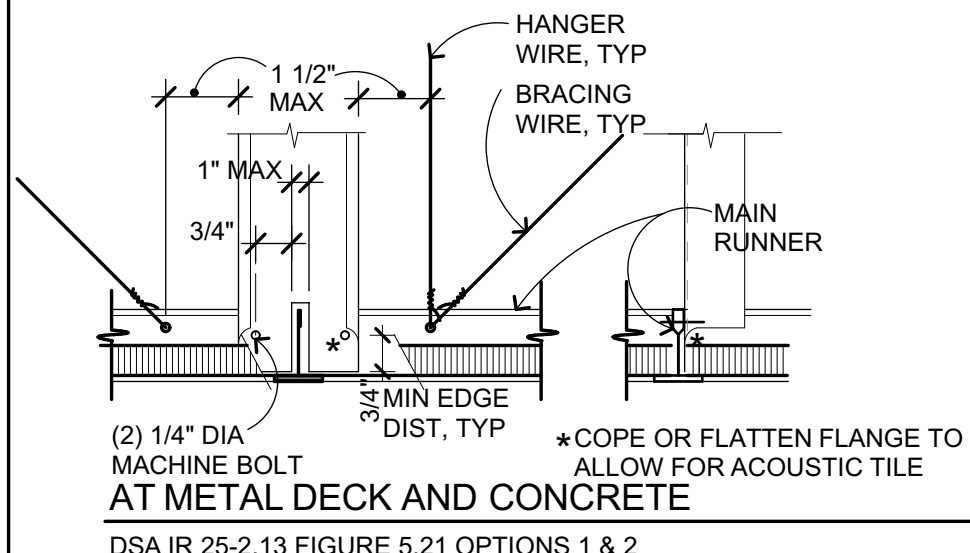ALT MTL CHANNEL STRUT


3" = 1'-0"



STEEL DECK W/ INSULATION 20 GA MIN DECK DSA IR 25-2.13 FIGURE 5.20 OPTIONS 1 & 2

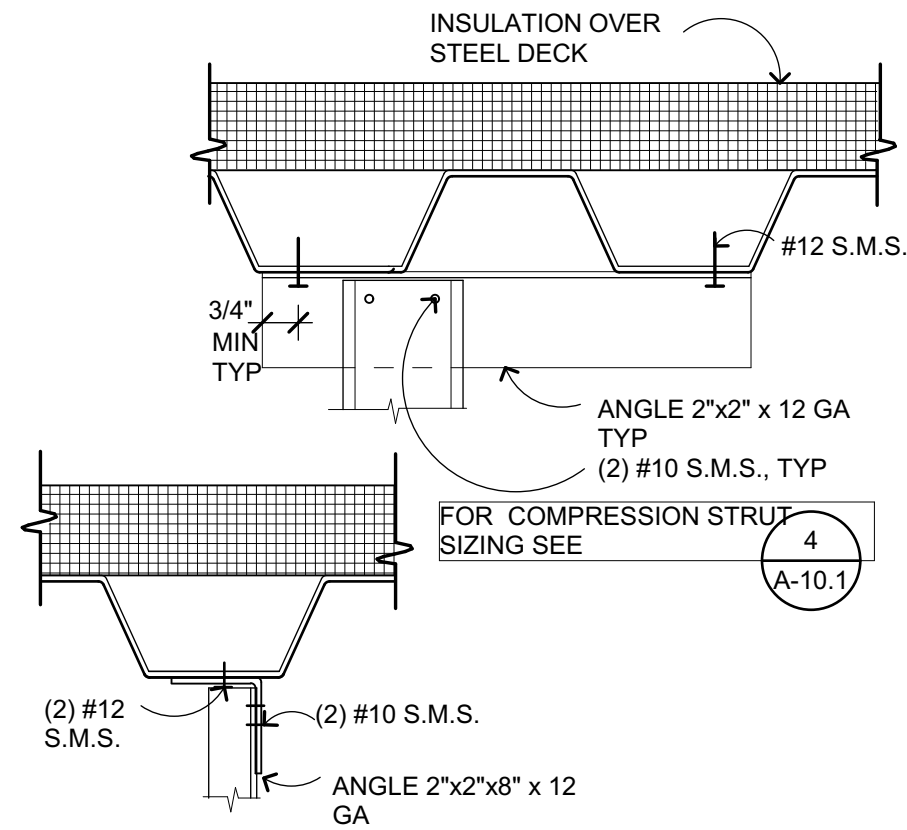4

C303202B

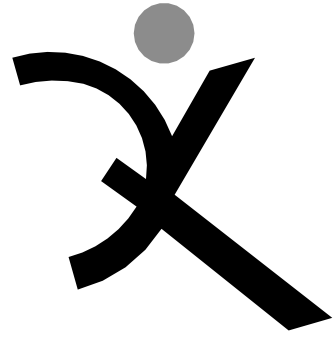

QUATTROCCHI KWOK ARCHITECTS

Main: 636 Fifth Street, Santa Rosa, CA 95404  
East Bay: 55 Harrison Street, Suite 525, Oakland, CA 94607  
(707) 576-0829



SIGNED: MAY 5, 2021

FREEDOM HIGH SCHOOL

NEW AUXILIARY GYMNASIUM

1050 NEROLY RD, OAKLEY, CA 94561

LIBERTY UNION HIGH SCHOOL DISTRICT

DSA APP NO. 01-119278

ARCH PROJECT NO: 1869.00

DRAWN BY: PAG

DRAWING SCALE: AS NOTED

PTN: 61721-78 FILE NO: 7-H4

BID DOCUMENT

APRIL 27, 2021


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CEILING DETAILS AT METAL DECK


SHEET NUMBER

A-10.2




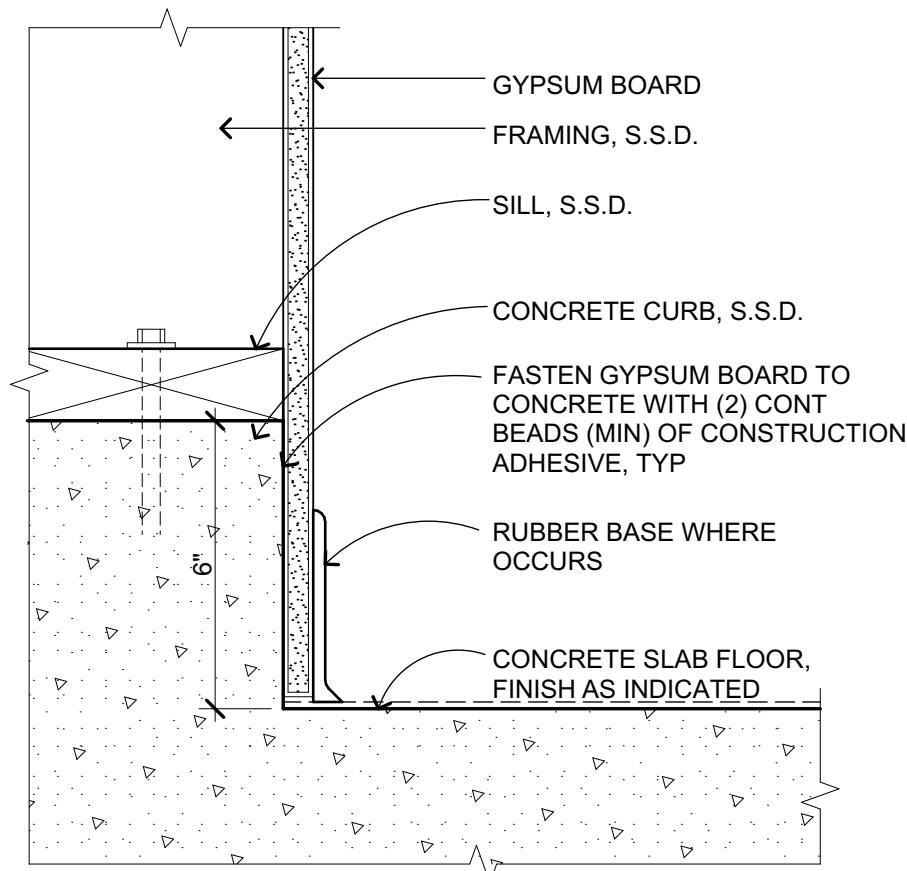


**CONC CURB AT INT WALL**  
3" = 1'-0" C301101

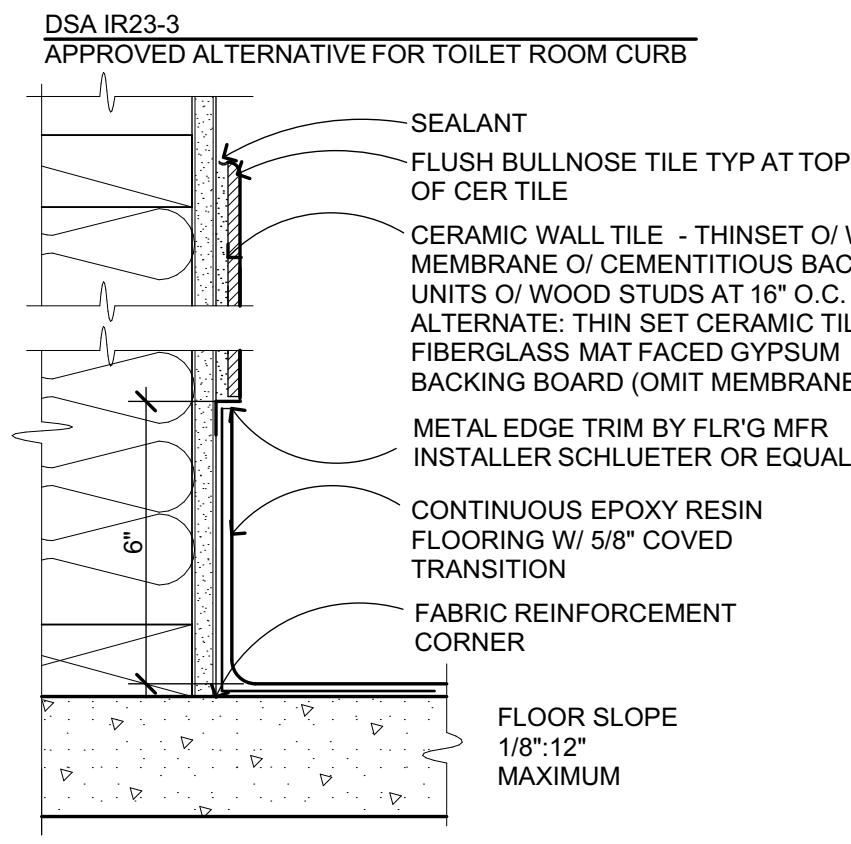


**INTERIOR EPOXY BASE**  
3" = 1'-0" C302102_A

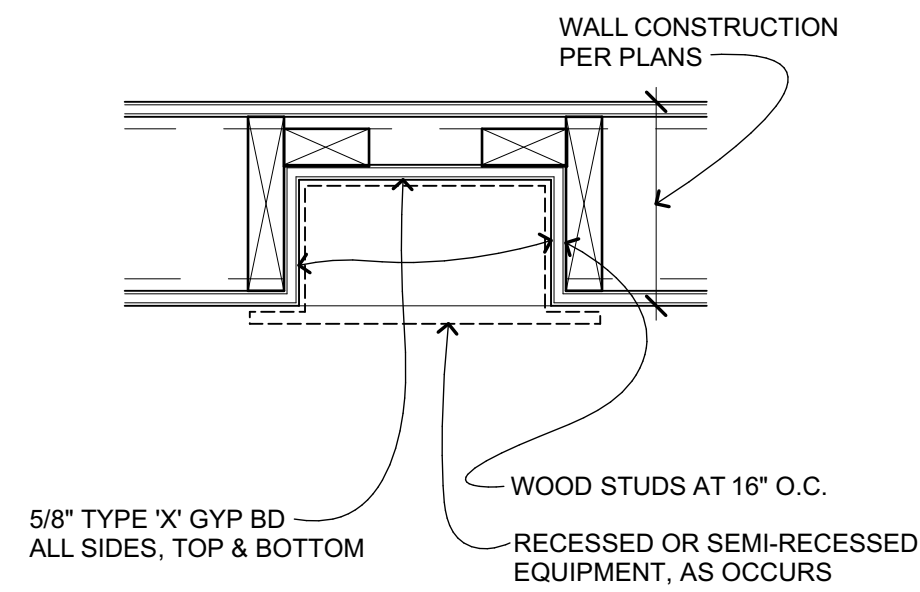



**RECESS AT WALL**  
1 1/2" = 1'-0" C104102

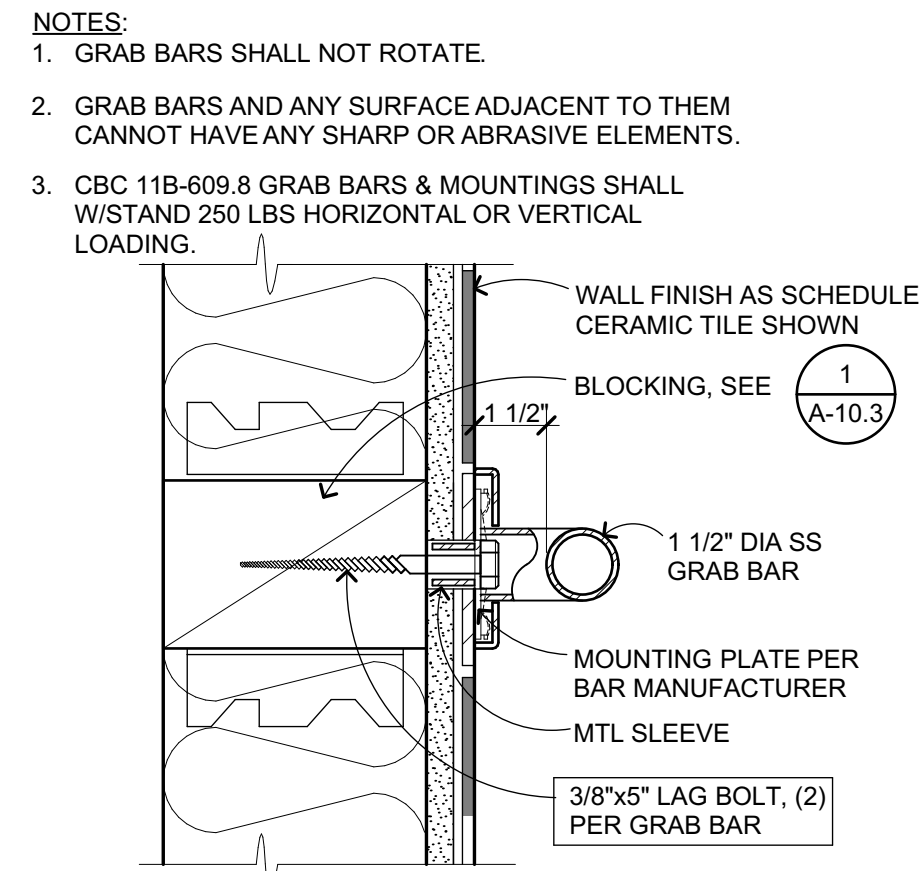


**GRAB BAR ATTACH**  
3" = 1'-0" C103101_A

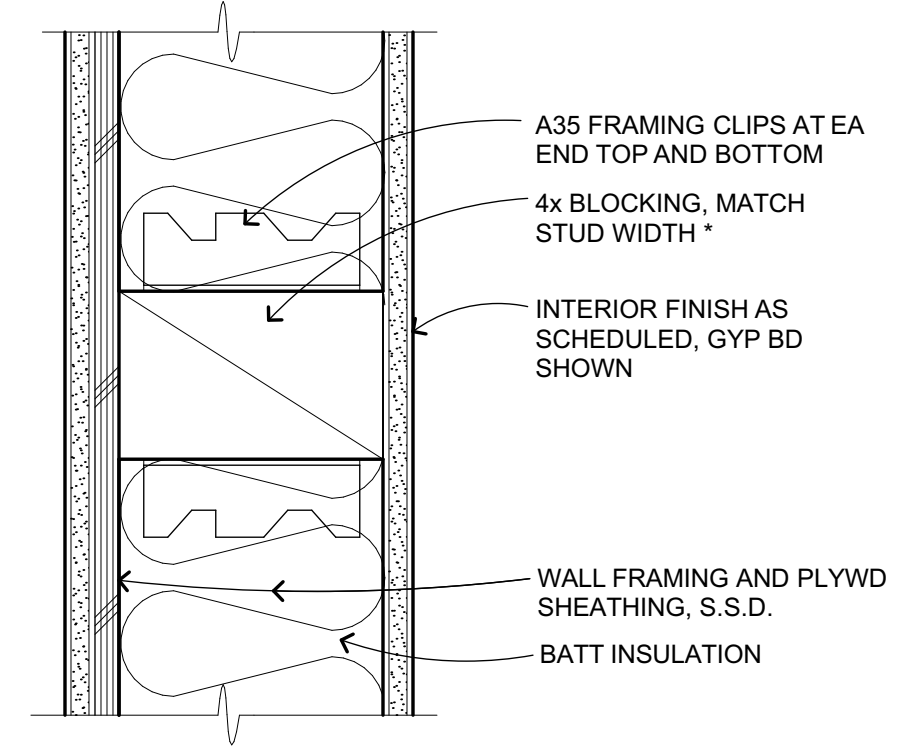


**BLK'G/BACKING-WD**  
3" = 1'-0" C108101_A

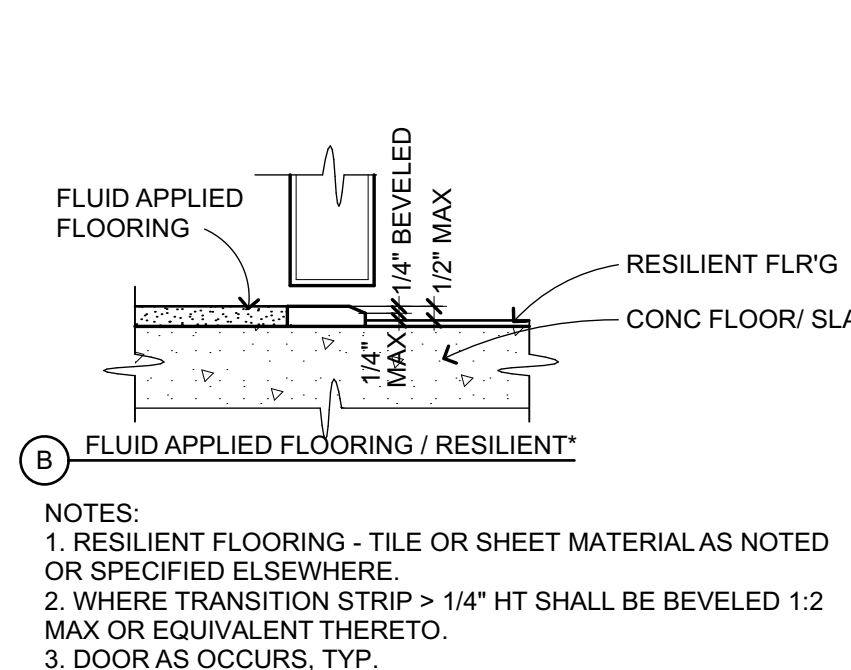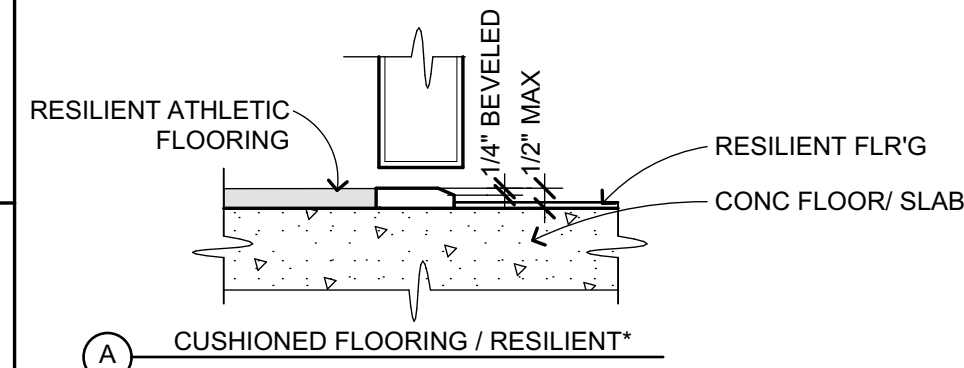


**FLOOR TRANSITIONS/SILLS**  
3" = 1'-0" C102801

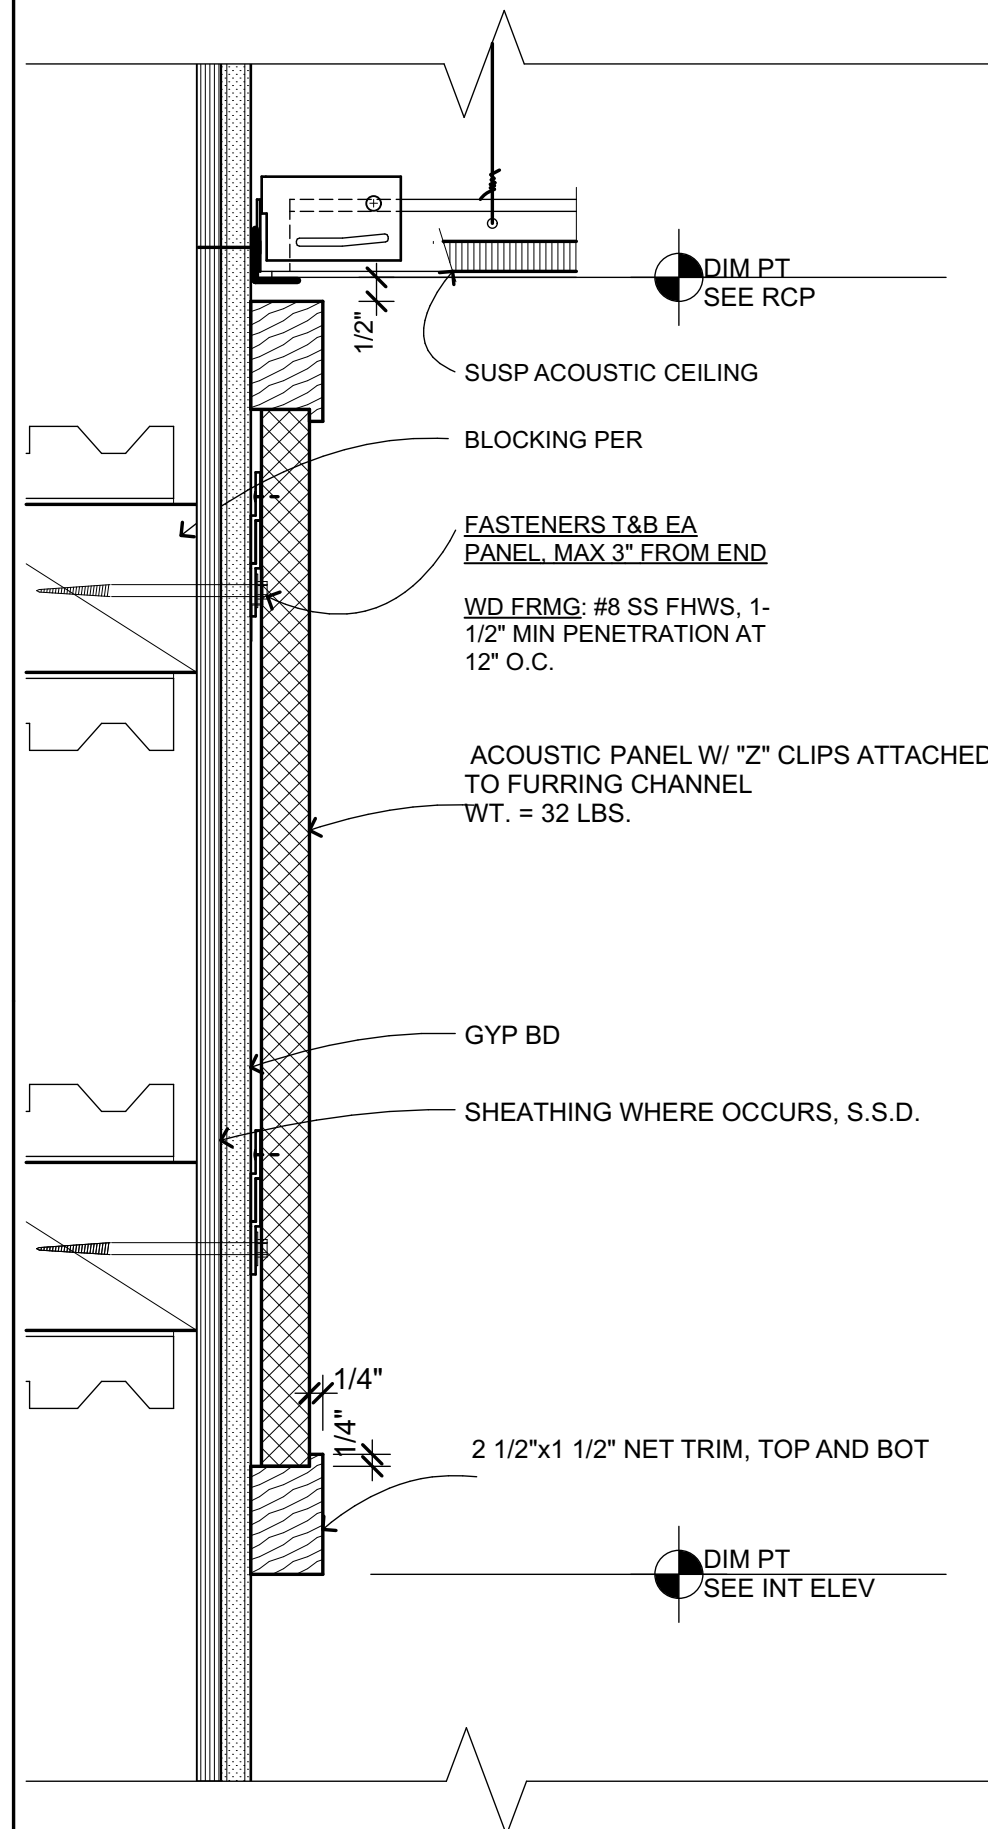


**ACOUSTIC WALL PANEL**  
3" = 1'-0" 1873.03

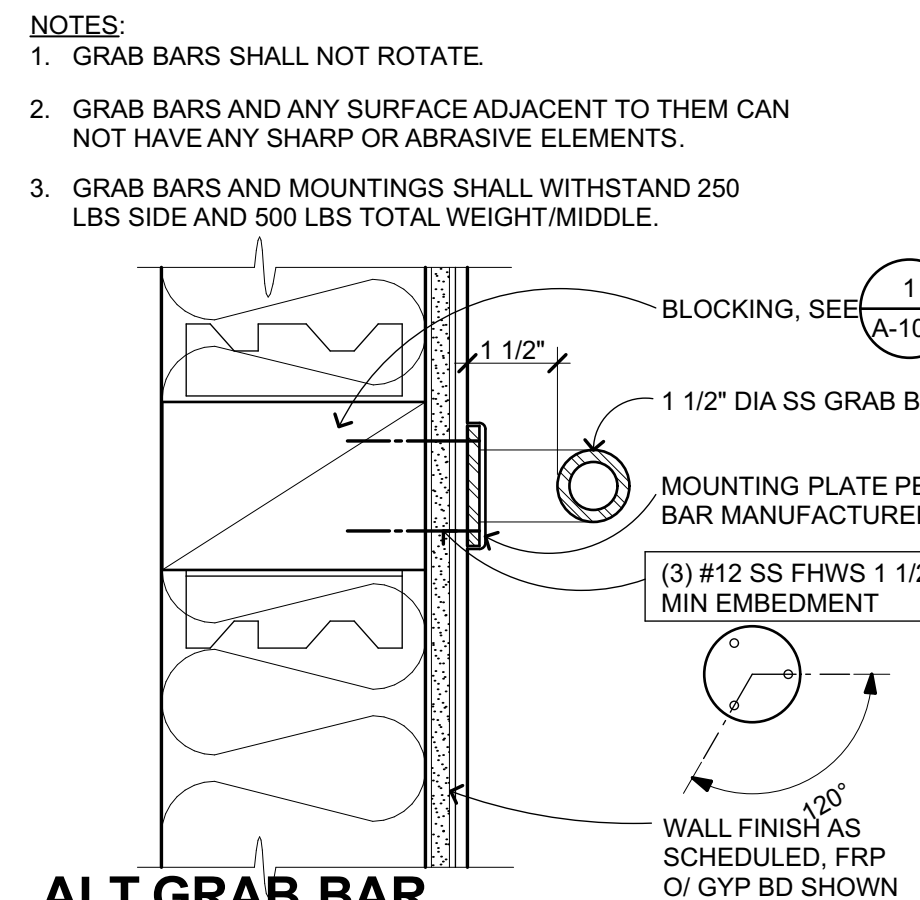


**ALT GRAB BAR ATTACHMENT**  
3" = 1'-0" C103102

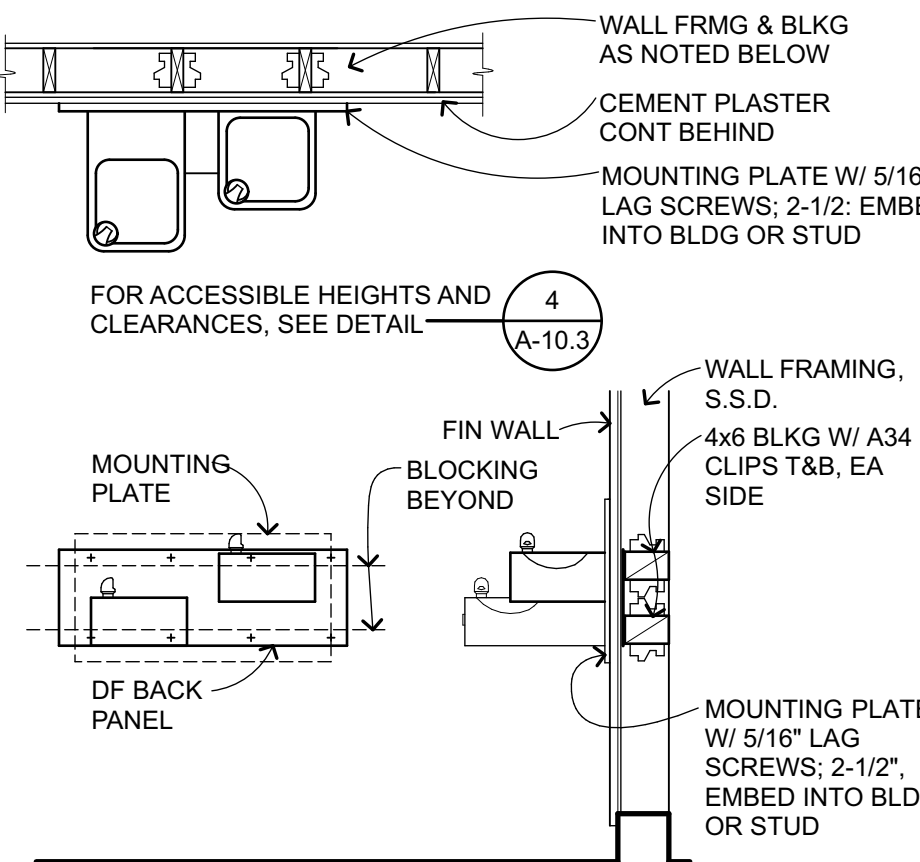


**DF MOUNTING-WD BLKG**  
1/2" = 1'-0" D208107

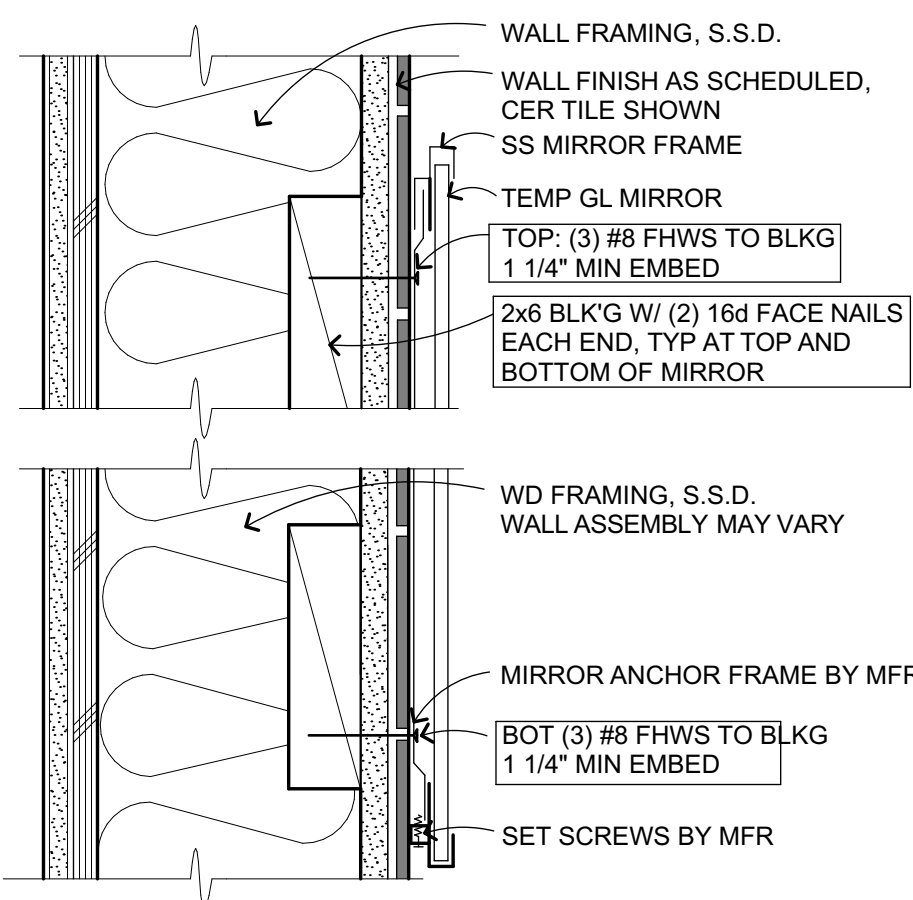

**MIRROR ATTACHMENT**  
3" = 1'-0" C103103_A

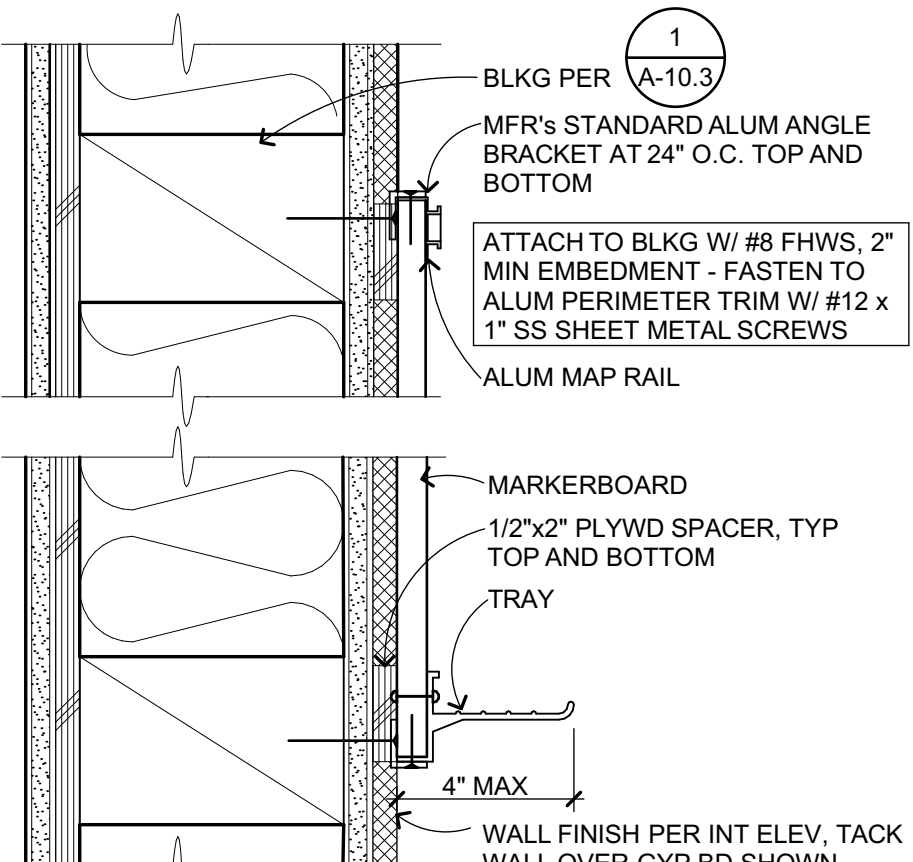



**MARKERBD ATTACH**  
3" = 1'-0" C103201_A

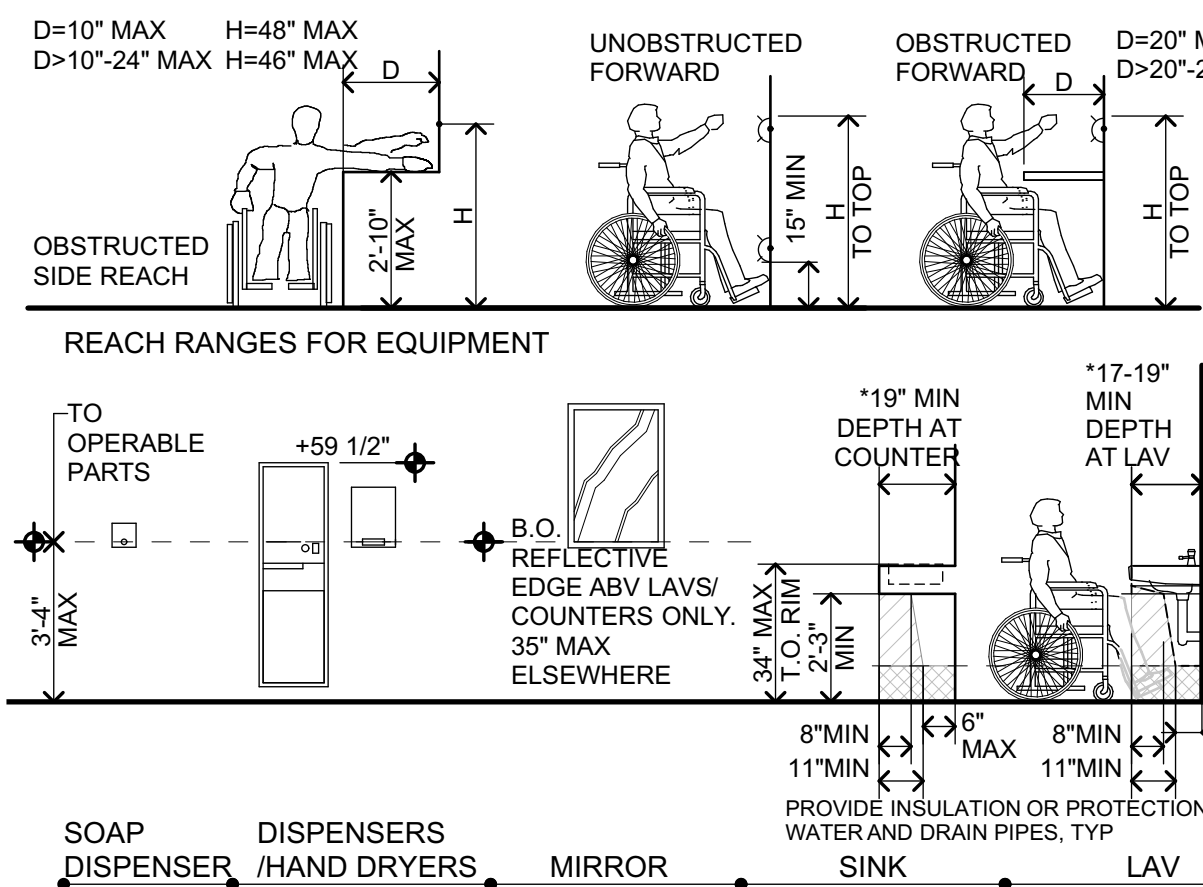

**ACC MOUNTING HEIGHTS - ADULT**  
1/4" = 1'-0"

**TYPICAL:**  
REFER TO PLANS FOR DETAILED INFORMATION SPECIFIC TO THE PROJECT. DIMENSIONS ARE TO FACE OF FINISH, CONTRACTOR TO VERIFY ALL WALL ASSEMBLIES AND INTERIOR FINISHES.

- NOTES AT ACC TOILET STALL**
- COAT HOOKS WHEN PROVIDED SHALL BE MOUNTED AT +48" MAX A.F.F.
  - DOOR PULLS (LOOP OR U-SHAPE HANDLE) SHALL BE MOUNTED AT BOTH SIDES OF DOOR.
  - SLIDE TYPE OR FLIP OVER LATCH (34"-44" A.F.F.) AT ACCESSIBLE STALL DOORS.
  - DOOR SHALL BE SELF CLOSING.

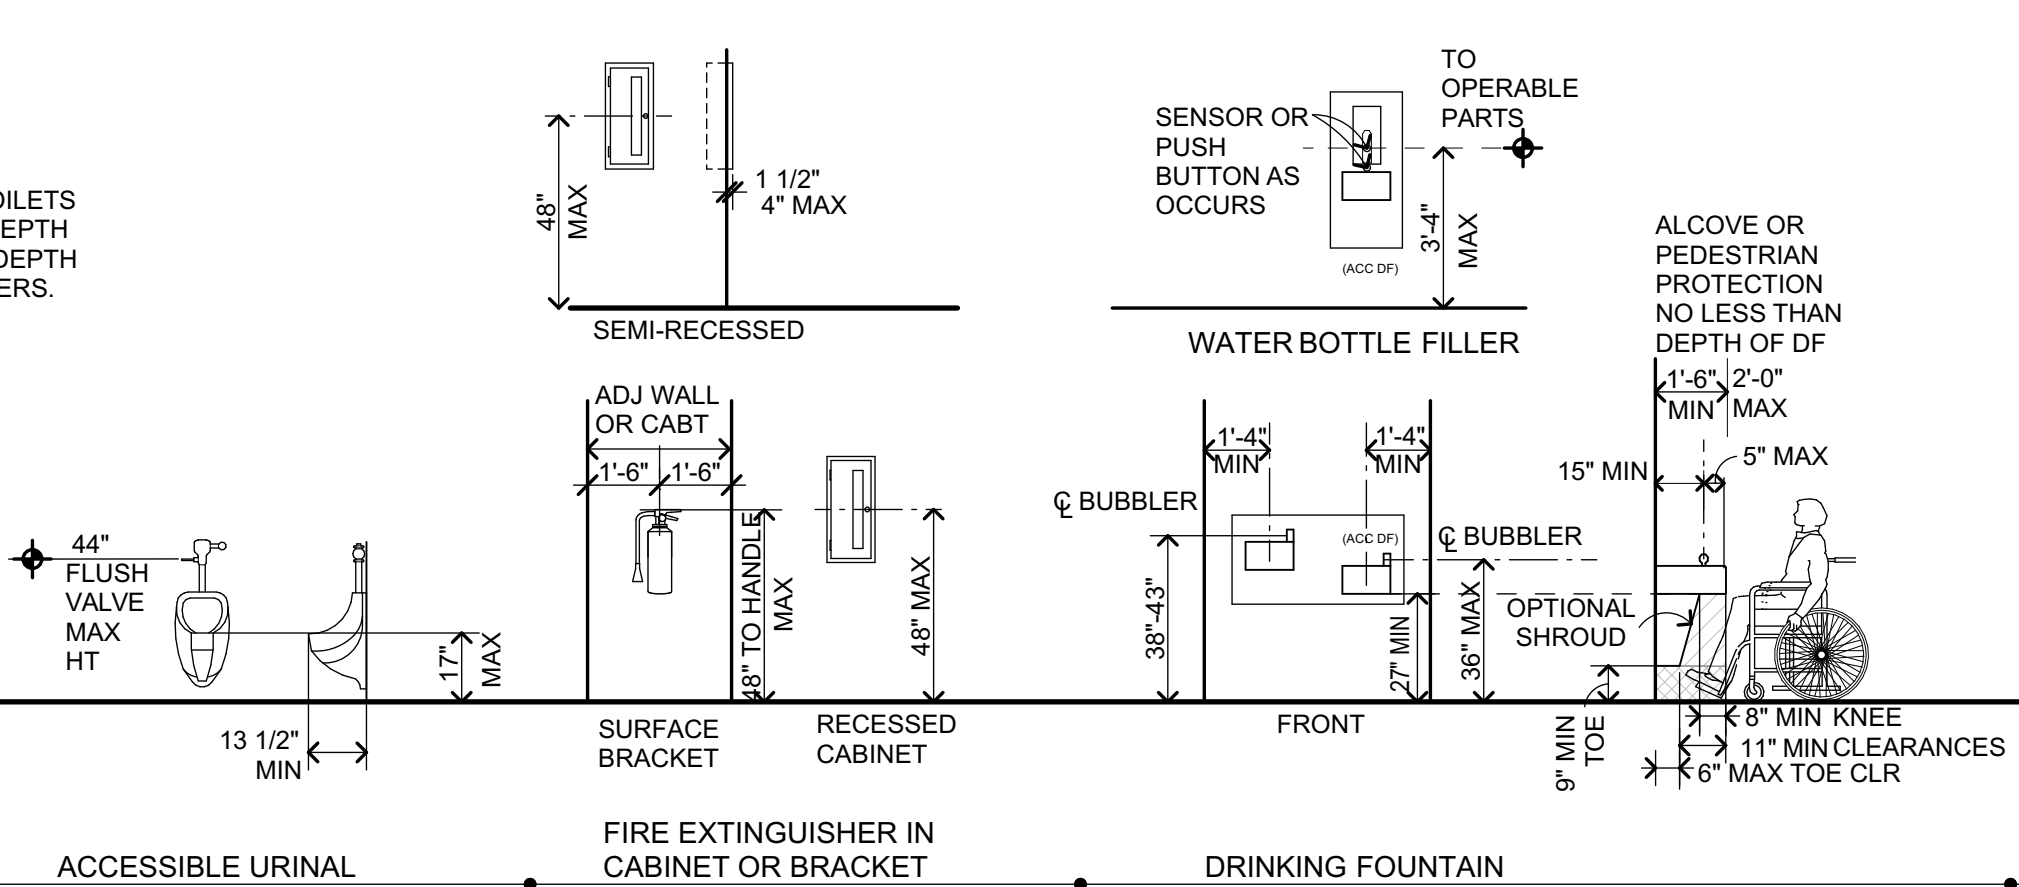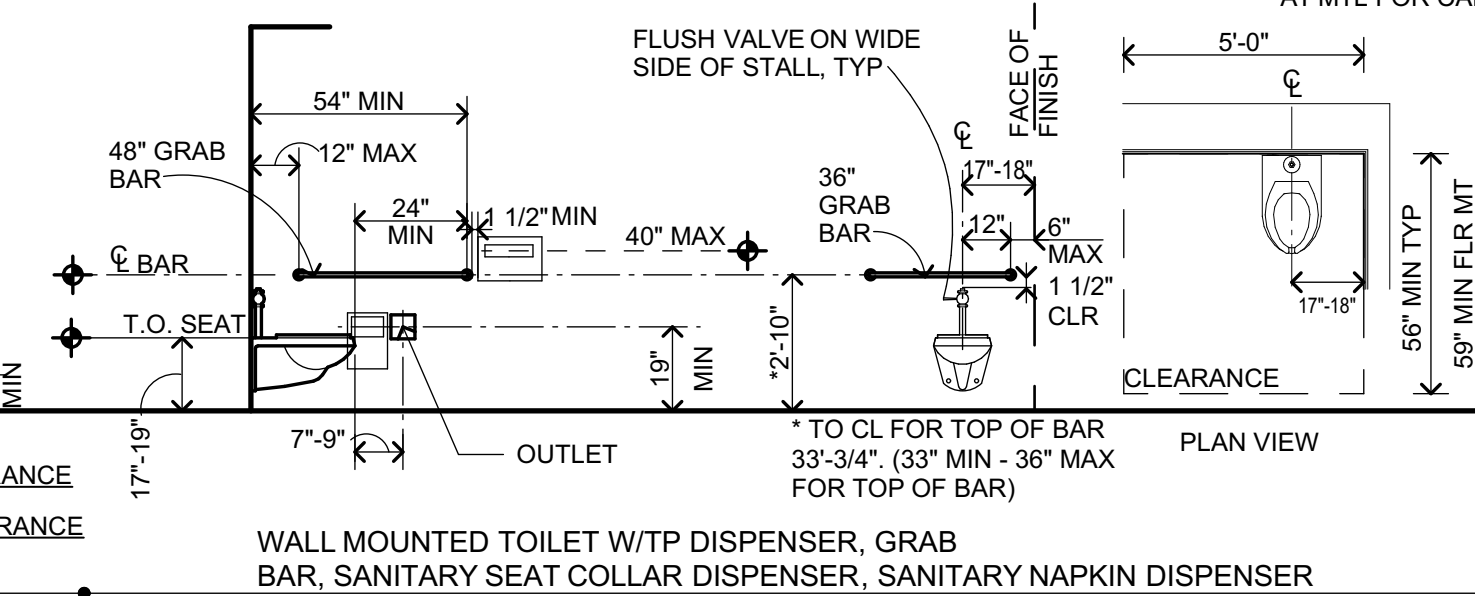

**4**



**Main:**  
636 Fifth Street, Santa Rosa, CA 95404  
**East Bay:**  
55 Harrison Street, Suite 525,  
Oakland, CA 94607  
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**FREEDOM  
HIGH SCHOOL**

**NEW AUXILIARY  
GYMNASIUM**

1050 NEROLY RD,  
OAKLEY, CA 94561

**LIBERTY UNION  
HIGH SCHOOL  
DISTRICT**

DSA APP NO. 01-119278

ARCH PROJECT NO: 1869.00  
DRAWN BY: PAG  
DRAWING SCALE: AS NOTED  
PTN: 61721-78 FILE NO: 7-H4

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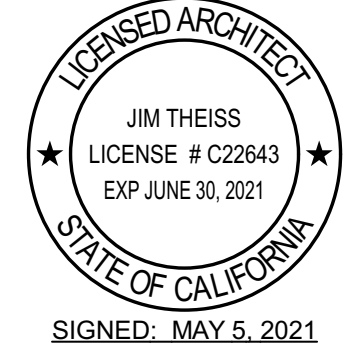
**APRIL 27, 2021**  
SHEET TITLE

**INTERIOR  
DETAILS**

SHEET NUMBER

**A-10.3**





## NEW AUXILIARY GYMNASIUM

1050 NEROLY RD,  
OAKLEY, CA 94561

LIBERTY UNION  
HIGH SCHOOL  
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SHEET TITLE

## INTERIOR DETAILS

SHEET NUMBER

## A-10.4

























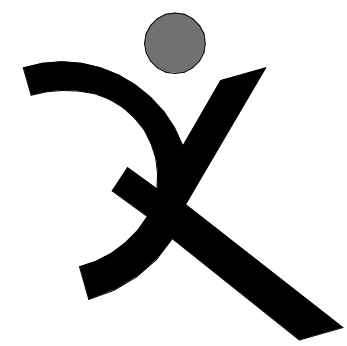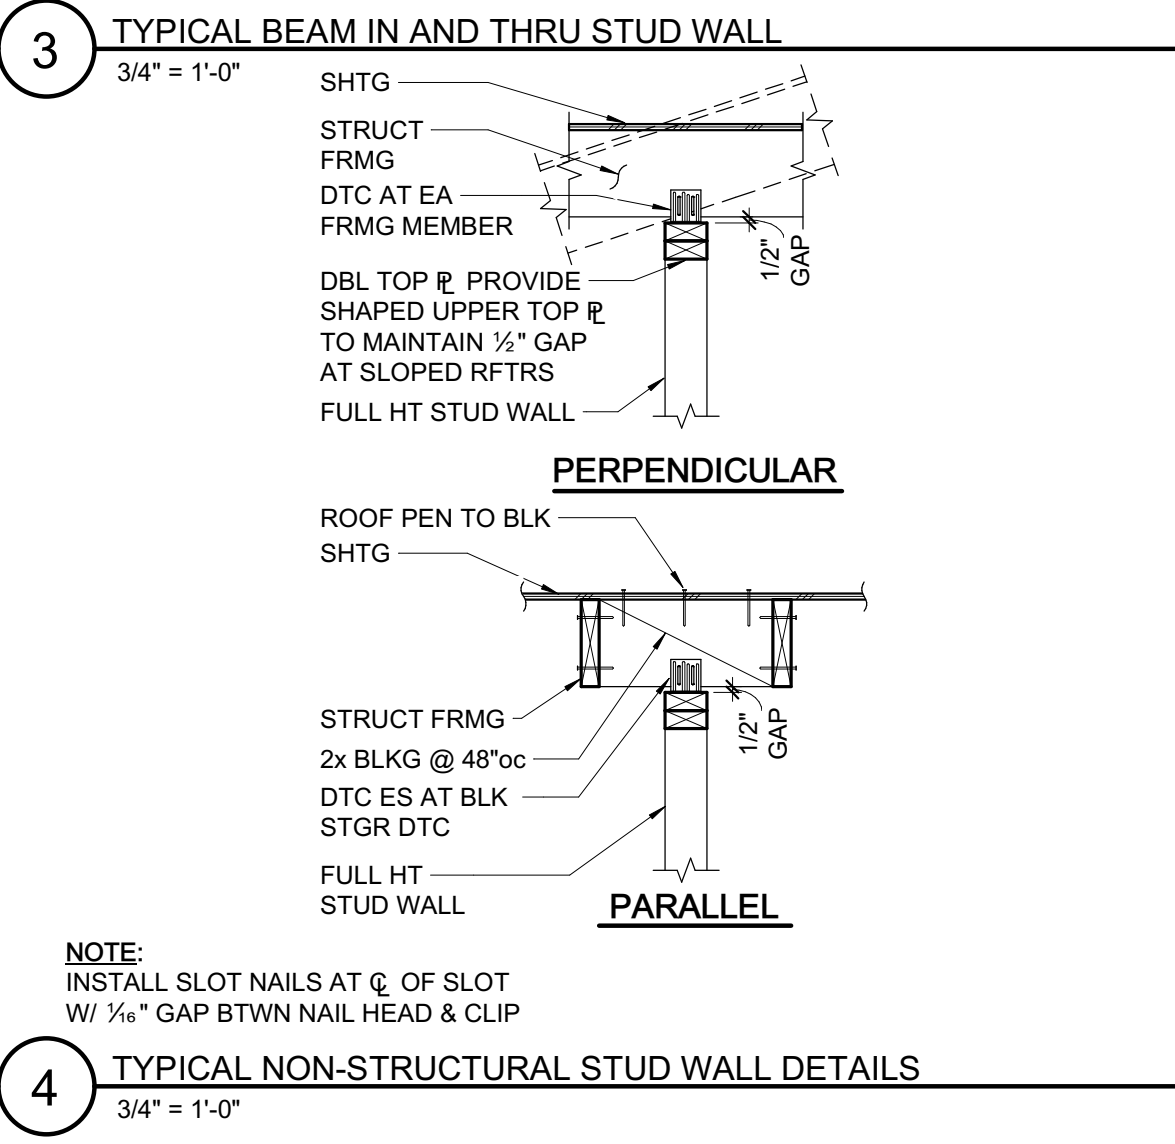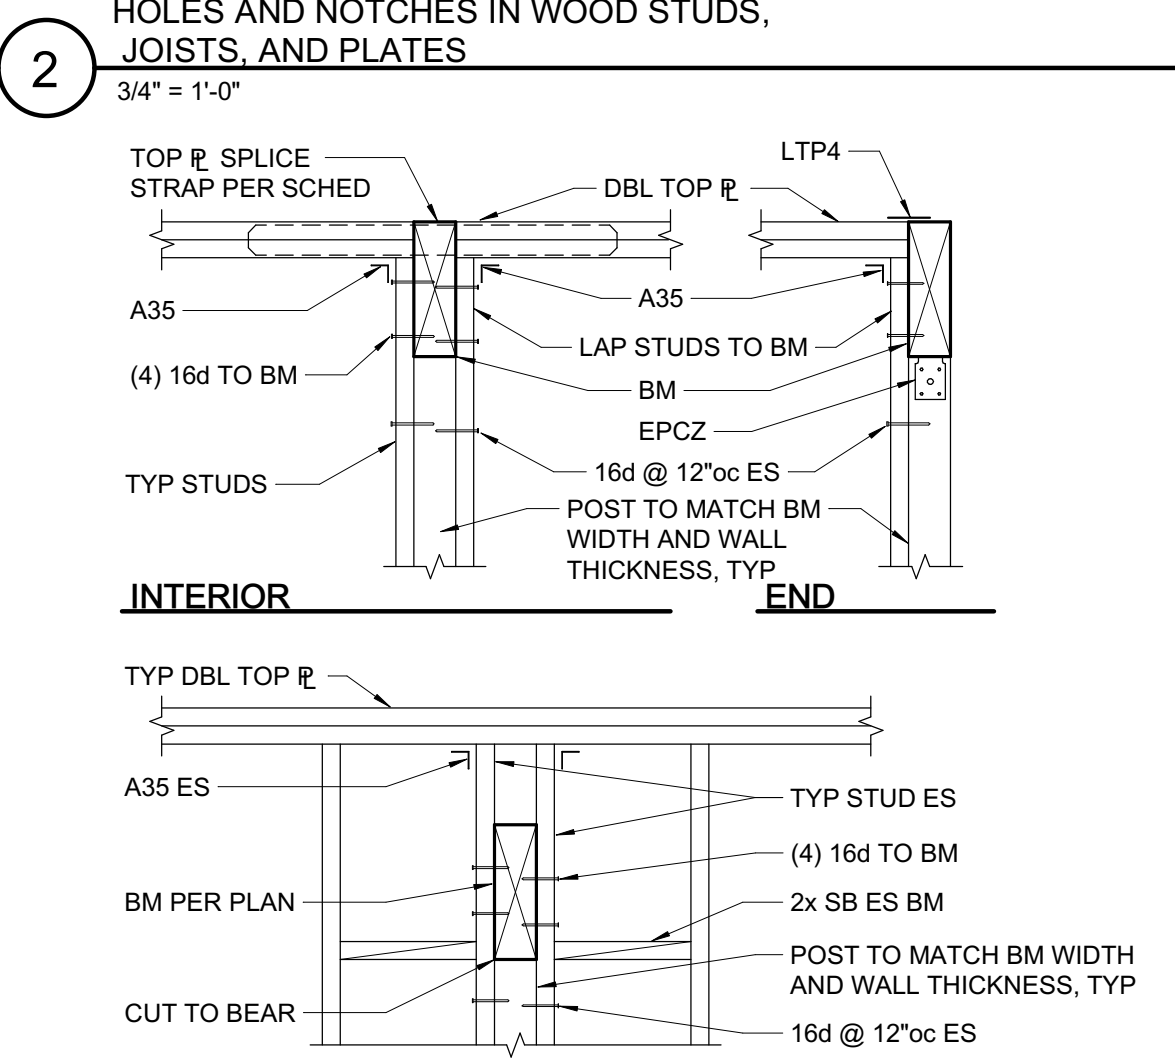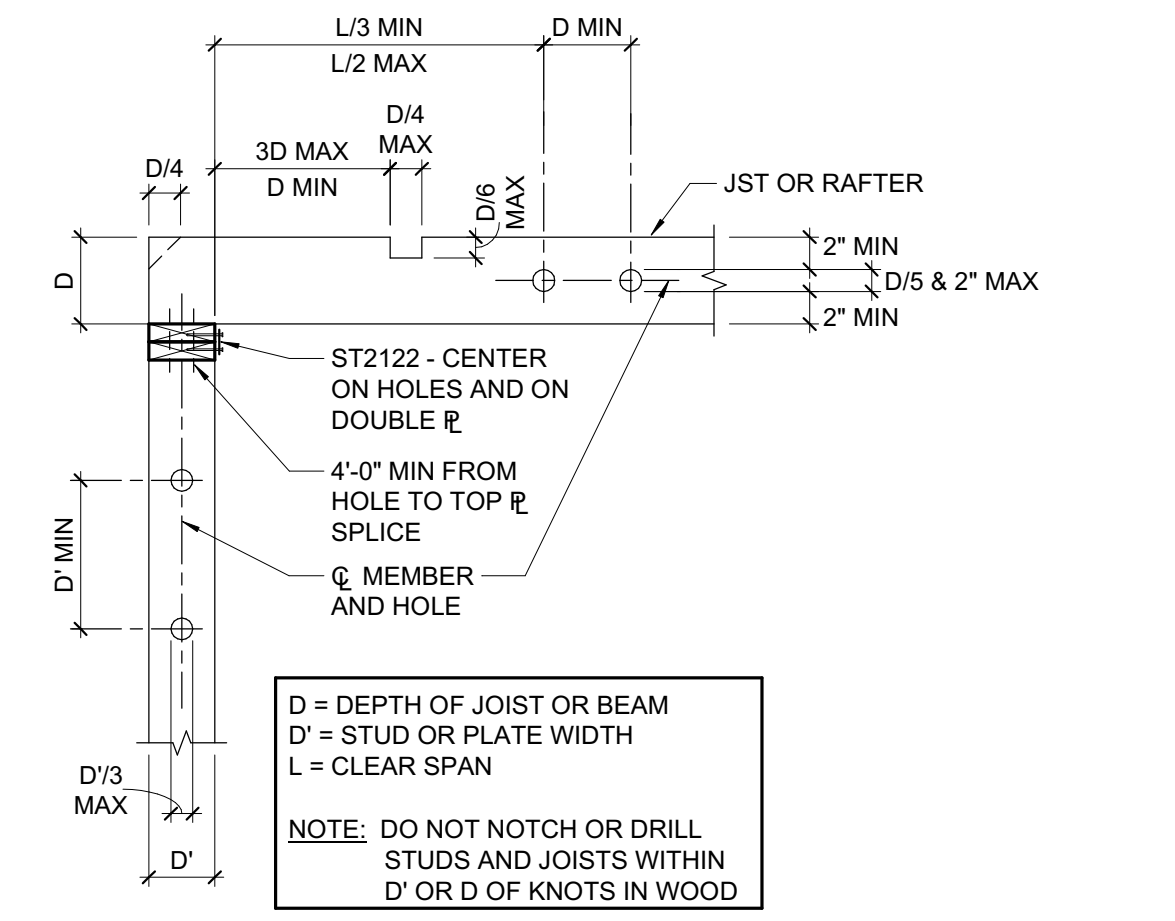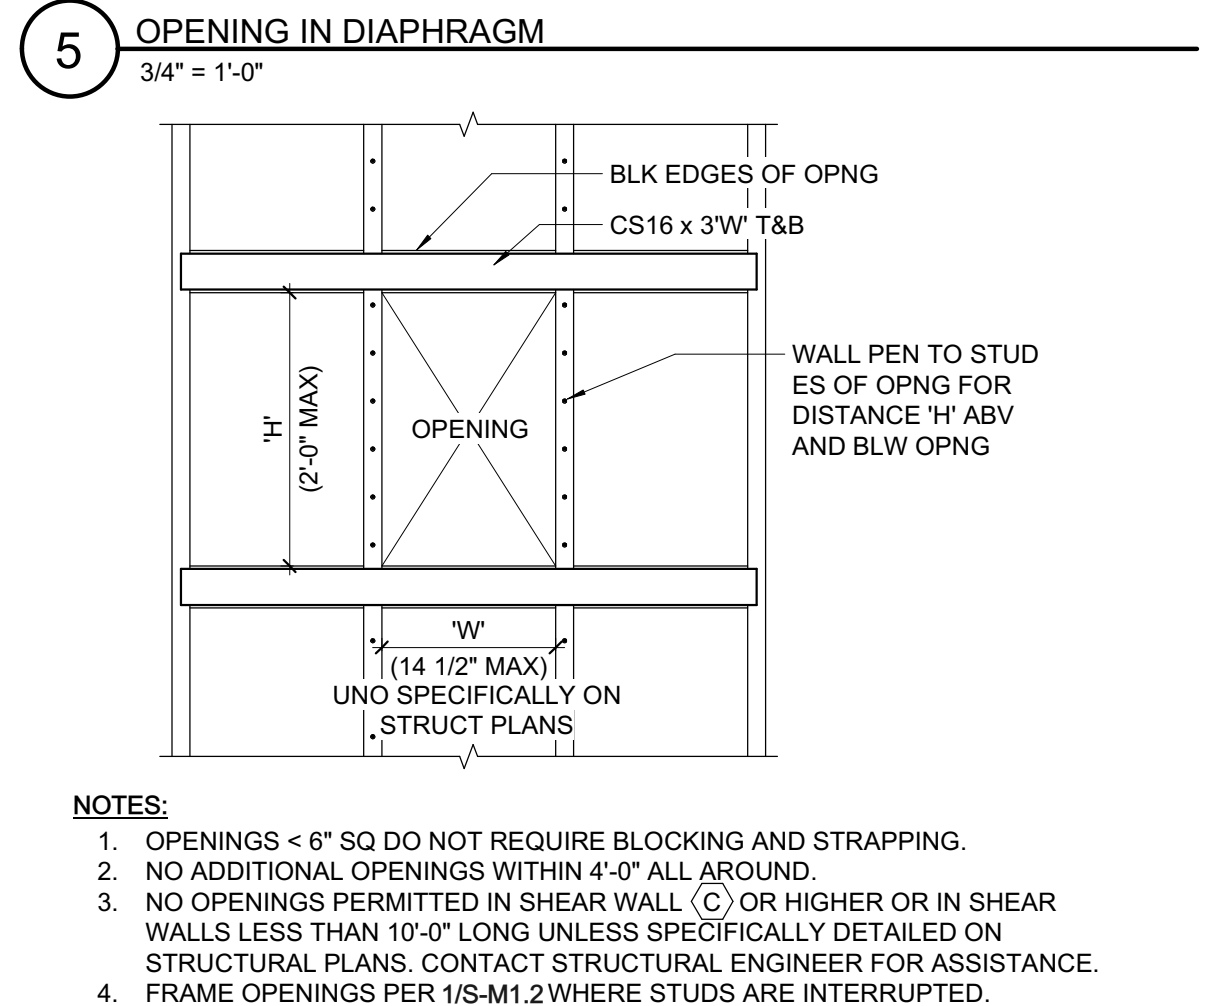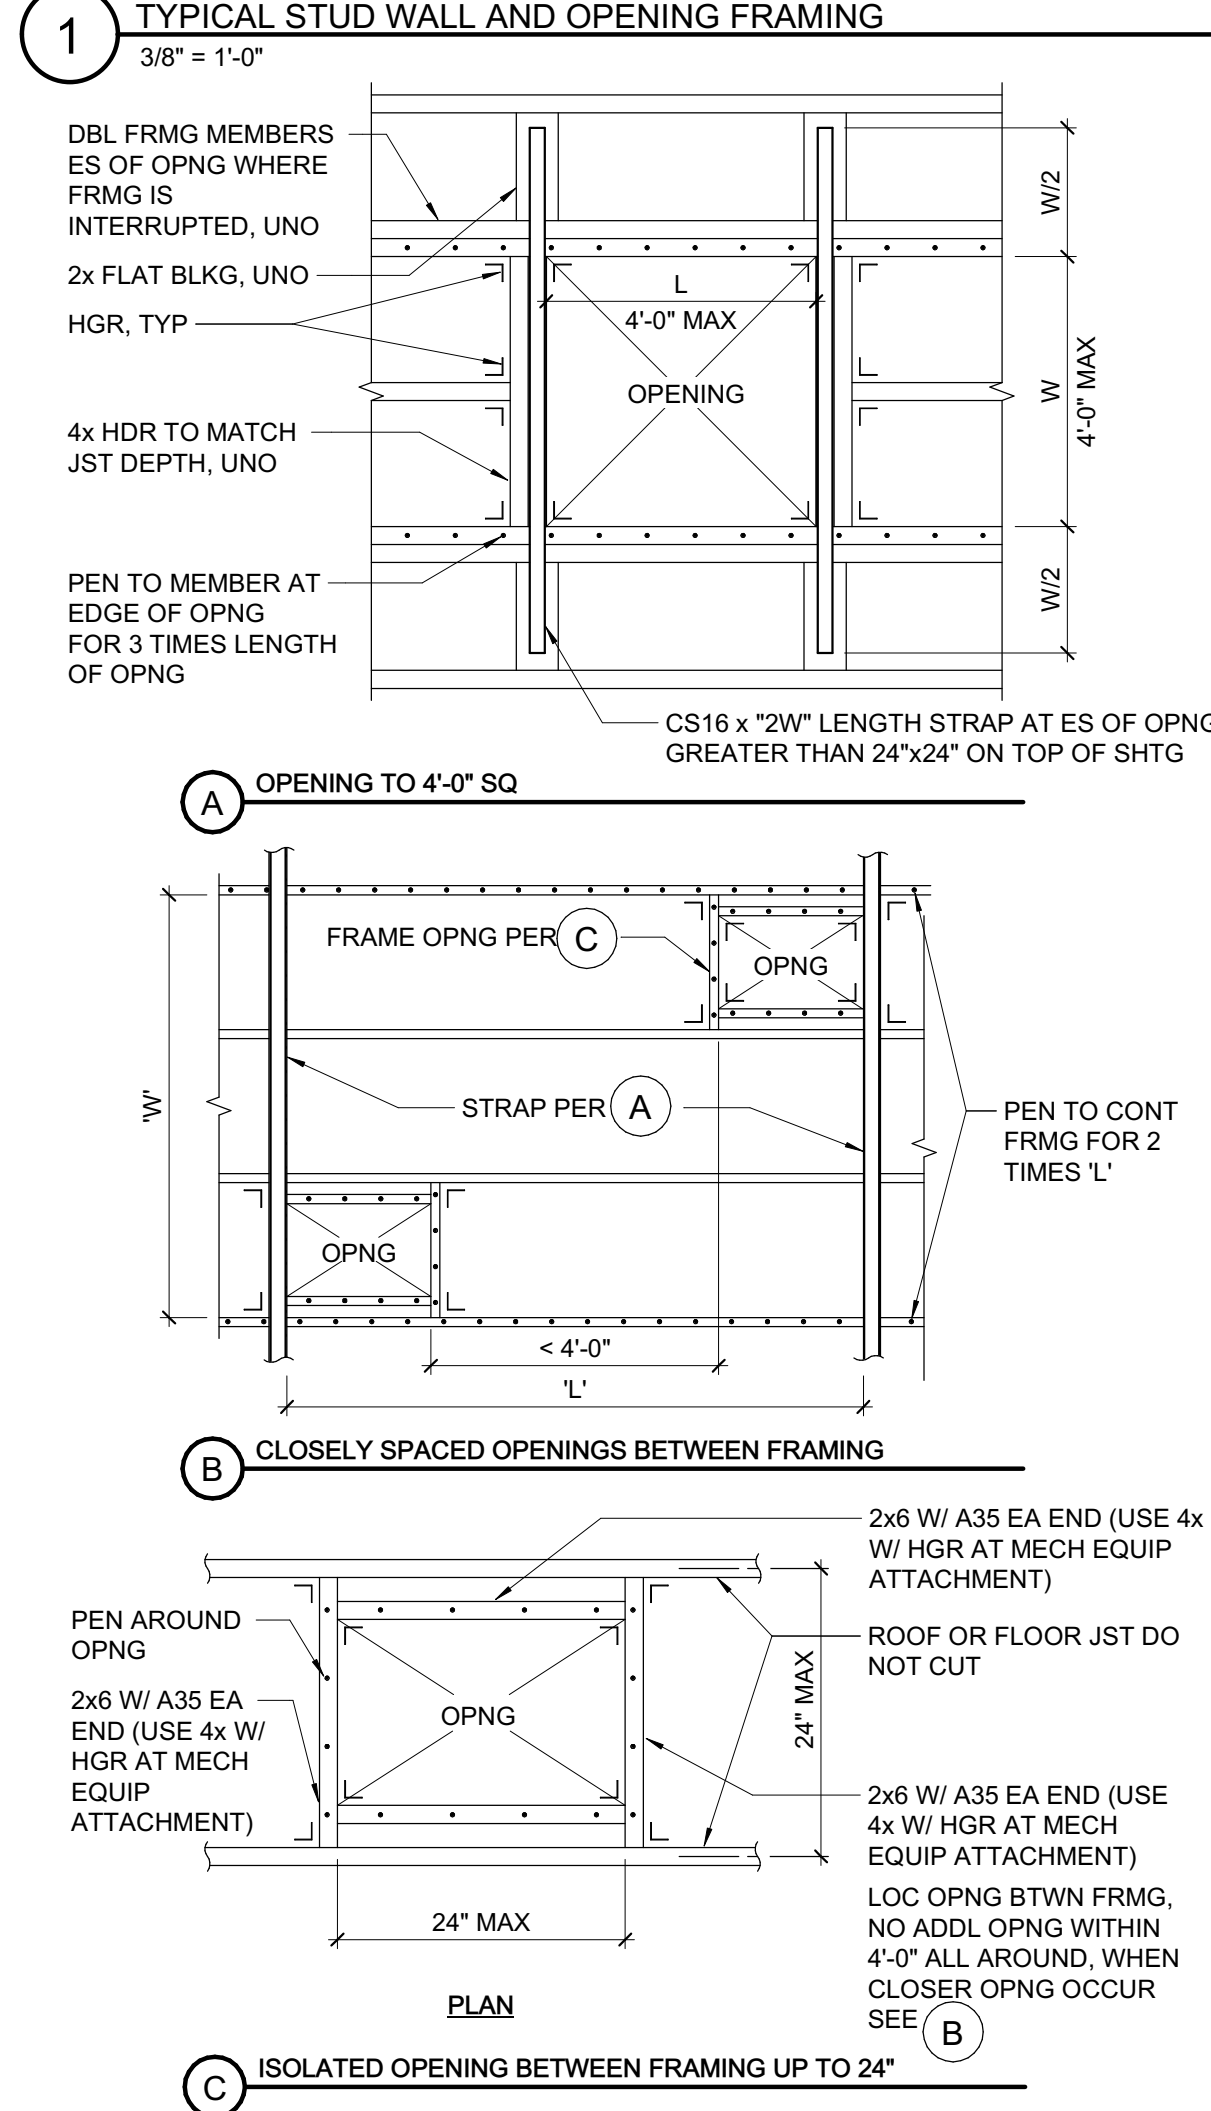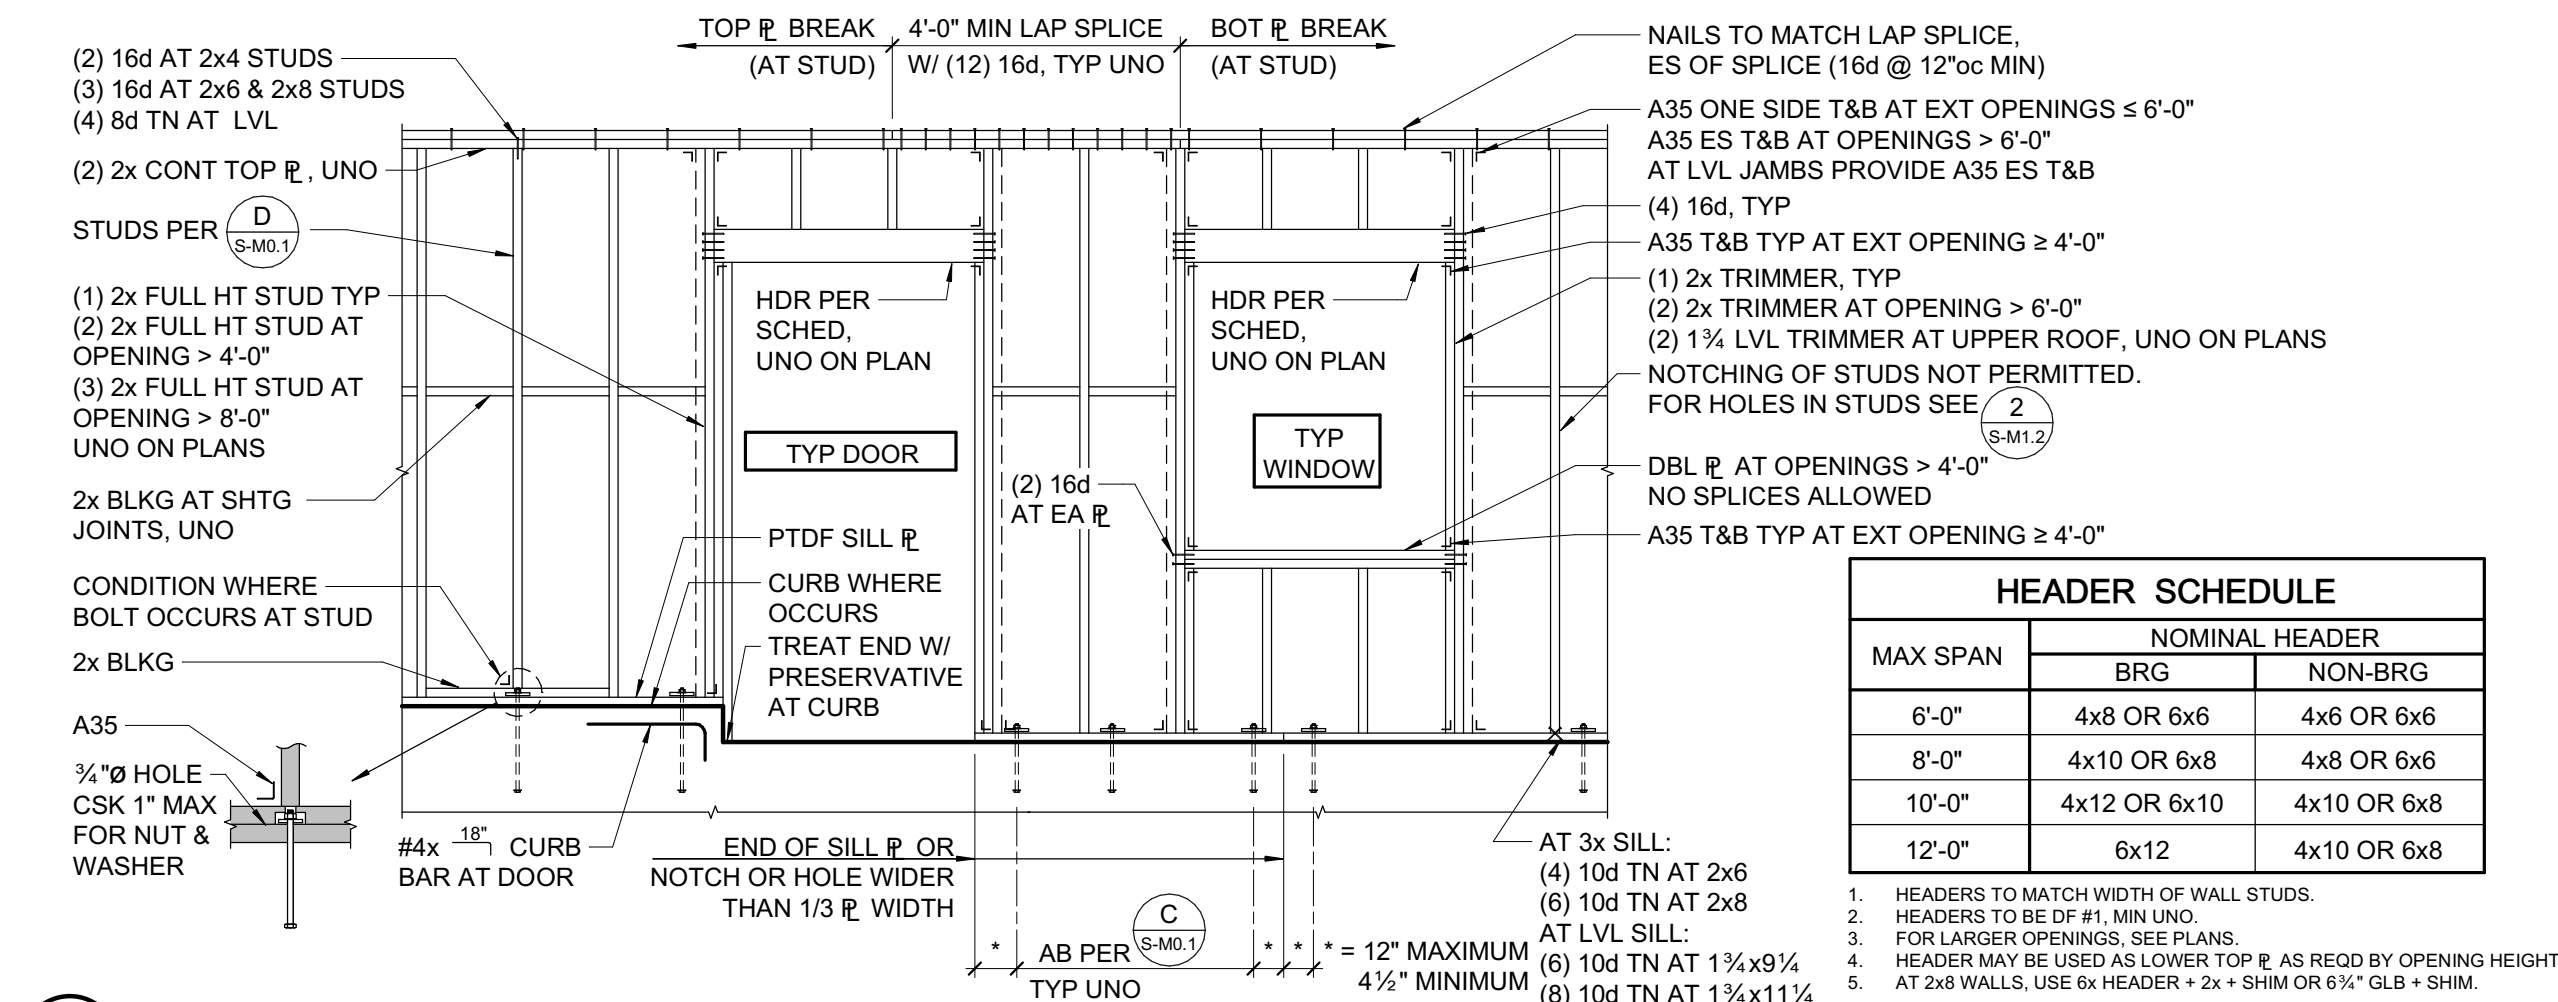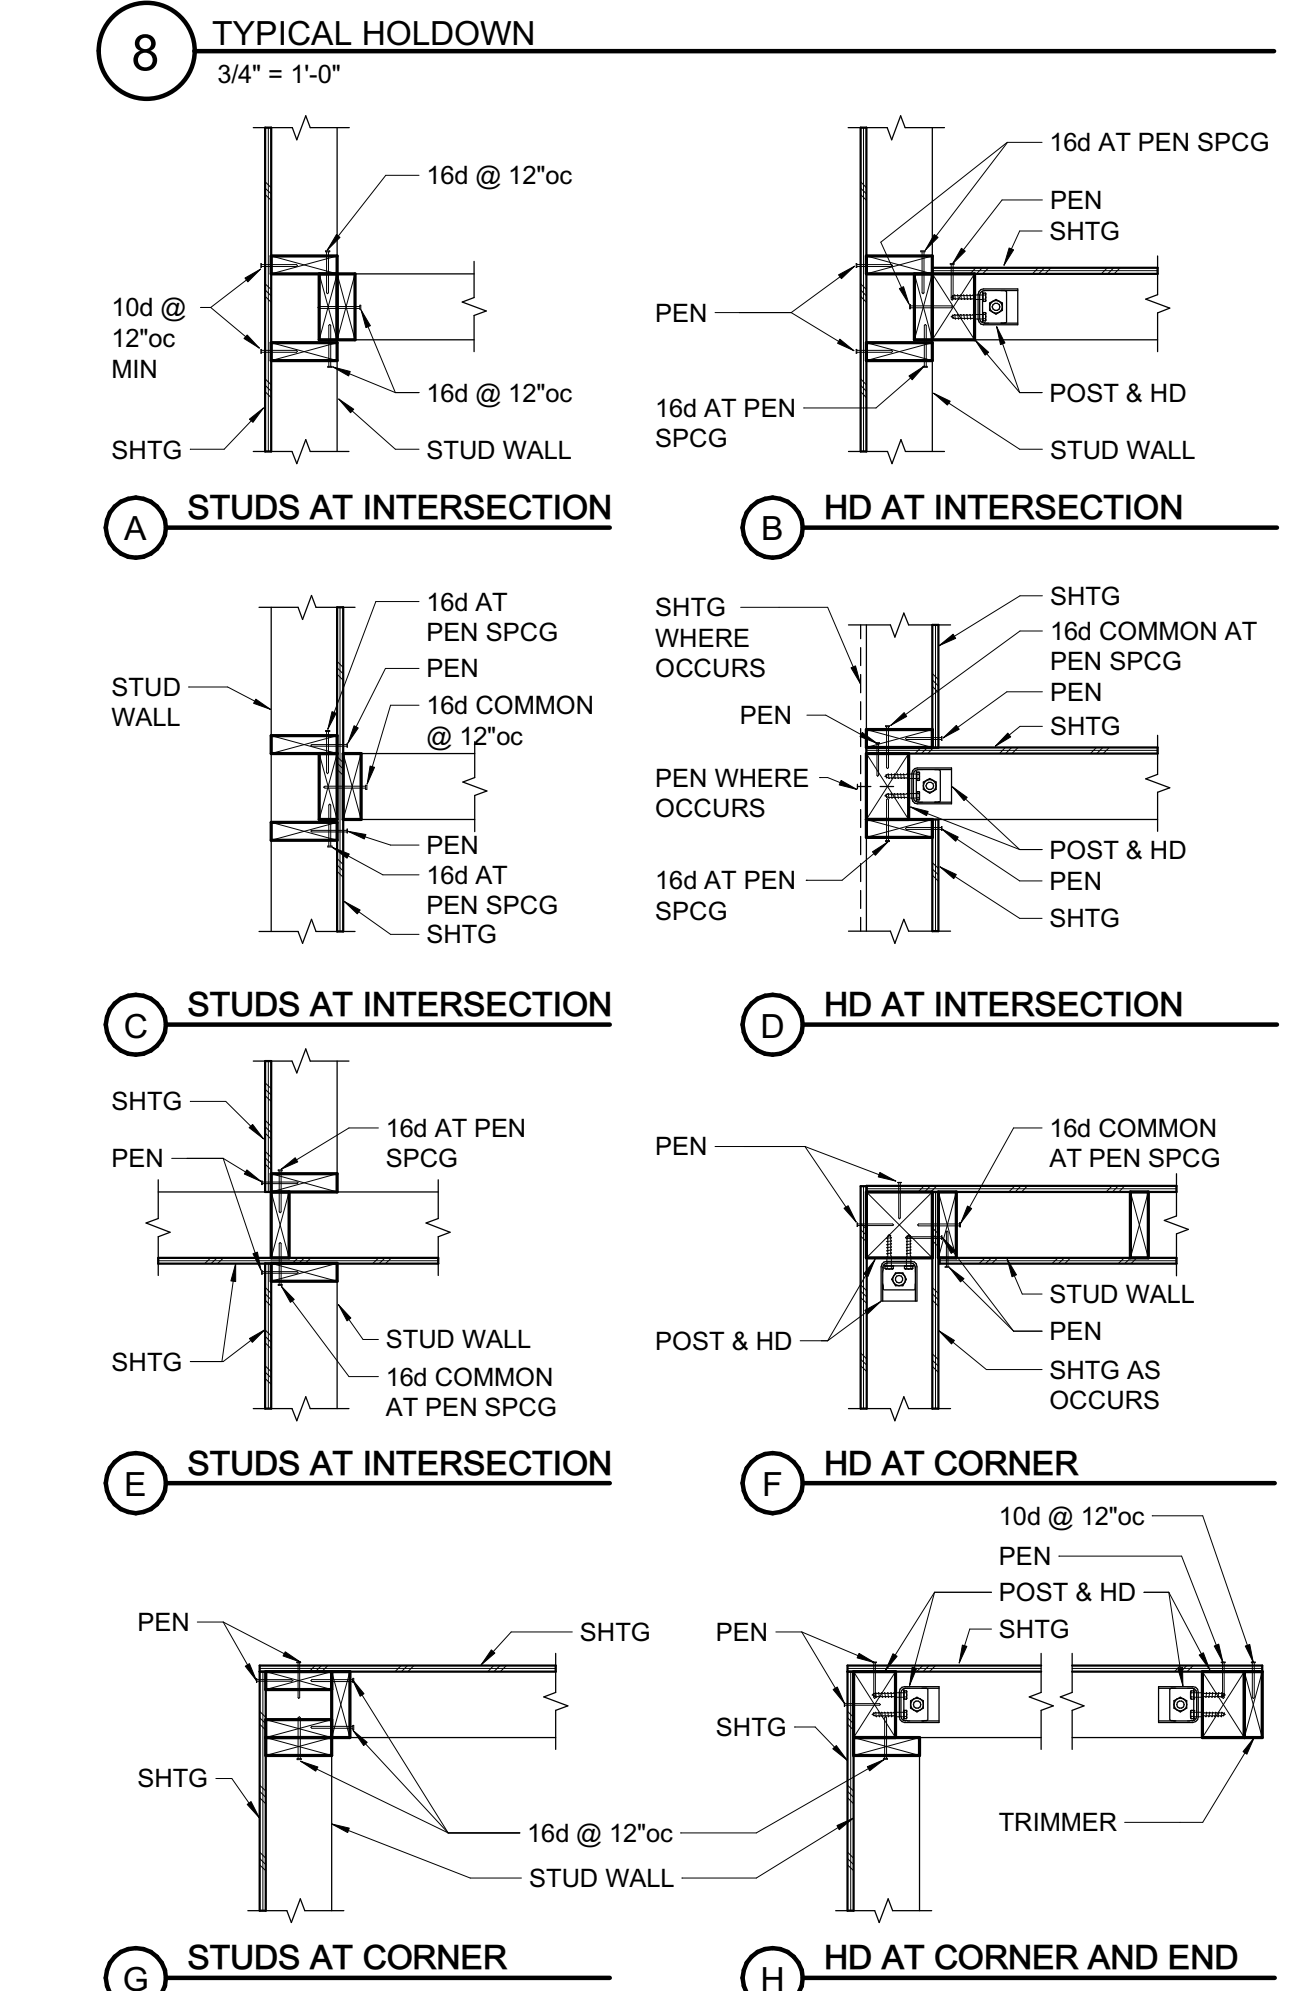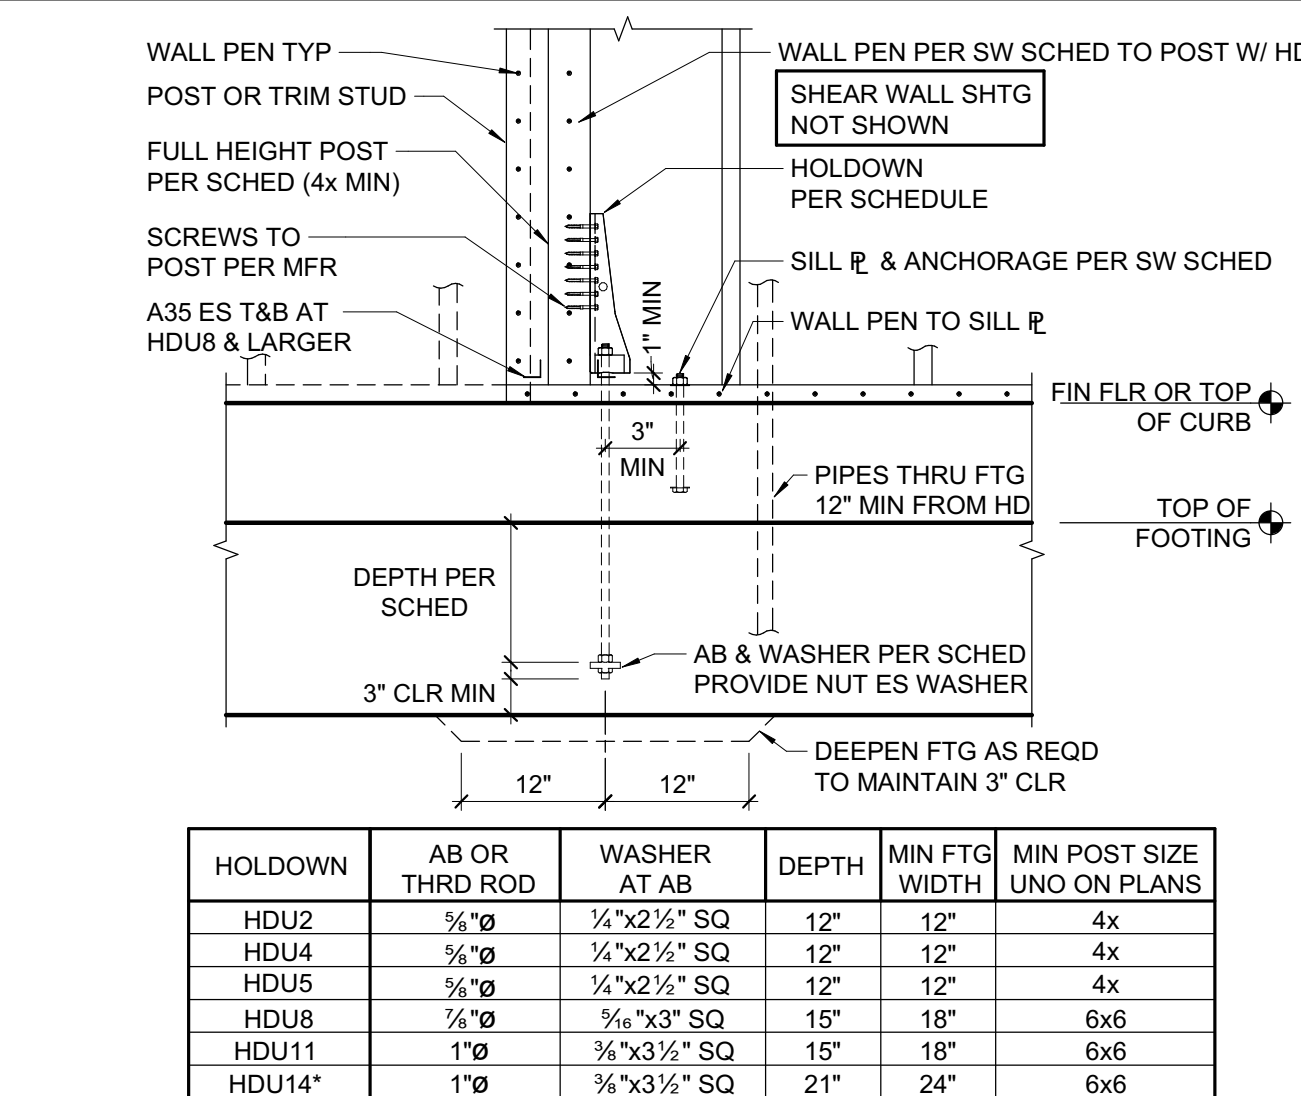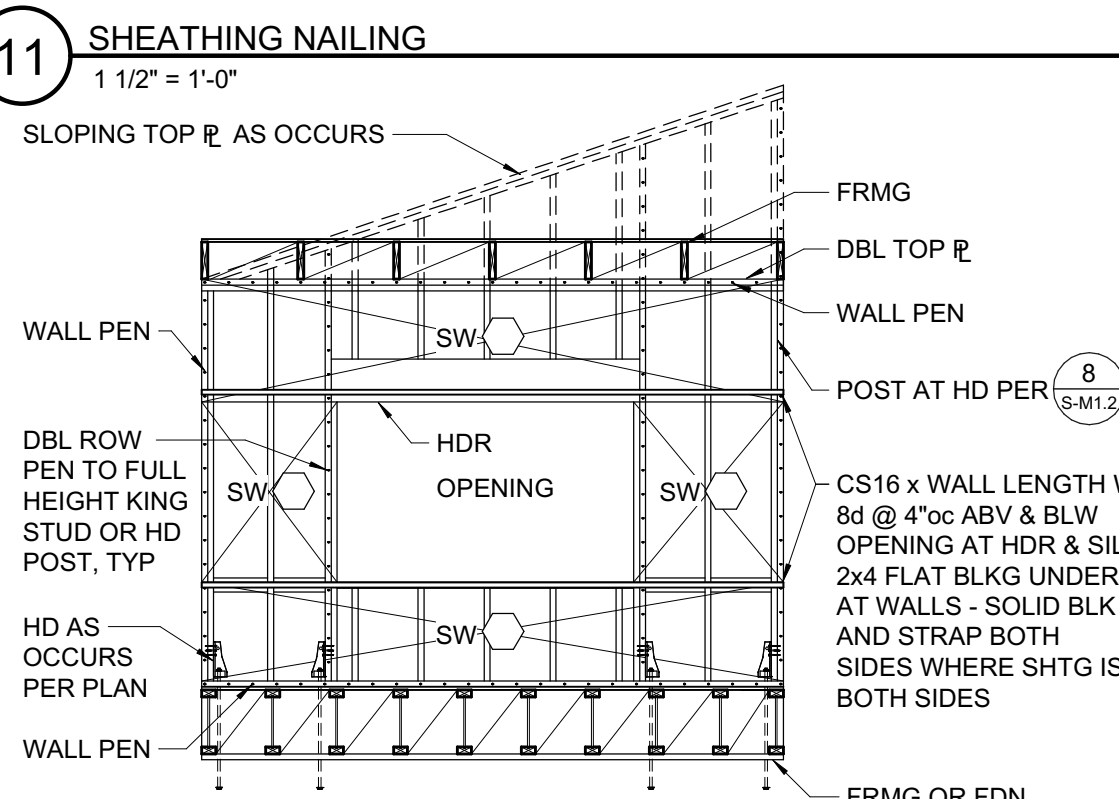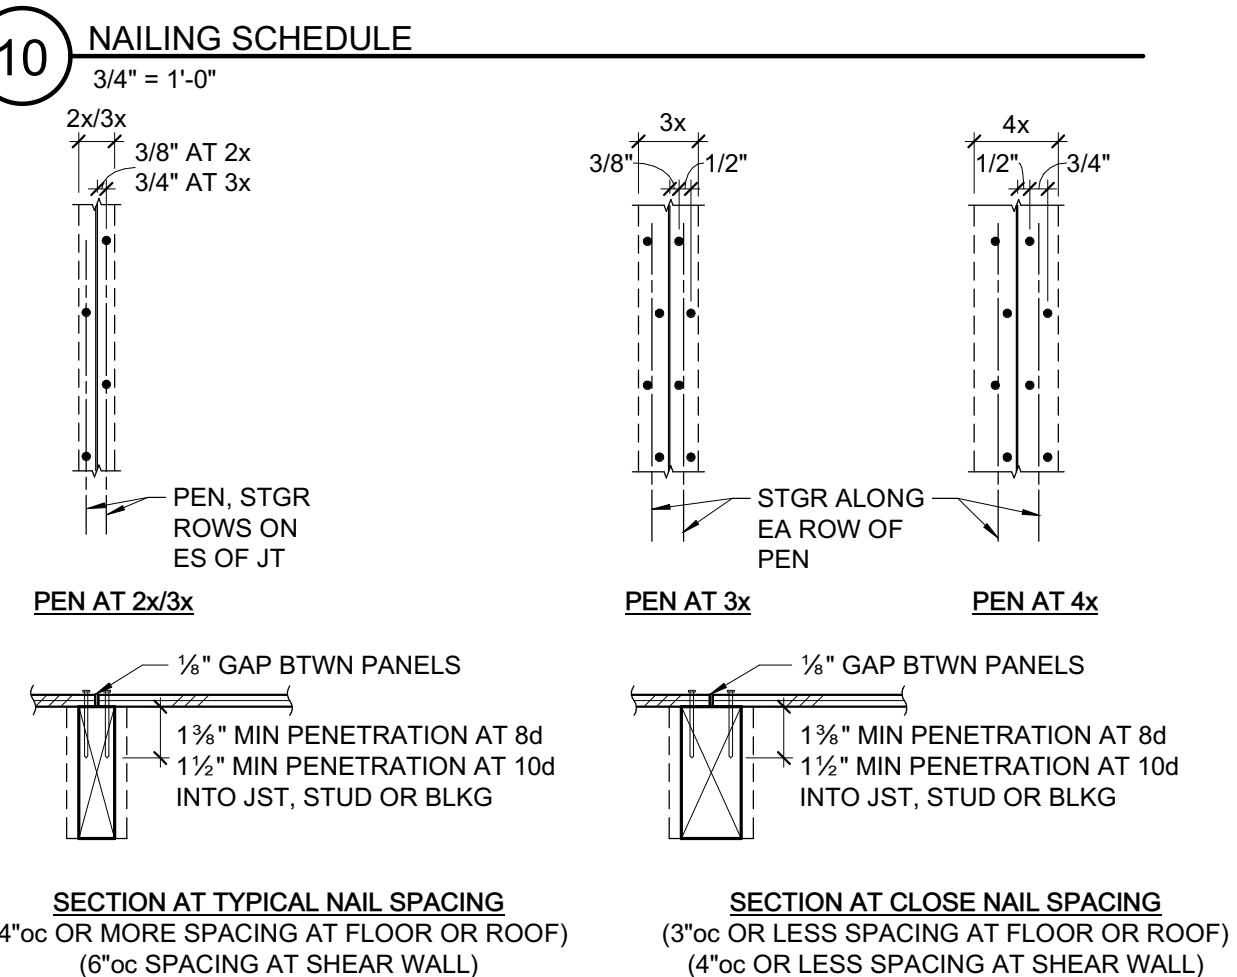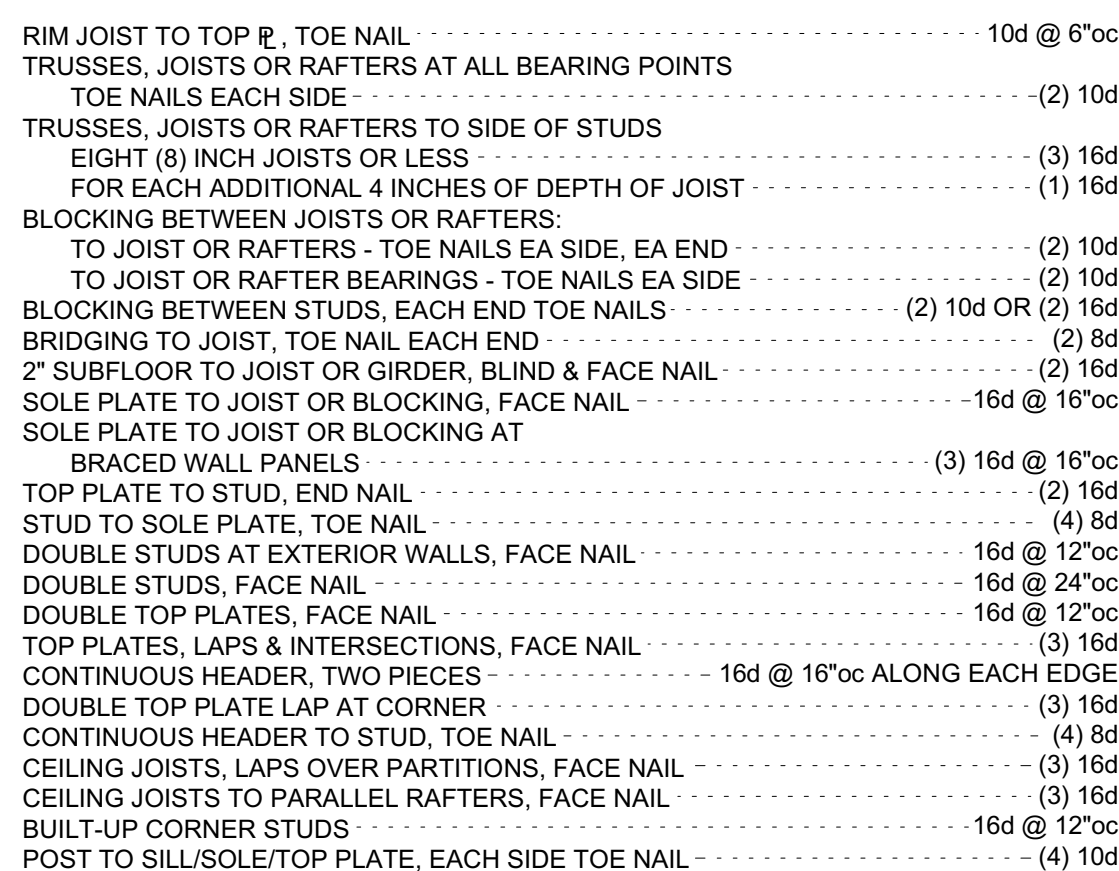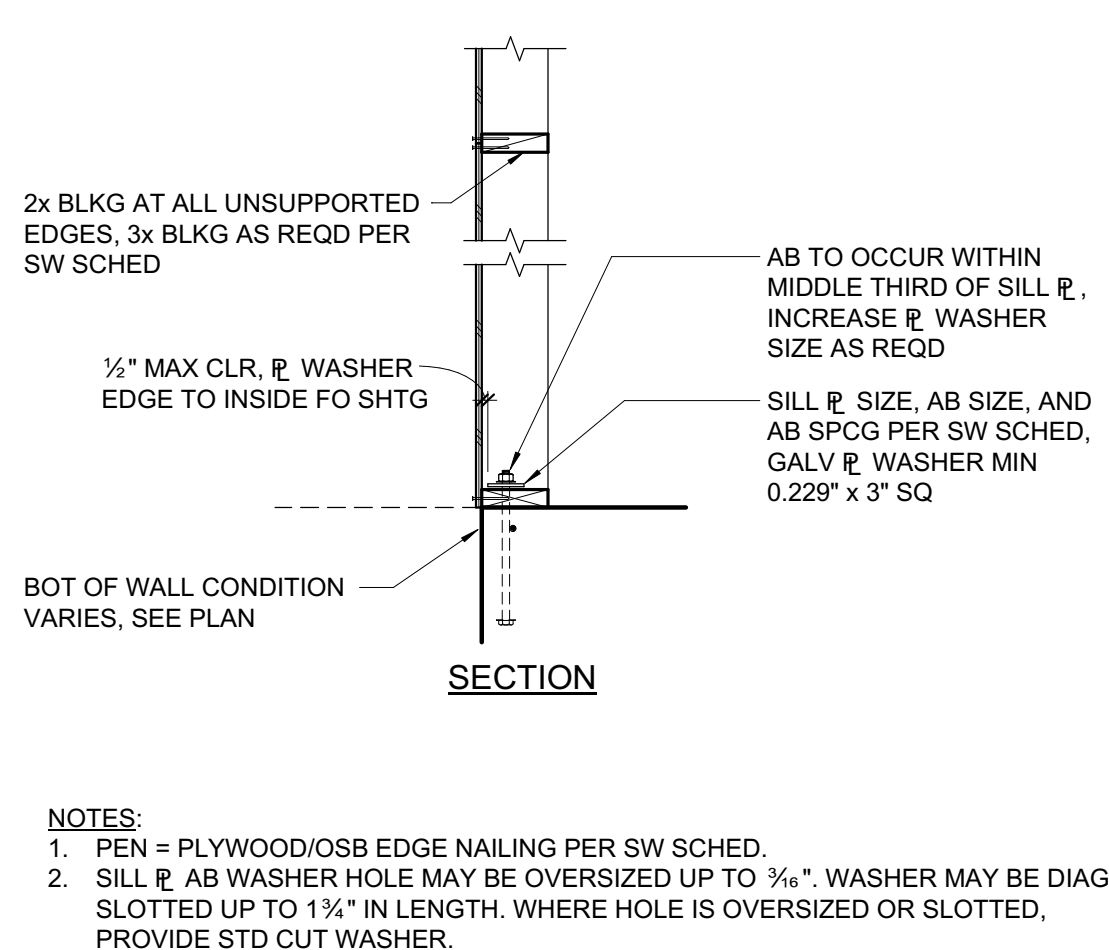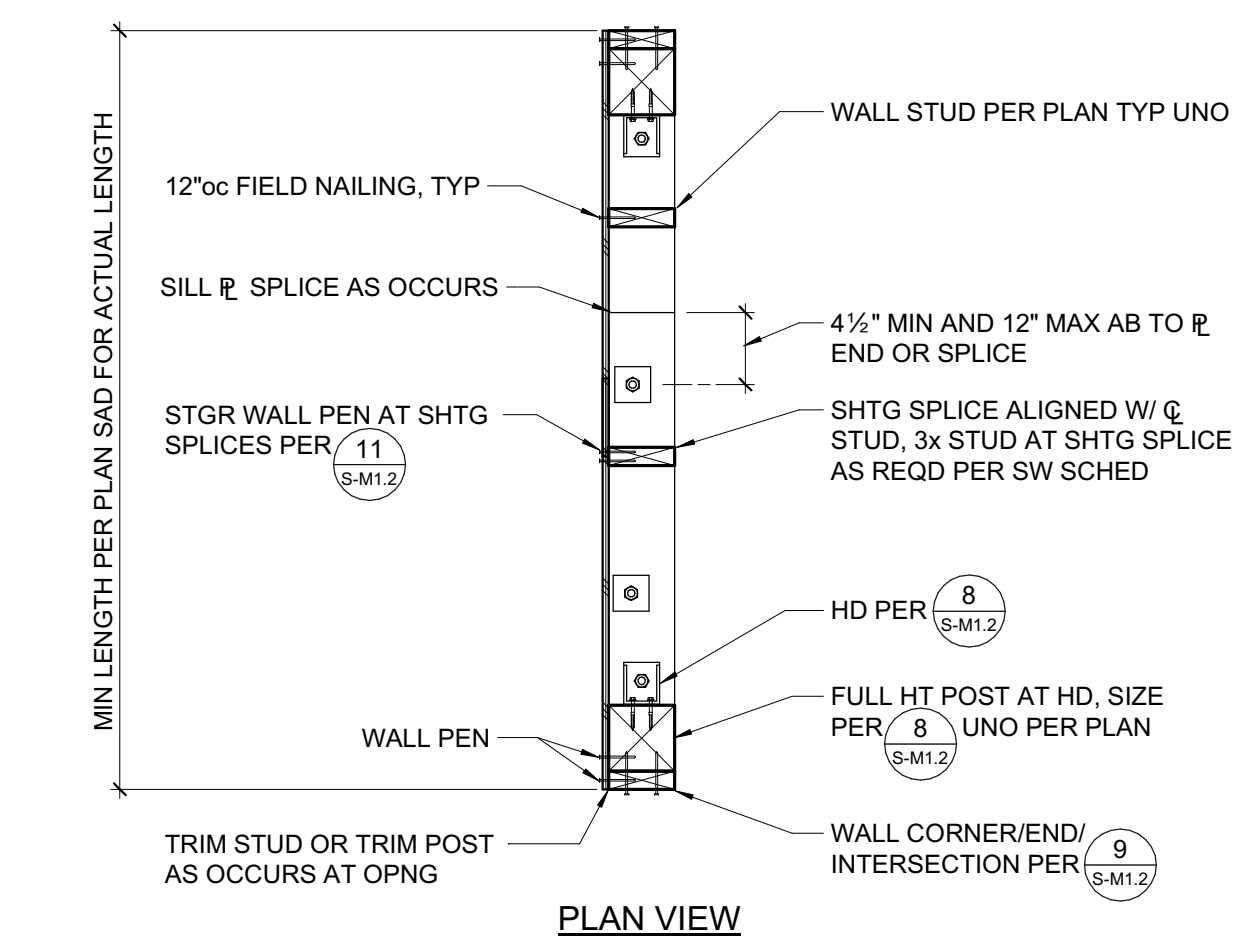

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636 Fifth Street, Santa Rosa, CA 95401  
East Bay:  
55 Harrison Street, Suite 525  
Oakland, CA 94607  
(707) 576-0829

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# FREEDOM HIGH SCHOOL

## NEW AUXILIARY GYMNASIUM

1050 NEROLY RD,  
OAKLEY, CA 94561

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SCHOOL DISTRICT[illegible]

DSA APP NO. 01-119278	
ZFA NO:	20315
ENGR / PM:	KNC / DLD
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PTN: 61721-78	FILE NO: 7-H4

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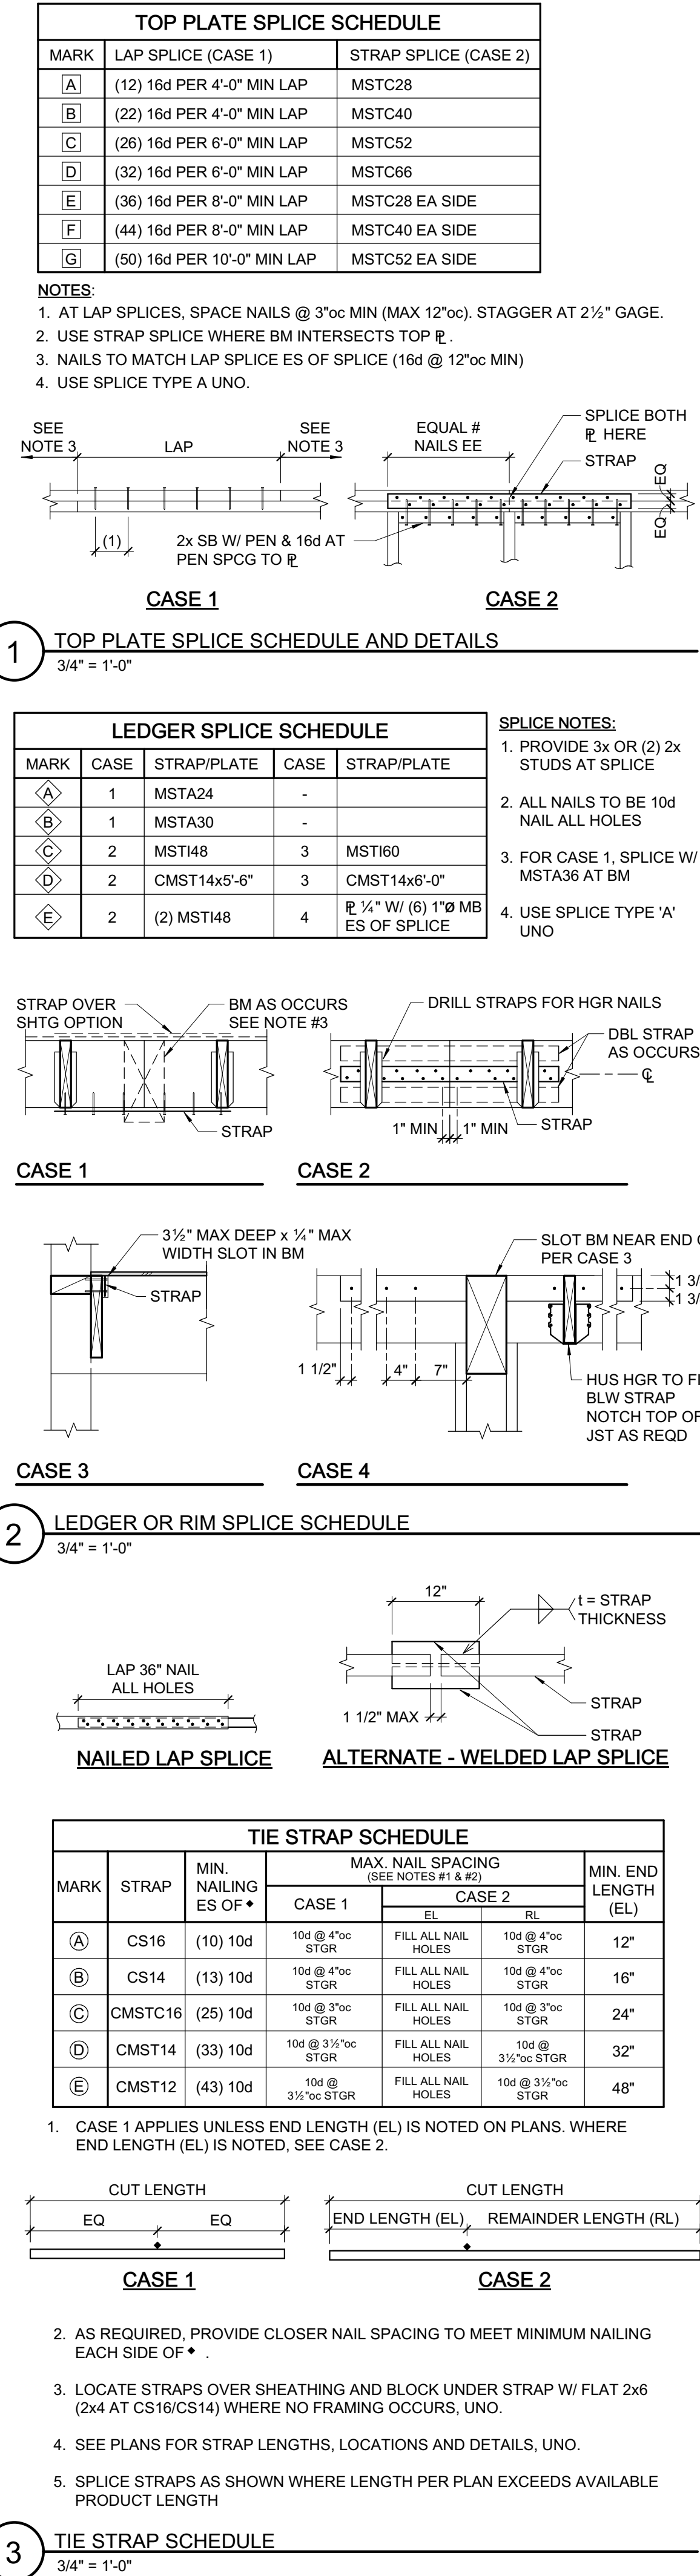
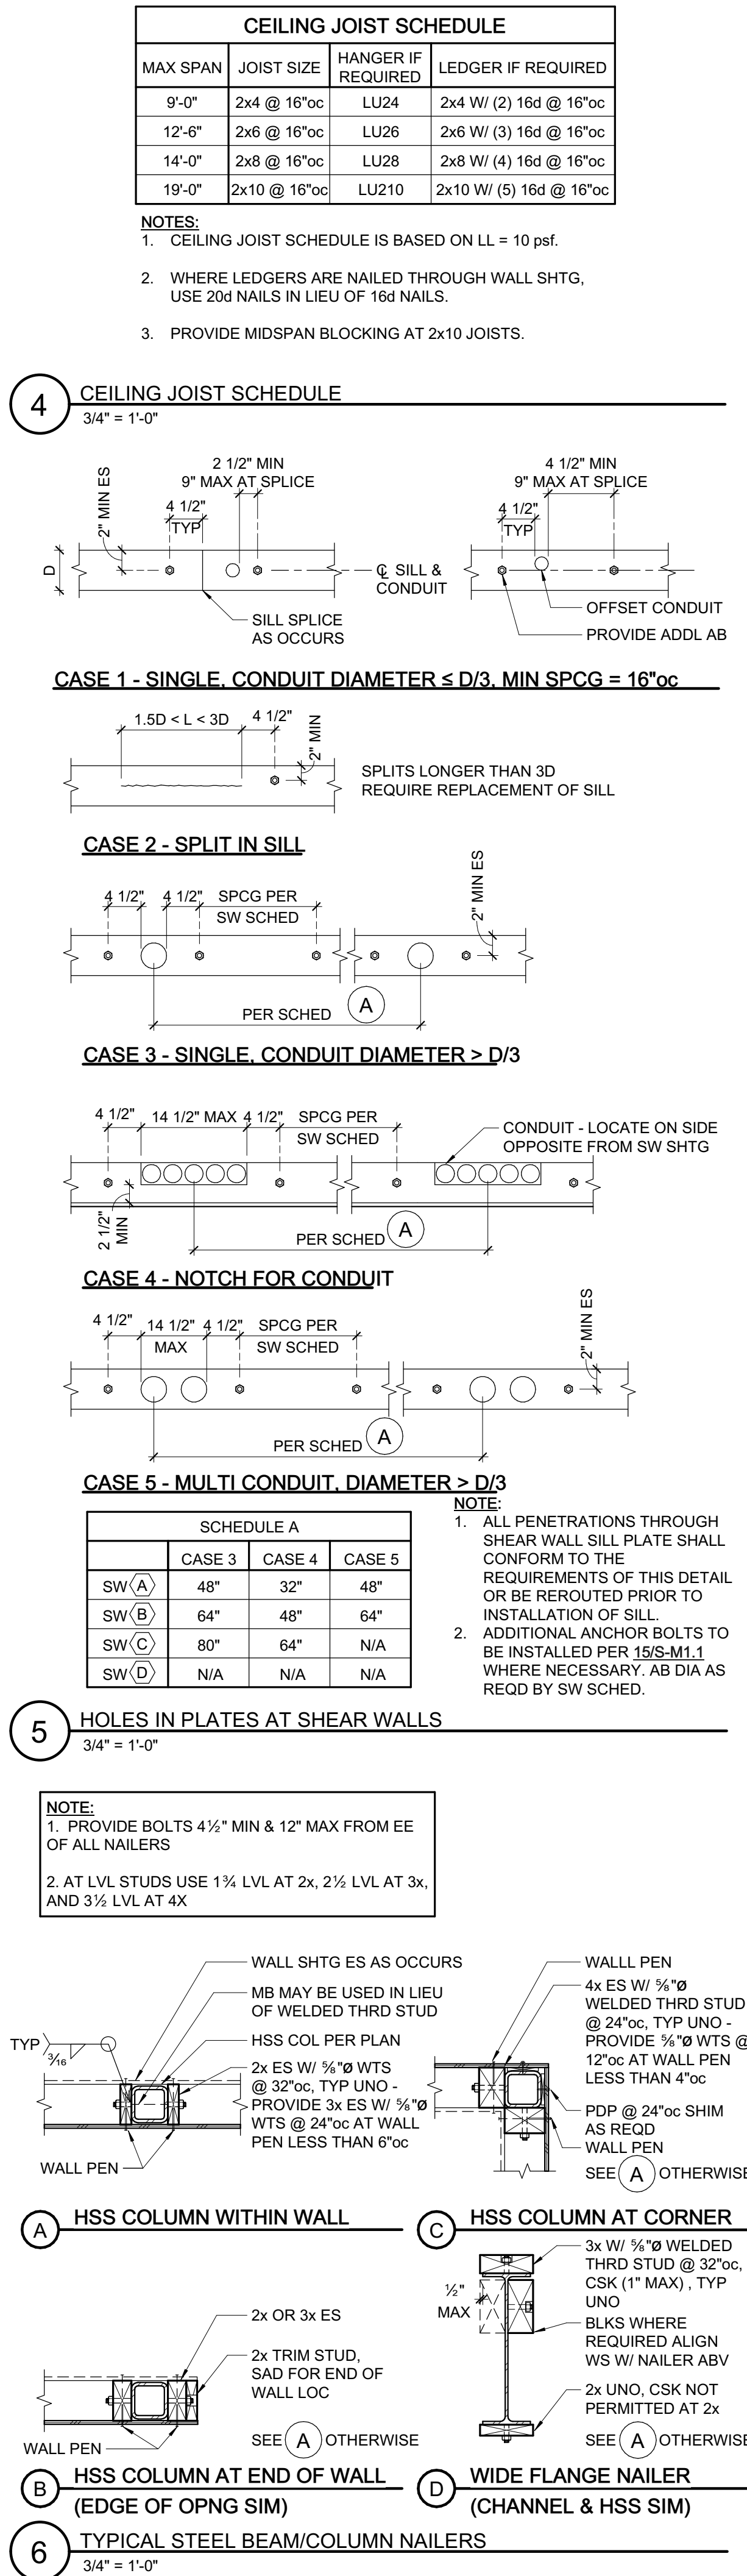
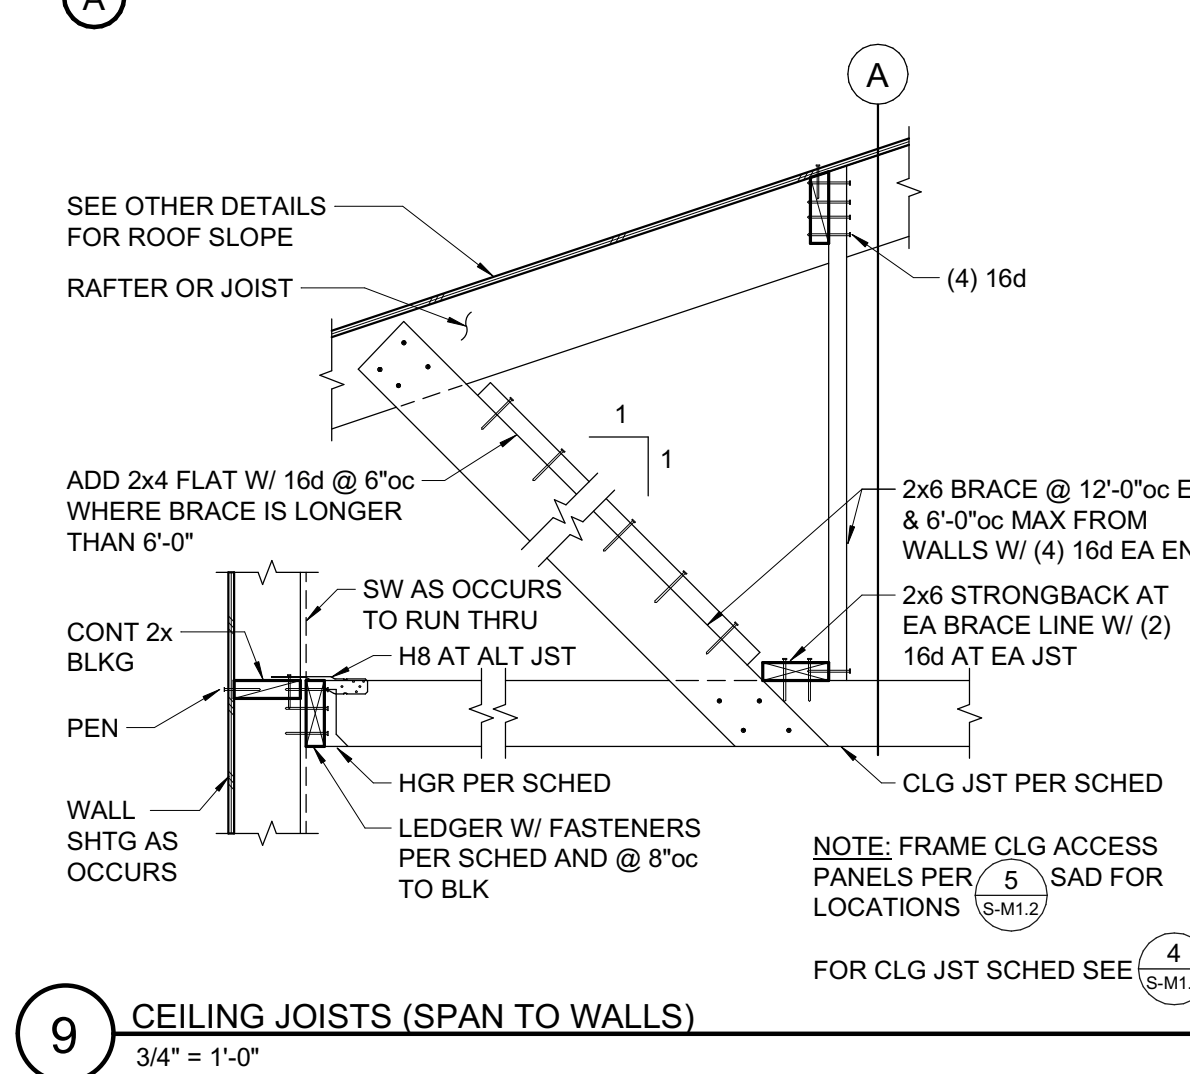
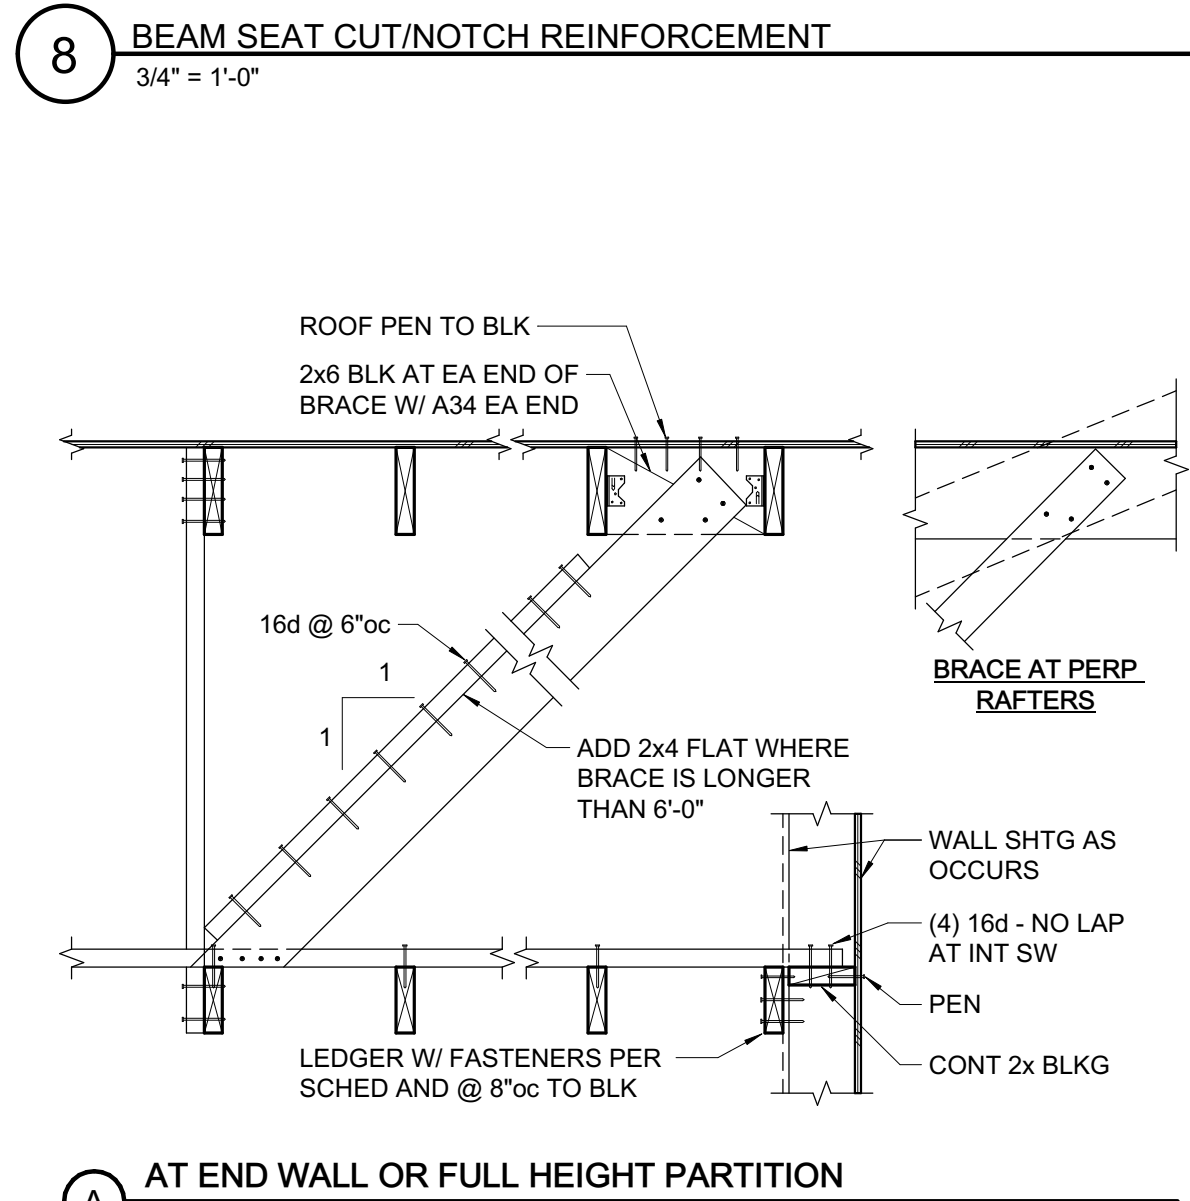
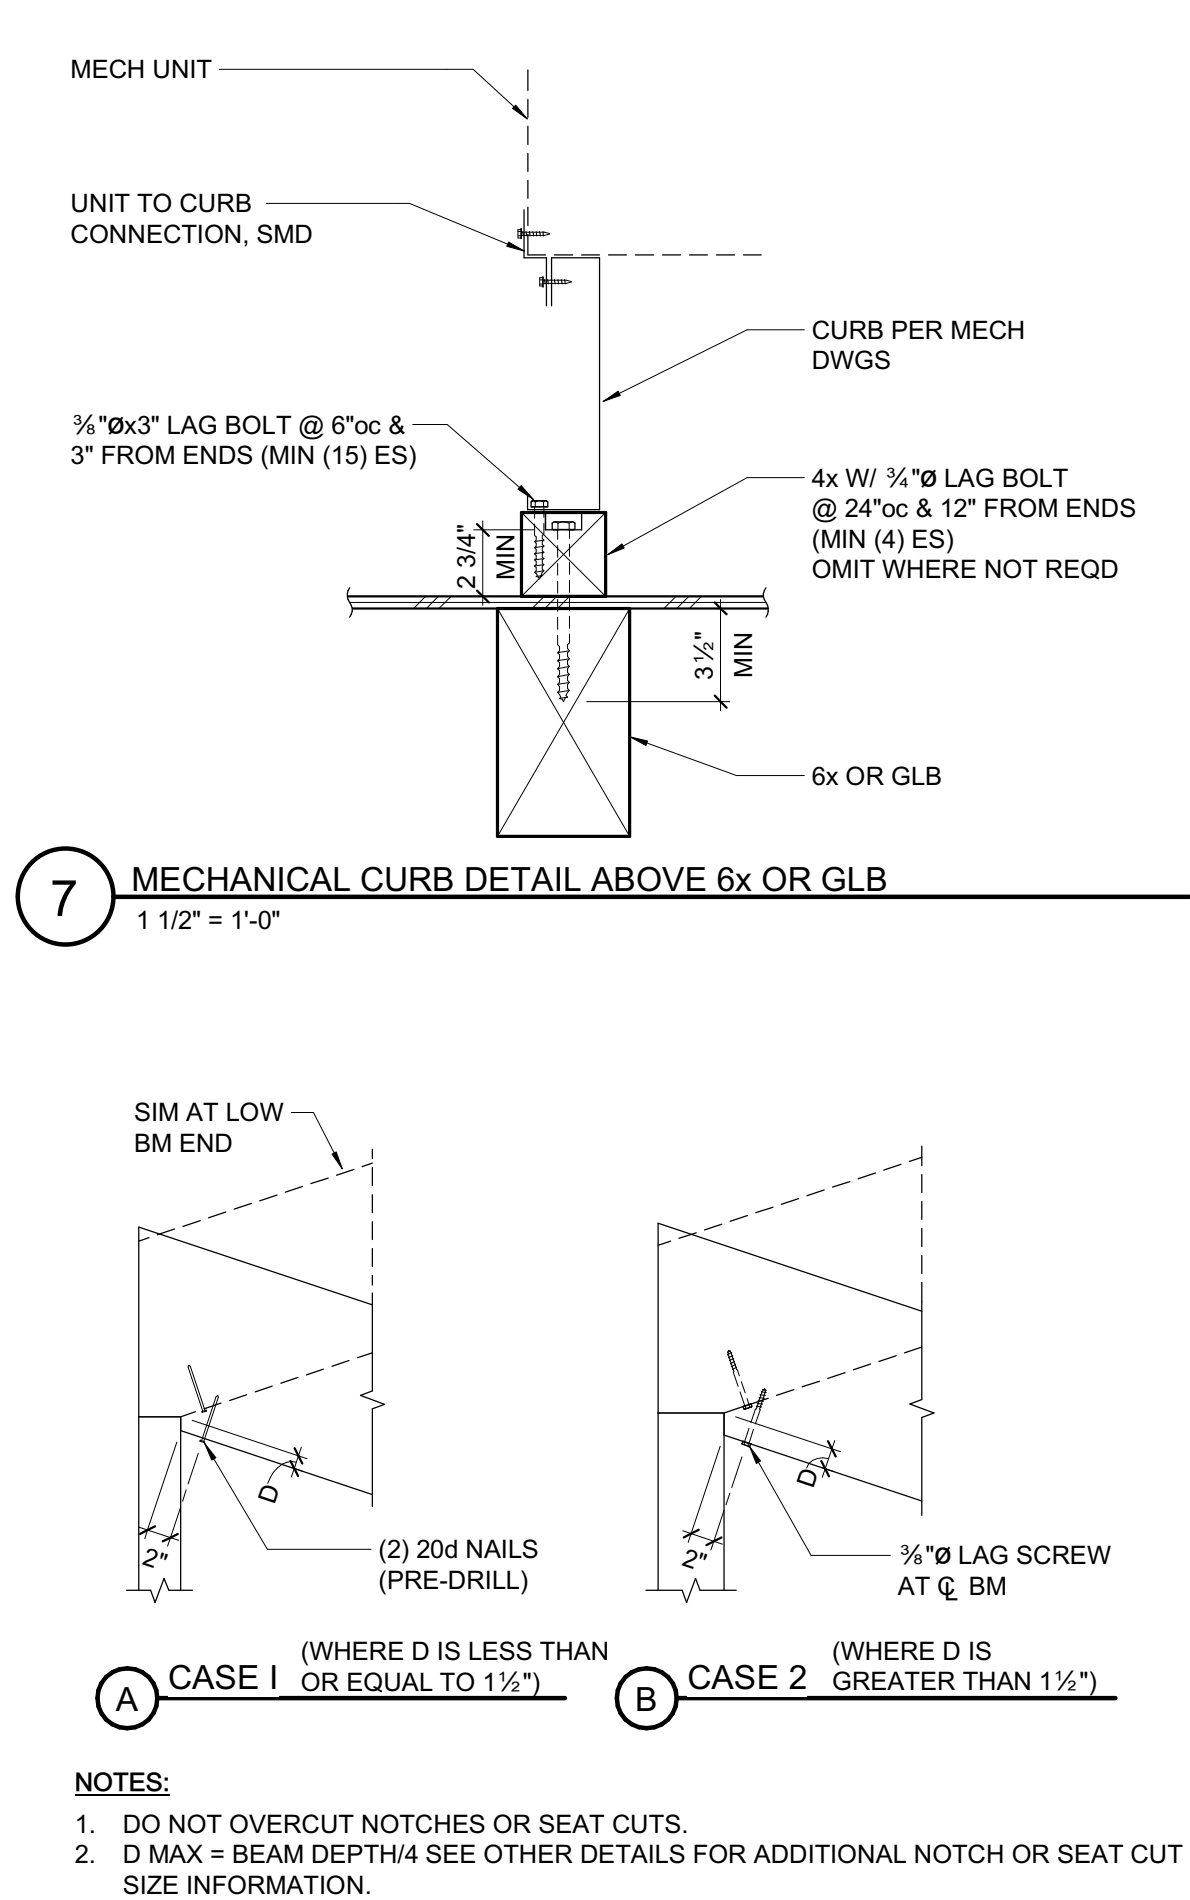
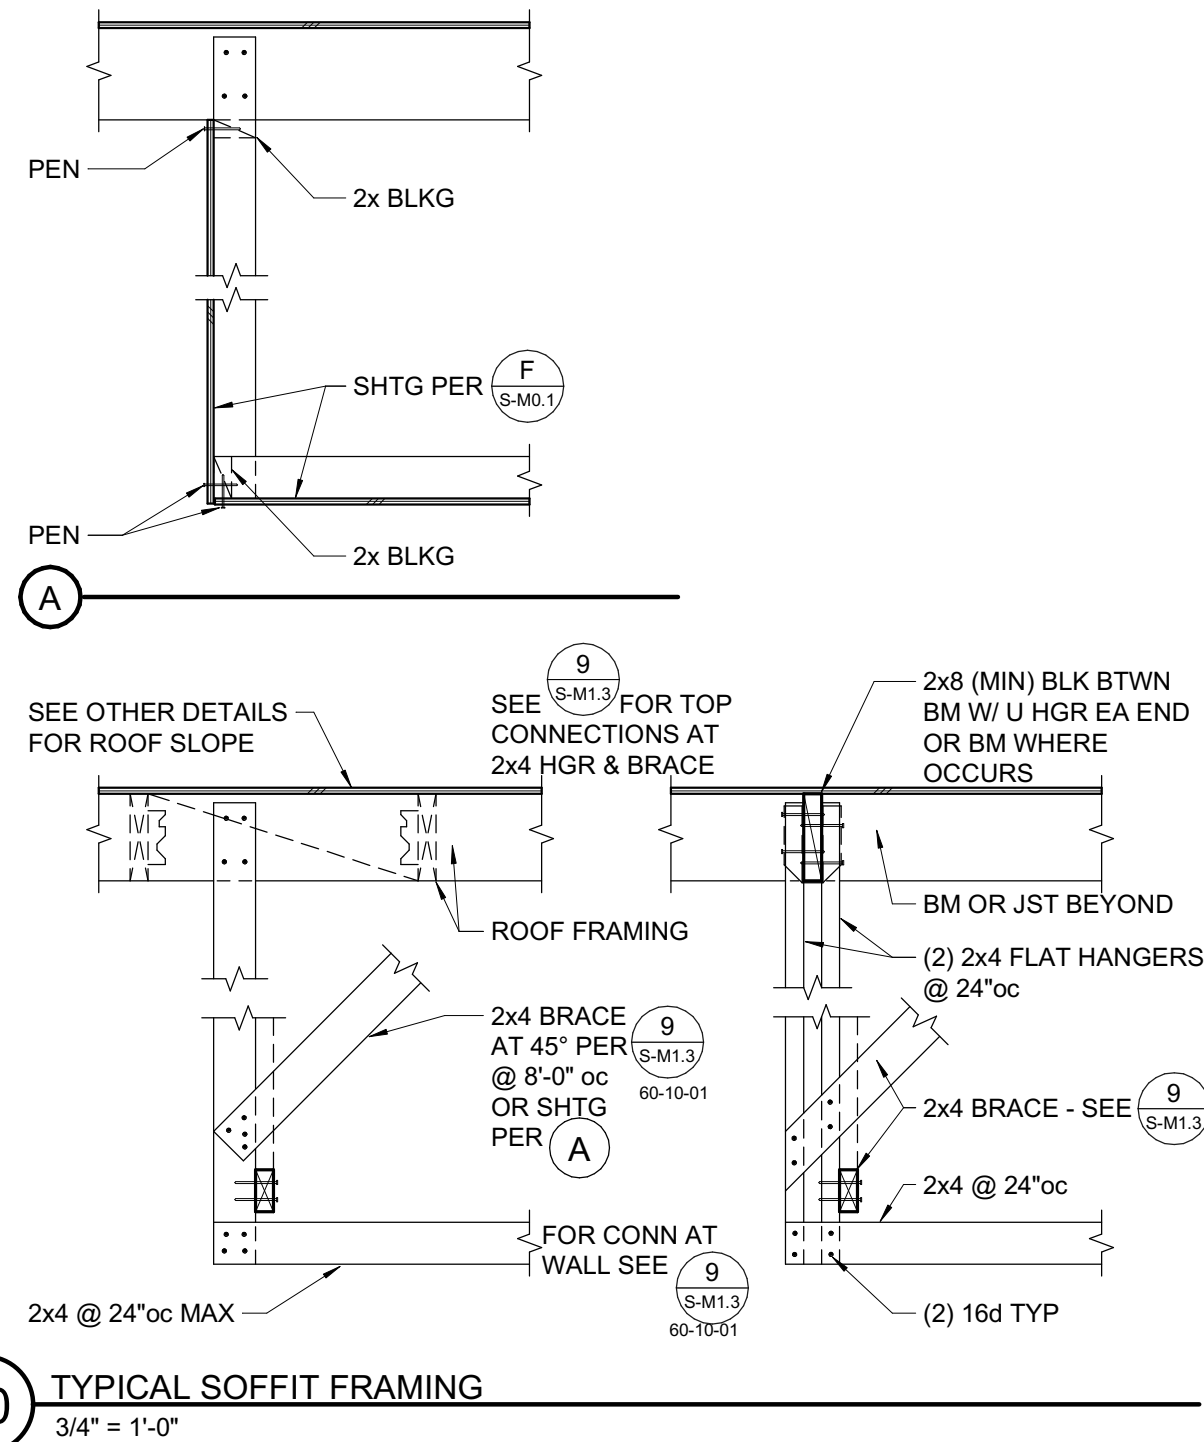
SHEET TITLE

## TYPICAL WOOD DETAILS

SHEET NUMBER

## S-M1.2






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636 Fifth Street, Santa Rosa, CA 95404  
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## NEW AUXILIARY GYMNASIUM

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## LIBERTY UNION HIGH SCHOOL DISTRICT

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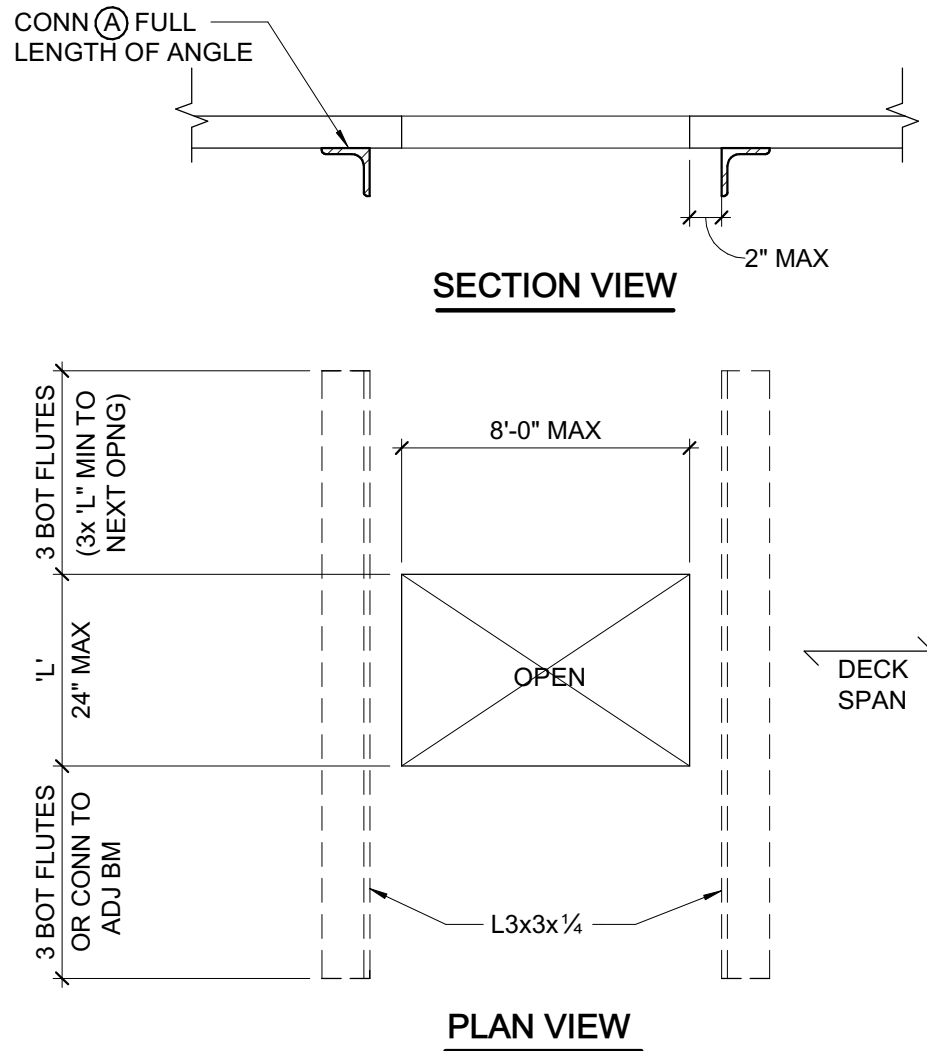
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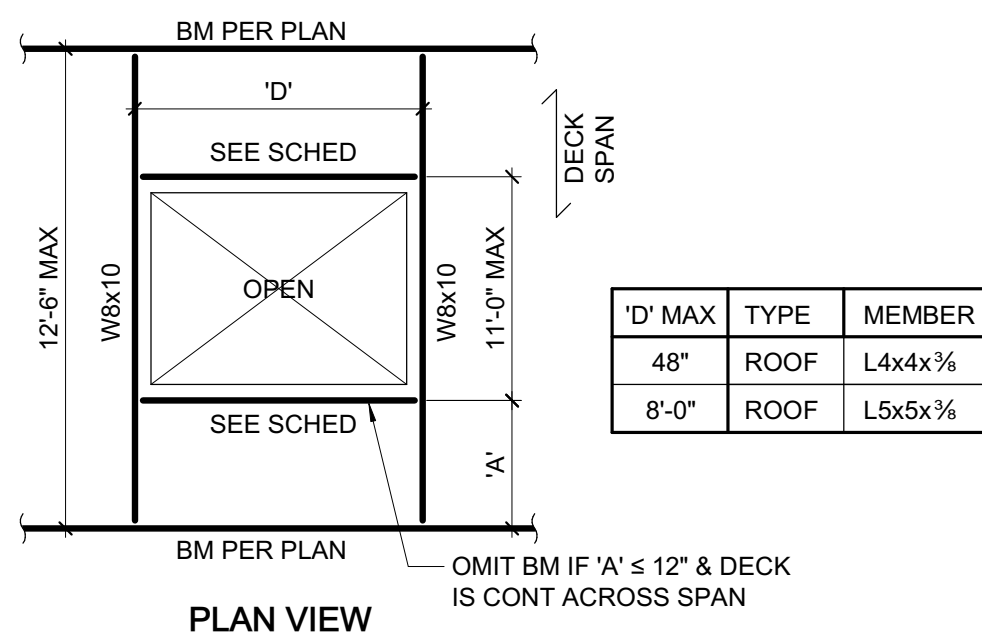
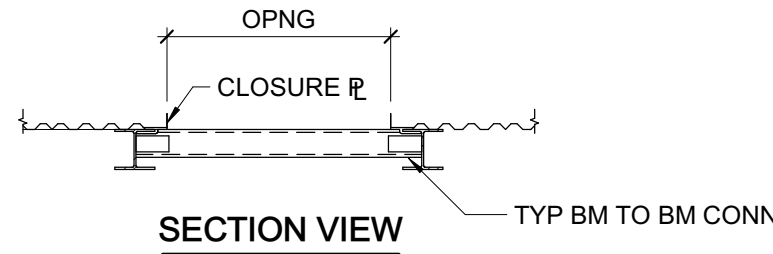
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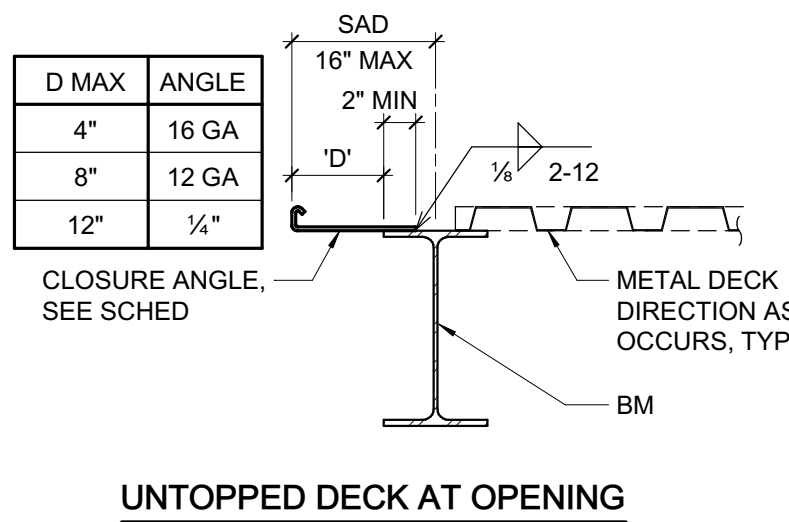


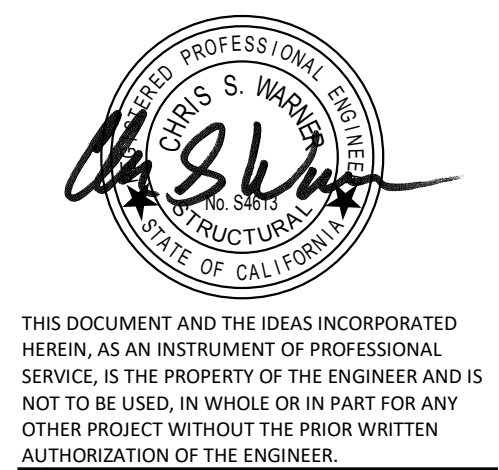


10 TYPICAL REINFORCED OPENING IN DECK (LESS THAN 24")  
1" = 1'-0"





11 TYPICAL FRAMED OPENING IN DECK (LESS THAN 11'-0")  
1" = 1'-0"



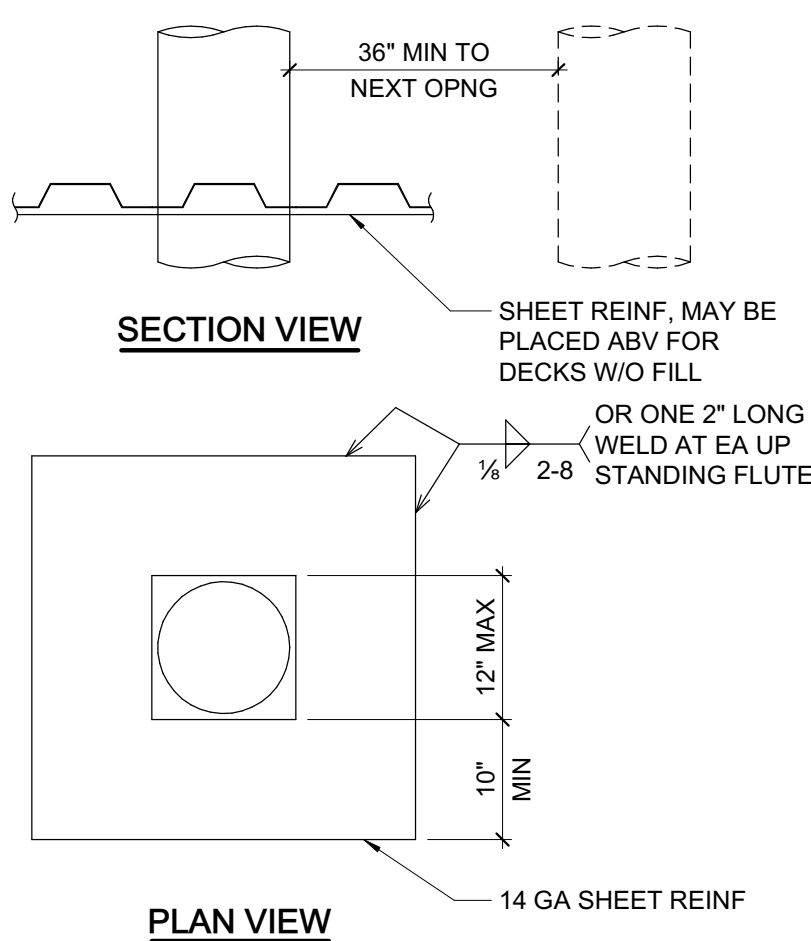

7 TYPICAL EDGE OF DECK  
1" = 1'-0"

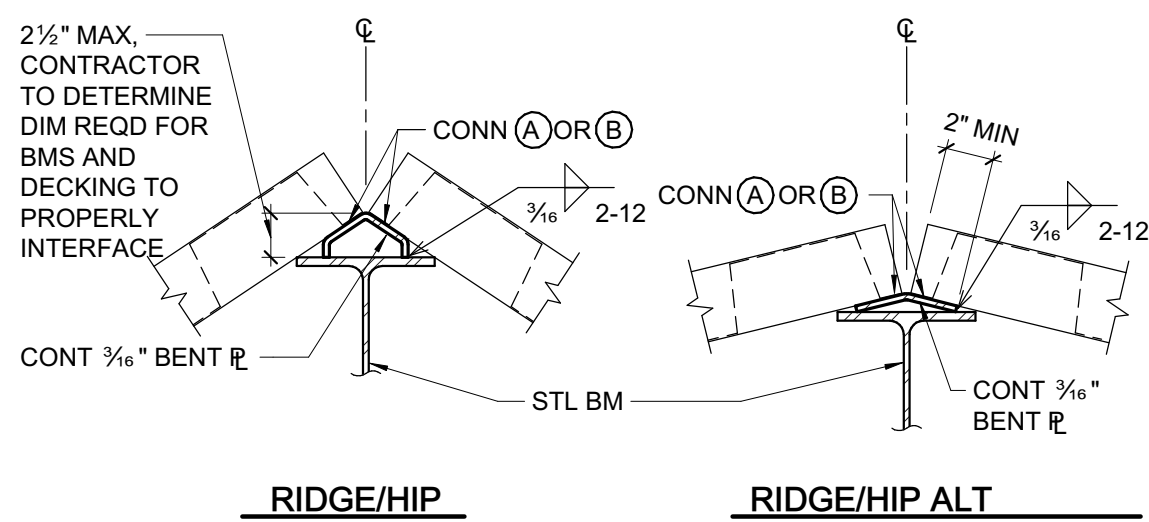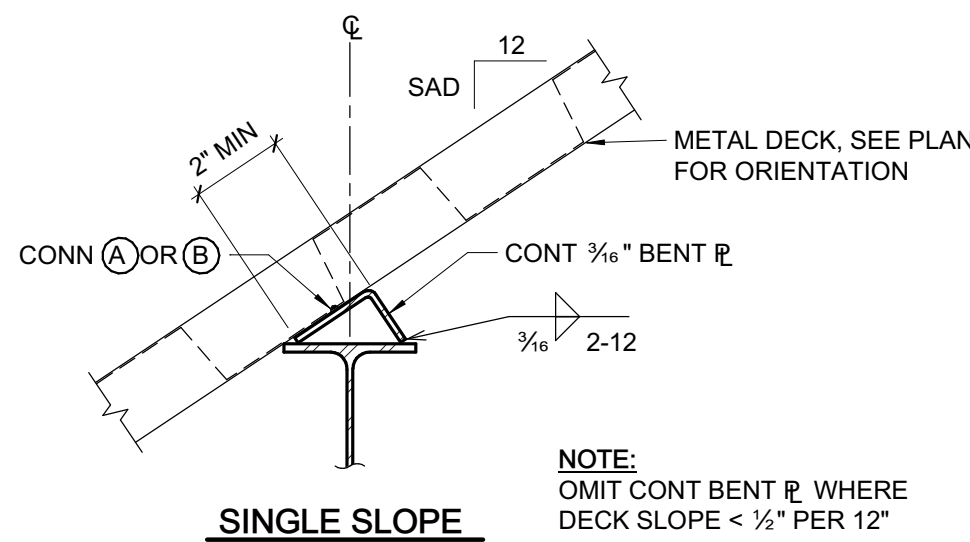

8 TYPICAL REINFORCED OPENING IN DECK (LESS THAN 12")  
3/4" = 1'-0"




9 TYPICAL SLOPED DECK SUPPORT  
1 1/2" = 1'-0"

MARK 	STEEL DECK GAGE & PROFILE TYPE SEE 5 	DECK CONNECTIONS						REMARKS
		END/INT BEARING CONN (A)		SIDE BEARING CONN (B)		SIDELAP CONNECTION (C)		
		SIZE & TYPE	PATTERN	SIZE & TYPE	SPACING	SIZE & TYPE	SPACING	
1	18 GA	PINS	24/3	PINS	12"	SCREWS	6"	14'-0" MAX SPAN
2	16 GA	SCREWS	36/7	SCREWS	12"	TSW	12"	RAIN CANOPY

- NOTES:
- ATTACH DECK TO ALL STEEL FRAMING AS OCCURS.
  - TSW = 1/2" TOP SEAM WELD (1/4" FILLET).
  - PINS = HILTI X-ENP-19 L15 PER ICC ESR-2197 AND ESR-2776.
  - SCREWS = HILTI S-SLC01, HILTI S-SLC02, OR #12 SELF-DRILLING OR SELF-PIERCING SCREWS PER ASTM C1513. PROVIDE NEOPRENE WASHERS AT DECK EXPOSED TO RAIN.
  - ABOVE REFERENCED DECKS ARE BASED ON ALLOWABLE DESIGN LOADS PER IAPMO ER-0218 VERCO MANUFACTURING - EQUIVALENT DECK MUST HAVE EQUIVALENT ALLOWABLE VERTICAL LOADS, DIAPHRAGM SHEAR VALUES, AND FLEXIBILITY FACTORS.
  - SHORING OF DECK REQUIRED AT SINGLE SPAN & 2 SPAN CONDITIONS. NOT REQUIRED AT 3 SPAN CONDITIONS. AT CONTRACTOR'S OPTION, HEAVIER DECK MAY BE USED TO AVOID SHORING PER SEOR WRITTEN APPROVAL.


1 DECKING SCHEDULE  
3/4" = 1'-0"

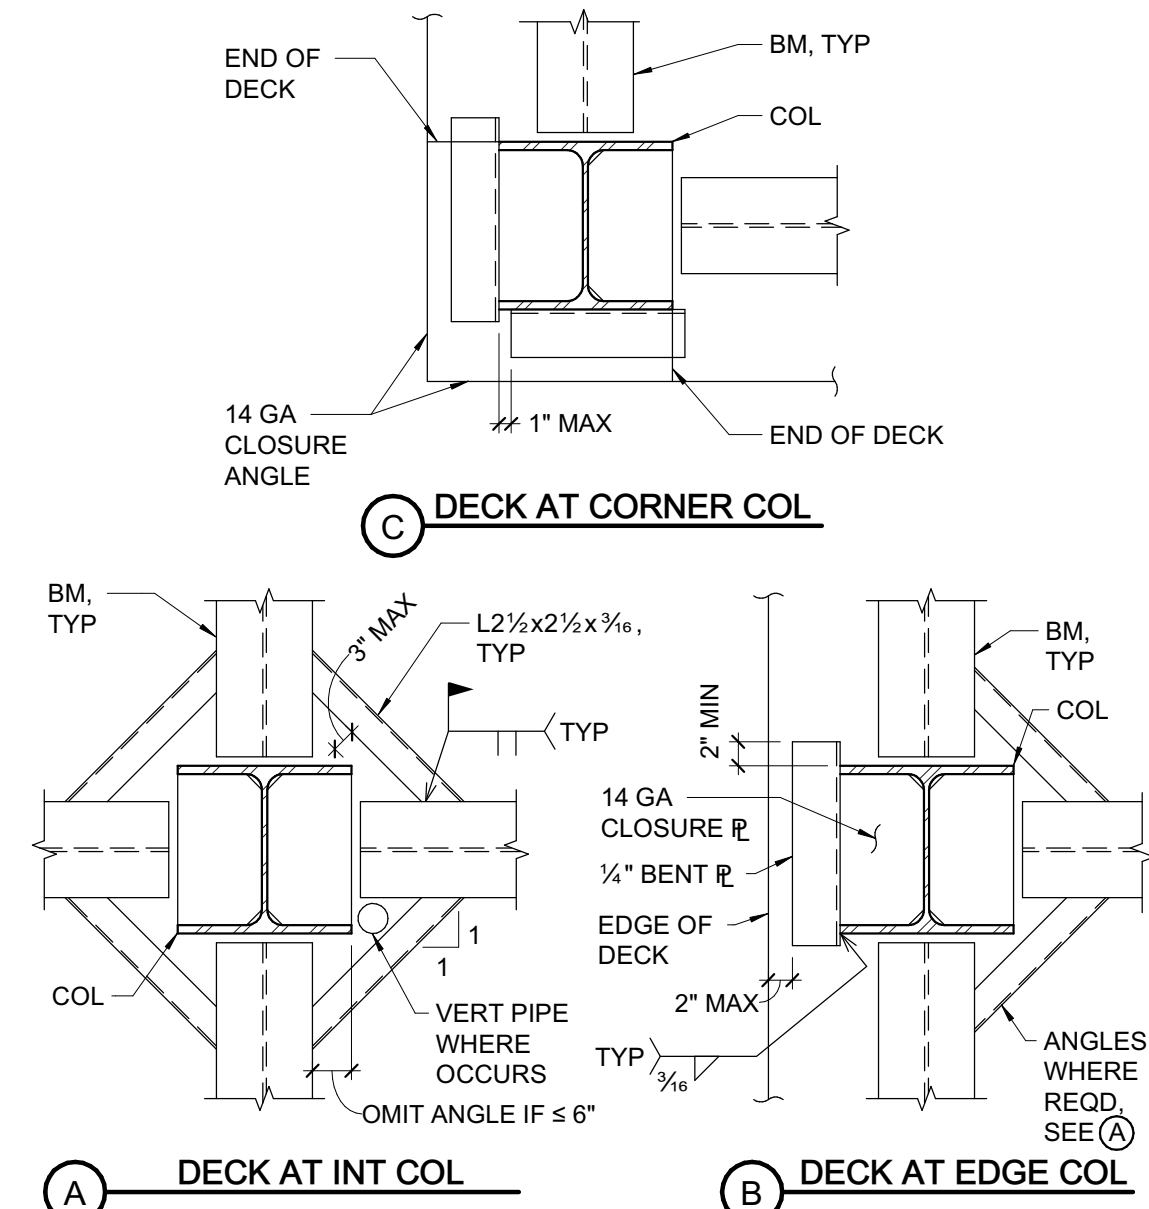


4 CONNECTION PATTERNS TYPICAL DECK SUPPORT AT COLUMN  
3/4" = 1'-0"

TYPE 2 DECK				
VERCO PLB, HSB, OR APPROVED EQUAL				
CONNECTION PATTERN				
GAGE	l _{av} (in ⁴ /ft)	l _{av} (in ⁴ /ft)	S _{av} (in ³ /ft)	S _{av} (in ³ /ft)
16 GA	2.463	2.418	1.084	1.224


5 DECKING TYPE AND CONNECTION PATTERN  
3/4" = 1'-0"

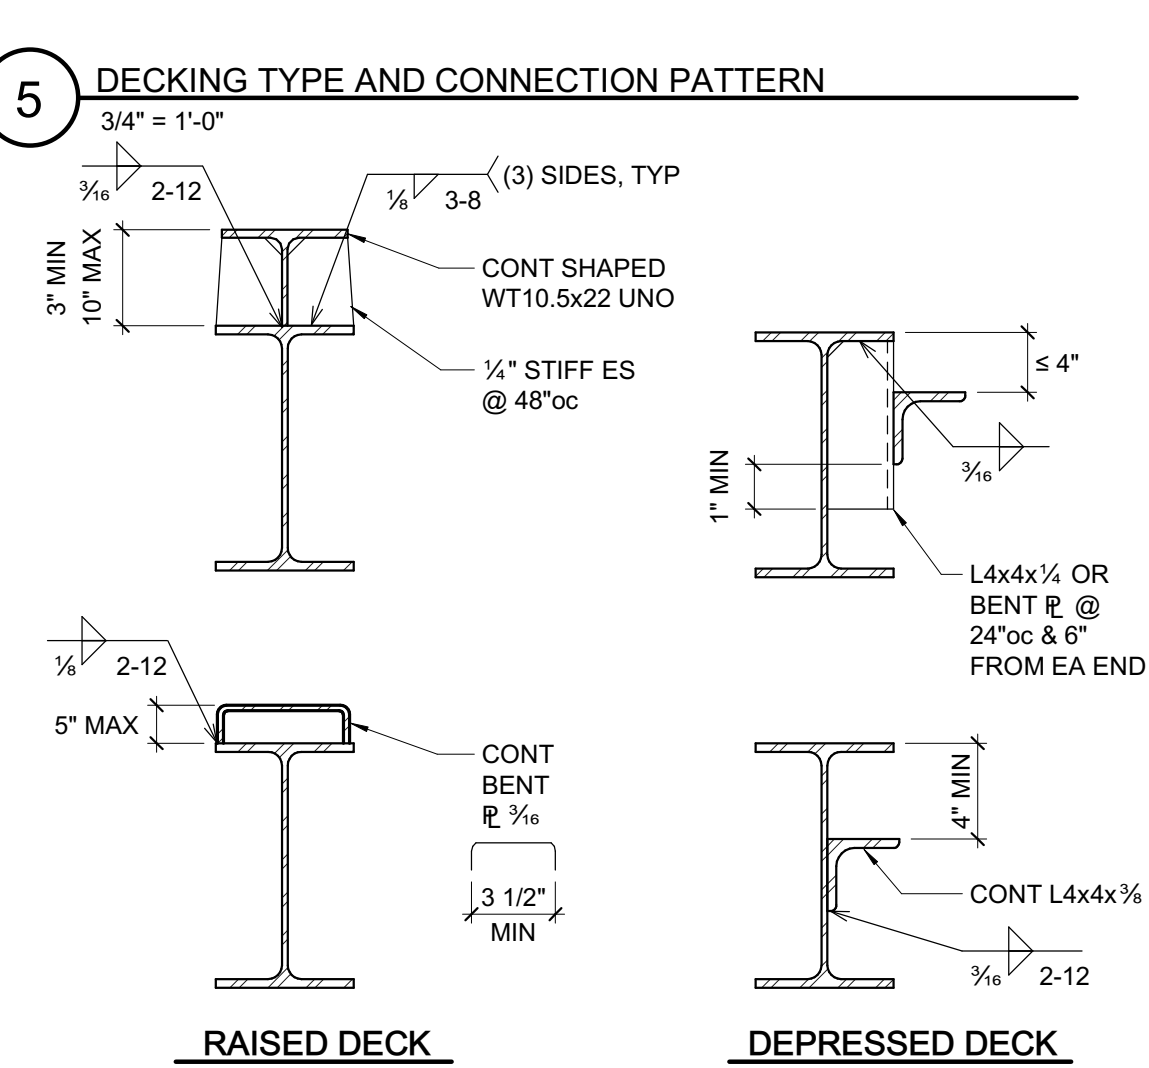


6 TYPICAL RAISED AND DEPRESSED DECK SUPPORT  
1 1/2" = 1'-0"

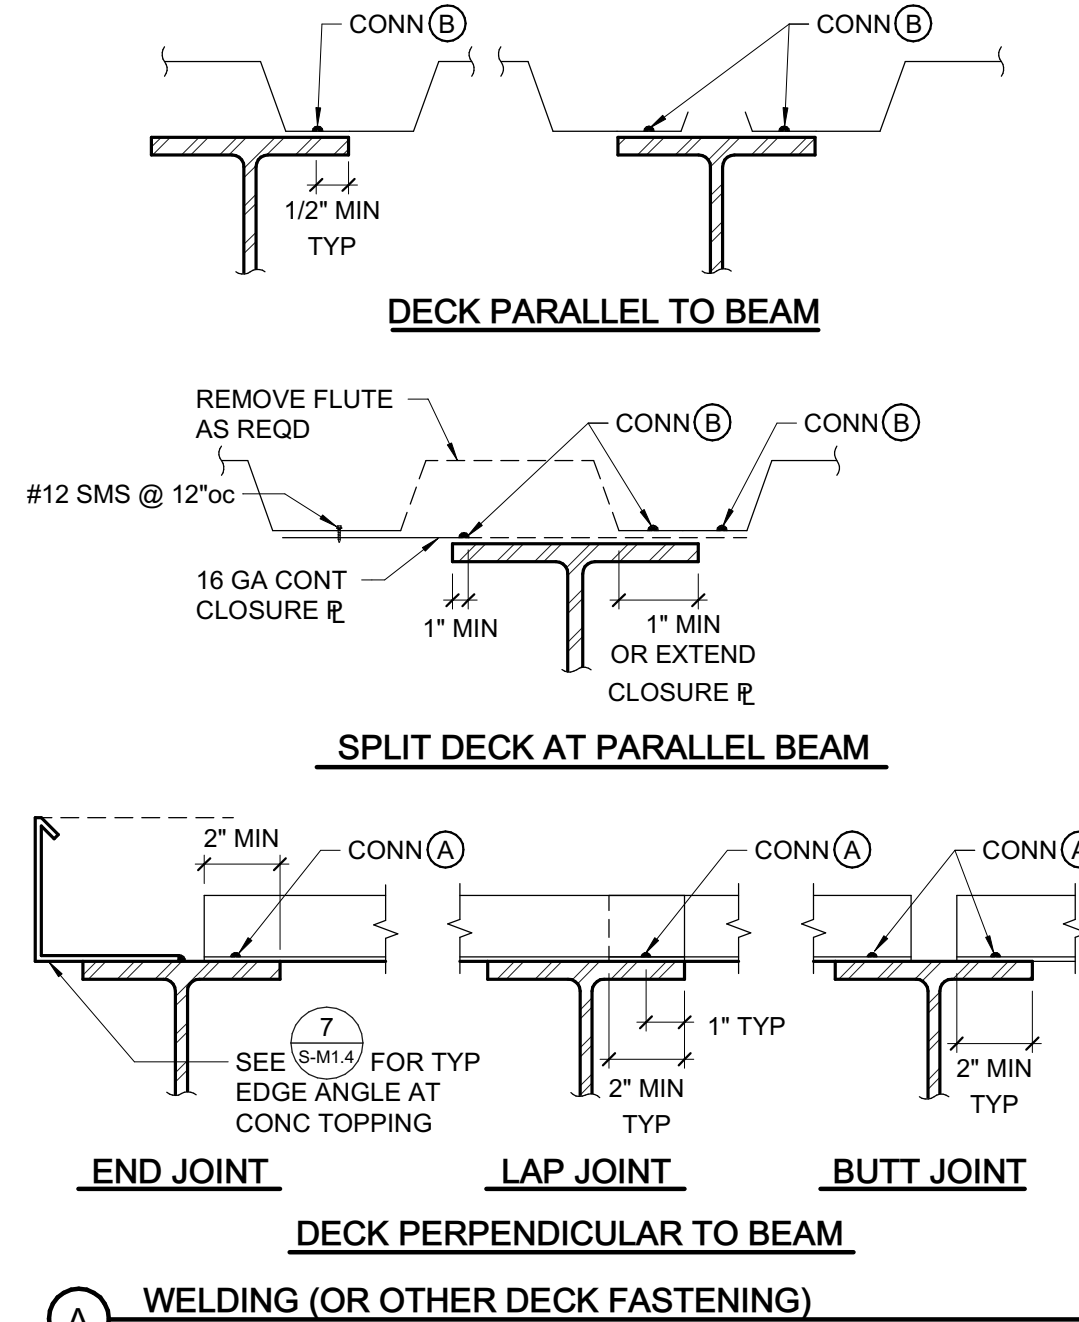

2 TYPICAL STEEL DECK SUPPORT AND WELDING  
3/4" = 1'-0"

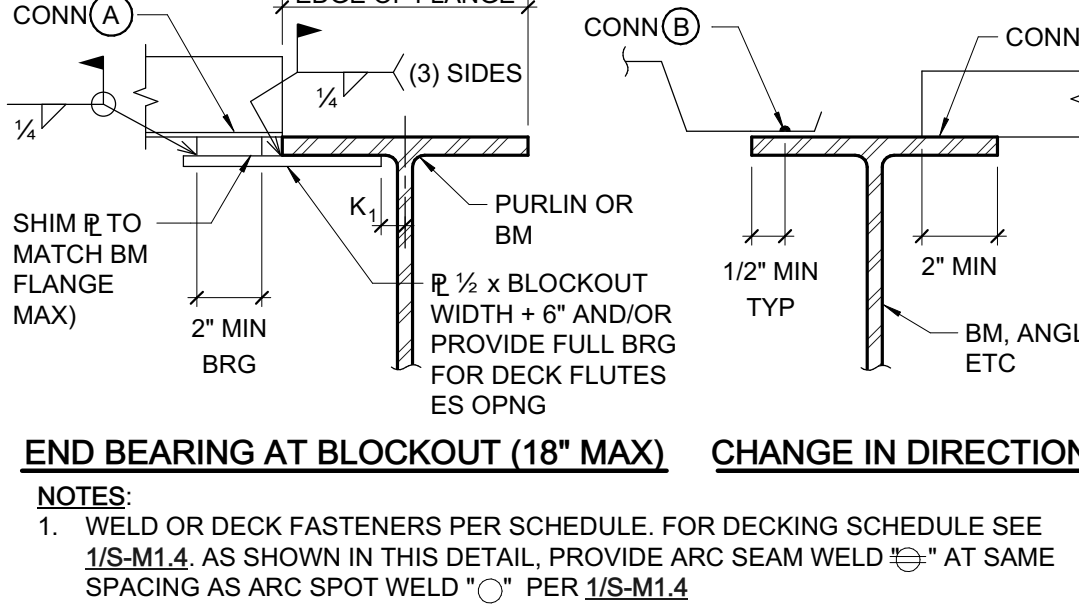

3 TYPICAL DECK SIDE LAP CONNECTION  
3" = 1'-0"

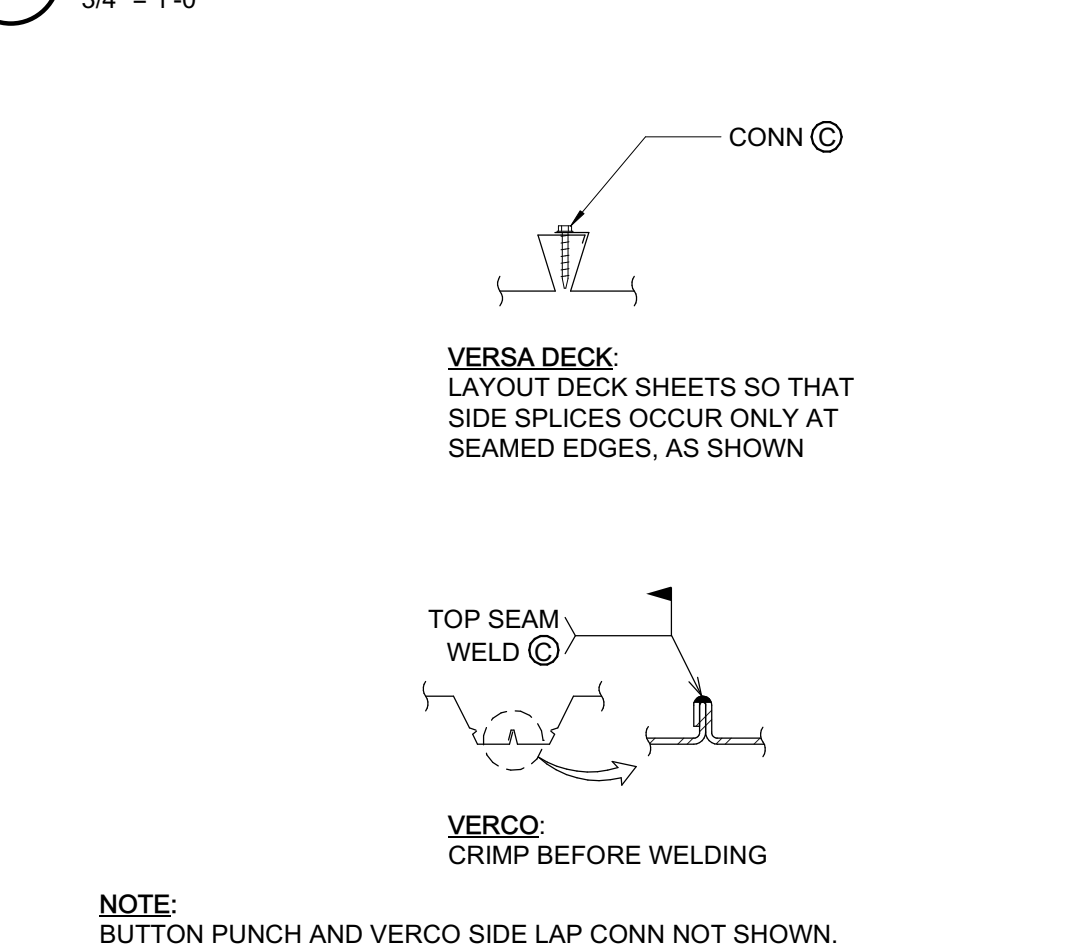

Quattrocchi Kwok Architects  
Main:  
636 Fifth Street, Santa Rosa, CA 95404  
East Bay:  
55 Harrison Street, Suite 525  
Oakland, CA 94607  
(707) 576-0829

ZFA STRUCTURAL ENGINEERS  
1212 fourth street | suite z zfa.com  
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OAKLEY, CA 94561

LIBERTY UNION HIGH SCHOOL DISTRICT

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ZFA NO: 20315  
ENGR / PM: KNC / DLD  
DRAWING SCALE: As indicated  
PTN: 61721-78 FILE NO: 7-H4

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APRIL 27, 2021  
SHEET TITLE

TYPICAL METAL DECKING DETAILS

SHEET NUMBER

S-M1.4








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4/27/2021 11:13:31 AM

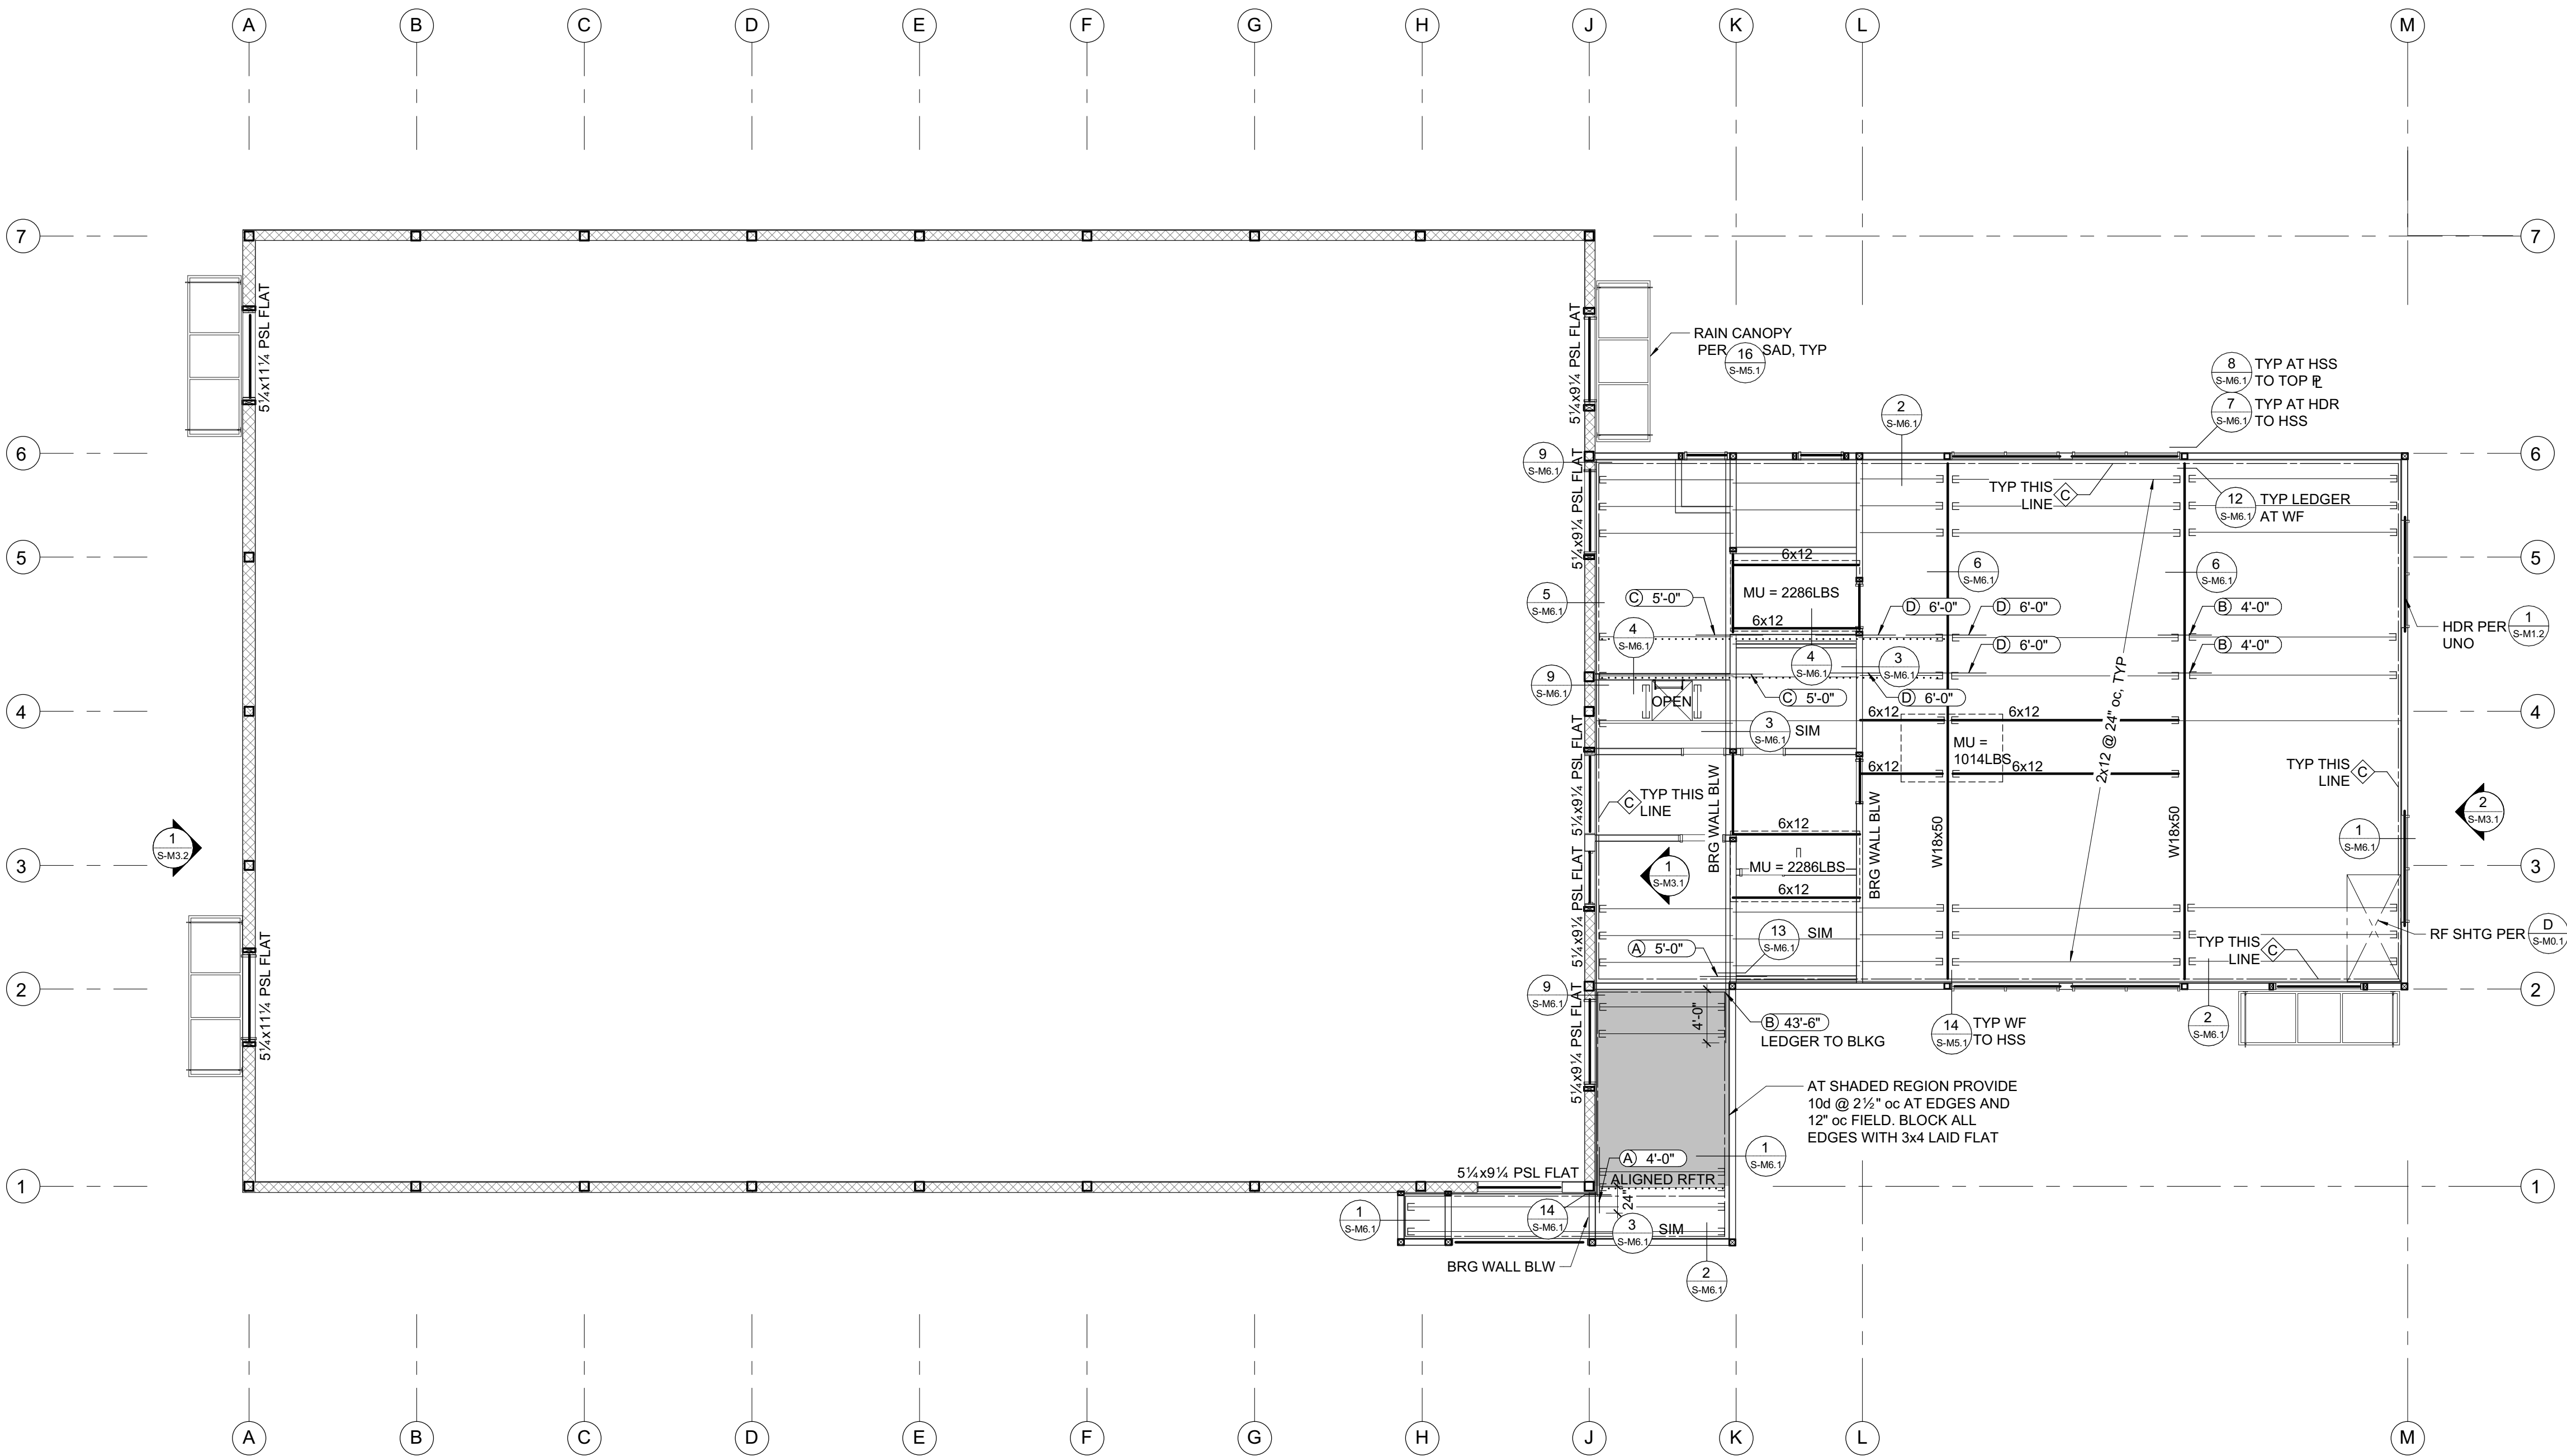

## LOWER ROOF FRAMING PLAN

1/8" = 1'-0"

### FRAMING PLAN NOTES:

- REFER TO SHEETS **S-M0.1**, **S-M1.2**, **S-M1.3** AND **S-M1.4** FOR GENERAL NOTES AND TYPICAL DETAILS. THE FOLLOWING DETAIL REFERENCES ARE PROVIDED FOR THE CONTRACTOR'S CONVENIENCE ONLY. ALL GENERAL NOTES AND TYPICAL DETAIL SHEETS NOTED ABOVE ARE APPLICABLE AND SHALL BE FOLLOWED.
- DIMENSIONS ARE TO FACE OF STUD UNLESS NOTED OTHERWISE. COORDINATE ALL DIMENSIONS WITH ARCHITECTURAL DRAWINGS PRIOR TO CONSTRUCTION. NOTIFY ARCHITECT/ENGINEER OF ANY DISCREPANCIES.
- MECHANICAL, ELECTRICAL AND PLUMBING PENETRATIONS THROUGH WALLS OR ROOFS SHALL BE PER REFERENCES BELOW UNLESS SHOWN AND DETAILED OTHERWISE ON THE STRUCTURAL PLANS. NOTIFY ARCHITECT/ENGINEER PRIOR TO ANY INSTALLATION NOT CONFORMING TO THESE DETAILS.

PENETRATIONS THROUGH SHEAR WALLS SHALL BE PER **6/S-M1.2**.


PENETRATIONS THROUGH ROOFS SHALL BE PER **5/S-M1.2**.
- ALL EXTERIOR WALLS NOT DESIGNATED AS SHEAR WALLS ON PLANS (INCLUDING WALLS ADJACENT TO SEISMIC GAPS) SHALL BE SHEATHED AS SHEAR WALL TYPE 'A' PER SHEAR WALL SCHEDULE, UNLESS NOTED OTHERWISE.

PLAN LEGEND		
SYMBOL	REFERENCE DETAIL	DESCRIPTION
	1/S-M1.2	INDICATES STRUCTURAL WALL.
	D/S-M0.1	INDICATES WOOD POST.
	6/S-M1.3	INDICATES STEEL COLUMN.
	11/S-M1.2	INDICATES PANEL EDGE NAILING ALONG FULL LENGTH OF MEMBER.
	D/S-M0.1	INDICATES HANGER.
		INDICATES LEDGER. SEE PLAN FOR SIZE AND ANCHORAGE.
		INDICATES GRIDLINE
		INDICATES ELEVATION.
	7/S-M1.3	INDICATES APPROXIMATE LOCATION, SIZE AND MAXIMUM WEIGHT OF MECHANICAL UNIT. SEE MECHANICAL DRAWINGS FOR ANCHORAGE AND ADDITIONAL INFORMATION.
		INDICATES STEP IN ELEVATION. SEE ARCHITECTURAL DRAWINGS.
	1/S-M1.3	INDICATES TOP PLATE SPLICE. SPLICE TYPE SHALL OCCUR ALONG THE ENTIRE LENGTH OF THE WALL, UNO. PROVIDE SPLICE TYPE 'A' IF NOT NOTED ON PLANS.
	2/S-M1.3	INDICATES LEDGER/RIM SPLICE. SPLICE TYPE SHALL OCCUR ALONG THE ENTIRE LENGTH OF THE WALL, UNO. PROVIDE SPLICE TYPE 'A' IF NOT NOTED ON PLANS.
	3/S-M1.3	INDICATES TIE STRAP. SEE SCHEDULE FOR STRAP, NAILING AND LENGTH.
	8/S-M5.1 9/S-M5.2	INDICATES BRACE BELOW

LEDGER SPLICE SCHEDULE				
MARK	CASE	STRAP/PLATE	CASE	STRAP/PLATE
A	1	MSTA24	-	
B	1	MSTA30	-	
C	2	MST148	3	MST160
D	2	CMST14x5'-6"	3	CMST14x6'-0"
E	2	(2) MST148	4	R 1/2" W/ (6) 1"Ø MB ES OF SPLICE

TIE STRAP SCHEDULE						
MARK	STRAP	MIN. NAILING ES OF ♦	MAX. NAIL SPACING (SEE NOTES #1 & #2)			MIN. END LENGTH (EL)
			CASE 1	CASE 2		
				EL	RL	
A	CS16	(10) 10d	10d @ 4"oc STGR	FILL ALL NAIL HOLES	10d @ 4"oc STGR	12"
B	CS14	(13) 10d	10d @ 4"oc STGR	FILL ALL NAIL HOLES	10d @ 4"oc STGR	16"
C	CMSTC16	(25) 10d	10d @ 3"oc STGR	FILL ALL NAIL HOLES	10d @ 3"oc STGR	24"
D	CMST14	(33) 10d	10d @ 3 1/2"oc STGR	FILL ALL NAIL HOLES	10d @ 3 1/2"oc STGR	32"
E	CMST12	(43) 10d	10d @ 3 1/2"oc STGR	FILL ALL NAIL HOLES	10d @ 3 1/2"oc STGR	48"

- CASE 1 APPLIES UNLESS END LENGTH (EL) IS NOTED ON PLANS. WHERE END LENGTH (EL) IS NOTED, SEE CASE 2.

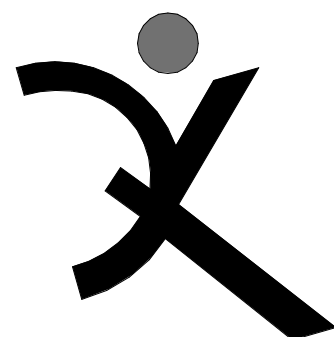

### QUATTROCCHI KWOK ARCHITECTS

Main:  
636 Fifth Street, Santa Rosa, CA 95404  
East Bay:  
55 Harrison Street, Suite 525  
Oakland, CA 94607  
(707) 576-0829

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## FREEDOM HIGH SCHOOL

### NEW AUXILIARY GYMNASIUM

1050 NEROLY RD,  
OAKLEY, CA 94561

### LIBERTY UNION HIGH SCHOOL DISTRICT

#### REVISIONS

NO.	DESCRIPTION	DATE

DSA APP NO. 01-119278

ZFA NO: 20315

ENGR / PM: KNC / DLD

DRAWING SCALE: As indicated

PTN: 61721-78 FILE NO: 7-H4

#### BID DOCUMENT

APRIL 27, 2021

SHEET TITLE

## LOWER ROOF FRAMING PLAN

SHEET NUMBER

# S-M2.2




C:\revit_local\20315_FREEDOM_S20C_kylec@zfa.com.rvt

4/27/2021 11:13:32 AM

## UPPER ROOF FRAMING PLAN

1/8" = 1'-0"

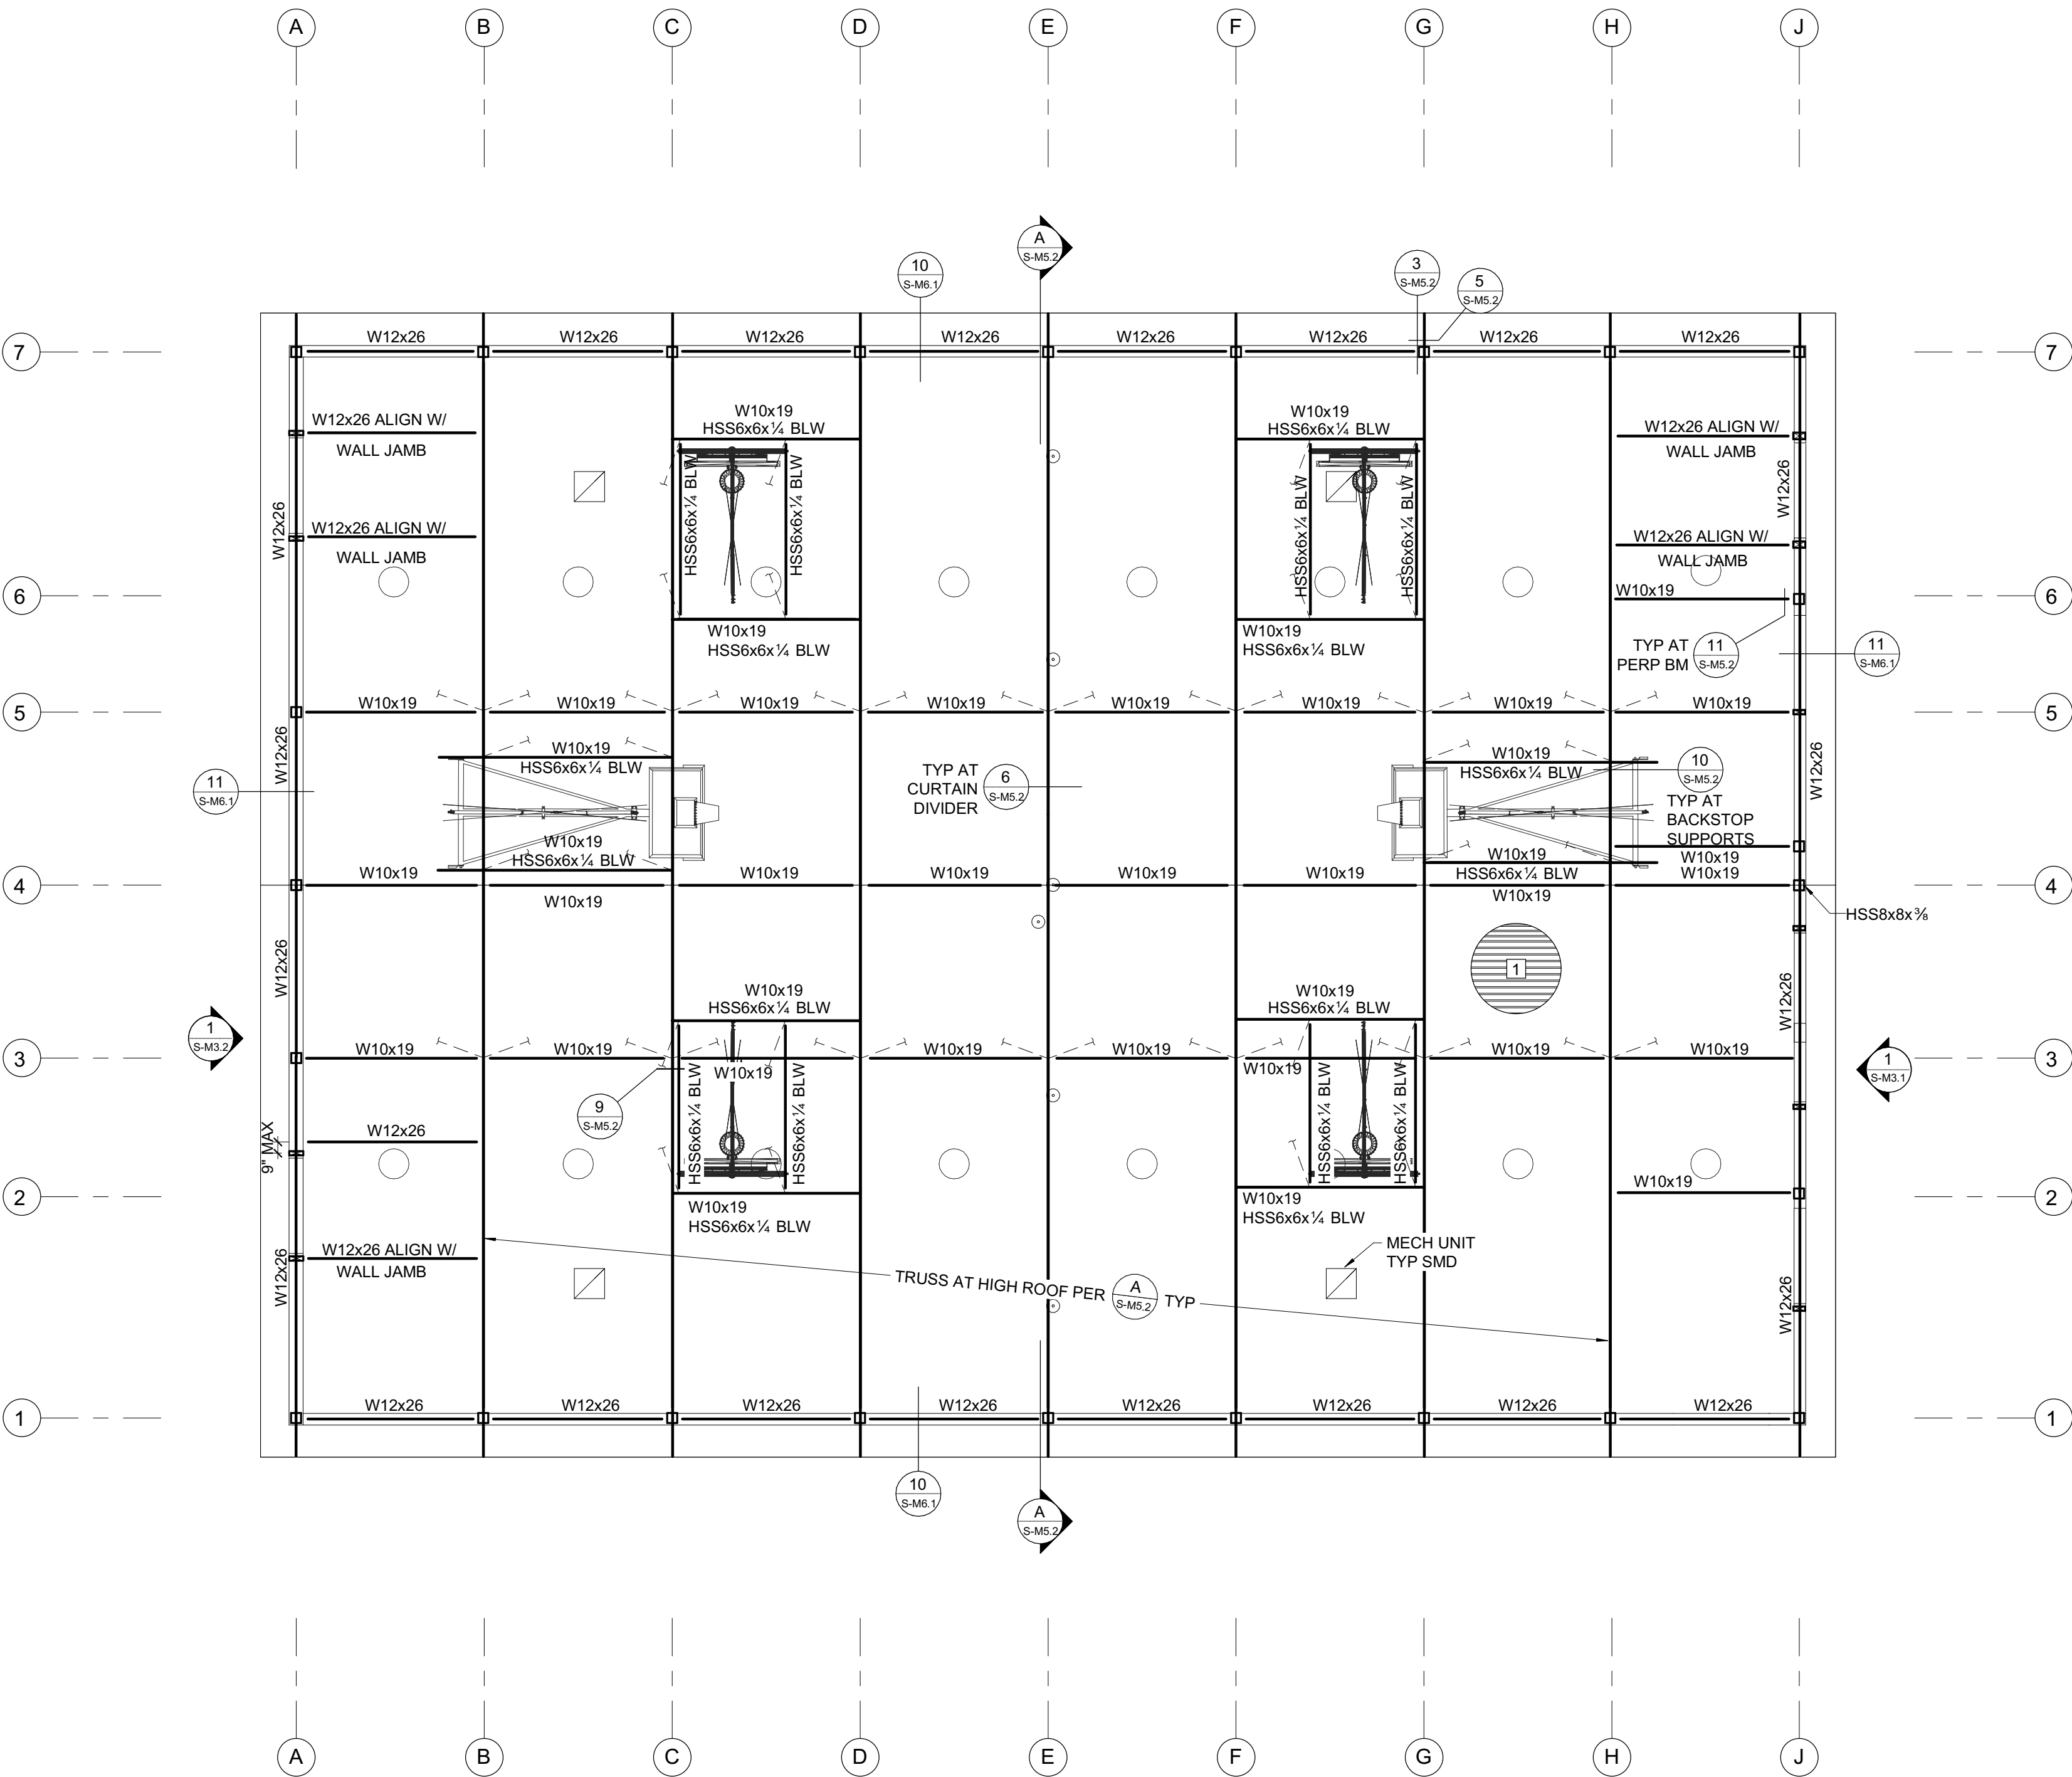


### FRAMING PLAN NOTES:

- REFER TO SHEETS **S-M0.1**, **S-M1.2**, **S-M1.3** AND **S-M1.4** FOR GENERAL NOTES AND TYPICAL DETAILS. THE FOLLOWING DETAIL REFERENCES ARE PROVIDED FOR THE CONTRACTOR'S CONVENIENCE ONLY. ALL GENERAL NOTES AND TYPICAL DETAIL SHEETS NOTED ABOVE ARE APPLICABLE AND SHALL BE FOLLOWED.
- DIMENSIONS ARE TO FACE OF STUD UNLESS NOTED OTHERWISE. COORDINATE ALL DIMENSIONS WITH ARCHITECTURAL DRAWINGS PRIOR TO CONSTRUCTION. NOTIFY ARCHITECT/ENGINEER OF ANY DISCREPANCIES.
- MECHANICAL, ELECTRICAL AND PLUMBING PENETRATIONS THROUGH WALLS OR ROOFS SHALL BE PER REFERENCES BELOW UNLESS SHOWN AND DETAILED OTHERWISE ON THE STRUCTURAL PLANS. NOTIFY ARCHITECT/ENGINEER PRIOR TO ANY INSTALLATION NOT CONFORMING TO THESE DETAILS.  
  
PENETRATIONS THROUGH SHEAR WALLS SHALL BE PER **6/S-M1.2**  
  
PENETRATIONS THROUGH ROOFS SHALL BE PER **5/S-M1.2**
- ALL EXTERIOR WALLS NOT DESIGNATED AS SHEAR WALLS ON PLANS (INCLUDING WALLS ADJACENT TO SEISMIC GAPS) SHALL BE SHEATHED AS SHEAR WALL TYPE 'A' PER SHEAR WALL SCHEDULE, UNLESS NOTED OTHERWISE.

PLAN LEGEND		
SYMBOL	REFERENCE DETAIL	DESCRIPTION
	<b>1/S-M1.2</b>	INDICATES STRUCTURAL WALL.
	<b>D/S-M0.1</b>	INDICATES WOOD POST.
	<b>6/S-M1.3</b>	INDICATES STEEL COLUMN.
	<b>11/S-M1.2</b>	INDICATES PANEL EDGE NAILING ALONG FULL LENGTH OF MEMBER.
	<b>D/S-M0.1</b>	INDICATES HANGER.
		INDICATES LEDGER. SEE PLAN FOR SIZE AND ANCHORAGE.
		INDICATES GRIDLINE
		INDICATES ELEVATION.
	<b>7/S-M1.3</b>	INDICATES APPROXIMATE LOCATION, SIZE AND MAXIMUM WEIGHT OF MECHANICAL UNIT. SEE MECHANICAL DRAWINGS FOR ANCHORAGE AND ADDITIONAL INFORMATION.
		INDICATES STEP IN ELEVATION. SEE ARCHITECTURAL DRAWINGS.
	<b>1/S-M1.3</b>	INDICATES TOP PLATE SPLICE. SPLICE TYPE SHALL OCCUR ALONG THE ENTIRE LENGTH OF THE WALL. UNO, PROVIDE SPLICE TYPE 'A' IF NOT NOTED ON PLANS.
	<b>2/S-M1.3</b>	INDICATES LEDGER/RIM SPLICE. SPLICE TYPE SHALL OCCUR ALONG THE ENTIRE LENGTH OF THE WALL. UNO, PROVIDE SPLICE TYPE 'A' IF NOT NOTED ON PLANS.
	<b>3/S-M1.3</b>	INDICATES TIE STRAP. SEE SCHEDULE FOR STRAP, NAILING AND LENGTH.
	<b>8/S-M5.1</b> <b>9/S-M5.2</b>	INDICATES BRACE BELOW

TIE STRAP SCHEDULE						
MARK	STRAP	MIN. NAILING ES OF •	MAX. NAIL SPACING (SEE NOTES #1 & #2)			MIN. END LENGTH (EL)
			CASE 1	CASE 2		
				EL	RL	
(A)	CS16	(10) 10d	10d @ 4"oc STGR	FILL ALL NAIL HOLES	10d @ 4"oc STGR	12"
(B)	CS14		10d @ 4"oc STGR	FILL ALL NAIL HOLES	10d @ 4"oc STGR	16"
(C)	CMSTC16	(25) 10d	10d @ 3"oc STGR	FILL ALL NAIL HOLES	10d @ 3"oc STGR	24"
(D)	CMST14	(33) 10d	10d @ 3 1/2"oc STGR	FILL ALL NAIL HOLES	10d @ 3 1/2"oc STGR	32"
(E)	CMST12	(43) 10d	10d @ 3 1/2"oc STGR	FILL ALL NAIL HOLES	10d @ 3 1/2"oc STGR	48"

1. CASE 1 APPLIES UNLESS END LENGTH (EL) IS NOTED ON PLANS. WHERE END LENGTH (EL) IS NOTED, SEE CASE 2.

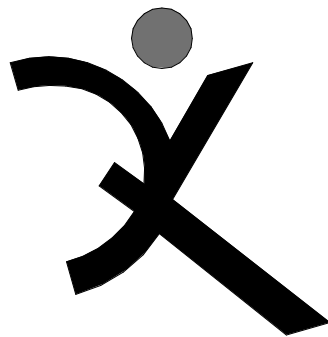

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Main:  
636 Fifth Street, Santa Rosa, CA 95404  
East Bay:  
55 Harrison Street, Suite 525  
Oakland, CA 94607  
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## FREEDOM HIGH SCHOOL

### NEW AUXILIARY GYMNASIUM

1050 NEROLY RD,  
OAKLEY, CA 94561

### LIBERTY UNION HIGH SCHOOL DISTRICT

#### REVISIONS


DSA APP NO. 01-119278

ZFA NO: 20315  
ENGR / PM: KNC / DLD  
DRAWING SCALE: As indicated  
PTN: 61721-78 FILE NO: 7-H4

#### BID DOCUMENT

APRIL 27, 2021


SHEET TITLE

## UPPER ROOF FRAMING PLAN


SHEET NUMBER

# S-M2.3



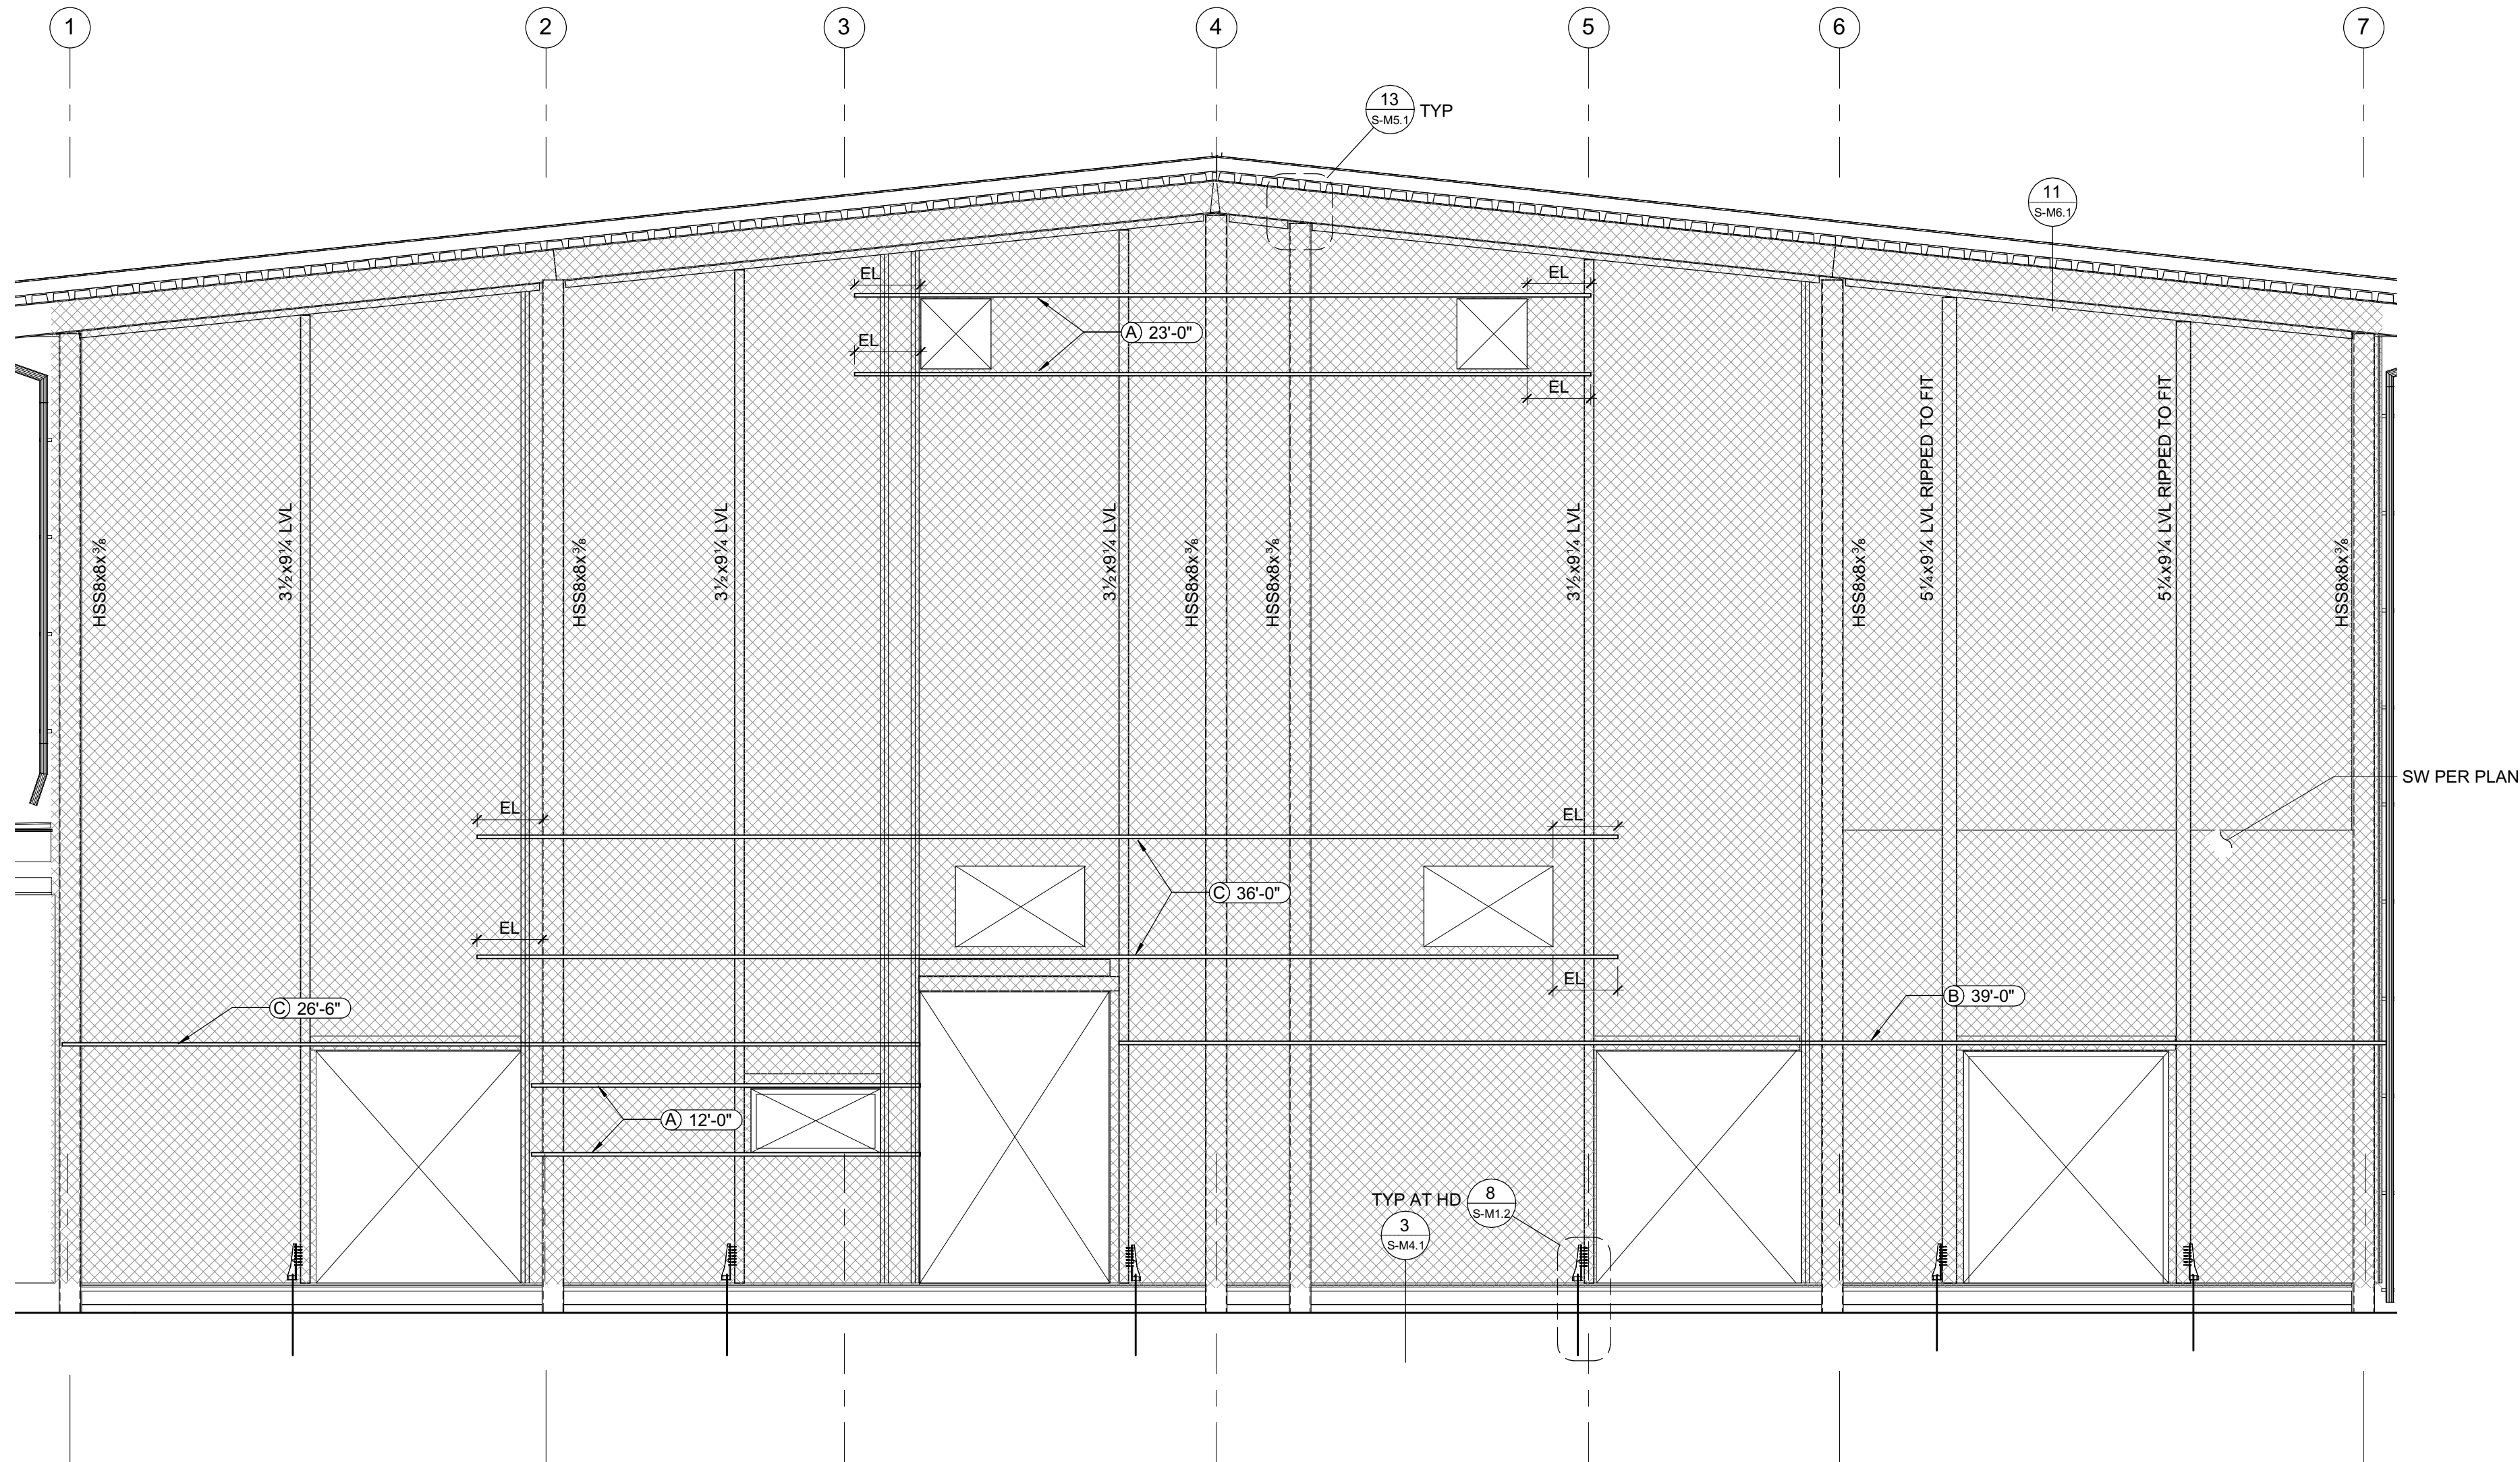

1 ELEVATION 1  
1/4" = 1'-0"

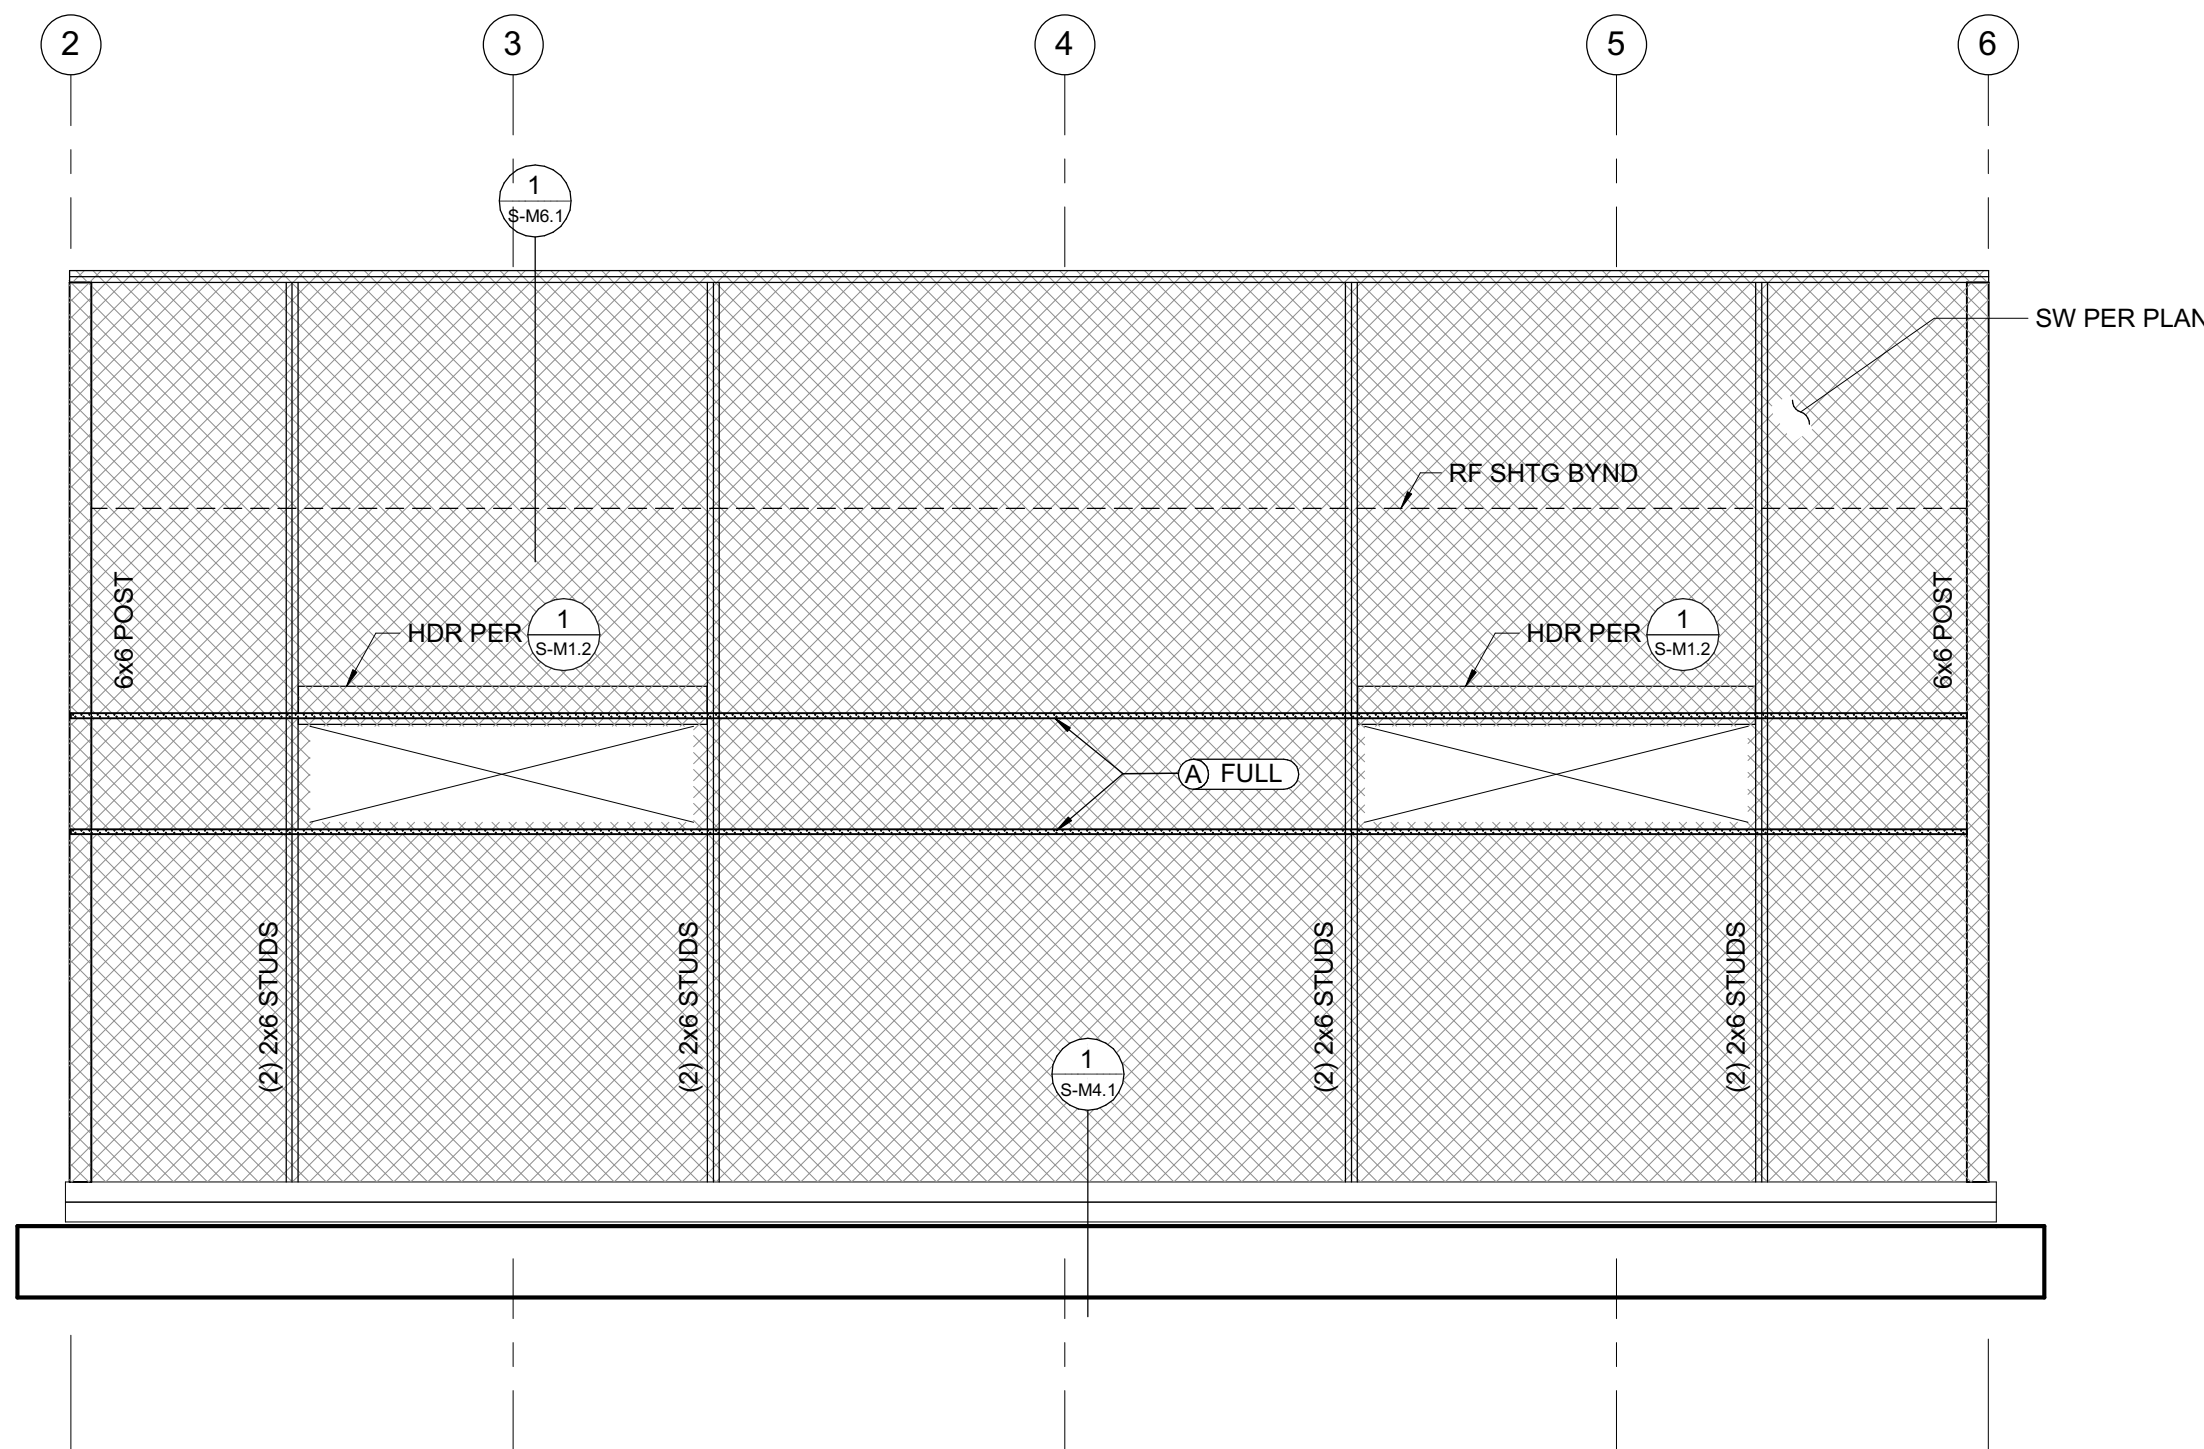


2 ELEVATION 2  
1/4" = 1'-0"

FRAMING ELEVATION NOTES:

- ELEVATIONS ARE SCHEMATIC. SEE PLANS FOR ADDITIONAL INFORMATION.
- SEE PLANS FOR ALL COLUMN AND BEAM SIZES.
- SAD FOR FRAMING HEIGHTS, BEAM SLOPES AND ALL DIMENSIONS.
- NO COLUMN SPLICES PERMITTED EXCEPT WHERE NOTED.

TIE STRAP SCHEDULE						
MARK	STRAP	MIN. NAILING ES OF *	MAX. NAIL SPACING (SEE NOTES #1 & #2)			MIN. END LENGTH (EL)
			CASE 1	CASE 2		
				EL	RL	
(A)	CS16	(10) 10d	10d @ 4"oc STGR	FILL ALL NAIL HOLES	10d @ 4"oc STGR	12"
(B)	CS14	(13) 10d	10d @ 4"oc STGR	FILL ALL NAIL HOLES	10d @ 4"oc STGR	16"
(C)	CMSTC16	(25) 10d	10d @ 3"oc STGR	FILL ALL NAIL HOLES	10d @ 3"oc STGR	24"
(D)	CMST14	(33) 10d	10d @ 3 1/2"oc STGR	FILL ALL NAIL HOLES	10d @ 3 1/2"oc STGR	32"
(E)	CMST12	(43) 10d	10d @ 3 1/2"oc STGR	FILL ALL NAIL HOLES	10d @ 3 1/2"oc STGR	48"

1. CASE 1 APPLIES UNLESS END LENGTH (EL) IS NOTED ON PLANS. WHERE END LENGTH (EL) IS NOTED, SEE CASE 2.

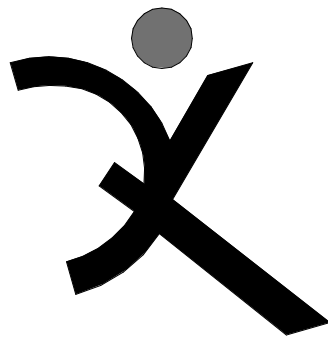

QUATTROCCHI KWOK  
ARCHITECTS

Main:  
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East Bay:  
55 Harrison Street, Suite 525  
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FREEDOM HIGH  
SCHOOL

NEW AUXILIARY  
GYMNASIUM

1050 NEROLY RD,  
OAKLEY, CA 94561

LIBERTY UNION HIGH  
SCHOOL DISTRICT

REVISIONS

NO.	DESCRIPTION	DATE

DSA APP NO. 01-119278

ZFA NO: 20315  
ENGR / PM: KNC / DLD  
DRAWING SCALE: As indicated  
PTN: 61721-78 FILE NO: 7-H4

BID DOCUMENT

APRIL 27, 2021


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ELEVATIONS

SHEET NUMBER


S-M3.1



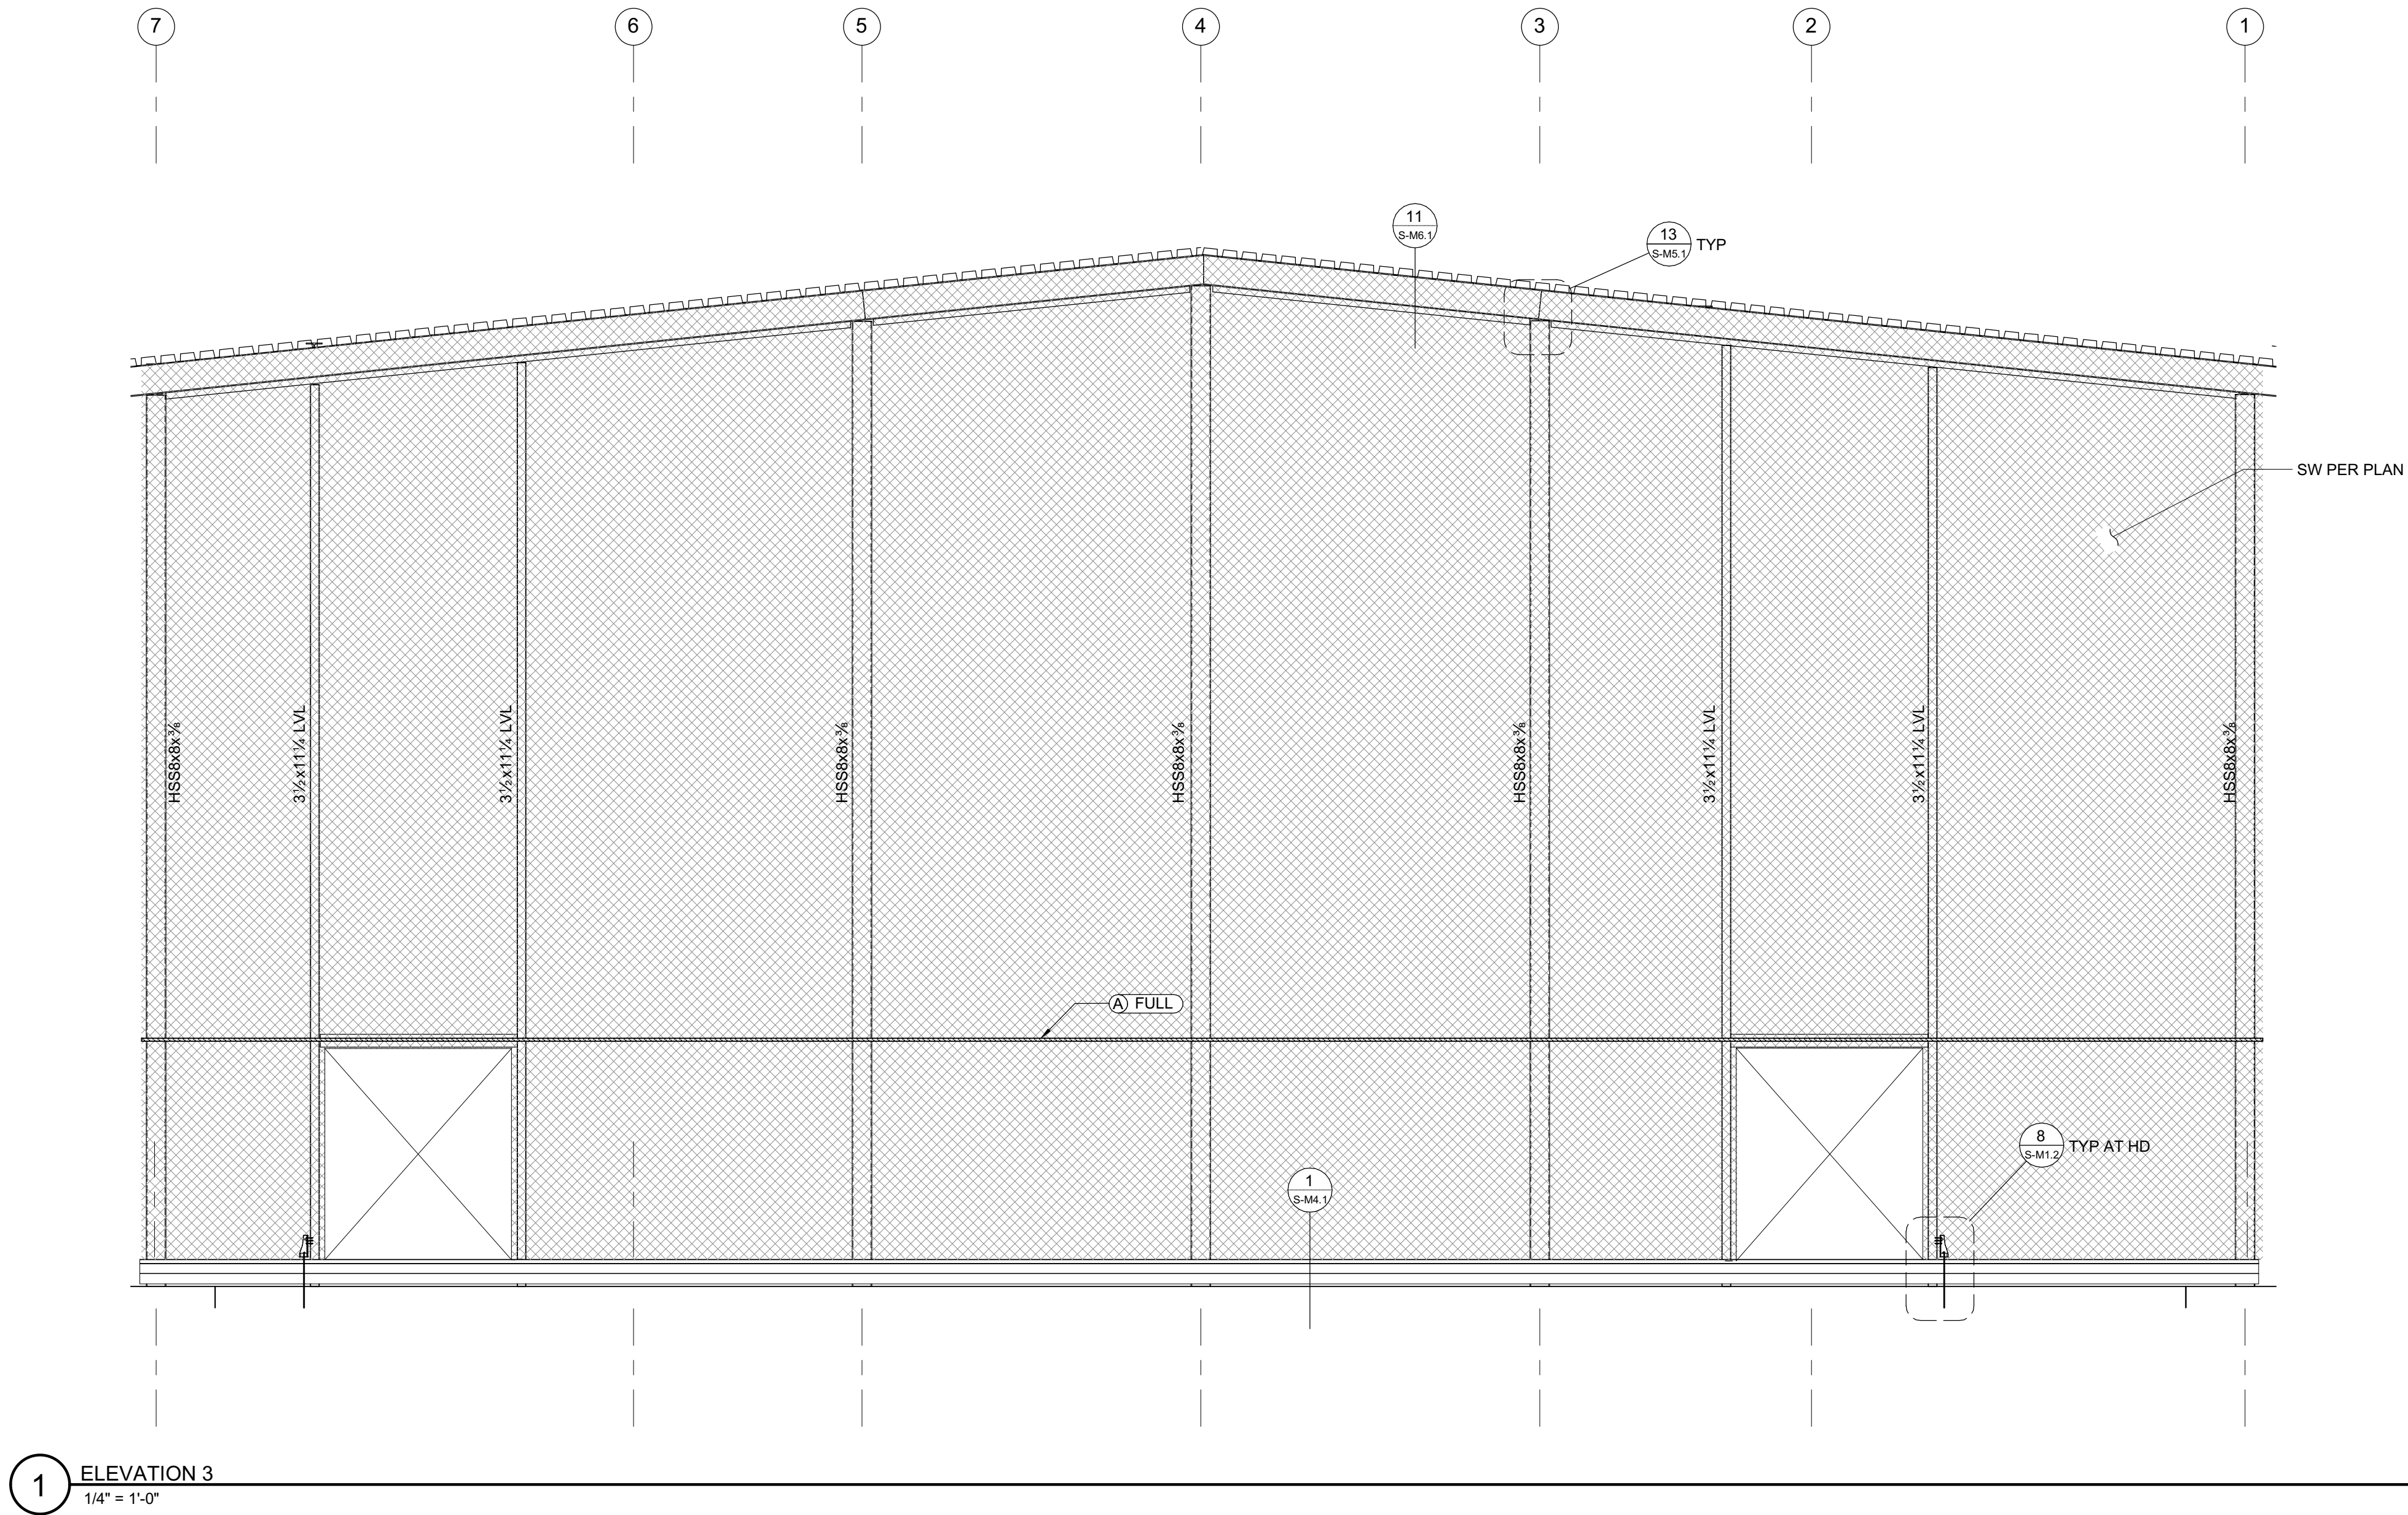

TIE STRAP SCHEDULE						
MARK	STRAP	MIN. NAILING ES OF *	MAX. NAIL SPACING (SEE NOTES #1 & #2)			MIN. END LENGTH (EL)
			CASE 1	CASE 2		
				EL	RL	
(A)	CS16	(10) 10d	10d @ 4"oc STGR	FILL ALL NAIL HOLES	10d @ 4"oc STGR	12"
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(E)	CMST12	(43) 10d	10d @ 3 1/2"oc STGR	FILL ALL NAIL HOLES	10d @ 3 1/2"oc STGR	48"

1. CASE 1 APPLIES UNLESS END LENGTH (EL) IS NOTED ON PLANS. WHERE END LENGTH (EL) IS NOTED, SEE CASE 2.

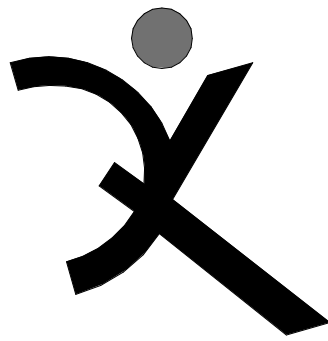

**QUATTROCCHI KWOK ARCHITECTS**  
Main:  
636 Fifth Street, Santa Rosa, CA 95404  
East Bay:  
55 Harrison Street, Suite 525  
Oakland, CA 94607  
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**FREEDOM HIGH SCHOOL**

**NEW AUXILIARY GYMNASIUM**

1050 NEROLY RD,  
OAKLEY, CA 94561

**LIBERTY UNION HIGH SCHOOL DISTRICT**

REVISIONS		

DSA APP NO. 01-119278

ZFA NO: 20315  
ENGR / PM: KNC / DLD  
DRAWING SCALE: As indicated  
PTN: 61721-78 FILE NO: 7-H4

**BID DOCUMENT**  
**APRIL 27, 2021**  
SHEET TITLE

**ELEVATIONS**

SHEET NUMBER

**S-M3.2**














11 HSS COLUMN AT BEAM  
3/4" = 1'-0"

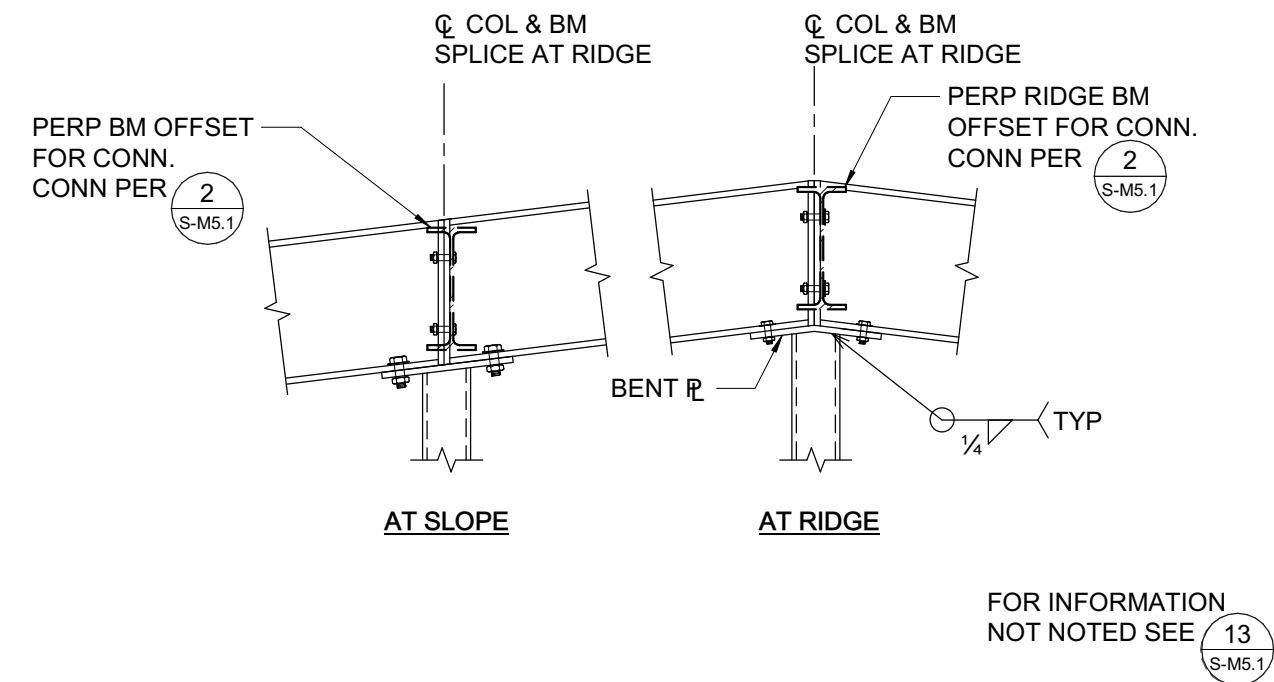


7 TRUSS SPLICE OPTION  
3/4" = 1'-0"

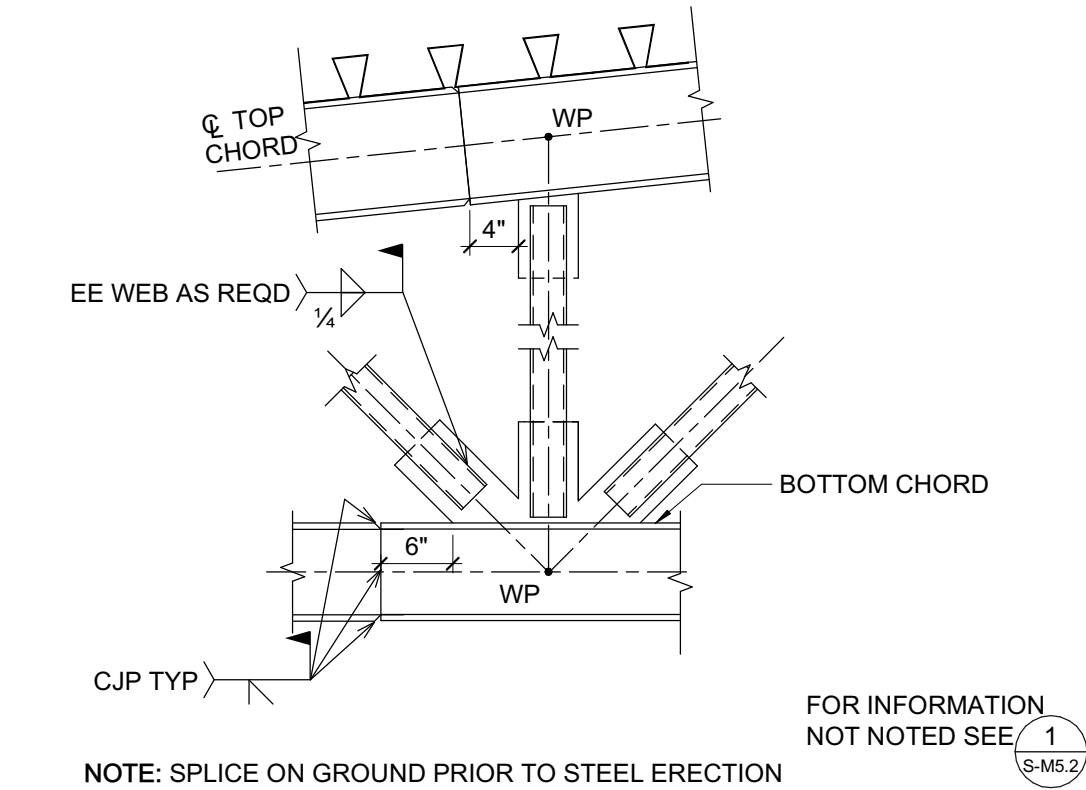

8 TRUSS TO COLUMN CONNECTION  
3/4" = 1'-0"

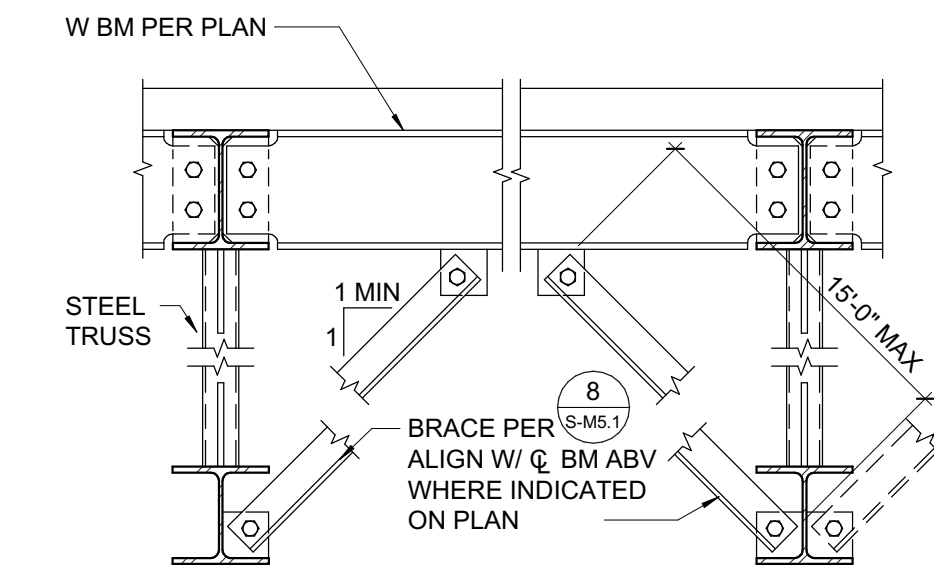


9 BRACING AT STEEL TRUSS  
3/4" = 1'-0"

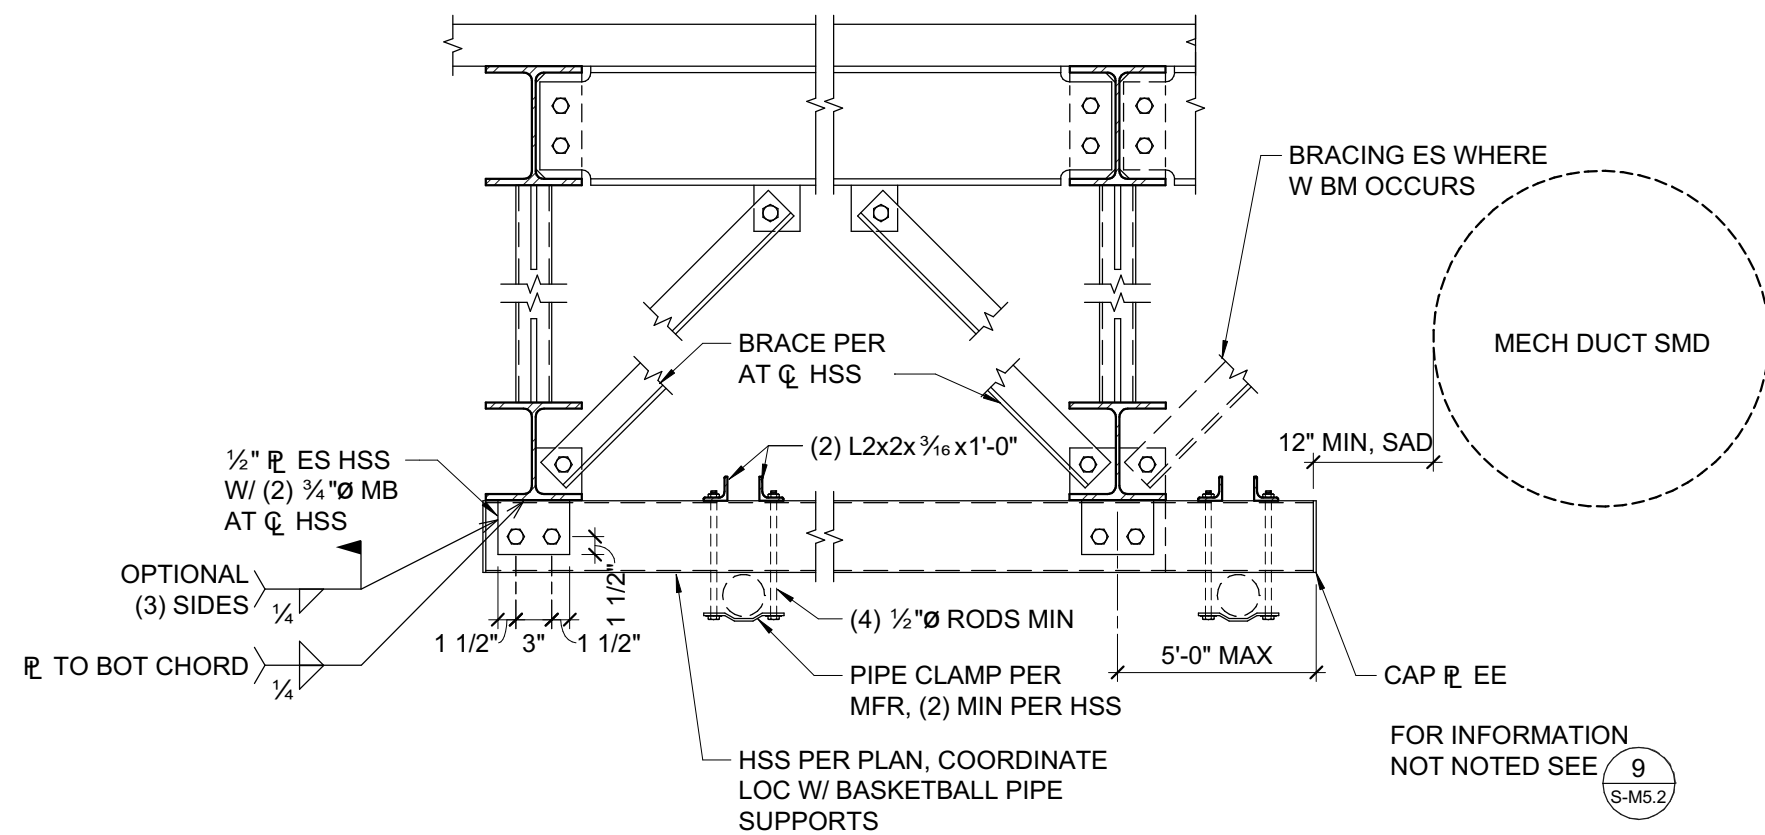


10 BASKETBALL BACKBOARD SUPPORT  
3/4" = 1'-0"




4 TRUSS WEB TO CHORD CONNECTION  
3/4" = 1'-0"

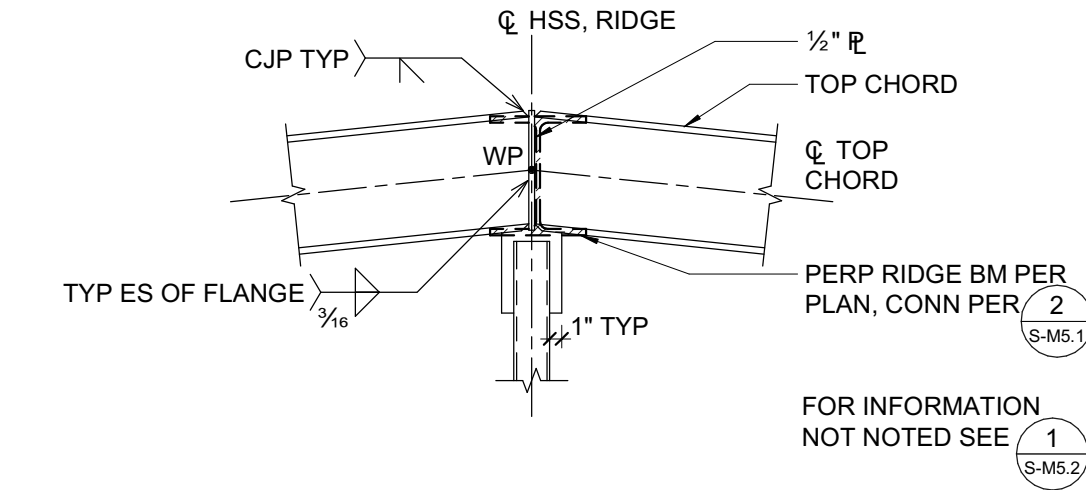


5 TRUSS TO COLUMN CONNECTION  
3/4" = 1'-0"

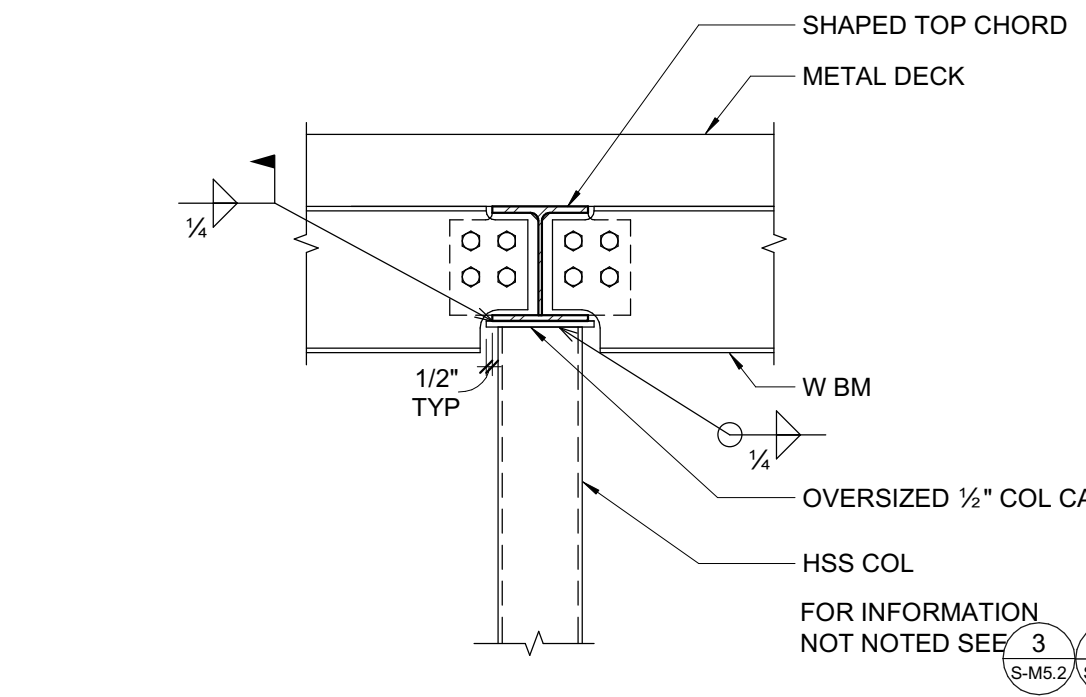


6 DIVIDER CURTAIN ATTACHMENT  
1" = 1'-0"

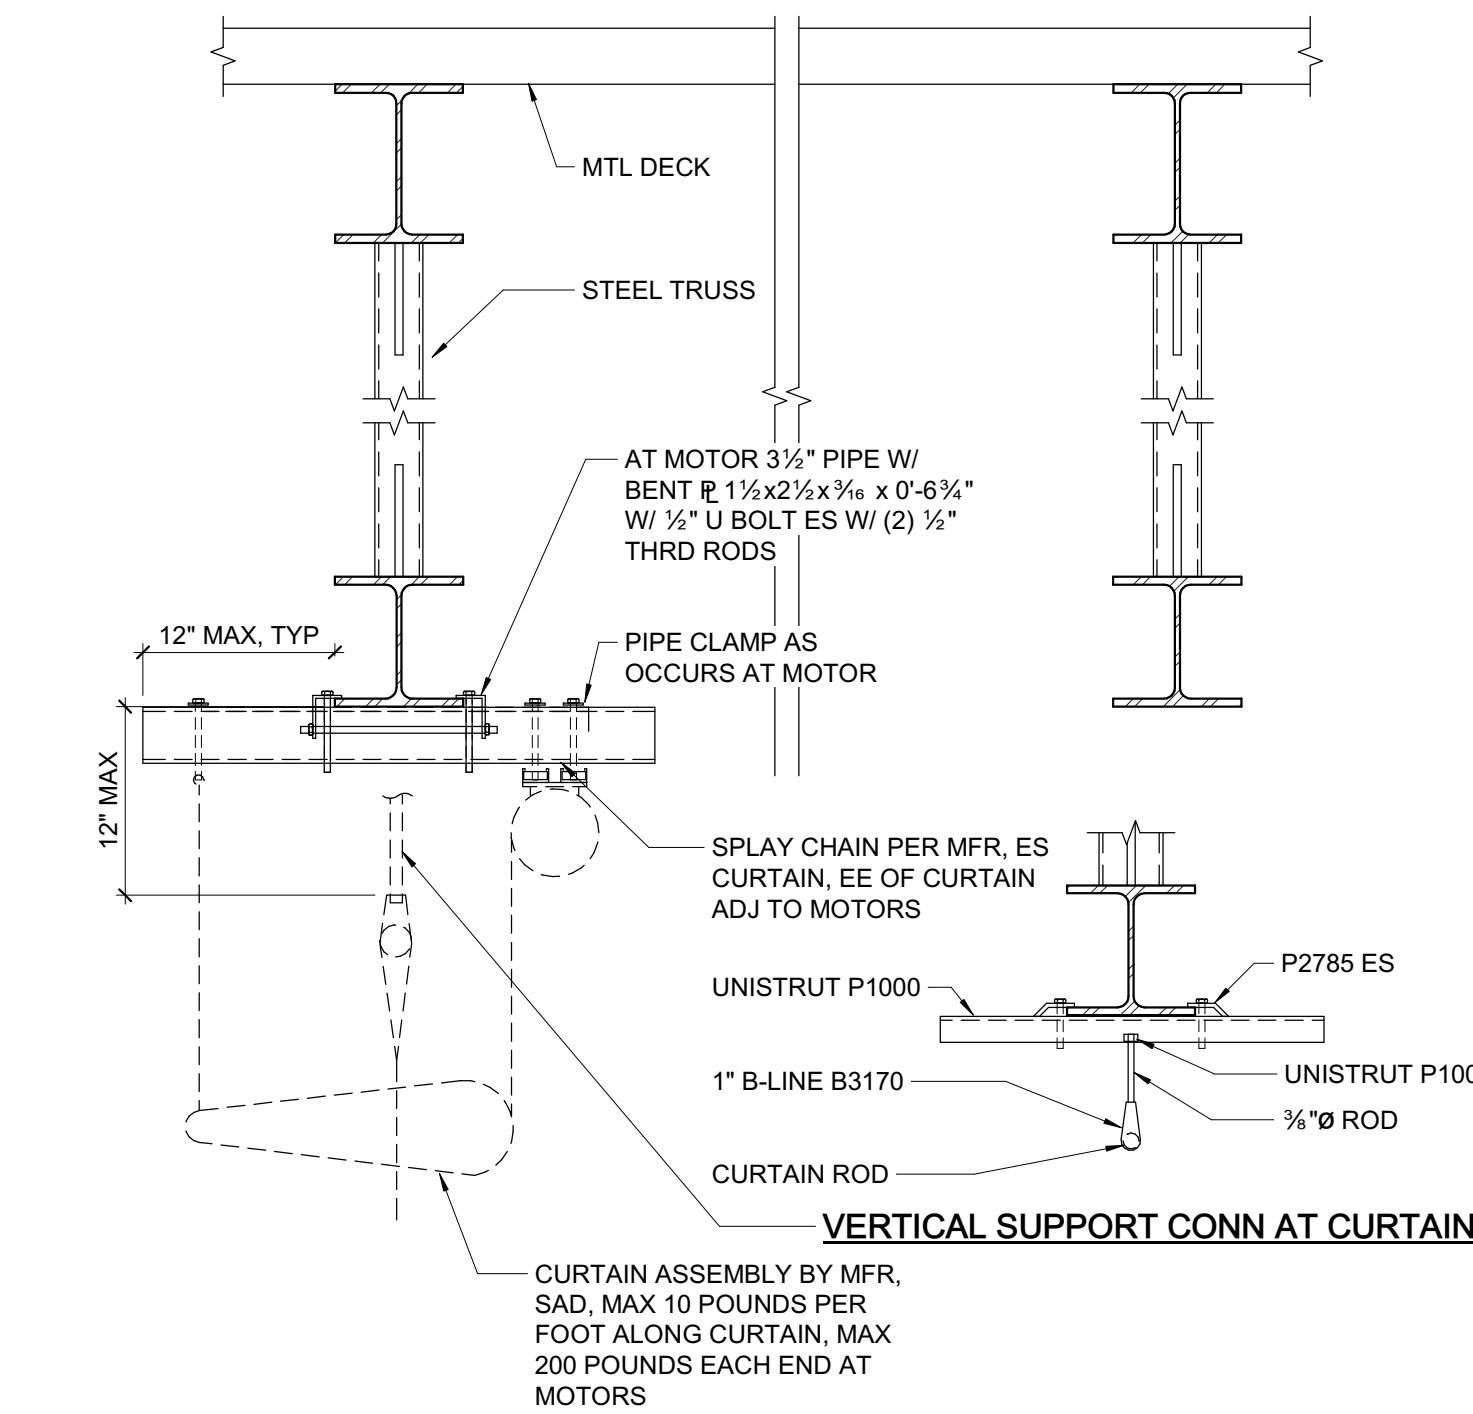



3 TRUSS TO COLUMN CONNECTION  
3/4" = 1'-0"

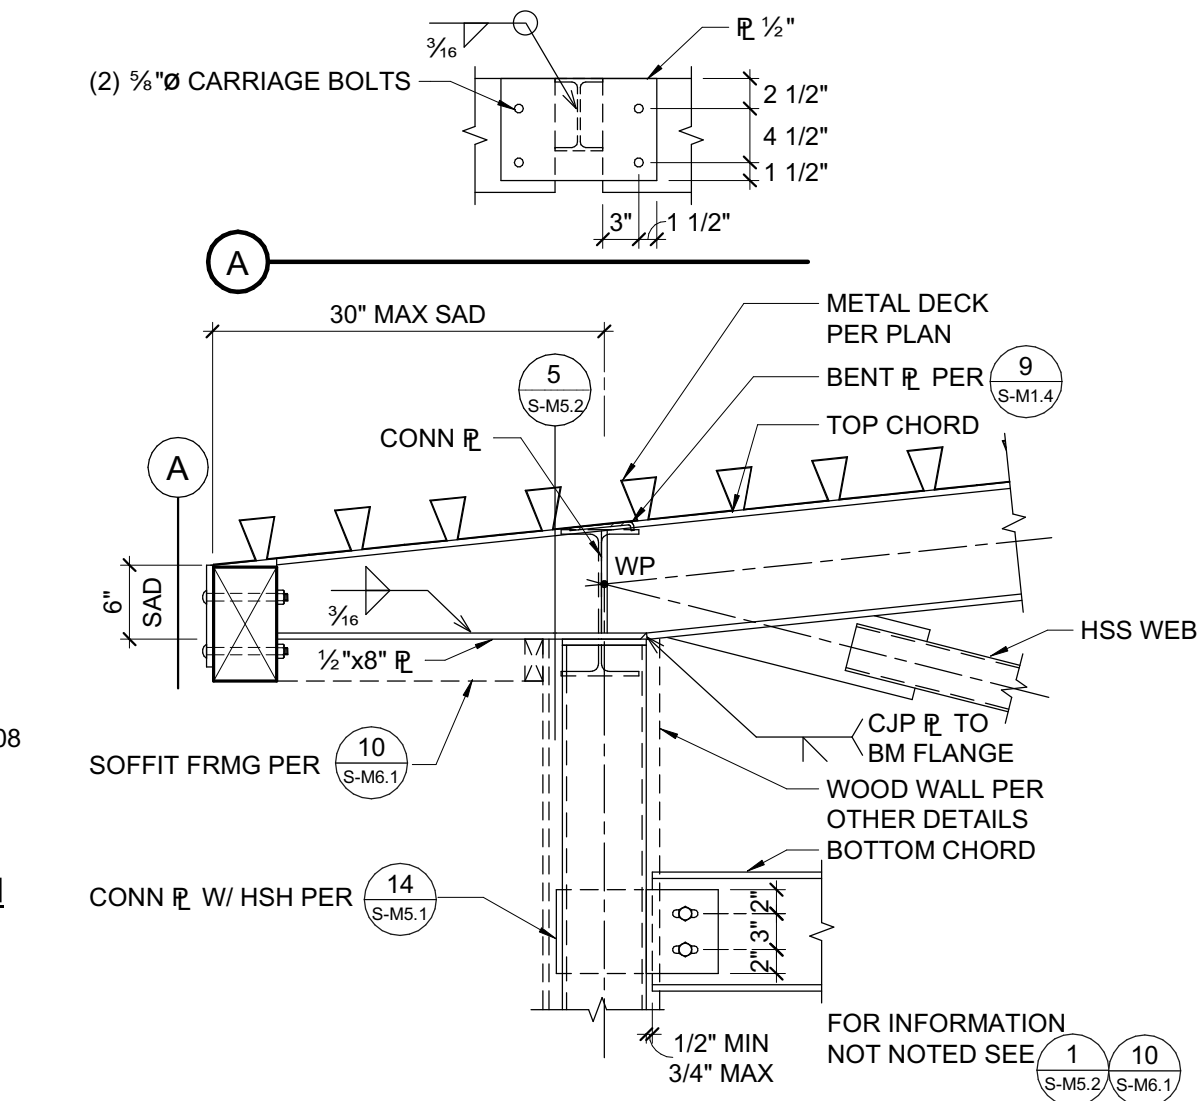

1 TRUSS WEB TO CHORD CONNECTION  
3/4" = 1'-0"

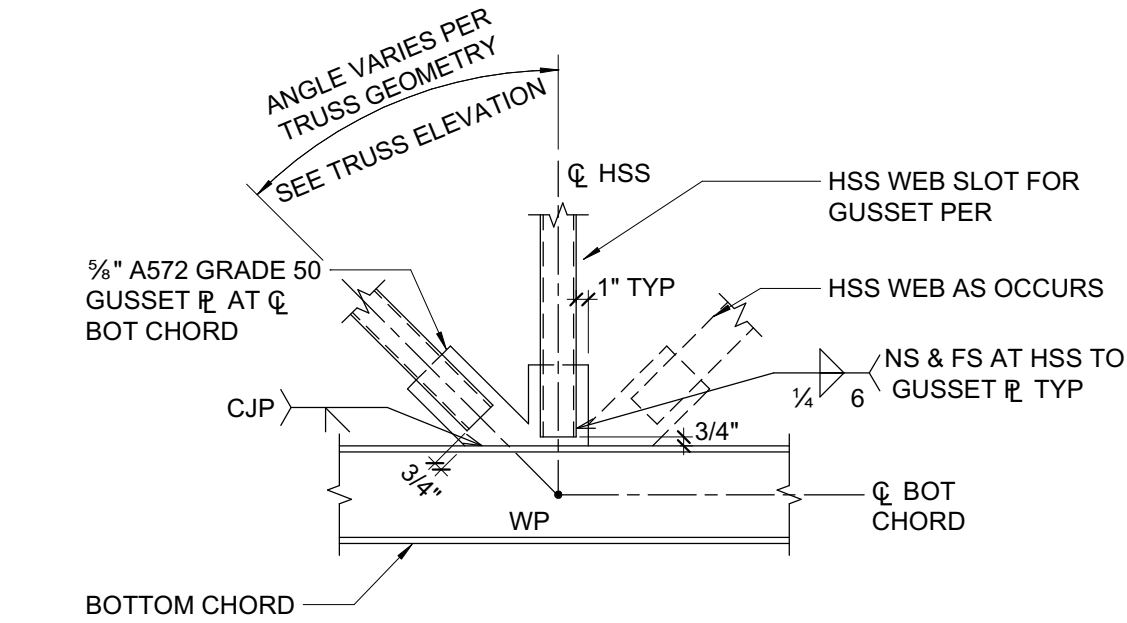


2 TRUSS WEB TO CHORD CONNECTION  
3/4" = 1'-0"

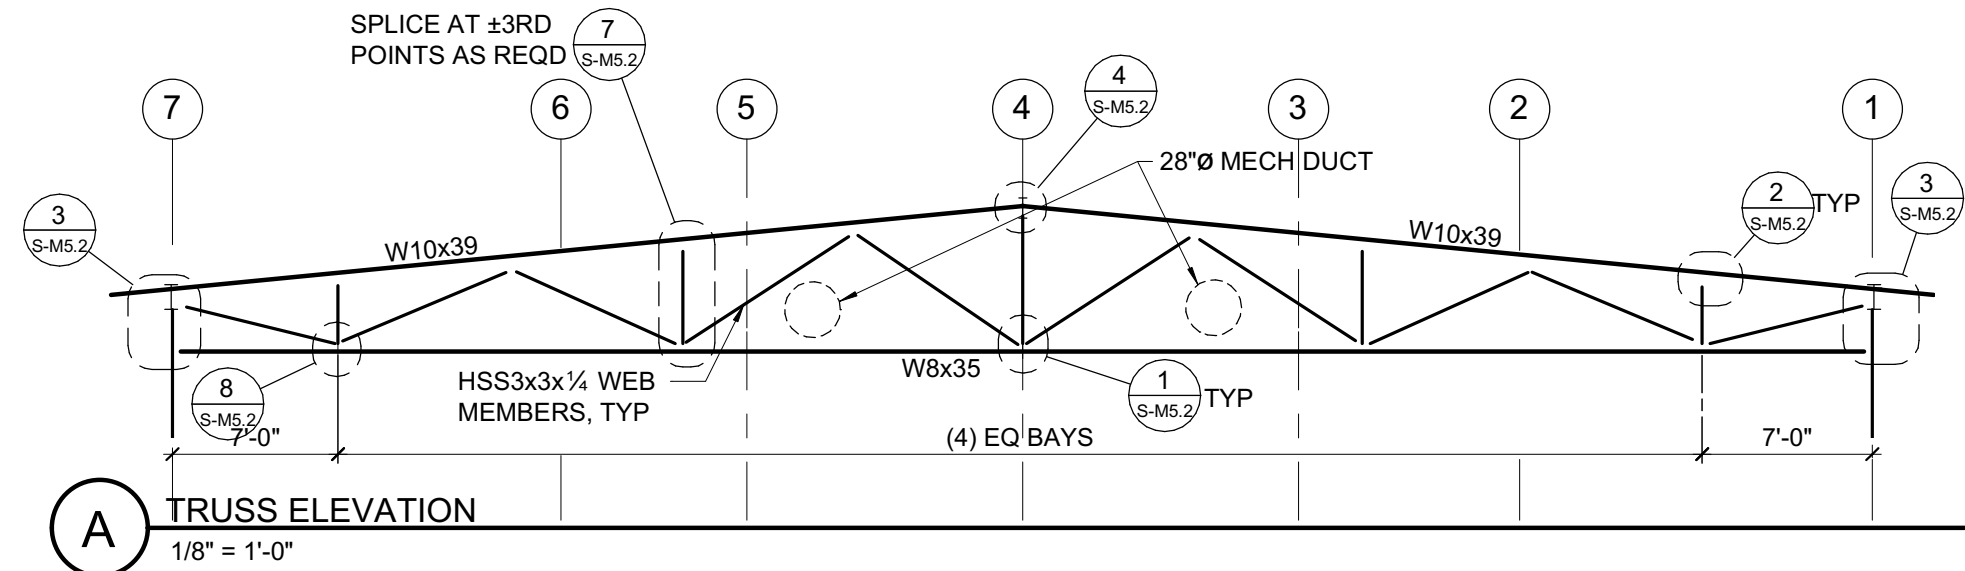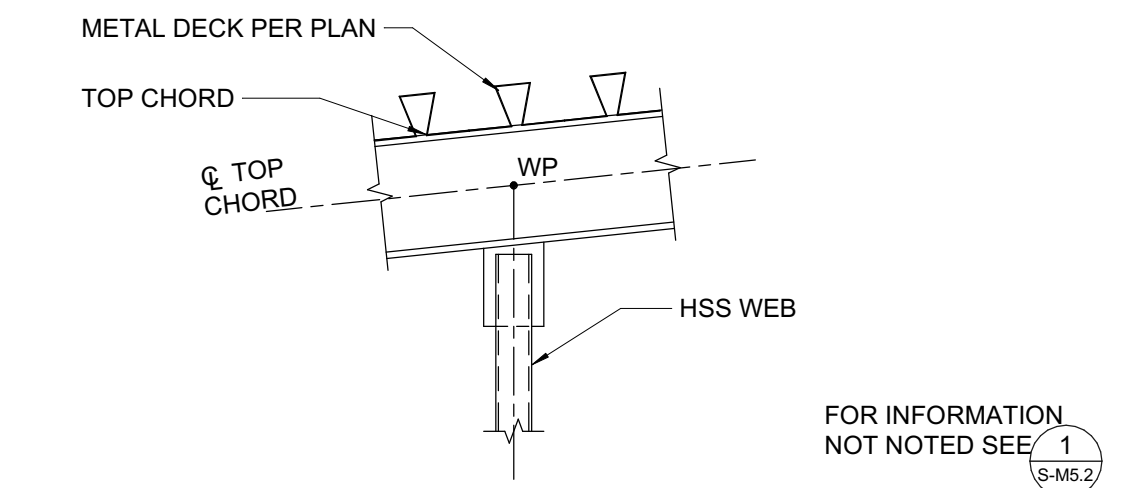

REVISIONS		



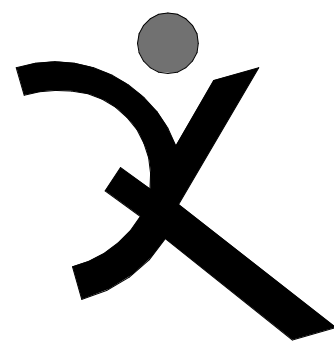

QUATTROCCHI KWOK  
ARCHITECTS

Main:  
636 Fifth Street, Santa Rosa, CA 95404  
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## FREEDOM HIGH SCHOOL

## NEW AUXILIARY GYMNASIUM

1050 NEROLY RD,  
OAKLEY, CA 94561

## LIBERTY UNION HIGH SCHOOL DISTRICT

### REVISIONS

NO.	DESCRIPTION	DATE

DSA APP NO. 01-119278

ZFA NO: 20315  
ENGR / PM: KNC / DLD  
DRAWING SCALE: 3/4" = 1'-0"  
PTN: 61721-78 FILE NO: 7-H4

### BID DOCUMENT


APRIL 27, 2021

SHEET TITLE


## WOOD DETAILS

SHEET NUMBER


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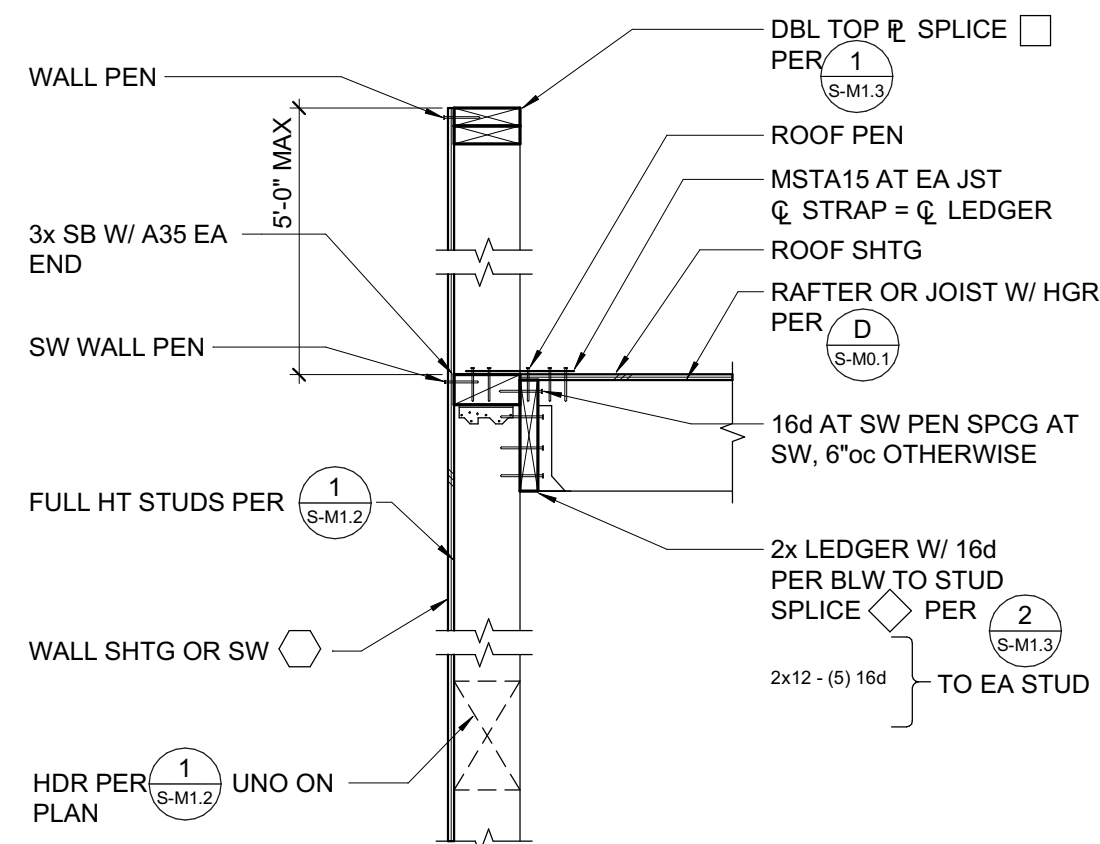
12 LEDGER SPLICE AT BEAM  
3/4" = 1'-0"

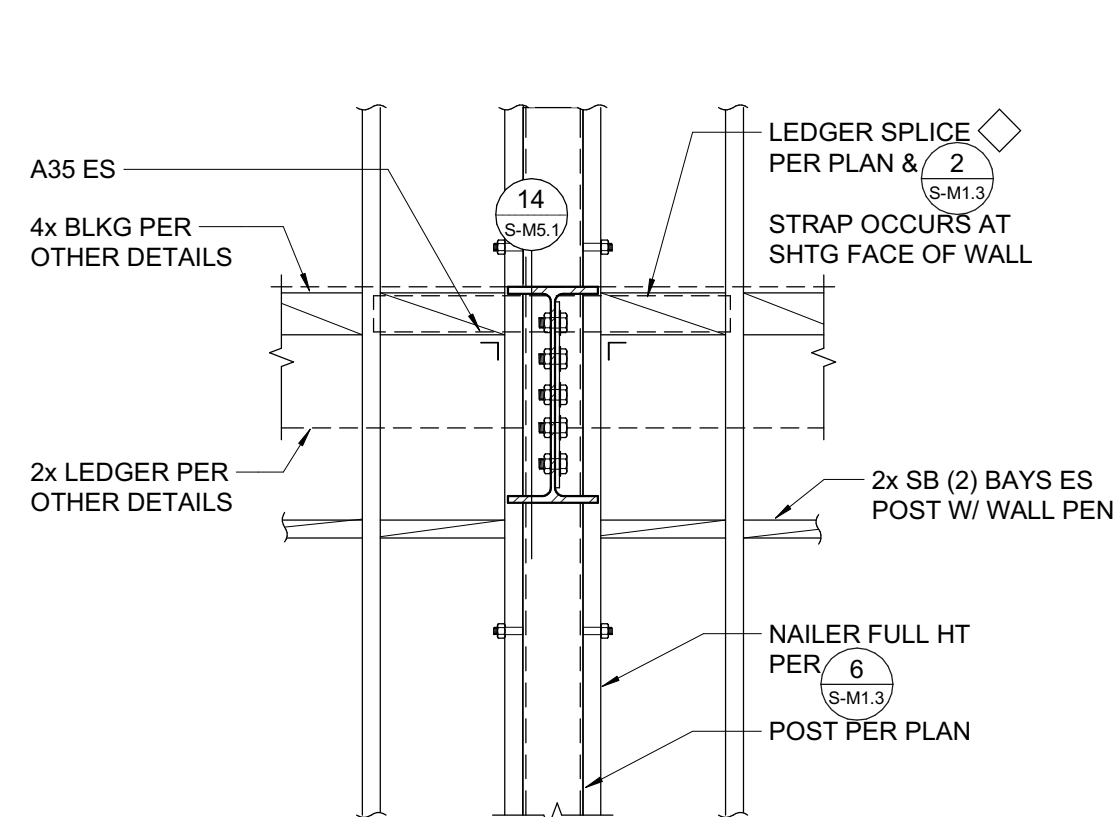


9 TOP PLATE TIE AT HSS COLUMN  
3/4" = 1'-0"

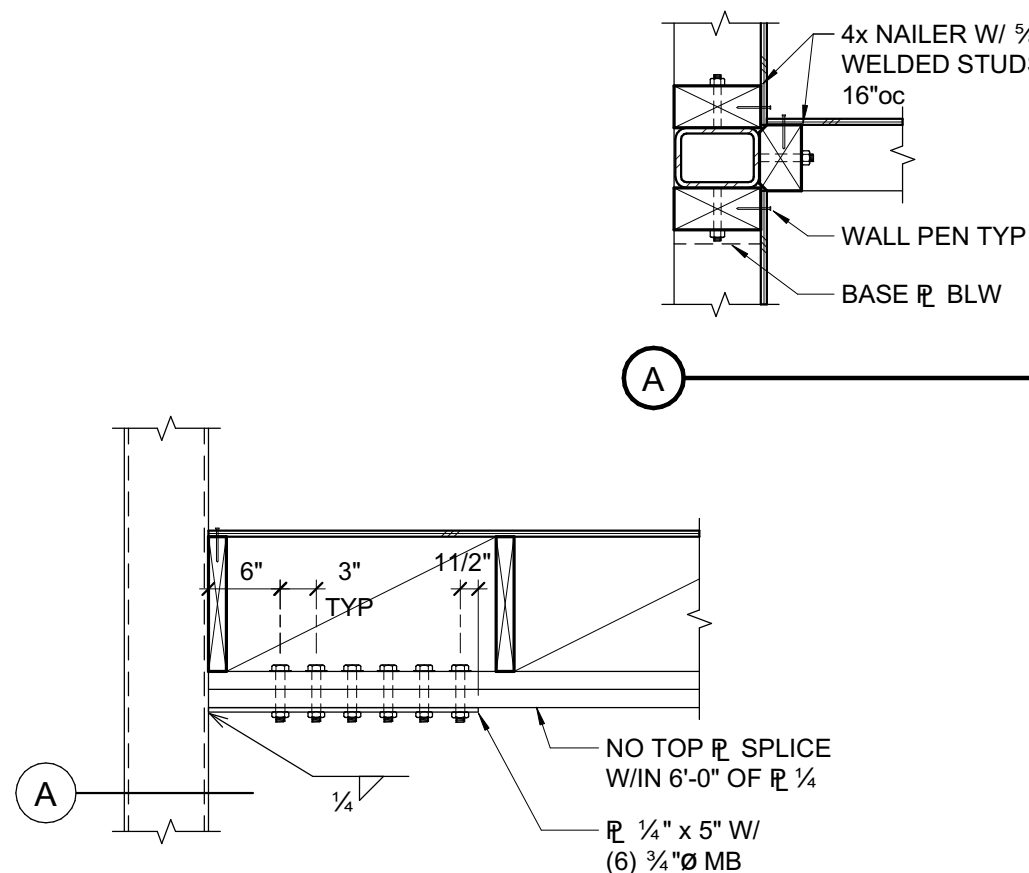


5 LEDGER AT EXTERIOR SHEAR WALL  
3/4" = 1'-0"

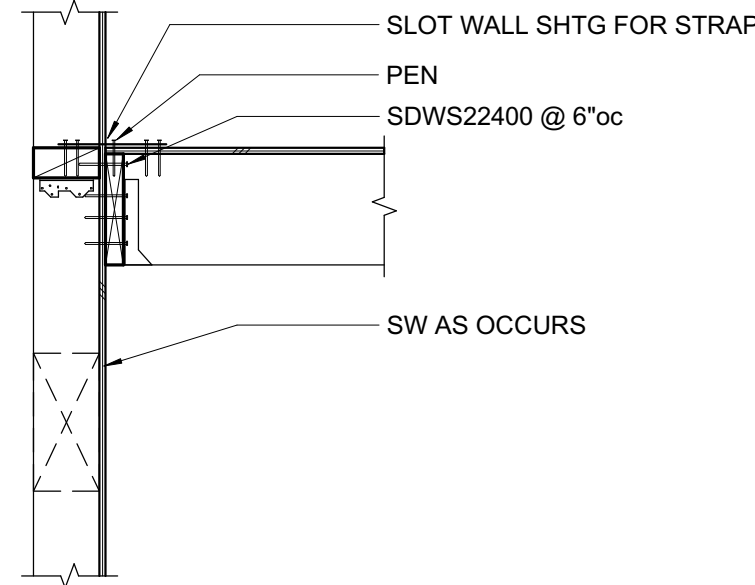


1 WALL ANCHORAGE AT EXTERIOR WALL  
3/4" = 1'-0"

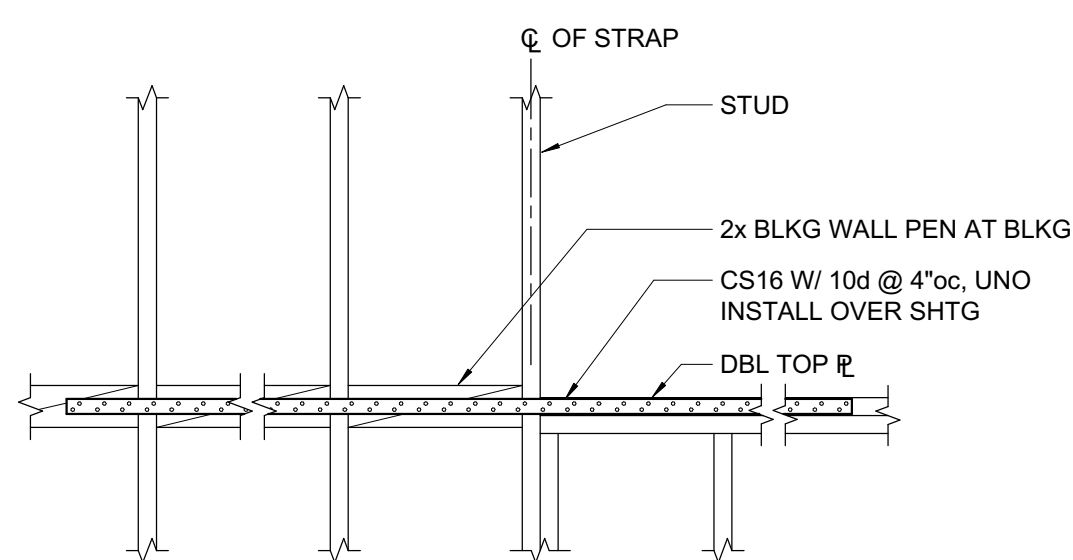


13 STRAP TIE ELEVATION  
3/4" = 1'-0"

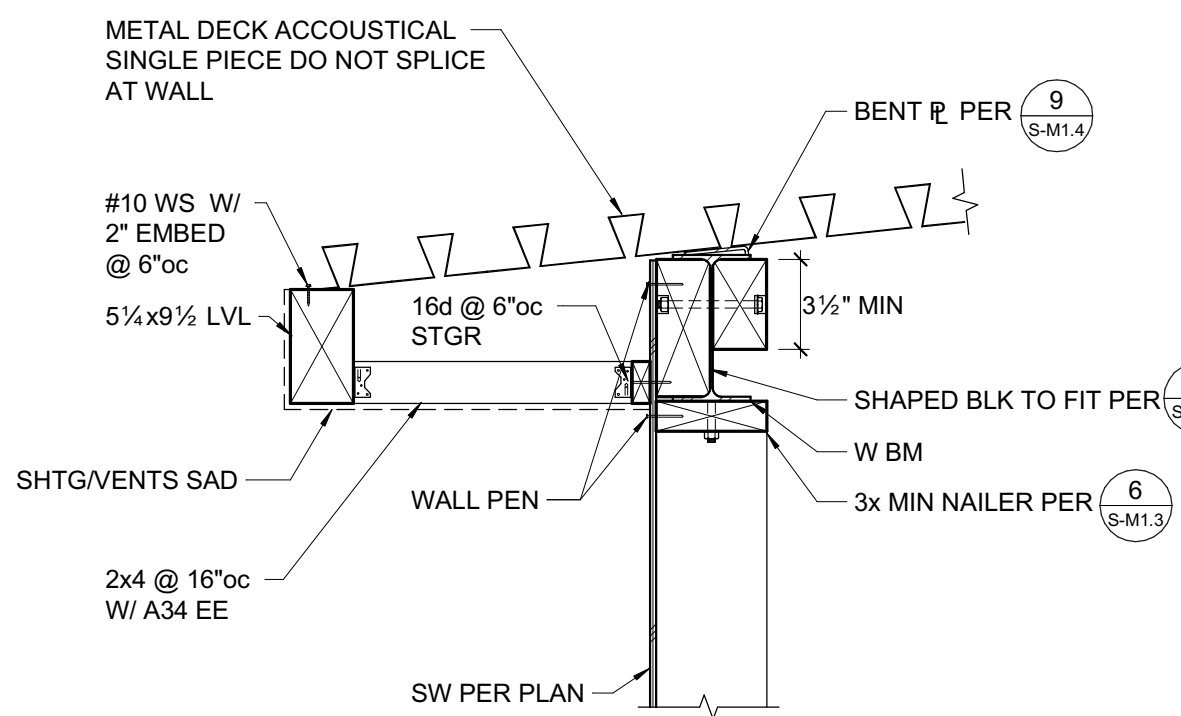


10 METAL DECK AT WOOD SHEAR WALL  
3/4" = 1'-0"

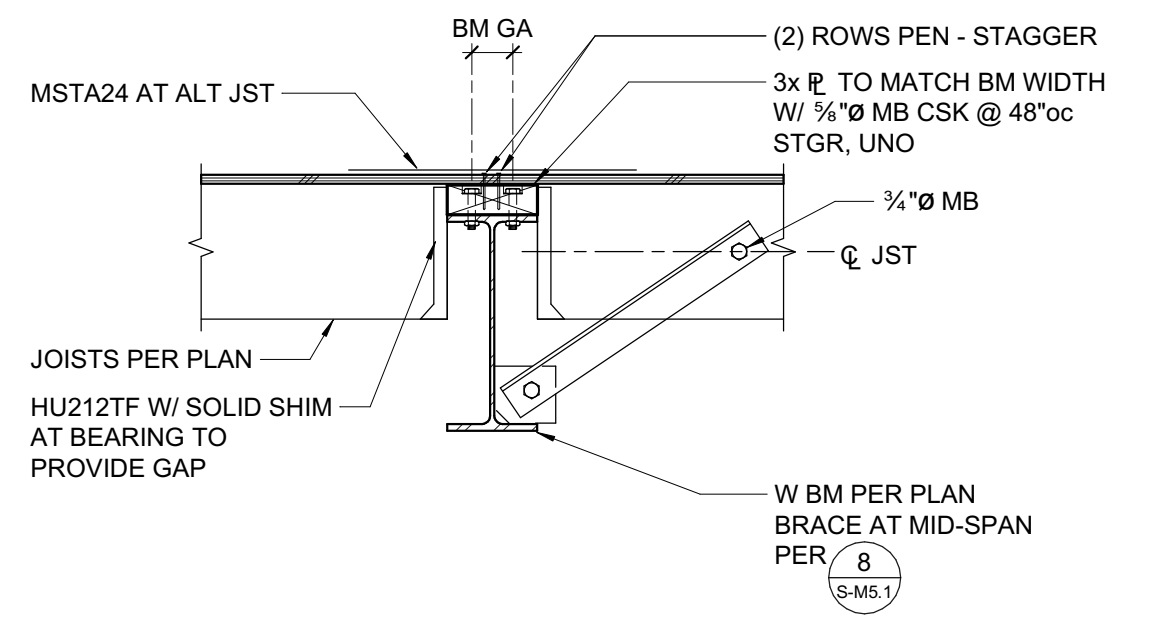


6 FRAMING AT BEAM  
3/4" = 1'-0"

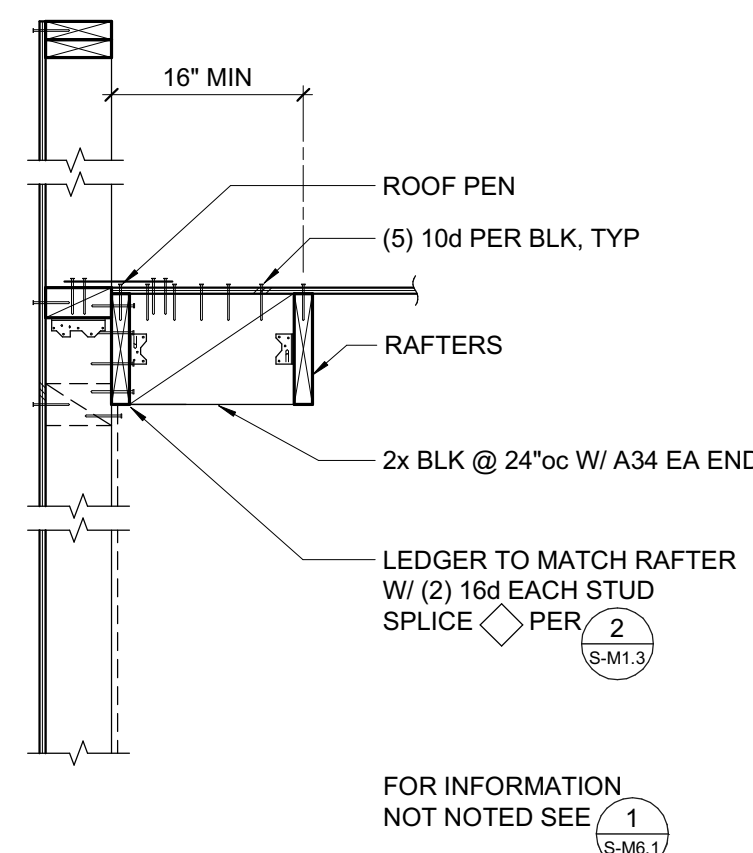


2 PARALLEL FRAMING AT EXTERIOR WALL  
3/4" = 1'-0"

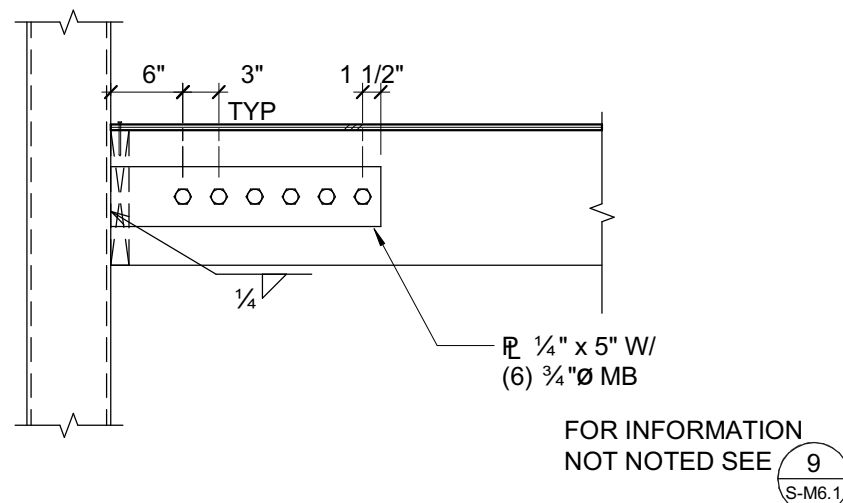


14 RAFTER TIE AT HSS COLUMN  
3/4" = 1'-0"

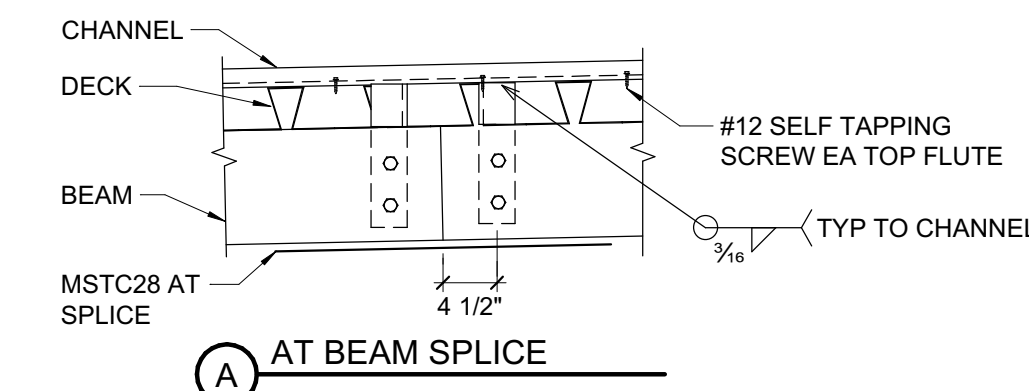


A AT BEAM SPLICE

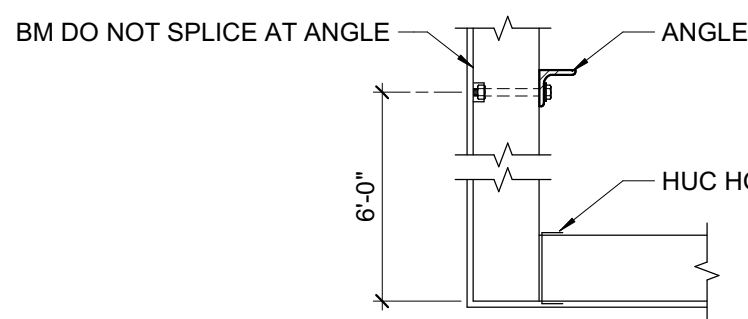


B AT CORNER

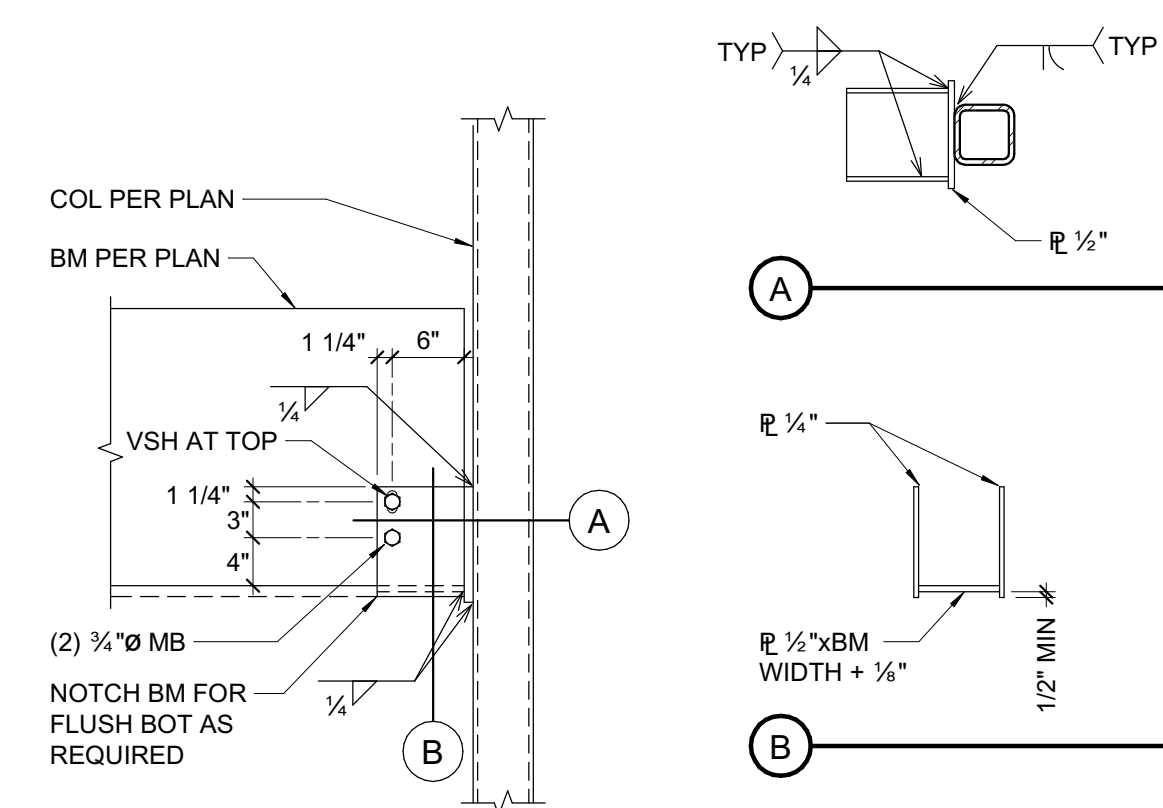


7 BEAM CONNECTION AT HSS COLUMN  
3/4" = 1'-0"

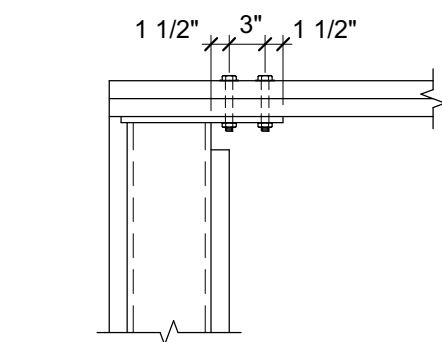


AT END OF WALL

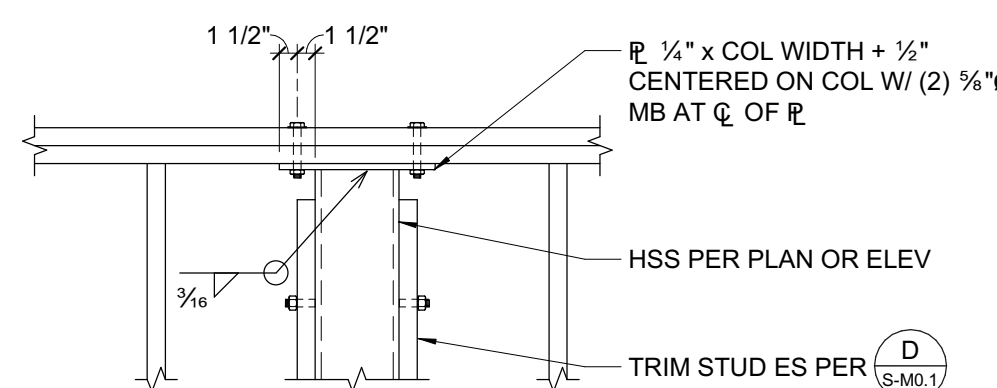

8 HSS COLUMN AT TOP PLATE  
3/4" = 1'-0"

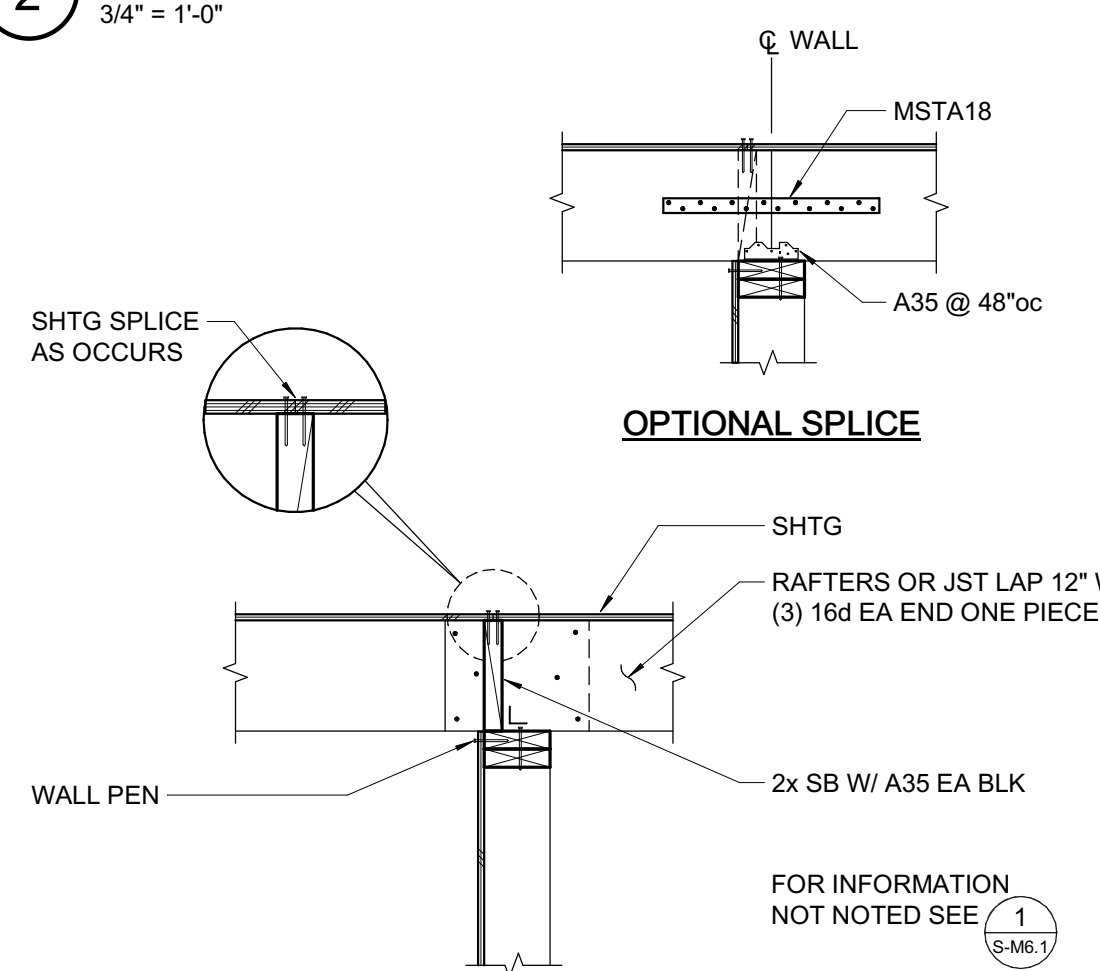

3 INTERIOR SHEAR WALL  
3/4" = 1'-0"

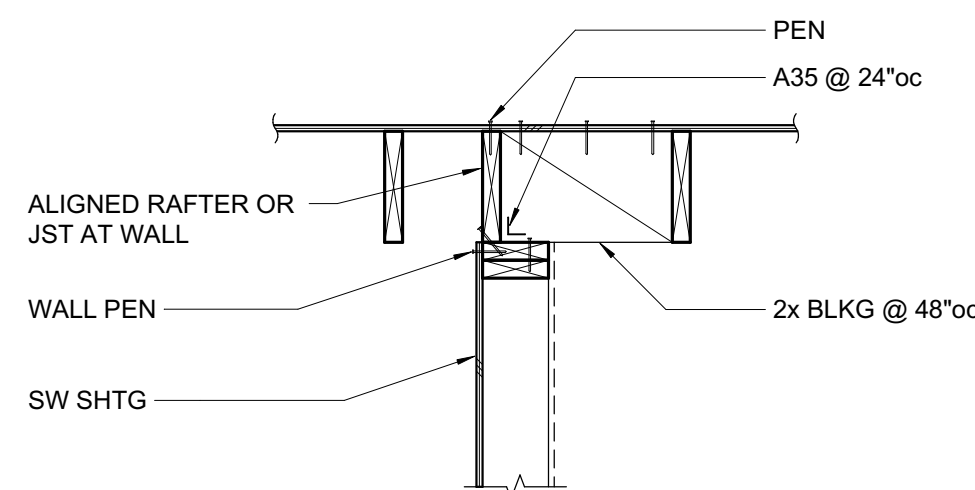

4 INTERIOR SHEAR WALL  
3/4" = 1'-0"



AC UNIT.																					
MARK	MANUFACTURER	MODEL NUMBER	UNIT SIZE TONS	SUPPLY FAN			SUPPLY FAN RPM	AIRFLOW CFM	COOLING CAPACITY			SEER	ELECTRICAL DATA			ECONOMIZER WEIGHT	UNIT WEIGHT	CURB ISOLATOR WEIGHT	TOTAL WEIGHT	SERVICE	REMARKS
				MIN O.A	MAX O.A	ESP			TOTAL COOLING (MBH)	SENSIBLE COOLING (MBH)	TOTAL HEATING (MBH)		V-Ø-Hz	MCA	MOCP						
AC-1	CARRIER	48HCDD14A3M6-0A3G0	12.5	525	1750	1.30 in-wg	821	5000	151.5	118.5	150	13.90	460-3-60	32.0	40	169	1545 lb	572	2286	AUXILIARY GYMNASIUM 101	2-8, 10
AC-2	CARRIER	48HCDD14A3M6-0A3G0	12.5	525	1750	1.30 in-wg	821	5000	151.5	118.5	150	13.90	460-3-60	32.0	40	169	1545 lb	572	2286	AUXILIARY GYMNASIUM 101	2-8, 10
AC-3	CARRIER	48GCDM06A2A6-0A0A0	5	250	600	1.00 in-wg	2251	2000	63.0	48.3	67	16.00	460-3-60	13.0	15	49	600 lb	365	1014	CLASSROOM 107	1,3-9, 11
REMARKS:																					
1. VERTICAL SUPPLY/RETURN DUCT CONFIGURATION.							6. PROVIDE WITH MICROMETL 14" HIGH BASE SPRING ISOLATION RAIL ROOF CURB. SEE DETAIL A/M-M7.1														
2. HORIZONTAL SUPPLY & VERTICAL RETURN DUCT CONFIGURATION.							8. CO2 ROOM SENSORS FOR DEMAND CONTROL VENTILATION & THERMOSTAT SEE PLANS FOR LOCATION.														
3. AUTOMATIC SHUTOFF NOT REQUIRED PER 2019 CMC608 EXEPTION 2 .							9. PROVIDE WITH BAROMETRIC RELIEF.														
4. PROVIDE WITH MERV-13 2" PLEATED FILTER.							10. PROVIDE WITH TWO STAGE HEATING INPUT 150/120 MBH, OUTPUT 120/96 MBH														
5. PROVIDE WITH MICROMETL MODULATING ECONOMIZER WITH DRY BULB TEMPERATURE CONTROL.							11. PROVIDE WITH TWO STAGE HEATING INPUT 67/50 MBH, OUTPUT 54/40 MBH														

SPLIT SYSTEM INDOOR UNIT													
MARK	MFR	MODEL	AIRFLOW	ELECTRICAL DATA			RATED HEATING	SENSIBLE COOLING	RATED MAX COOLING	FILTER	WEIGHT	SERVICE	REMARKS
				V-Ø-HZ	MCA	MOCP							
FC-1	DAIKIN	FFQ09Q2VJU	378 CFM	SEE OUTDOOR UNIT			10000.0 Btu/h	7990.0 Btu/h	11100.0 Btu/h	WASHABLE	36 lb	OFFICE 103	2-5
FC-2	DAIKIN	FTXS18LVJU	484 CFM	SEE OUTDOOR UNIT			21600.0 Btu/h	18000.0 Btu/h	14790.0 Btu/h	WASHABLE	31 lb	ELECTRICAL RM	2-4,6
FC-3	DAIKIN	FTXB09AXVJU	330 CFM	SEE OUTDOOR UNIT			9400.0 Btu/h	7677.0 Btu/h	8800.0 Btu/h	WASHABLE	20 lb	AV RACK IN STORAGE	1-4,6
REMARKS:													
1. HIGH TEMPERATURE ALARM NU-TEMP NU-30 BY PAL PRODUCTS, SET AT 90F.							6. WALL MOUNT FAN COIL MOUNT PER DETAIL F/M-M7.1						
2. SEE B/M-M8.1 FOR CONTROL DIAGRAM													
3. PROVIDE WITH PELICAN CONTROLS WIRELESS THERMOSTAT.													
4. PROVIDE INDIVIDUAL POWER TO ONE (1)OUTDOOR UNIT.													
5. CEILING CASSETT MOUNT PER DETAIL C/M-M7.1													

SPLIT SYSTEM OUTDOOR UNIT									
MARK	MFR.	MODEL NO.	EER	ELECTRICAL DATA			WEIGHT	SERVICE	REMARKS
				V-Ø-HZ	MCA	MOCP			
HP-1	DAIKIN	RX09RMVJU	13	208-1-60	9	15	60	FC 1	1-7
HP-2	DAIKIN	RXS18LVJU	12.7	208-1-60	13.75	20	104	FC 2	1-7
HP-3	DAIKIN	RXB09AXVJU	11	208-1-60	7	15	53	FC 3	1-7
REMARKS:									
1. COORDINATE WITH FAN COIL UNIT.				6. PROVIDE WITH R-410A REFRIGERANT					
2. BALL BEARING FAN MOTOR.				7. MOUNT ON ROOF PER DETAIL BIM-M7.1					
3. COMPRESSOR START ASSIST CAPACITOR AND RELAY.									
4. FREEZE-STAT.									
5. LOW-AMBIENT PRESSURE SWITCH AND WINTER START CONTROL.									

EXHAUST FAN SCHEDULE												
MARK	MFR	MODEL NO	AIRFLOW	FAN RPM	INLET SONES	ELECTRICAL DATA				WEIGHT	SERVICE	REMARKS
						MOTOR HP	OPER. HP	WATTS	V-Ø-Hz			
EF 1	PANASONIC	FV-0511VKS2	80 CFM	795	0.3	-		10 W	120-1-60	11.90 lb	JAN 104	1-3
EF 2	PANASONIC	FV-0511VKS2	80 CFM	795	0.3	-		10 W	120-1-60	11.90 lb	UBISEX TOILET 106	1-3
EF 3	PANASONIC	FV-0511VKS2	80 CFM	795	0.3	-		10 W	120-1-60	11.90 lb	UBISEX TOILET 105	1-3
REMARKS:												
1. INTERLOCK WITH LIGHT SWITCH (BY ELEC.)												
2. PROVIDE OEM ACCESSORY OCCUPANCY SENSOR.												
3. EXHAUST MOUNTED PER DETAIL E/M-M7.1												

Mechanical Ventilation.					
ROOM #	ROOM NAME	SF	Occupant Density (People per 1000 sq.ft.)	ASHRAE 62.1 OCCUPANCY	DESIGN OSA
101	AUXILIARY GYMNASIUM	6946	100	62-Educational Facilities - Multiuse Assembly	3500
102	HALLWAY	132	0	62-General - Corridor	0
103	OFFICE	95	5	62-Office Buildings - Office Space	25
107	CLASSROOM	1564	35	62-Educational Facilities - Classrooms Age 9 Plus	600

Applicable Code: 2019 CBC

02/05/2020

Revised: 02/14/2020

MEP Componet Anchorage Note

All mechanical, plumbing, and electrical components shall be anchored and installed per the details on the DSA-approved construction documents. The following components shall be anchored or braced to meet the force and displacement requirements prescribed in the 2019 CBC Sections 1617A.1.18 through 1617A.1.26 and ASCE 7-16 Chapters 13, 26, and 30:

- All permanent equipment and components.
- Temporary, movable or mobile equipment that is permanently attached (e.g, hard wired) to the building utility services such as electricity, gas or water. "Permanently attached" shall include all electrical connections except plugs for 110/220 volt receptacles having a flexible cable.
- Temporary, movable or mobile which is heavier than 400 pounds or has a center of mass located 4 feet or more above the adjacent floor or roof level that directly support the component is required to be restrained in a manner approved by DSA.

The following mechanical and electrical components shall be positively attached to the structure but need not demonstrate design compliance with the references noted above. These components shall have flexible connections provided between the component and associated ductwork, piping, and conduit. Flexible connections must allow movement in both trasverse and longitudinal directions:

- Components weighing less than 400 pounds and having a center of mass located 4 feet or less above the adjacent floor or roof level that directly support the component.
- Components weighing less than 20 pounds, or in the case of distributed systems, less than 5 pounds per foot, which are suspended from a roof or floor or hung from a wall.

The anchorage of all mechanical, electrical and plumbing components shall be subject to the approval of the design professional in general responsible charge of strctural engineer delegated responsibility and acceptance by DSA. The project inspector will verify that all components and equipment have been anchored in accordance with the above requirements.

Piping, Ductwork, and Electrical Distribution System Bracing Note

Piping, ductwork, and electrical distribution systems shall be braced to comply with the forces and displacements prescribed in ASCE 7-16 Section 13.3 as defined in ASCE 7-16 Sections 13.6.5, 13.6.6, 13.6.7, 13.6.8; and 2019 CBC, Sections 1617A.1.24, 1617A.1.25 and 1617A.1.26.

The method of showing bracing and attachments to the structure for the identified distribution system are as noted below. When bracing and attachments are based on a preapproved installation guide ( e.g., OSHPD OPM for 2013 CBC or later), copies of the bracing system installation guide or manual shall be available on the jobsite prior to the start of and during the haging and bracing of the distribution systems. The Structural Engineer of Record shall verify the adequacy of the structure to support the hanger and brace loads.

Mechanical Piping (MP), Mechanical Ducts (MD), Plumbing Piping (PP), Electrical Distribution Systems (E):

MP ☐ MD ☐ PP ☐ E ☐

Option 1: Detailed on the approved drawings with project specific notes and details

MP ☒ MD ☒ PP ☐ E ☐ Option 2: Shall comply with the applicable OSHPD Pre-Approval (OPM #) #OPM-0043-13

## MECHANICAL LEGEND


SYMBOL	ABBREVIATION	DESCRIPTION
		EQUIPMENT TYPE EQUIPMENT NUMBER
		DETAIL / DRAWING NUMBER SHEET NUMBER
	SA OR OA	SECTION THRU SUPPLY AIR OR OUTSIDE AIR DUCT
	RA	SECTION THRU RETURN AIR DUCT
	EXH	SECTION THRU EXHAUST AIR DUCT
		ROUND DUCT DOWN
	DN OR UP	SLOPE DUCT DOWN OR UP IN DIRECTION OF FLOW
	AL	ACOUSTICAL LINING
	FC	FLEXIBLE DUCT CONNECTION
	VD	VOLUME DAMPER
	FD	FIRE DAMPER
	FSD	FIRE SMOKE DAMPER
	TV	TURNING VANES
		FLEXIBLE DUCT
		45° ROUND DUCT TAKE-OFF
		45° RECTANGULAR DUCT TAKE-OFF
		90° TURN - ROUND DUCT
		90° RADIUS TURN - ROUND OR RECTANGULAR DUCT
		SQUARE TO ROUND DUCT TRANSITION
		DUCT TRANSITION
		RECTANGULAR DUCT 90° SPLIT
		THERMOSTAT @ 48" AFF TO TOP OF T-STAT, MAX
	AP	ACCESS PANEL
	POC	POINT OF CONNECTION
	UTR	UP THRU ROOF
	UIW	UP IN WALL
	BHP	BRAKE HORSEPOWER
	HP	HORSEPOWER
	SAD	SEE ARCHITECTURAL DRAWINGS
	SSD	SEE STRUCTURAL DRAWINGS
	SCD	SEE CIVIL DRAWINGS
	AFC	ABOVE FINISH CEILING

## AIR TERMINAL SCHEDULE

MANUFACTURER: TITUS  
(EXCEPT AS NOTED)

S-DL		DRUM LOUVER	S-DL (SV) - ROTATING DRUM WITH CURVED FRAME. HORIZONTAL BLADES, WITH AIR SCOOP VOLUME EXTRACTOR - WHITE FINISH
CD-1		CEILING DIFFUSER	TDC - COMPLETE WITH EQUALIZING GRID, THROW-REDUCING VANES, STEEL CONSTRUCTION
WR		WALL RETURN GRILLE	3502ZRL - LOUVERS ON 3/4" CENTERS, STEEL CONSTRUCTION, LOUVERS PARALLEL WITH LONG DIMENSION
EG		EXHAUST GRILLE CEILING RETURN	50F - 1/2" x 1/2" x 1/2" EGGCRATE, ALUMINUM CORE WITH ALUMINUM GRID
CR		CEILING RETURN	50F - 1/2" x 1/2" x 1/2" EGGCRATE, ALUMINUM CORE WITH ALUMINUM GRID

- NOTES: 1. ADAPTER NEEDED FOR TRANSITION FROM SQUARE NECK TO ROUND DUCT.  
2. SIZE (NECK/FACE) TYPE FACE SIZE FOR T-BAR CEILING ONLY  
CFM (NO. OF THROW)

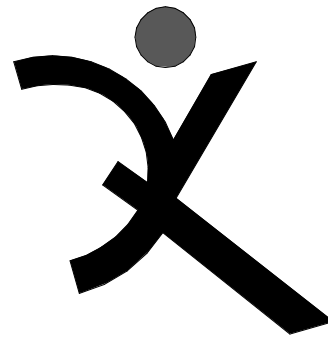

QUATTROCCHI KWOK

ARCHITECTS

Main Office:  
636 Fifth Street, Santa Rosa, CA 95404  
East Bay:  
55 Harrison Street, Suite 525,  
Oakland, CA 94607  
(707) 576-0829

SIGNED: OCTOBER 30, 2020



COSTA ENGINEERS INC.

3274 Villa Lane Suite, CA 94618 ph: 707-252-9177 fax: 707-252-0473



FREEDOM  
HIGH SCHOOL

NEW AUXILIARY  
GYMNASIUM

1050 NEROLY RD,  
OAKLEY, CA 94561

LIBERTY UNION  
HIGH SCHOOL  
DISTRICT

DSA APP NO. 01-119278

ARCH PROJECT NO: 1869.00

DRAWN BY: MQ/RE

DRAWING SCALE:

PTN: 61721-78 FILE NO: 7-H4

BID DOCUMENT

APRIL 27, 2021

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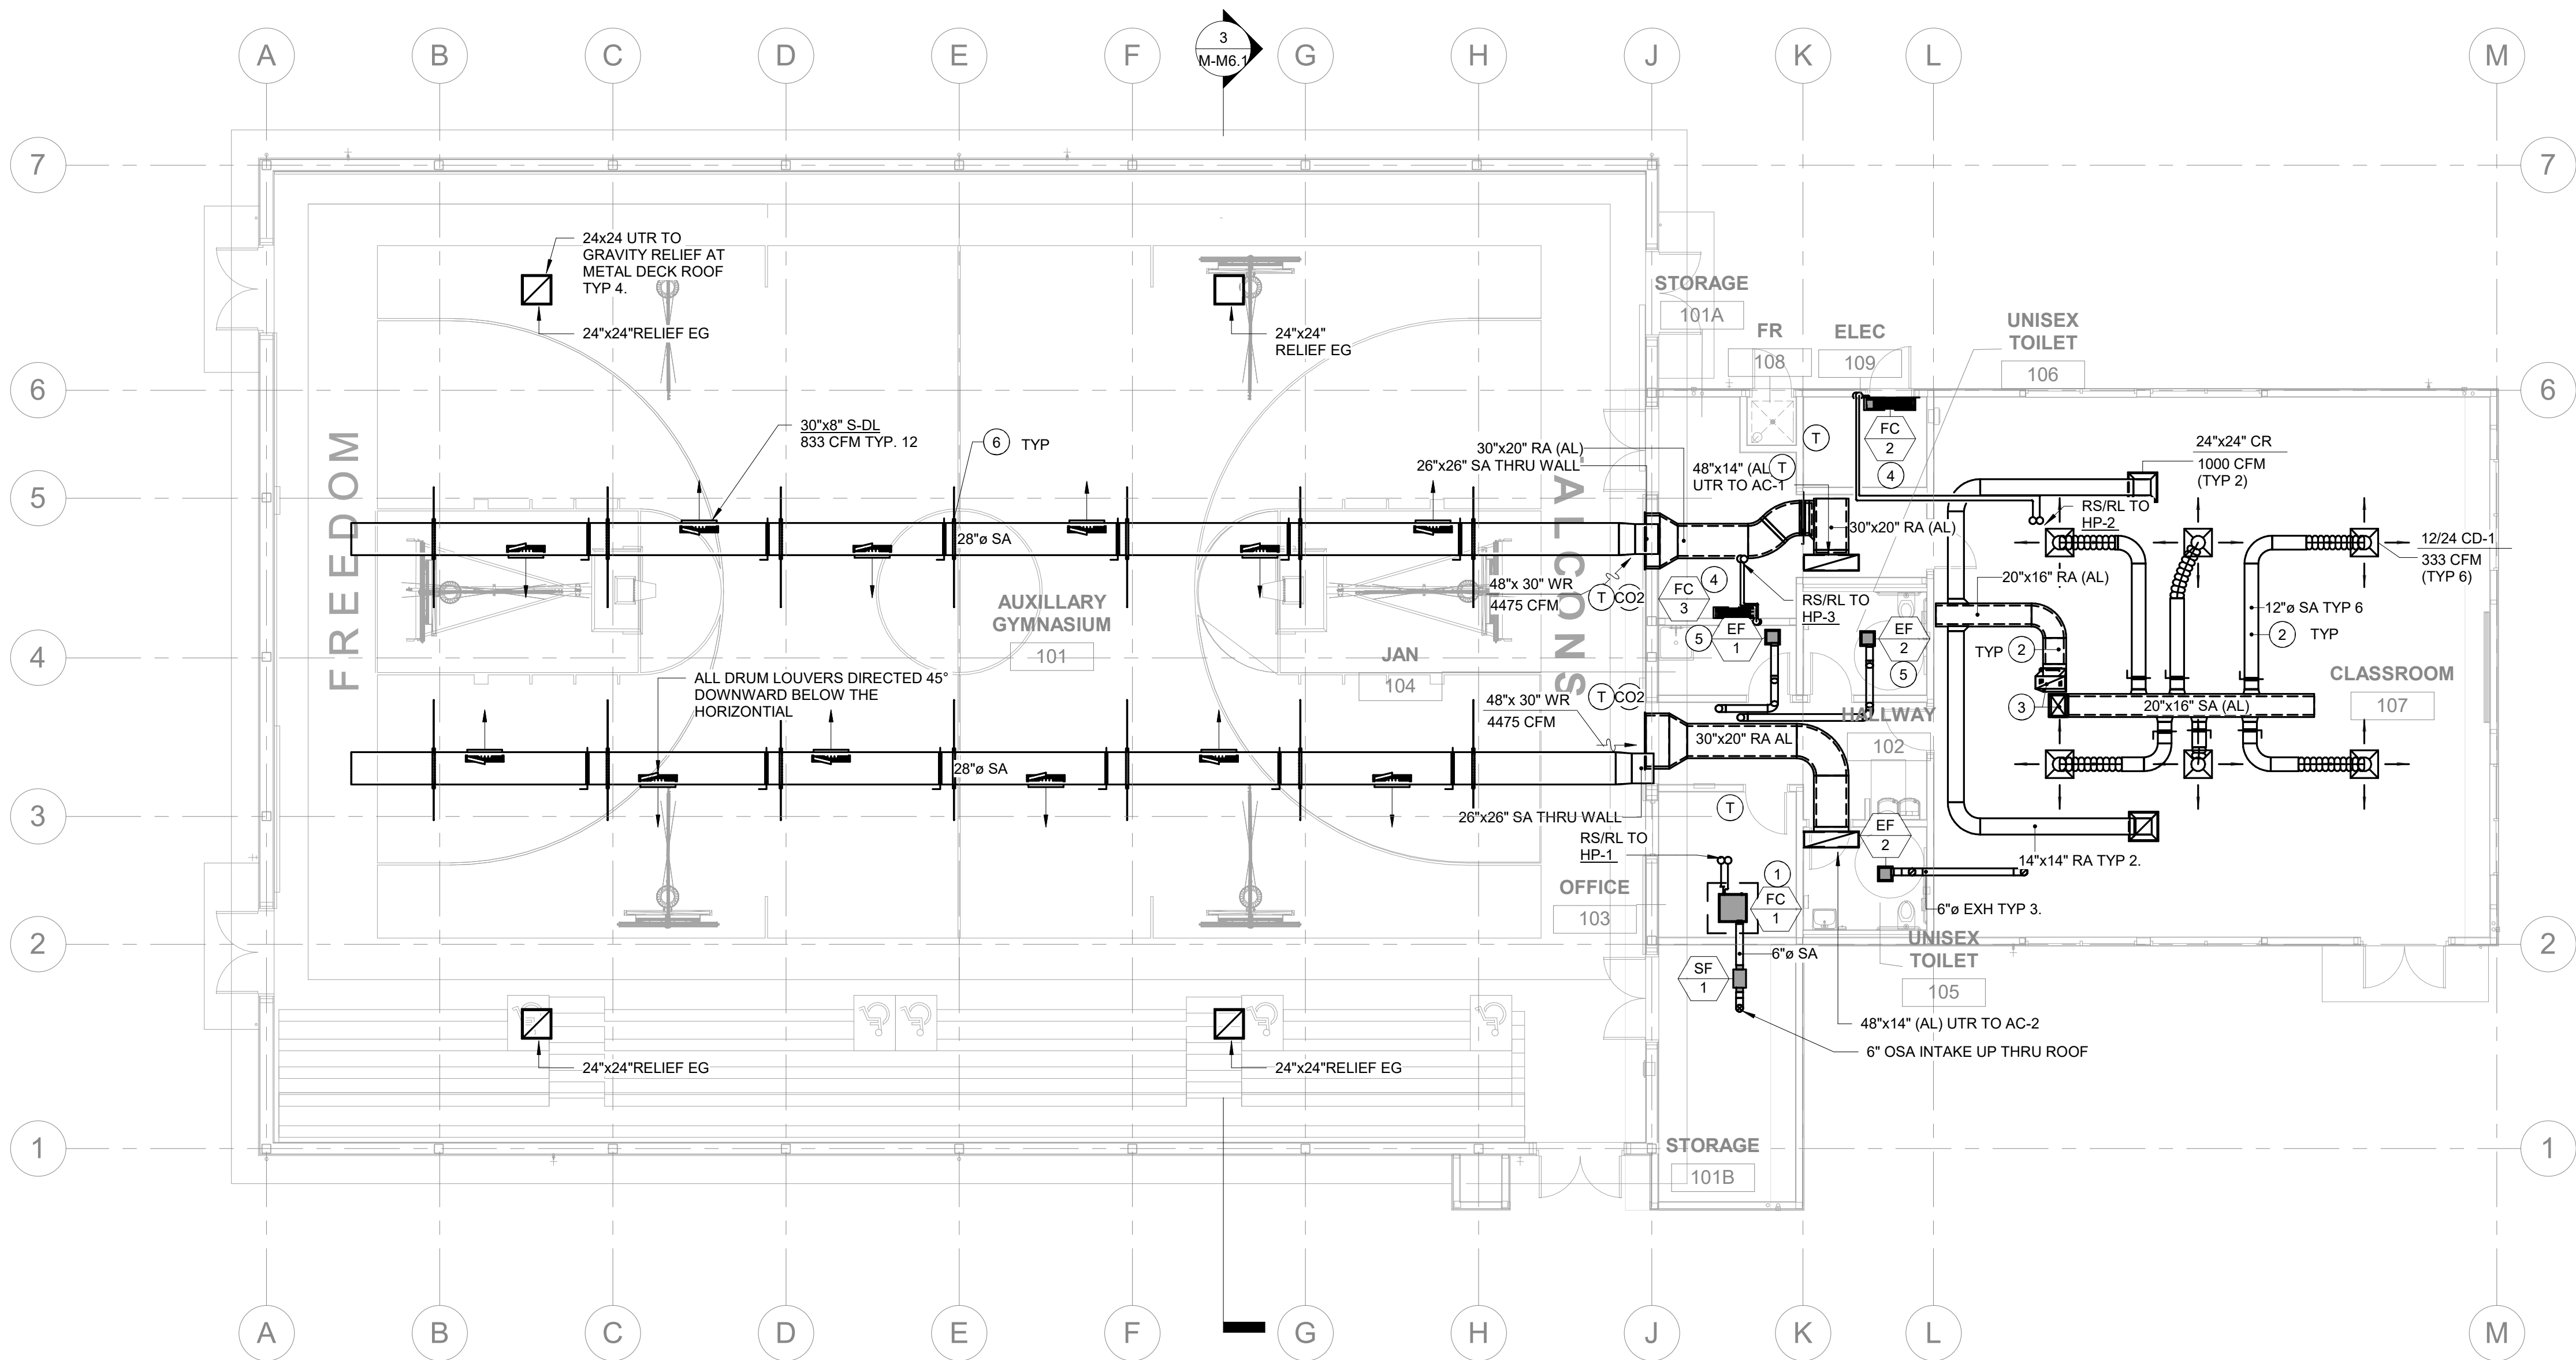
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LEGENDS &  
SCHEDULES

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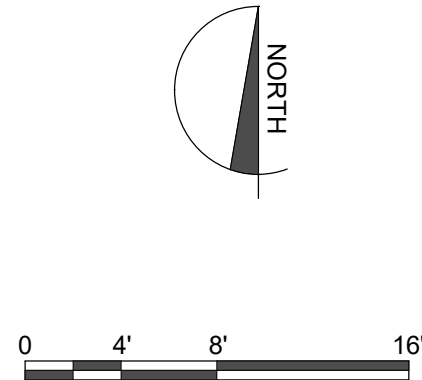
M-M1.1



4/27/2021 11:53:10 AM C:\Users\robentDocuments\20053 Freedom HS Auxiliary Gym RVT18_rengland@costaengineers.com.rvt



**1** **AUXILIARY GYM - MECHANICAL FLOOR PLAN**  
1/8" = 1'-0"



## GENERAL NOTES

- A. FOR MECHANICAL GENERAL NOTES, LEGENDS, AND SYMBOLS, REFER TO SHEET M-M1.1
- B. MECHANICAL CONTRACTOR SHALL BE RESPONSIBLE FOR COORDINATING THE MECHANICAL WORK WITH OTHER TRADES. MAKE ANY OFFSETS AS REQUIRED TO AVOID CONFLICT WITH PIPING, LIGHT FIXTURES, SKYLIGHTS, ETC.
- C. CONTRACTOR SHALL COORDINATE ALL GRILLE LOCATIONS AND CEILING TYPES PRIOR TO ORDERING GRILLES, SEE ARCHITECTURAL CEILING PLANS AND ELECTRICAL LIGHTING PLANS.
- D. WHERE BRACING DETAILS ARE NOT SHOWN ON THE DRAWING OR IN THE GUIDELINES, THE FIELD INSTALLATION SHALL BE SUBJECT TO THE APPROVAL OF THE ARCHITECT, MECHANICAL ENGINEER AND FIELD INSPECTOR OF THE GOVERNING AUTHORITY.

## SHEET NOTES



- 1 CEILING CASSETTE FAN COIL; SEE SCHEDULE FOR PAIRED HEAT PUMP. MOUNTED PER DETAIL. **C** **M-M7.1**
- 2 FOR TYPICAL DUCT SUPPORT SEE DETAIL. **A** **M-M7.3**
- 3 20"x16" SA (AL) & 16"x20" RA (AL) UTR TO AC-3 FOR DUCT THRU ROOF SEE DETAIL. **B** **M-M7.2**
- 4 WALL MOUNTED FAN COIL; SEE SCHEDULE FOR PAIR CONDENSING UNIT OR HEAT PUMP. FOR MOUNT DETAIL IN STUD WOOD WALL SEE DETAIL. **F** **M-M7.1**
- 5 CEILING EXHAUST FAN WITH 6" DUCT UTR. FOR MOUNTING DETAIL SEE. **E** **M-M7.1**
- 6 EXPOSED ROUND DUCT AT GYM. SUPPORT AT EVERY FLANGE OR CHANNEL. MOUNT PER DETAIL. **A** **M-M7.4**

## WALL LEGENDS

NOTES:  
S.S.D. FOR WOOD FRAMING SIZES FOR ALL BEARING WALLS. ALL OTHER WALLS ARE 2X6 WOOD STUDS U.O.N.


WOOD FRAMING - NON RATED

## KEYPLAN

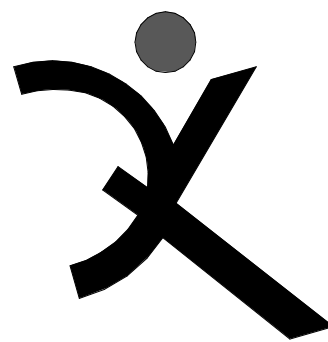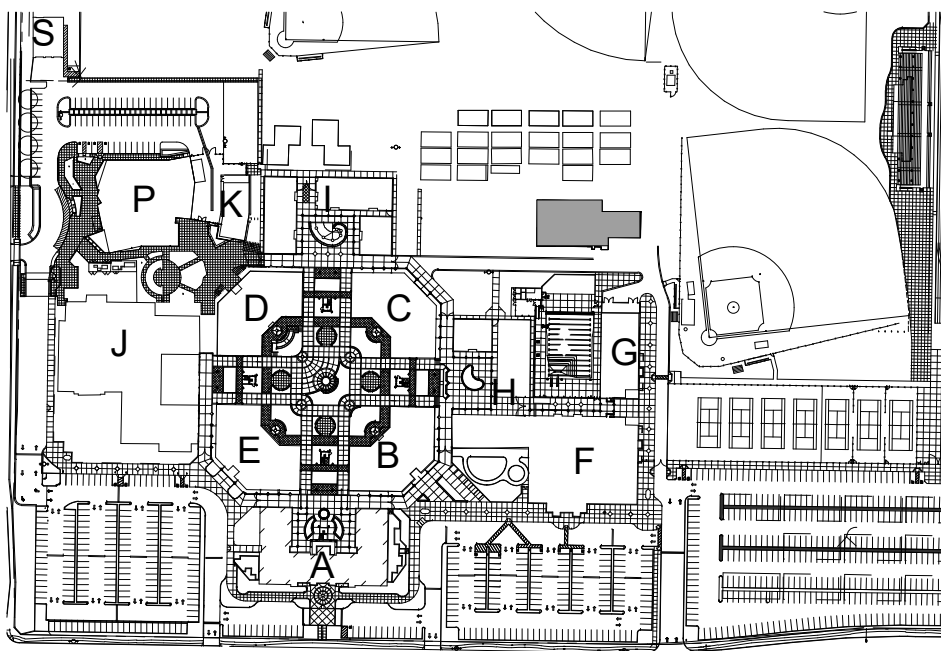

**QUATTROCCHI KWOK  
ARCHITECTS**  
Main Office:  
636 Fifth Street, Santa Rosa, CA 95404  
East Bay:  
55 Harrison Street, Suite 525,  
Oakland, CA 94607  
(707) 576-0829

SIGNED: OCTOBER 30, 2020

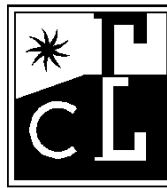

**COSTA ENGINEERS INC.**



**FREEDOM  
HIGH SCHOOL**

**NEW AUXILIARY  
GYMNASIUM**

1050 NEROLY RD,  
OAKLEY, CA 94561

**LIBERTY UNION  
HIGH SCHOOL  
DISTRICT**

DSA APP NO. 01-119278

ARCH PROJECT NO: 1869.00

DRAWN BY: MQ/RE

DRAWING SCALE: 1/8" = 1'-0"

PTN: 61721-78 FILE NO: 7-H4

BID DOCUMENT

APRIL 27, 2021

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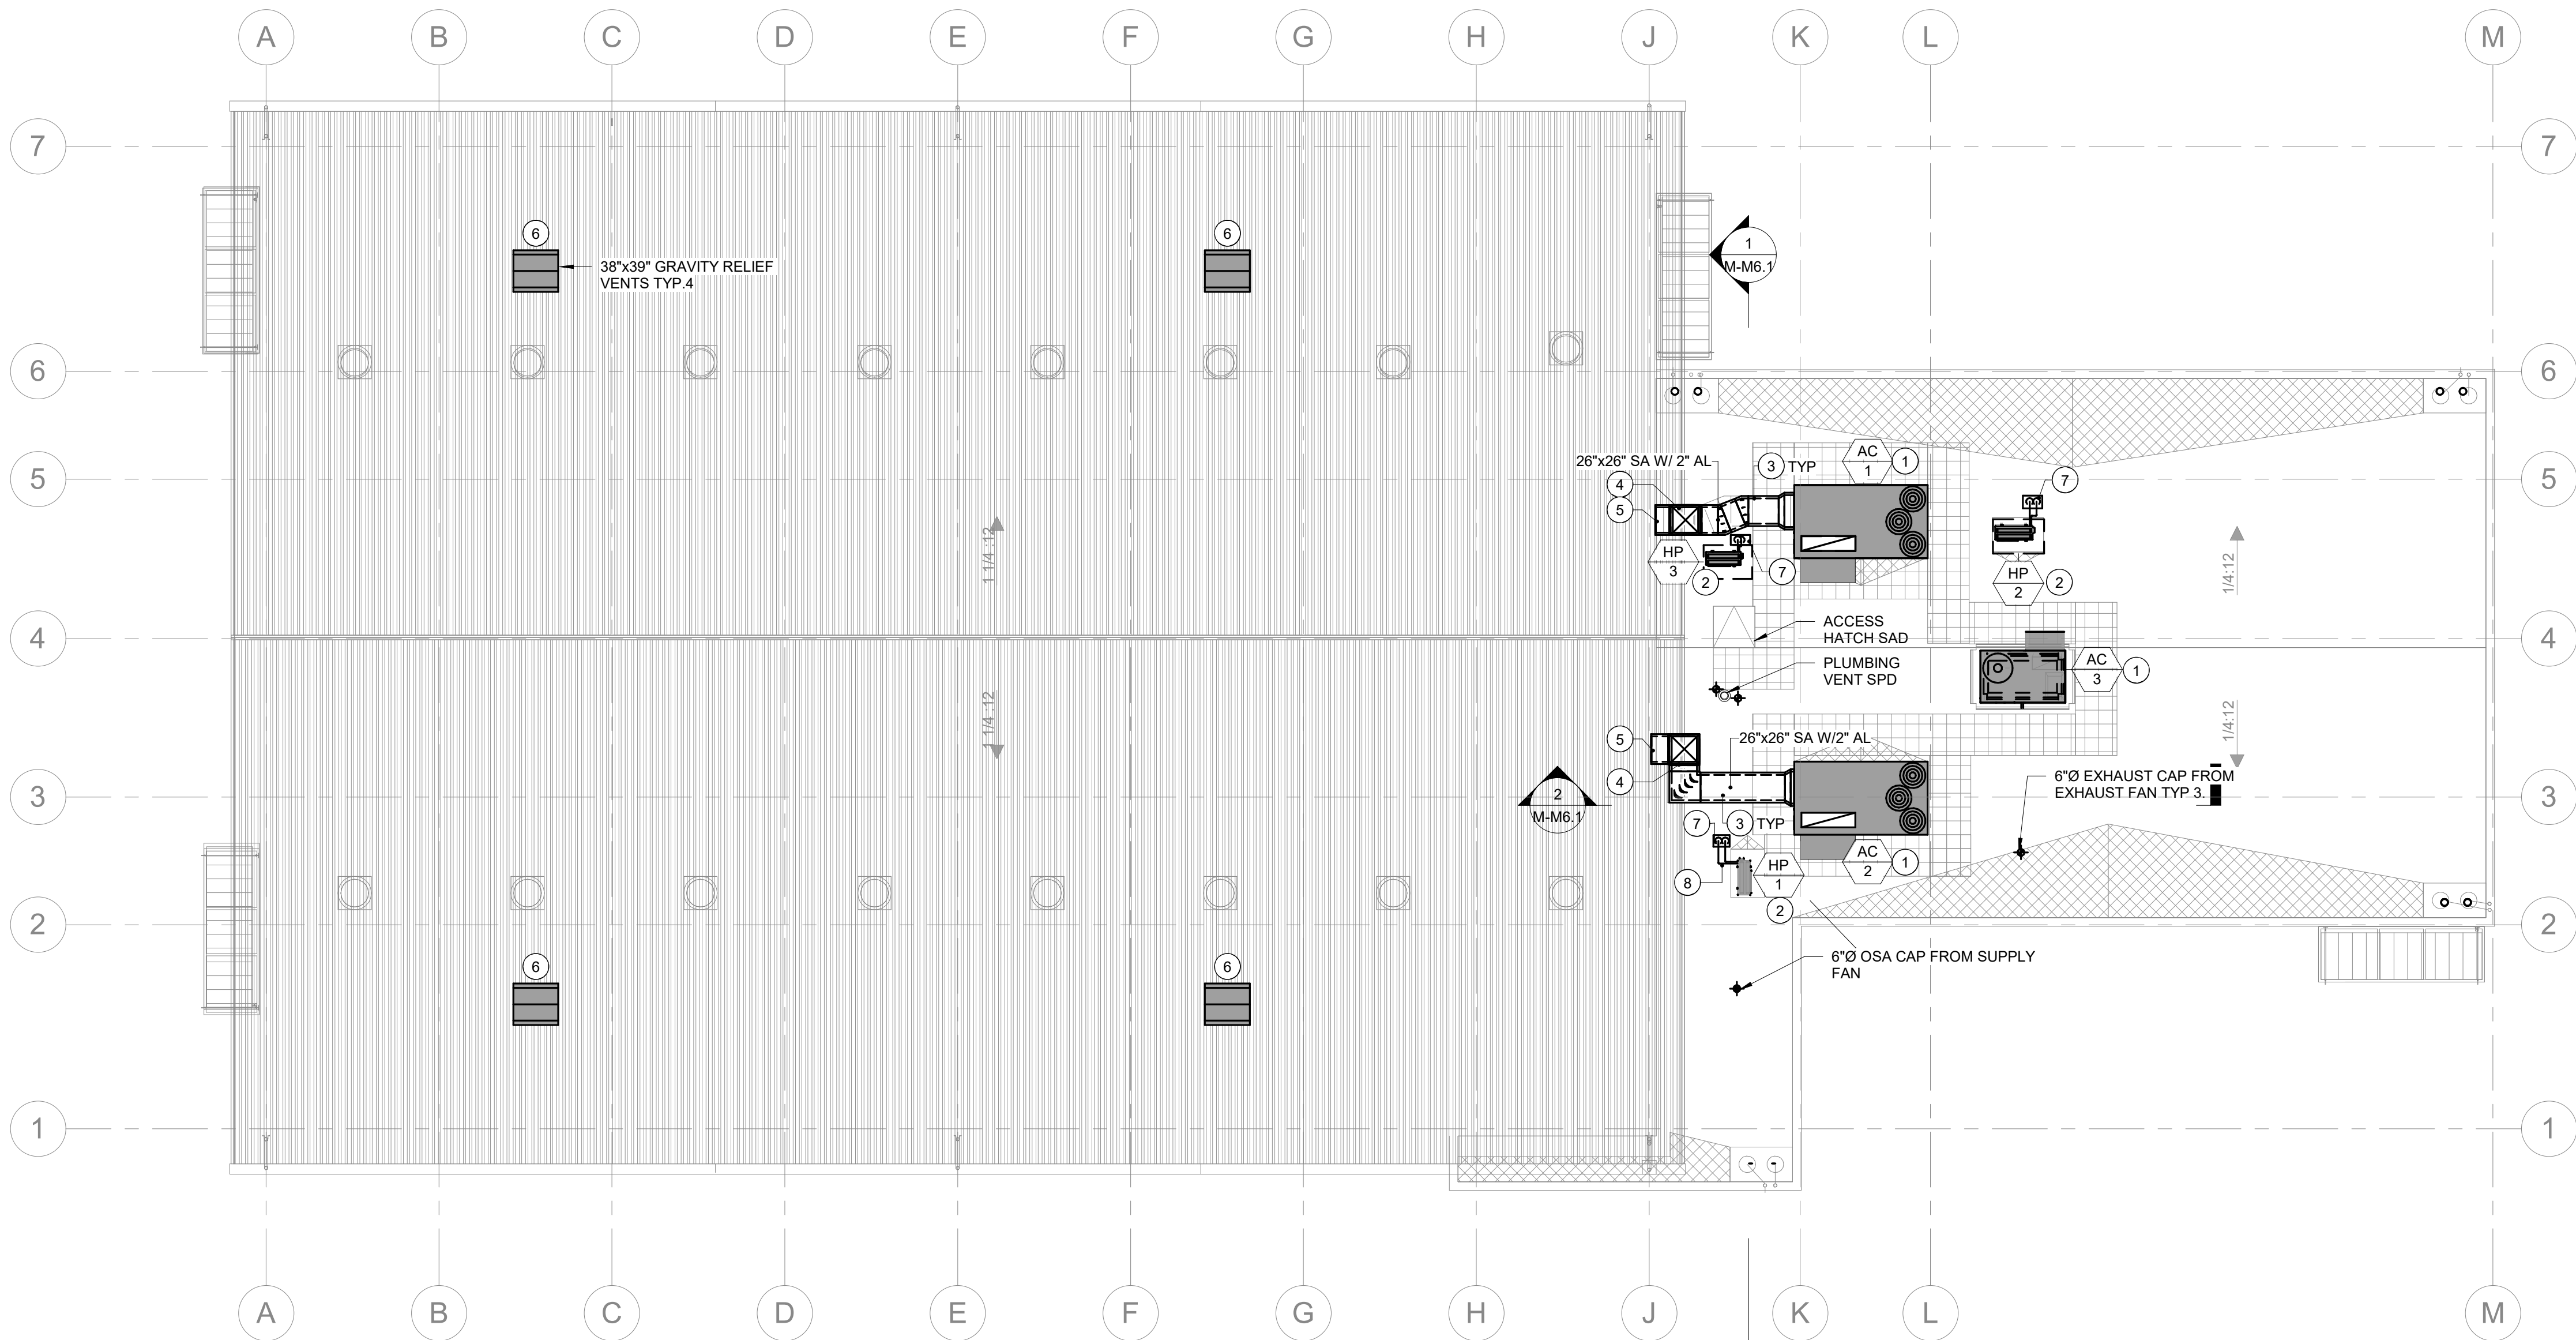
**MECHANICAL  
FLOOR PLAN**

SHEET NUMBER

**M-M2.1**



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**1** **AUXILIARY GYM - MECHANICAL ROOF PLAN**  
1/8" = 1'-0"

**GENERAL NOTES**

- A. FOR MECHANICAL GENERAL NOTES, LEGENDS, AND SYMBOLS, REFER TO SHEET M-M1.1
- B. MECHANICAL CONTRACTOR SHALL BE RESPONSIBLE FOR COORDINATING THE MECHANICAL WORK WITH OTHER TRADES. MAKE ANY OFFSETS AS REQUIRED TO AVOID CONFLICT WITH PIPING, LIGHT FIXTURES, SKYLIGHTS, ETC.
- C. CONTRACTOR SHALL COORDINATE ALL GRILLE LOCATIONS AND CEILING TYPES PRIOR TO ORDERING GRILLES, SEE ARCHITECTURAL CEILING PLANS AND ELECTRICAL LIGHTING PLANS.
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**SHEET NOTES**



- 1 AC UNIT MOUNTED IN PRE-FABRICATED MICROMENTL ISOLATION CURB. FOR MOUNTING DETAIL SEE **A** M-M7.1
- 2 HEAT PUMP OR CONDENSING UNIT. MOUNTED ON WOOD SLEEPER. FOR MOUNTING DETAIL SEE **B** M-M7.1
- 3 DUCT MOUNTED ON WOOD SLEEPER. FOR MOUNTING DETAIL SEE **D** M-M7.1
- 4 EXPOSED DUCT UP ALONG EXTERIOR WALL AND THRU WALL SEE DETAIL **A** M-M7.2
- 5 DUCT THRU EXTERIOR WALL SEE DETAIL **B** M-M7.2
- 6 GRAVITY RELIEF ON METAL DECK ROOF SEE DETAIL **C** M-M7.2
- 7 REFRIGERANT PIPE THRU ROOF SEE DETAIL **D** M-M7.2
- 8 REFRIGERANT PIPE ON ROOF SEE DETAIL **E** M-M7.2

**WALL LEGENDS**

NOTES:  
S.S.D. FOR WOOD FRAMING SIZES FOR ALL BEARING WALLS. ALL OTHER WALLS ARE 2X6 WOOD STUDS U.O.N.

WOOD FRAMING - NON RATED

**KEYPLAN**

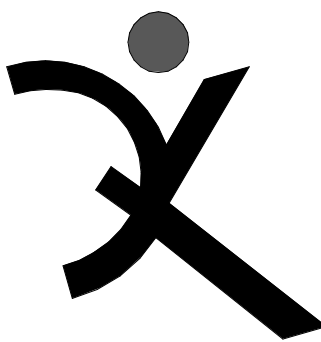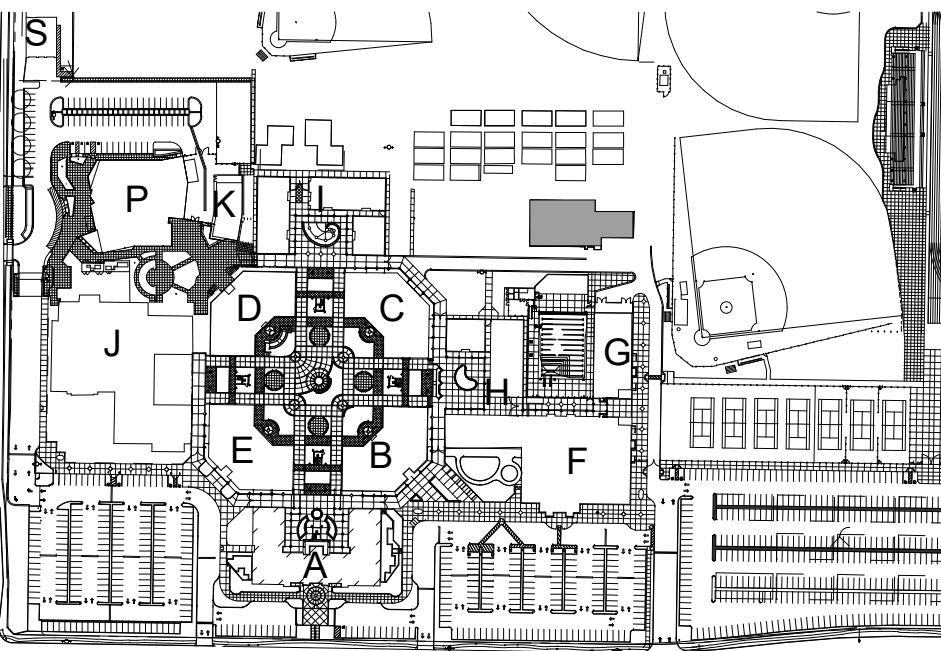

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Main Office:  
636 Fifth Street, Santa Rosa, CA 95404  
East Bay:  
55 Harrison Street, Suite 525,  
Oakland, CA 94607  
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**LIBERTY UNION HIGH SCHOOL DISTRICT**


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DRAWING SCALE: 1/8" = 1'-0"  
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**APRIL 27, 2021**



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**MECHANICAL ROOF PLAN**

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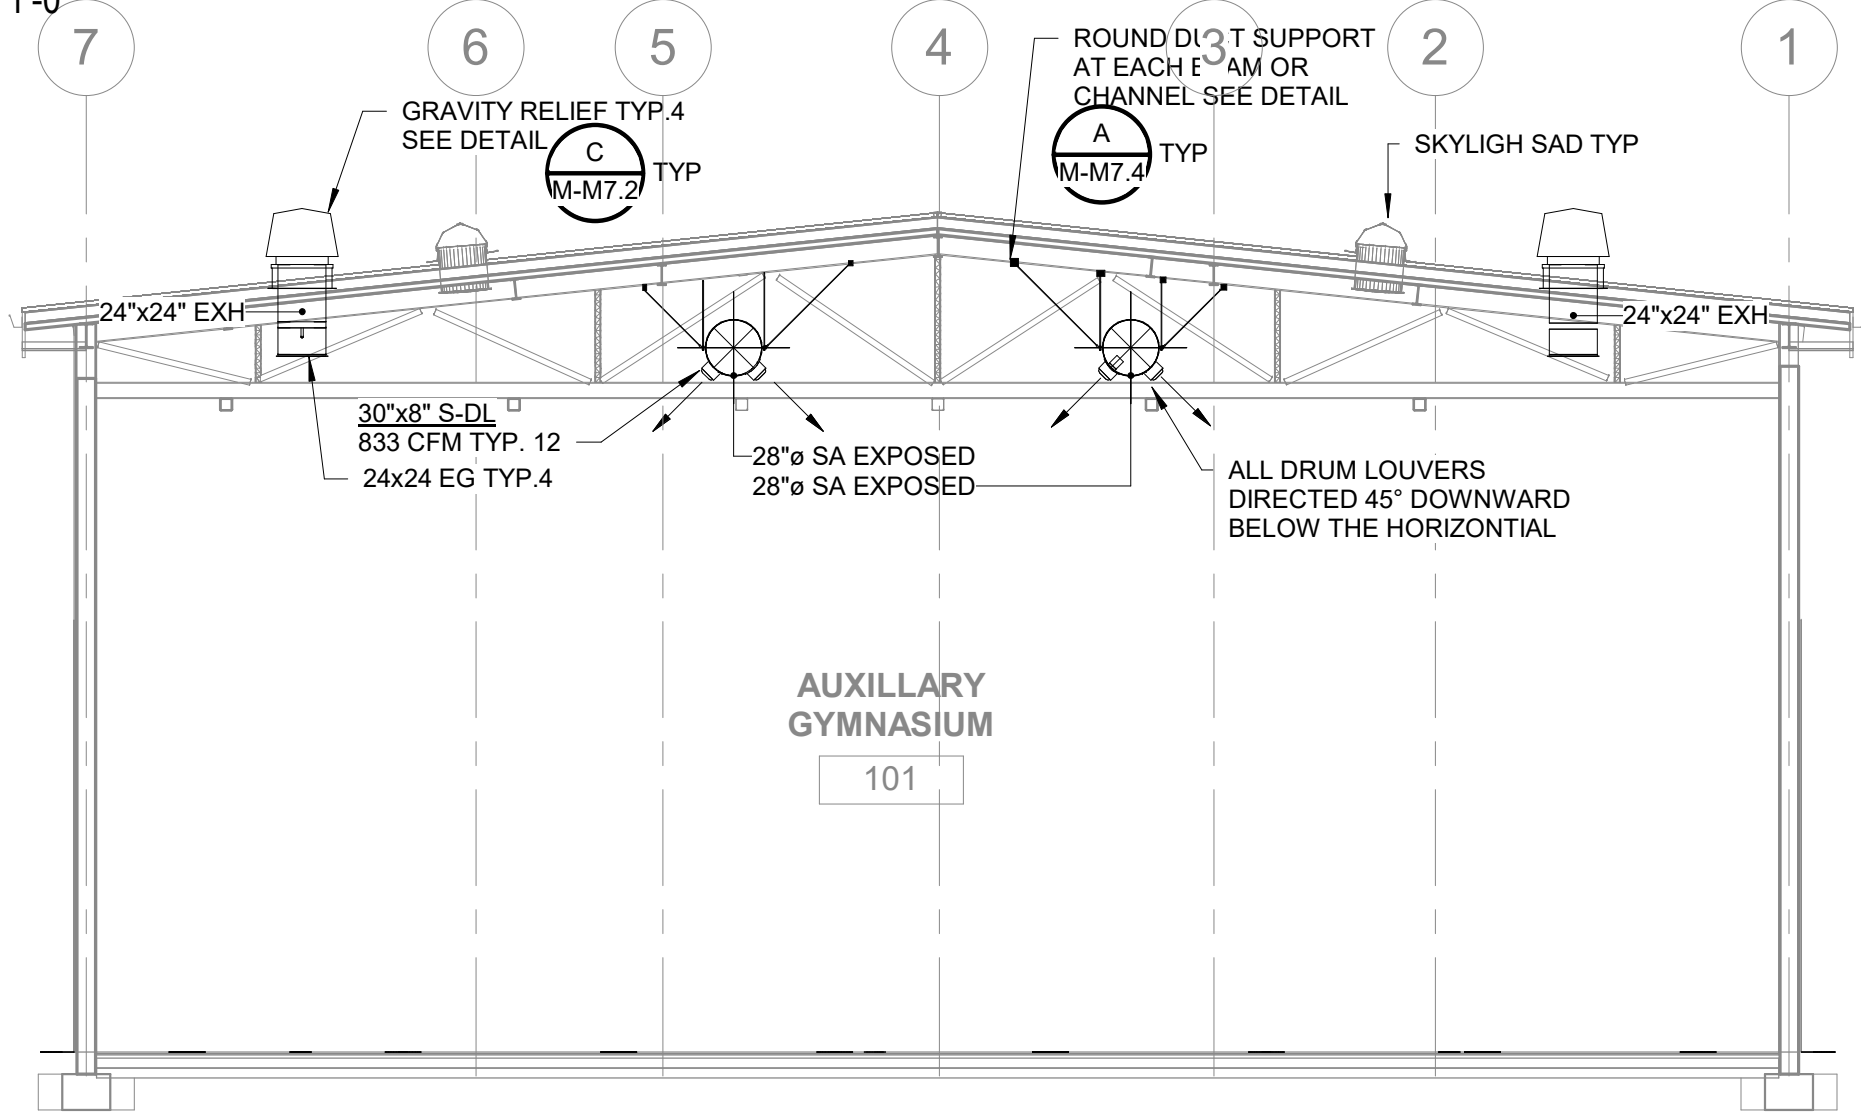
**M-M3.1**





### 1 MECHANICAL ROOF SECTION THRU GYM

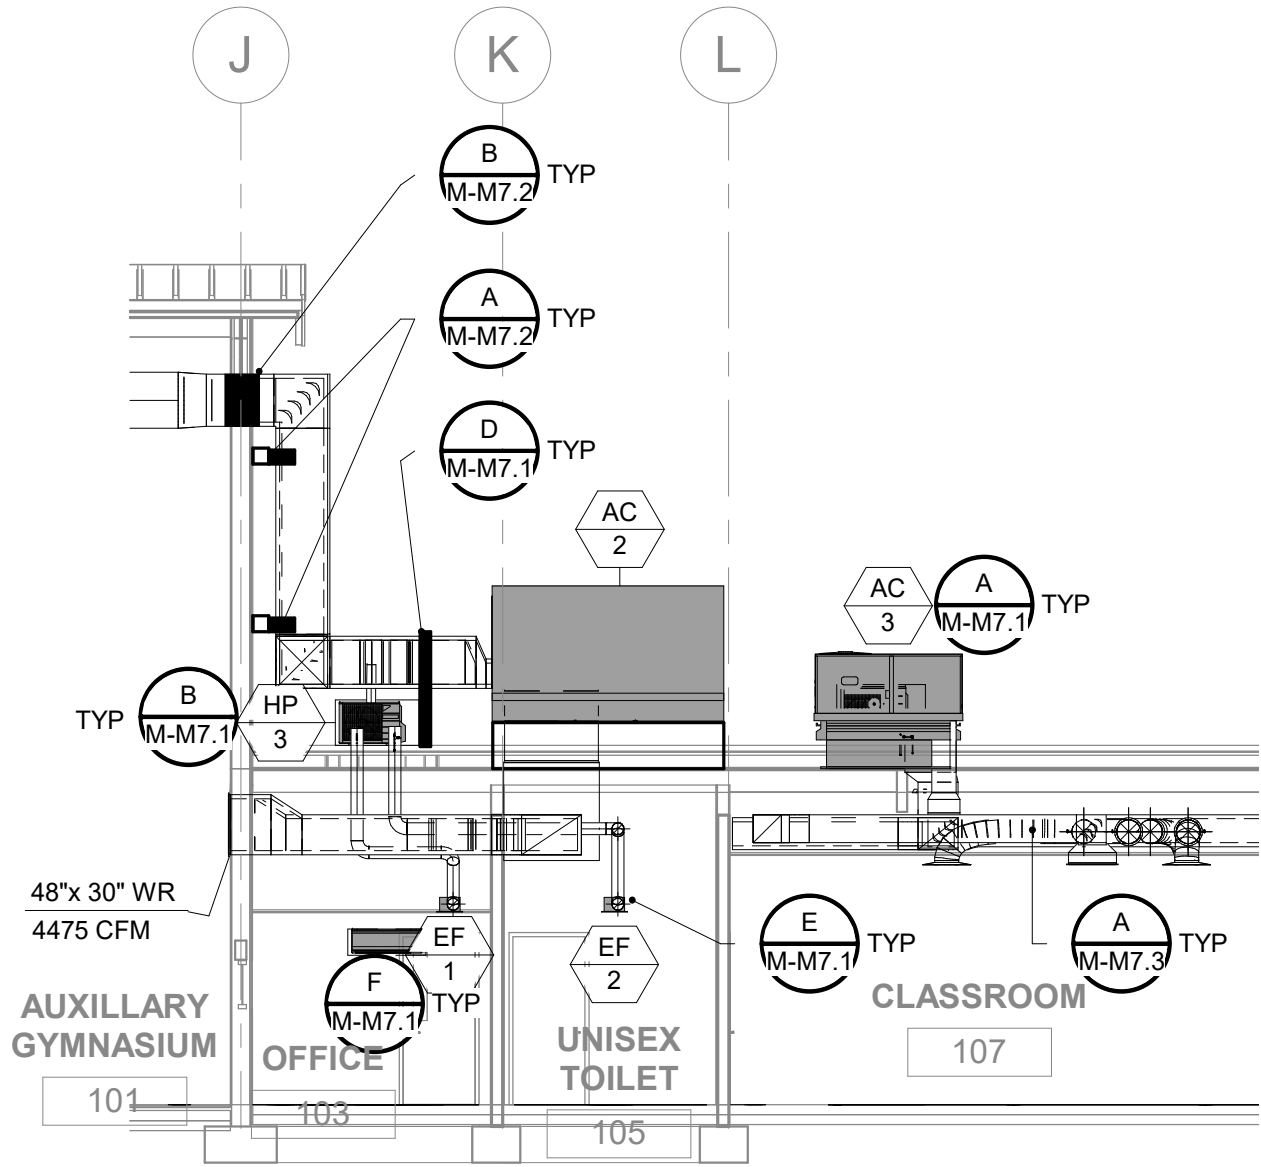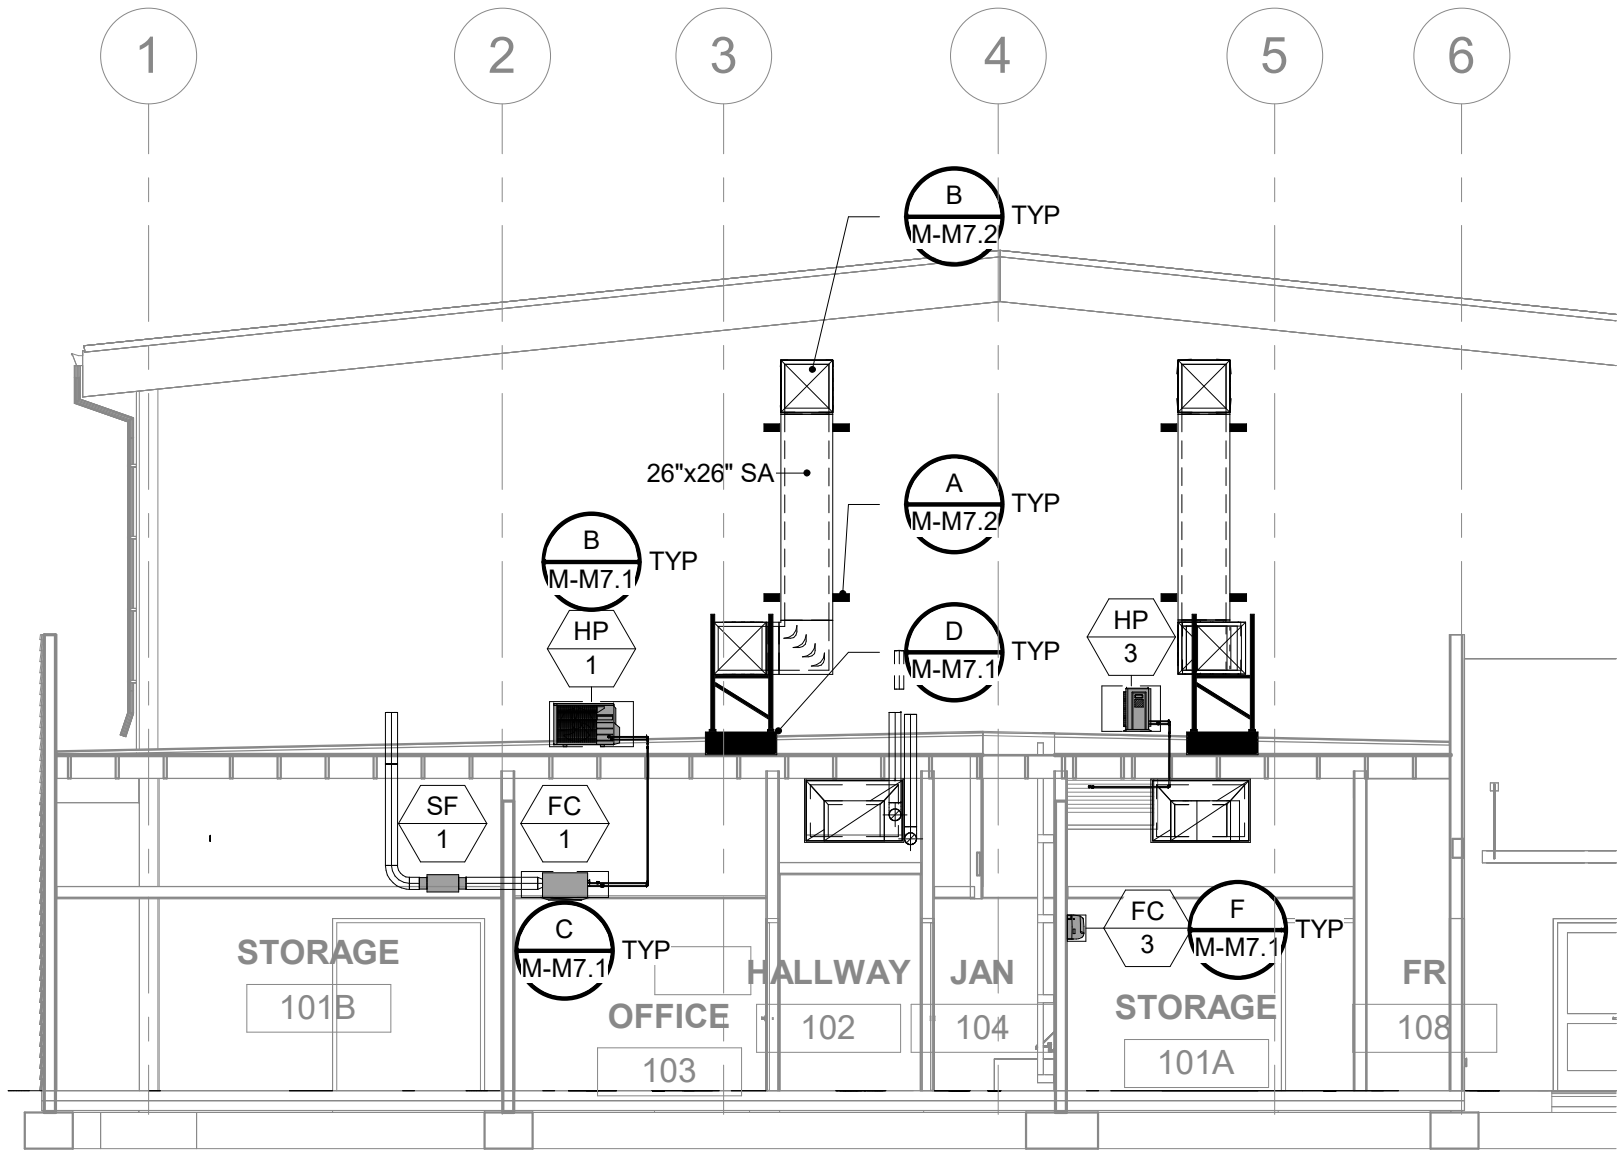1/8" = 1'-0"




### 2 MECHANICAL ROOF SECTION THRU EXTERIOR GYM WALL

1/8" = 1'-0"

### 3 MECHANICAL SECTION

1/8" = 1'-0"

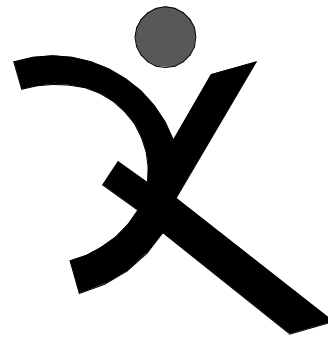

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3274 Villa Lane Suite, CA 94608 ph: 707-252-9177 fax: 707-252-9473



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DRAWN BY: MQ

DRAWING SCALE: 1/8" = 1'-0"

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BID DOCUMENT

APRIL 27, 2021

SHEET TITLE

MECHANICAL  
SECTIONS


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M-M6.1









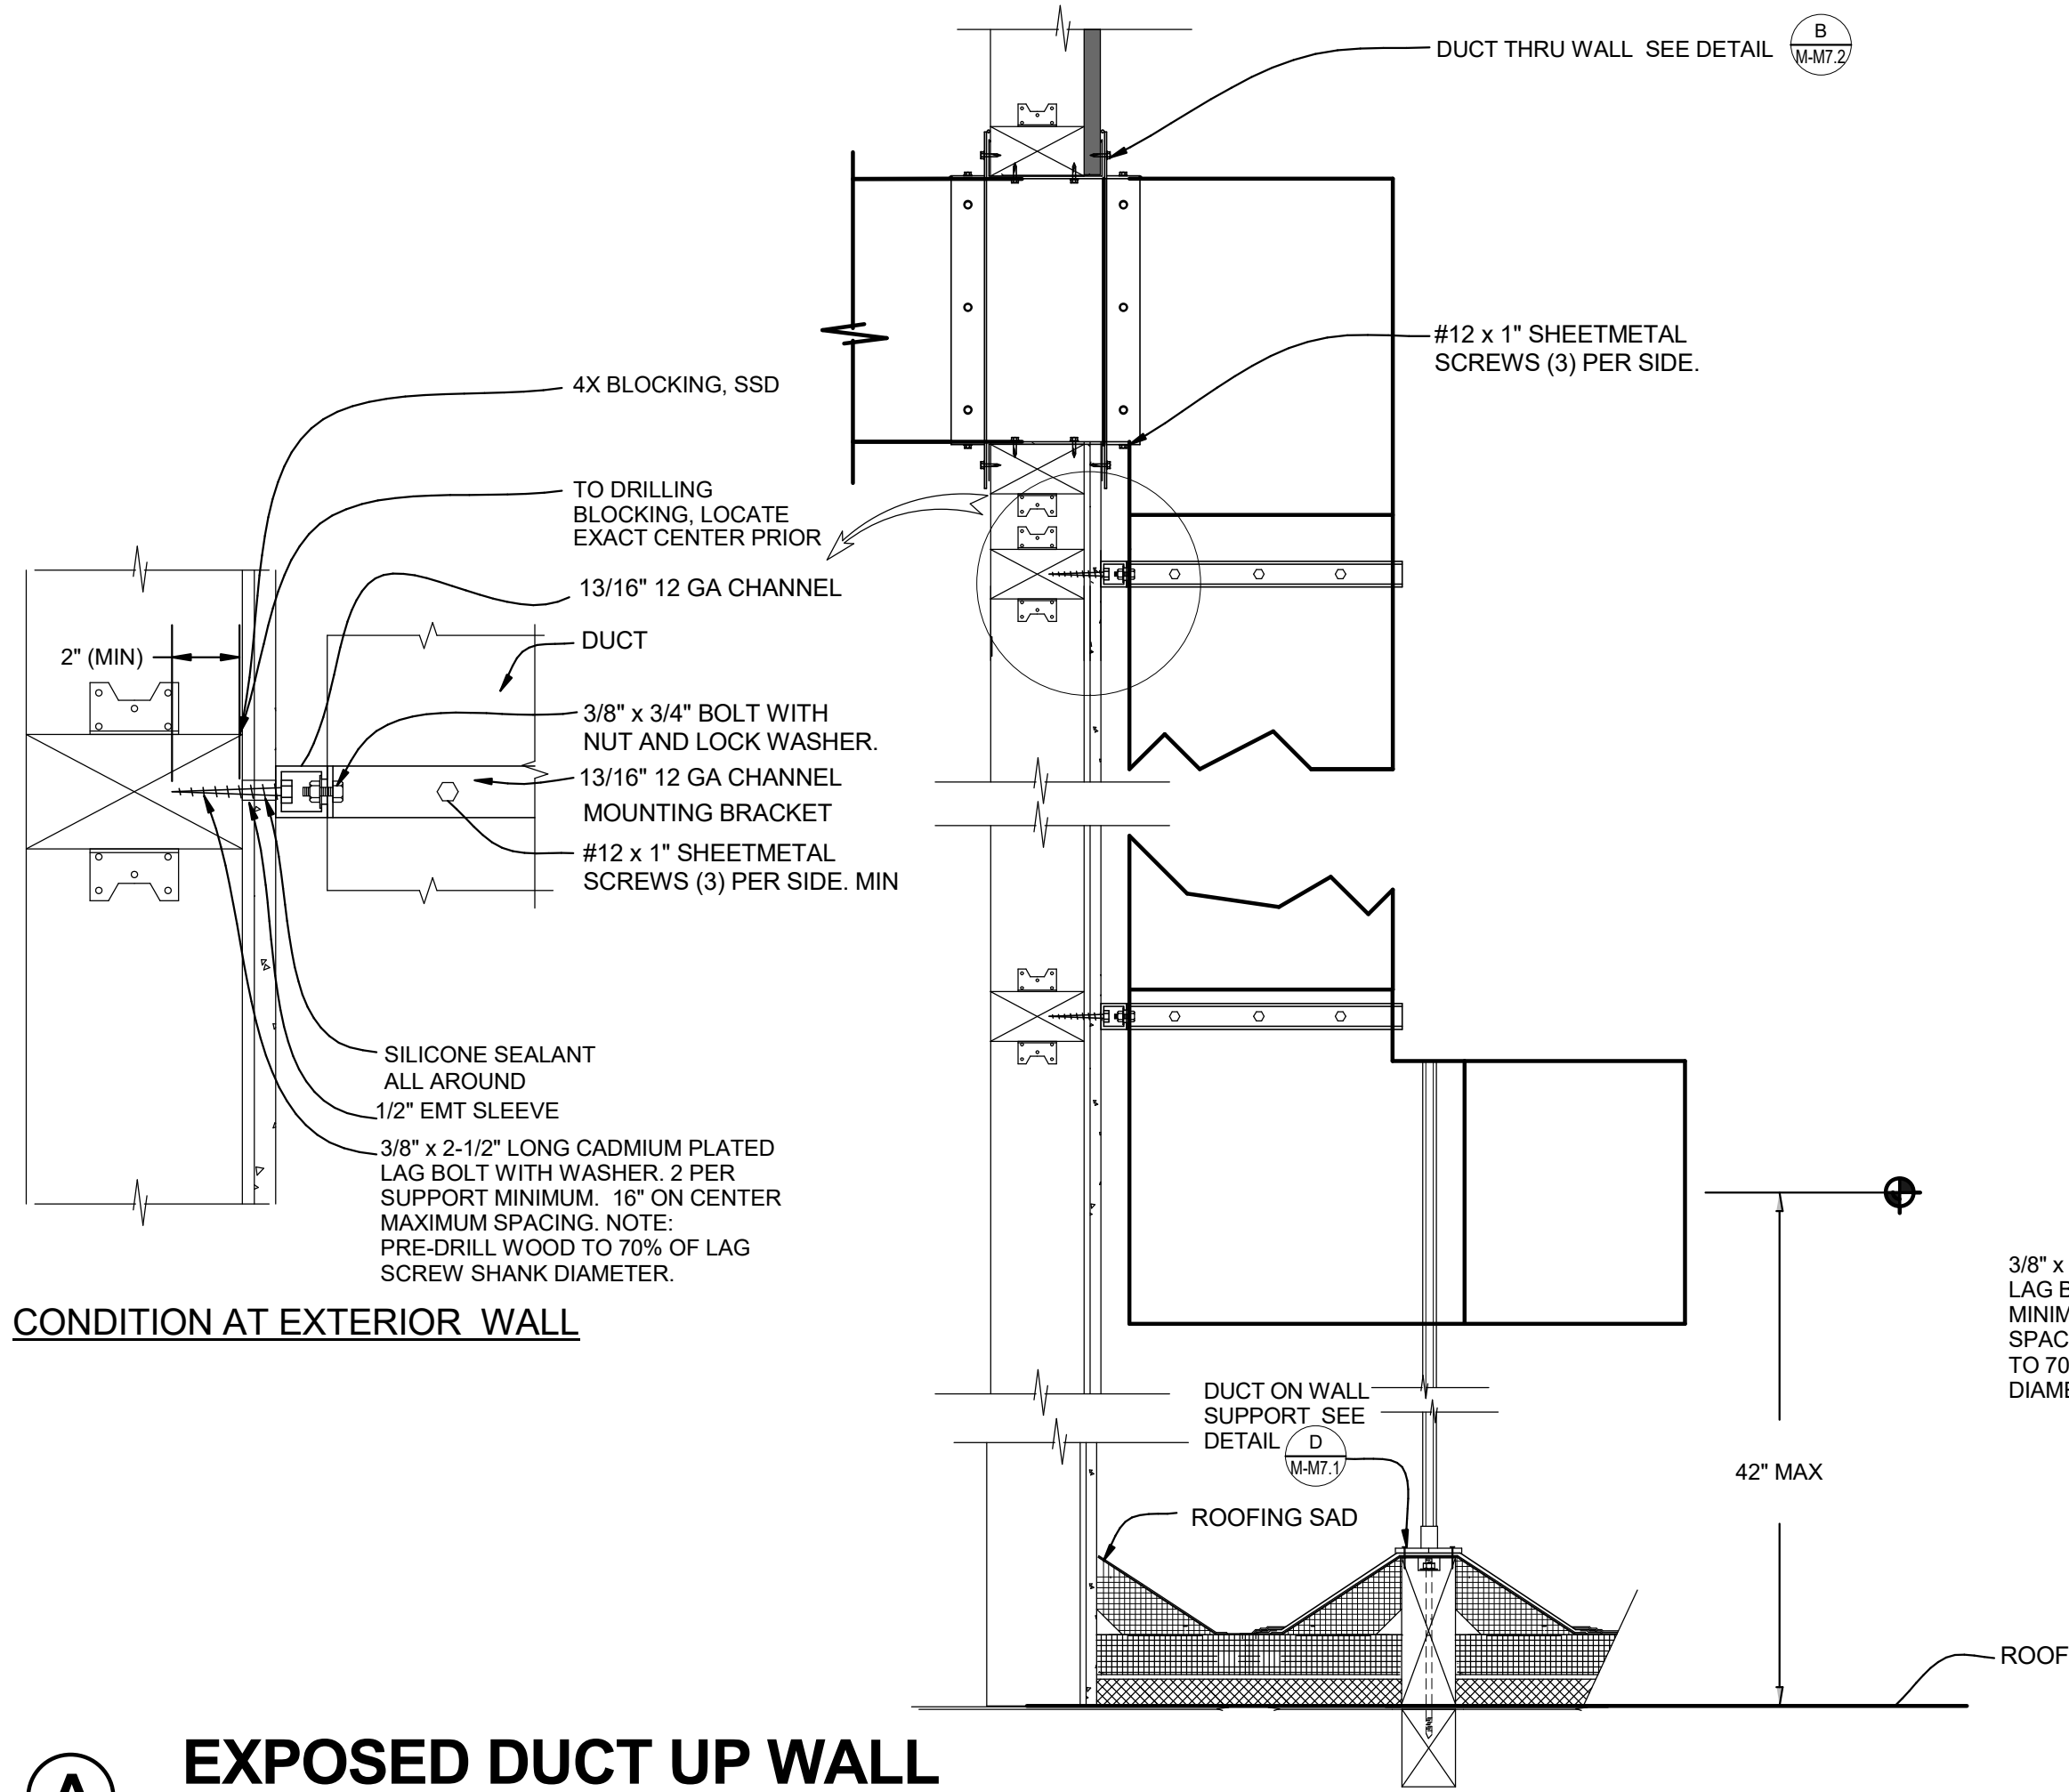


**A** EXPOSED DUCT UP WALL  
SCALE: NONE

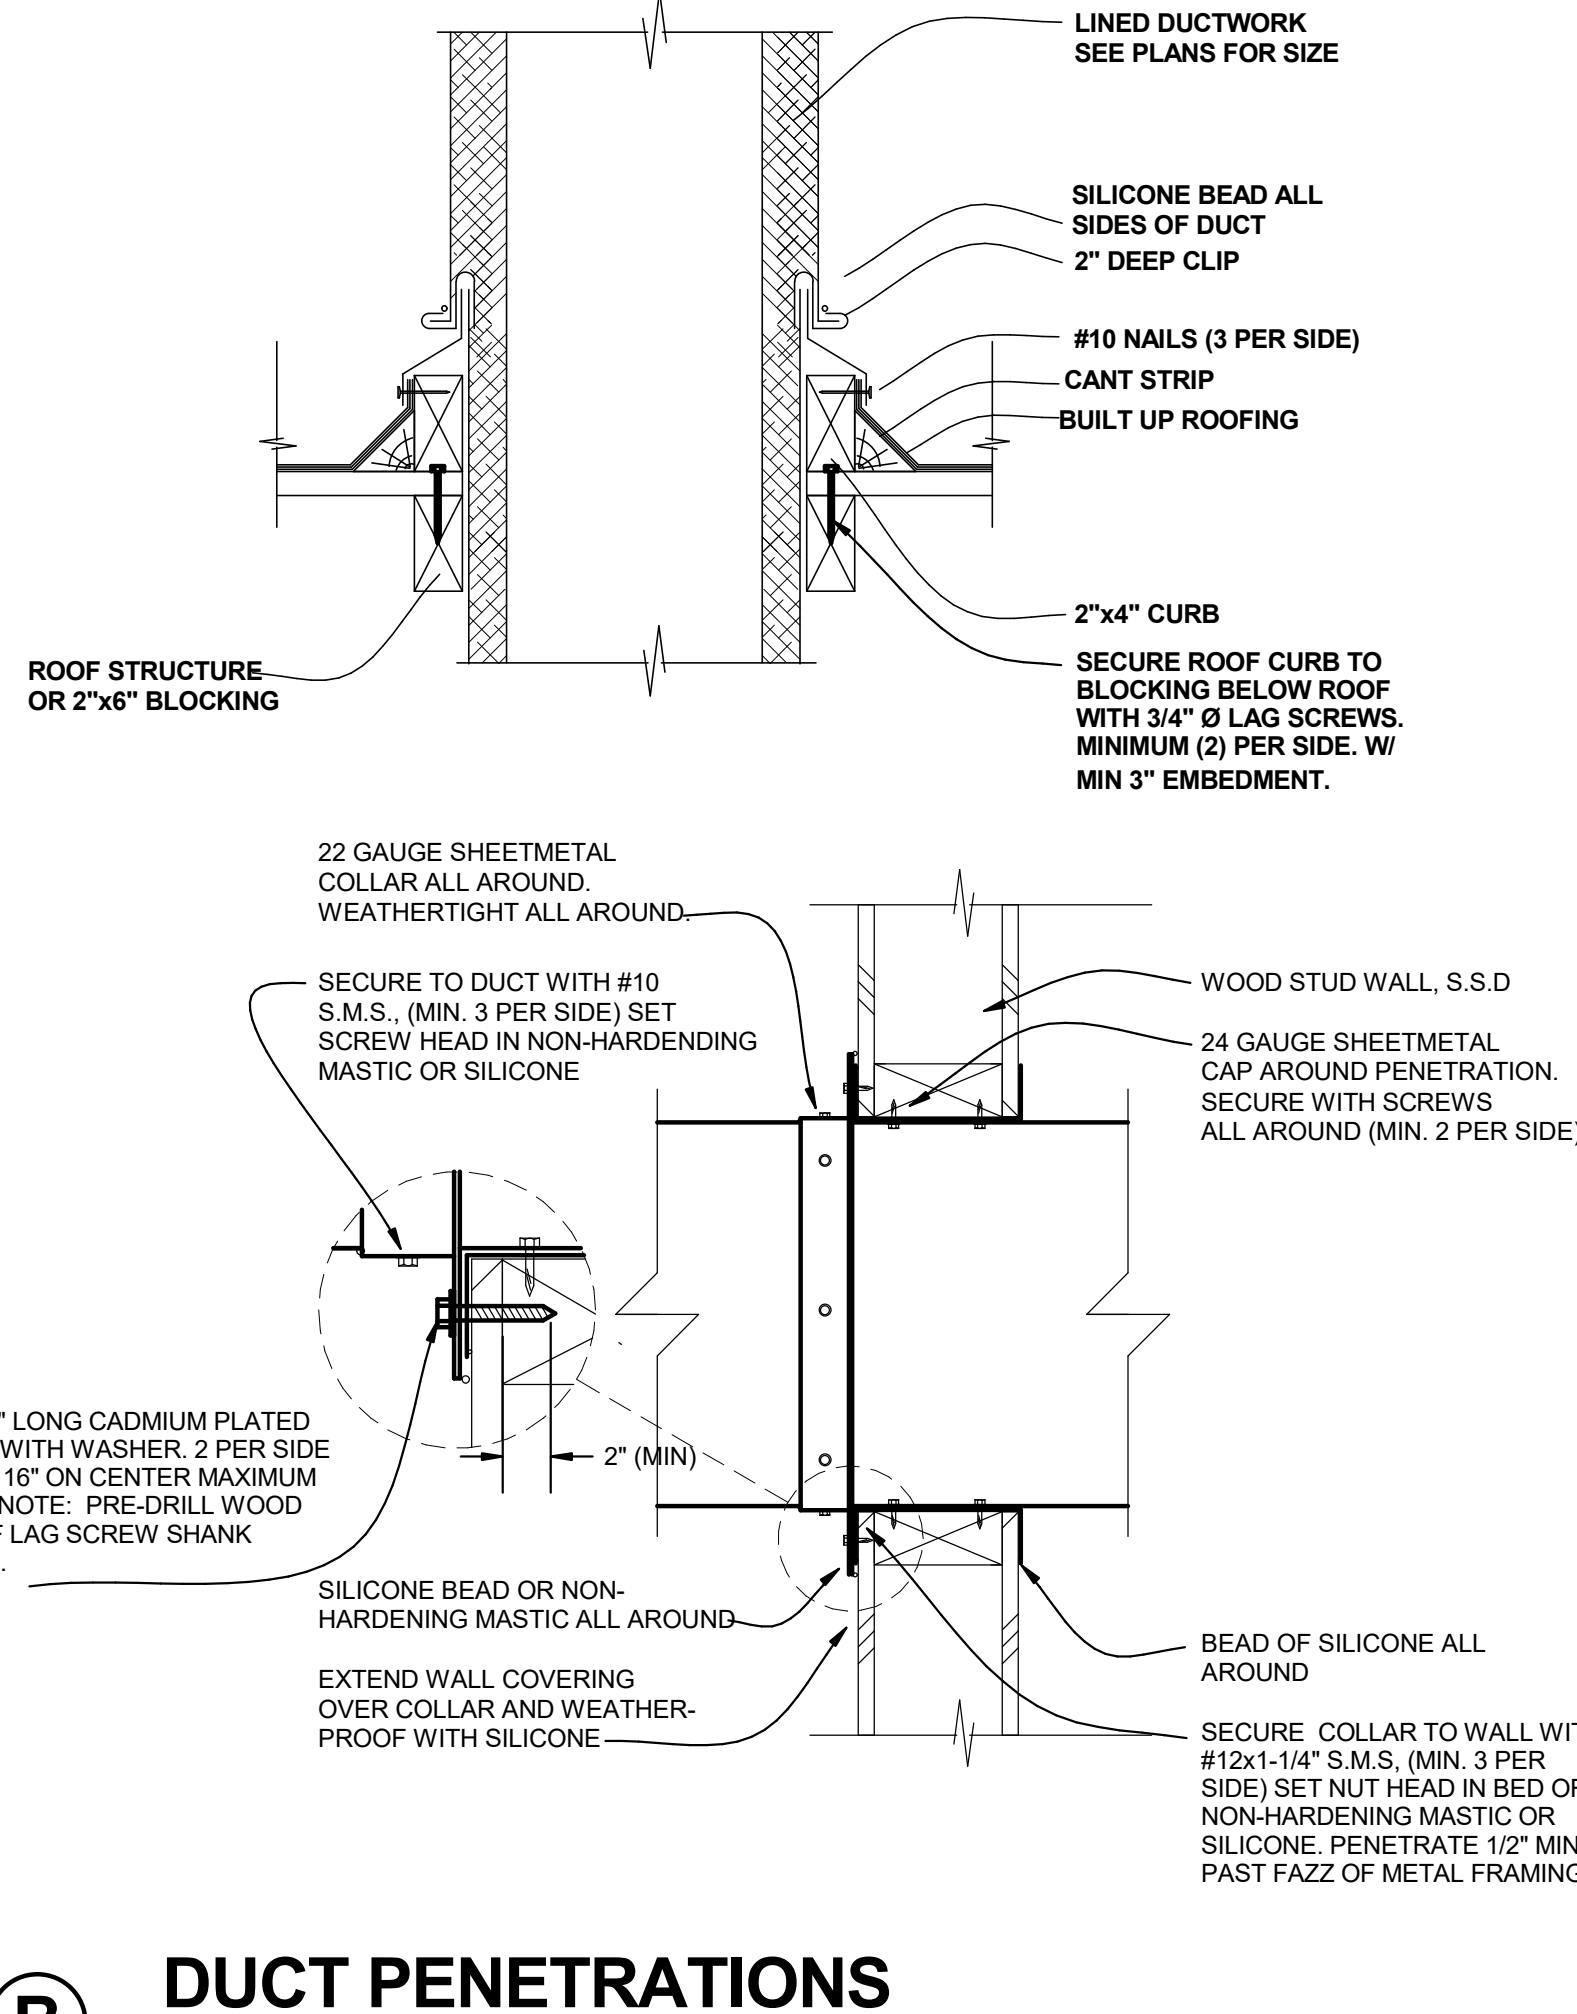


**B** DUCT PENETRATIONS  
SCALE: NONE

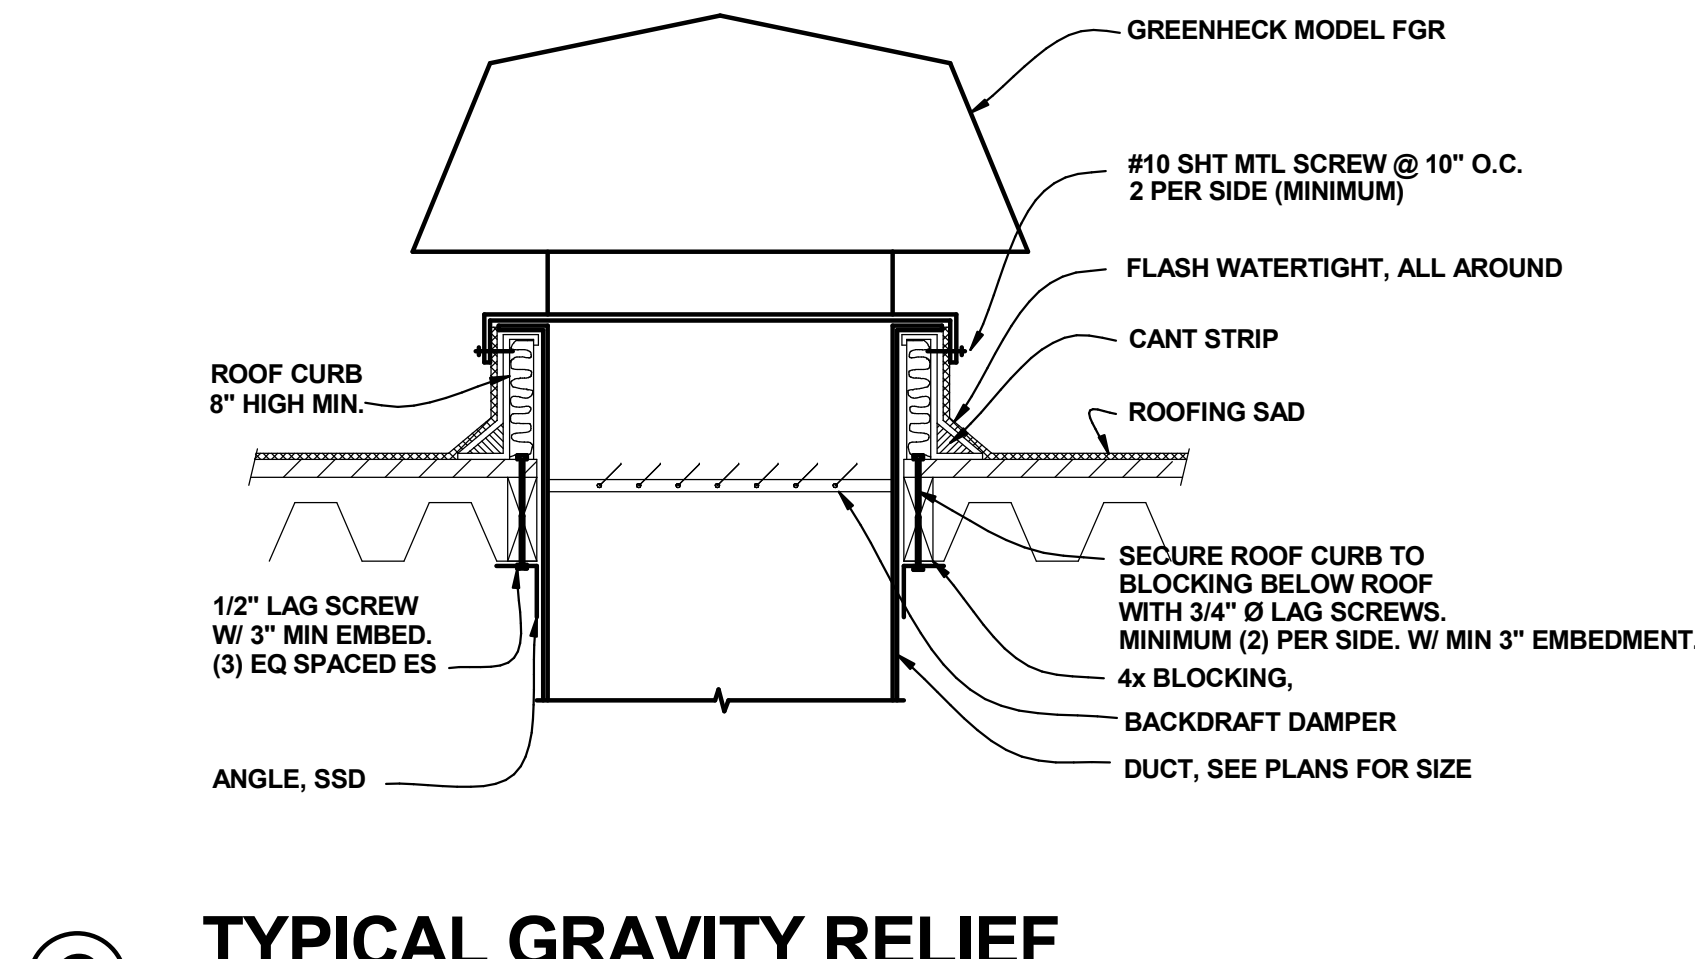

**C** TYPICAL GRAVITY RELIEF  
SCALE: NONE

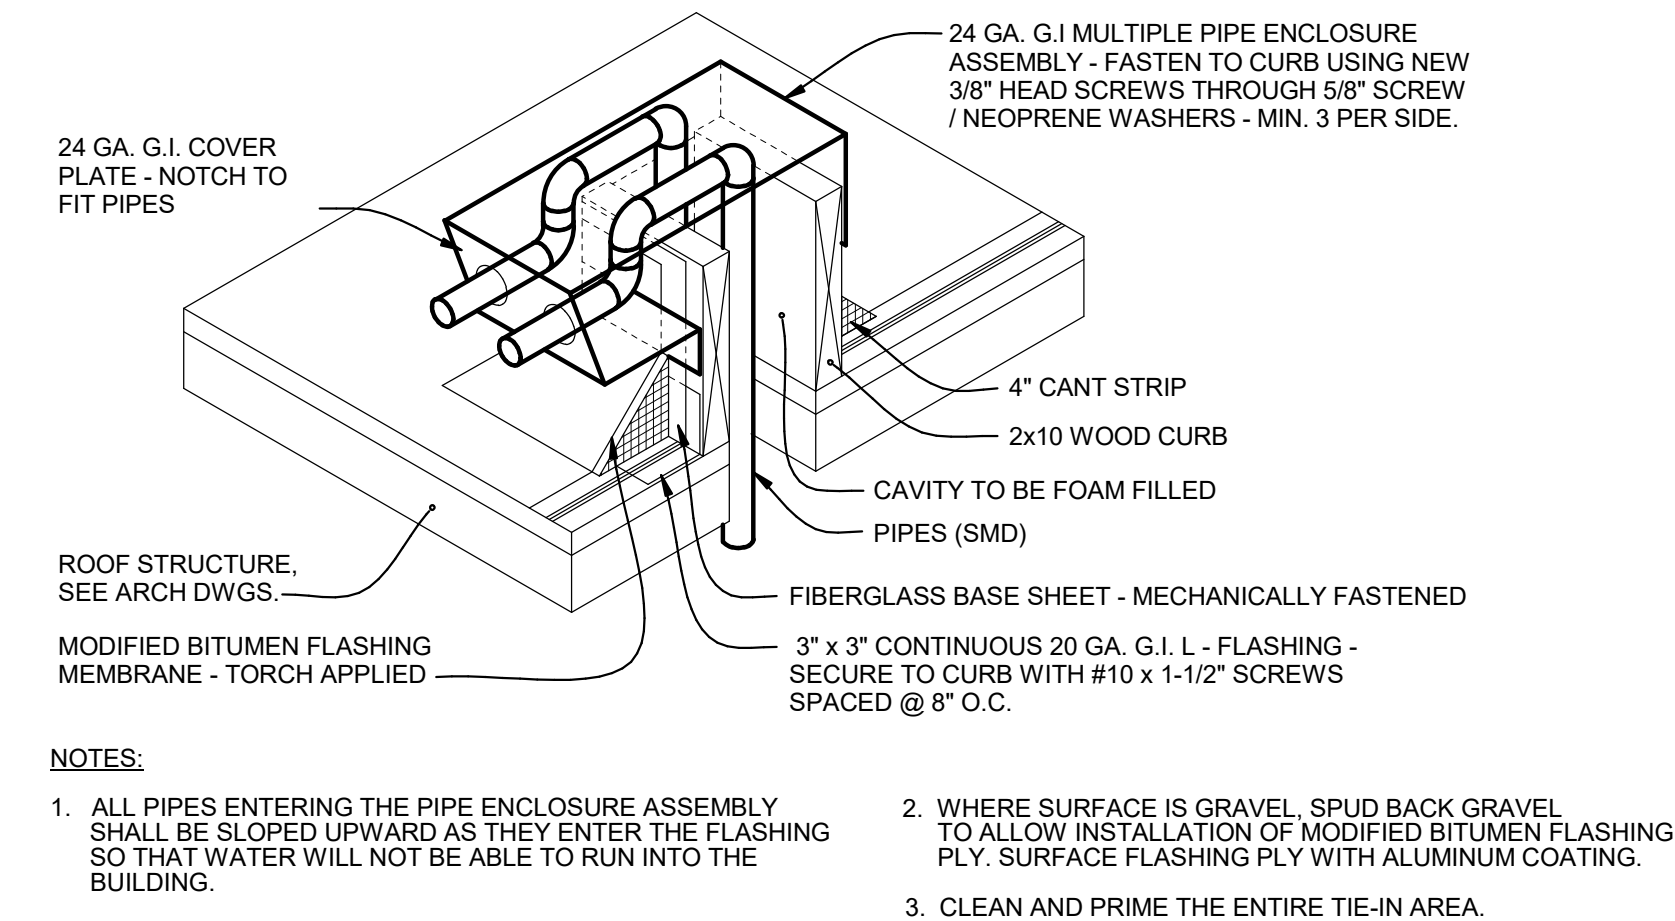

**D** PIPE ENCLOSURE DETAIL  
SCALE: NONE

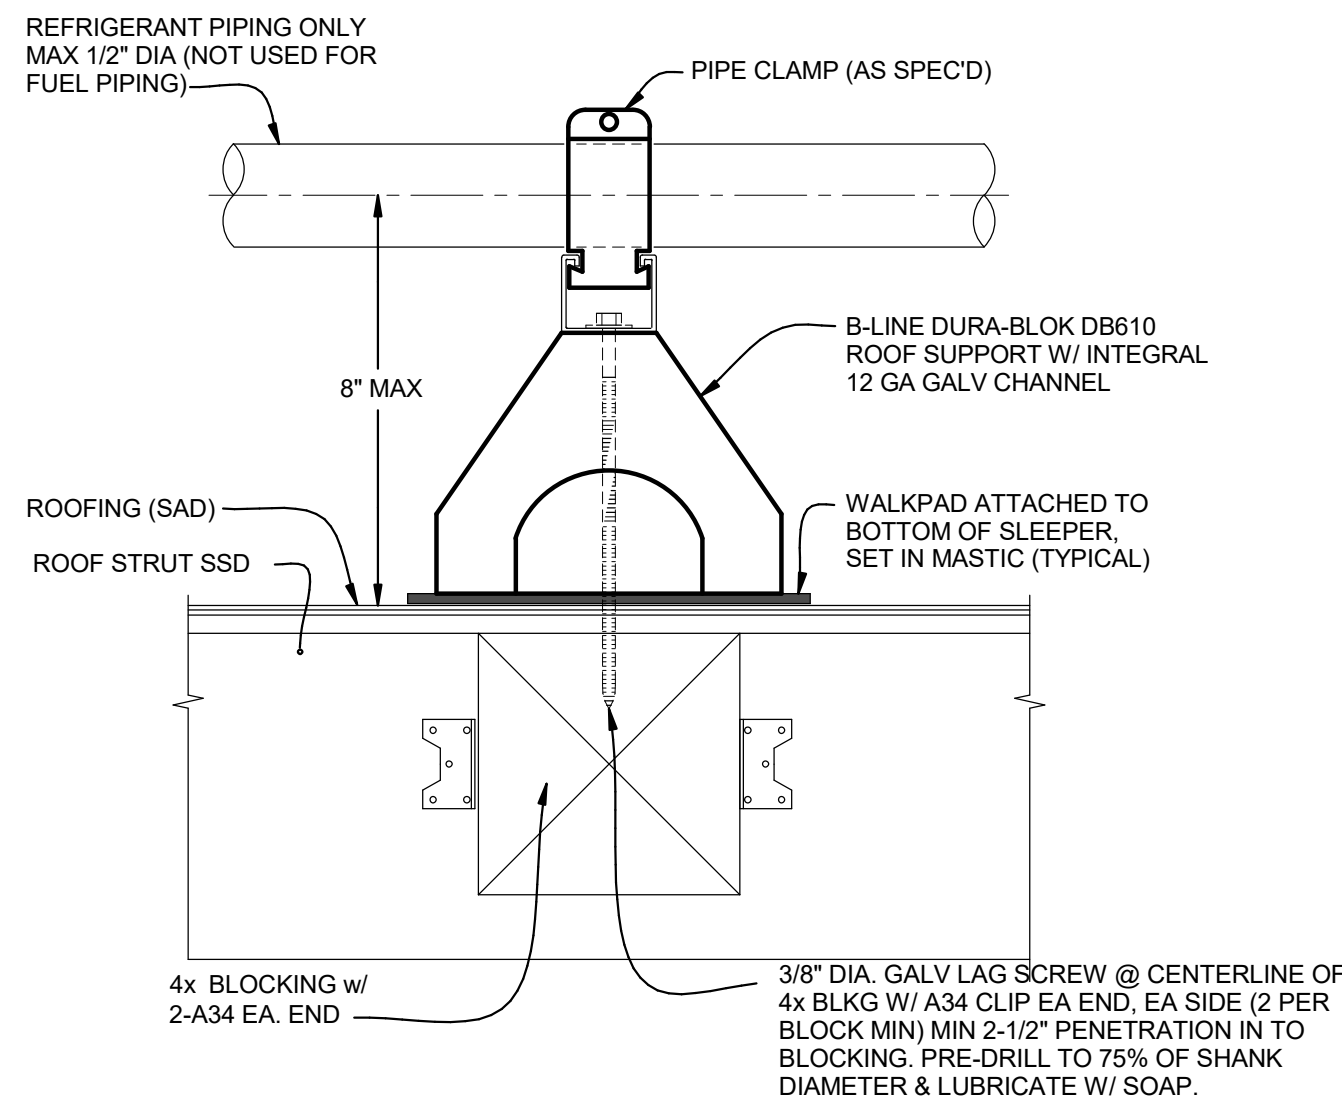

**E** PIPING SUPPORT ON ROOF DETAIL  
SCALE: NONE

**QUATTROCCHI KWOK ARCHITECTS**  
Main Office:  
636 Fifth Street, Santa Rosa, CA 95404  
East Bay:  
55 Harrison Street, Suite 525,  
Oakland, CA 94607  
(707) 576-0829

SIGNED: OCTOBER 30, 2020

**COSTA ENGINEERS INC.**  
3274 Villa Lane Suite, CA 94618 ph: 707-252-9177 fax: 707-252-0473

REGISTERED PROFESSIONAL ENGINEER  
CHRISTOPHER J. DEL CORRAL  
No. 33600  
Exp. 12-31-20  
MECHANICAL  
STATE OF CALIFORNIA

**FREEDOM HIGH SCHOOL**

**NEW AUXILIARY GYMNASIUM**

1050 NEROLY RD,  
OAKLEY, CA 94561

**LIBERTY UNION HIGH SCHOOL DISTRICT**



DSA APP NO. 01-119278	
ARCH PROJECT NO:	1869.00
DRAWN BY:	MQ
DRAWING SCALE:	
PTN: 61721-78	FILE NO: 7-H4
BID DOCUMENT	
APRIL 27, 2021	
SHEET TITLE	

**MECHANICAL DETAILS**


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**M-M7.2**



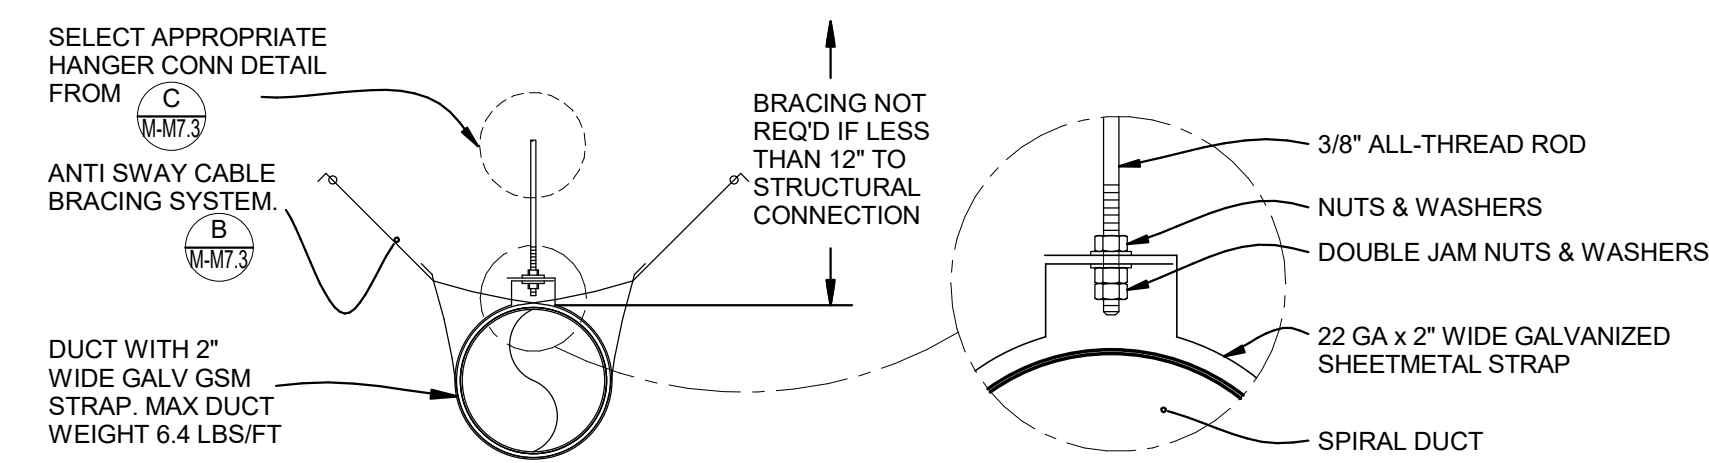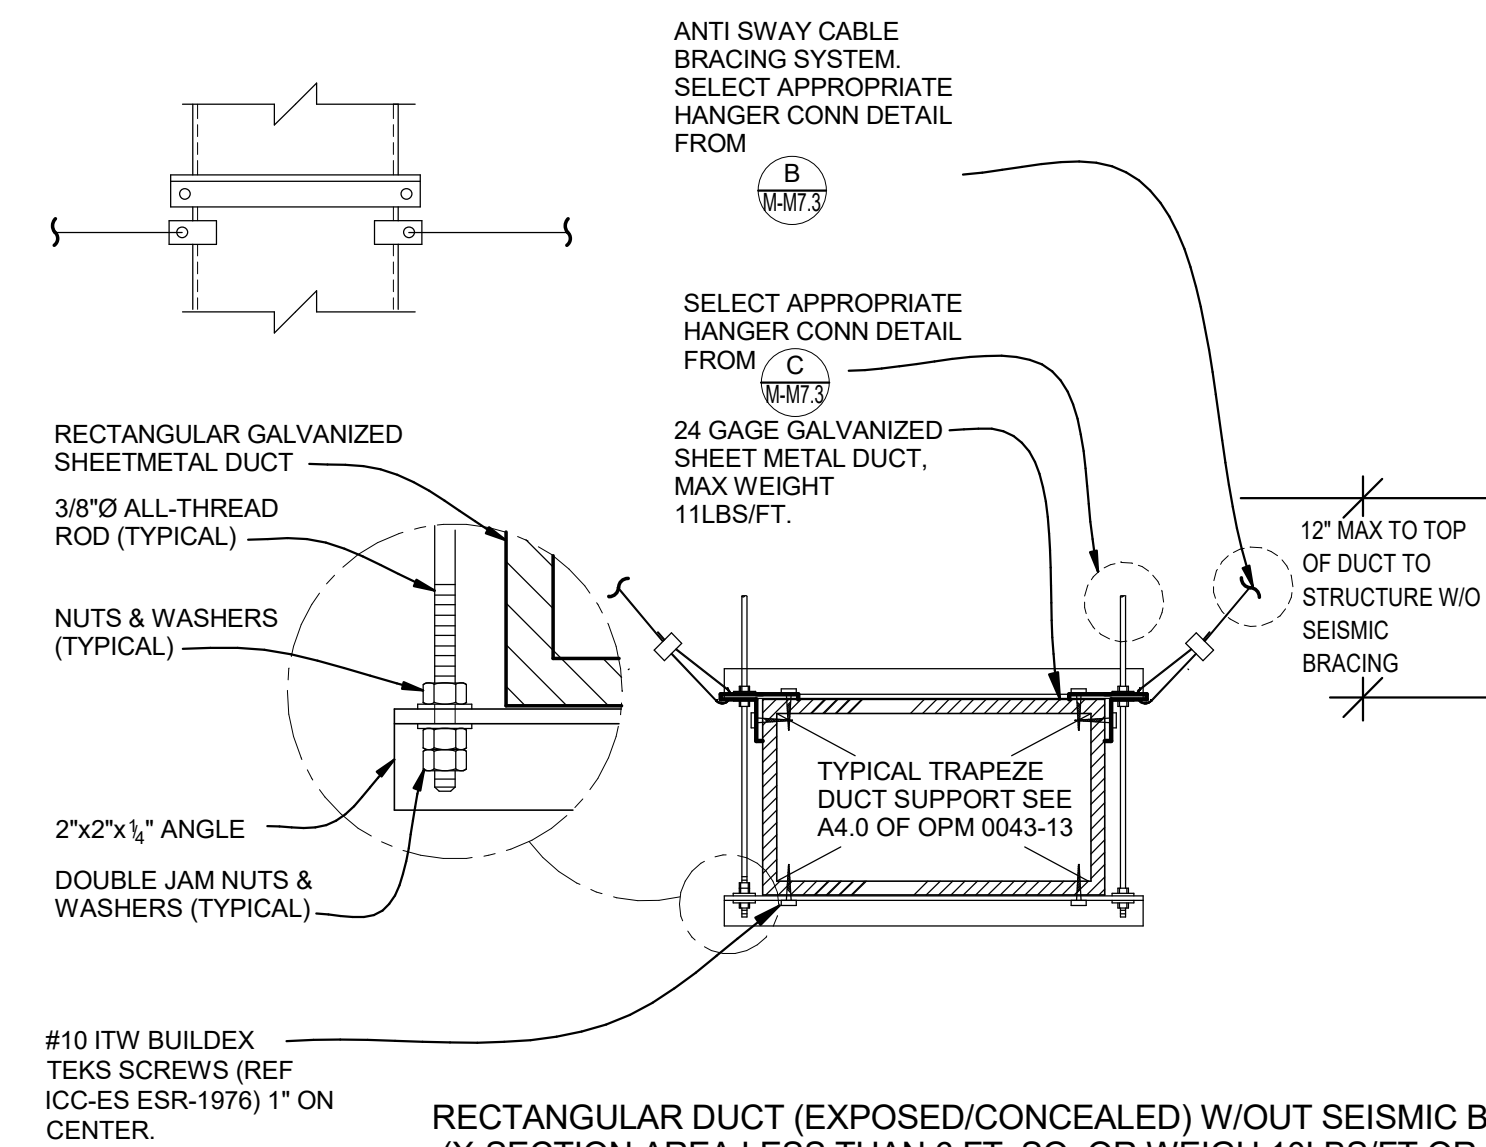


ROUND DUCT (EXPOSED/CONCEALED)  
(WITH CROSS-SECTIONAL AREA LARGER THAN 6 SQFT)

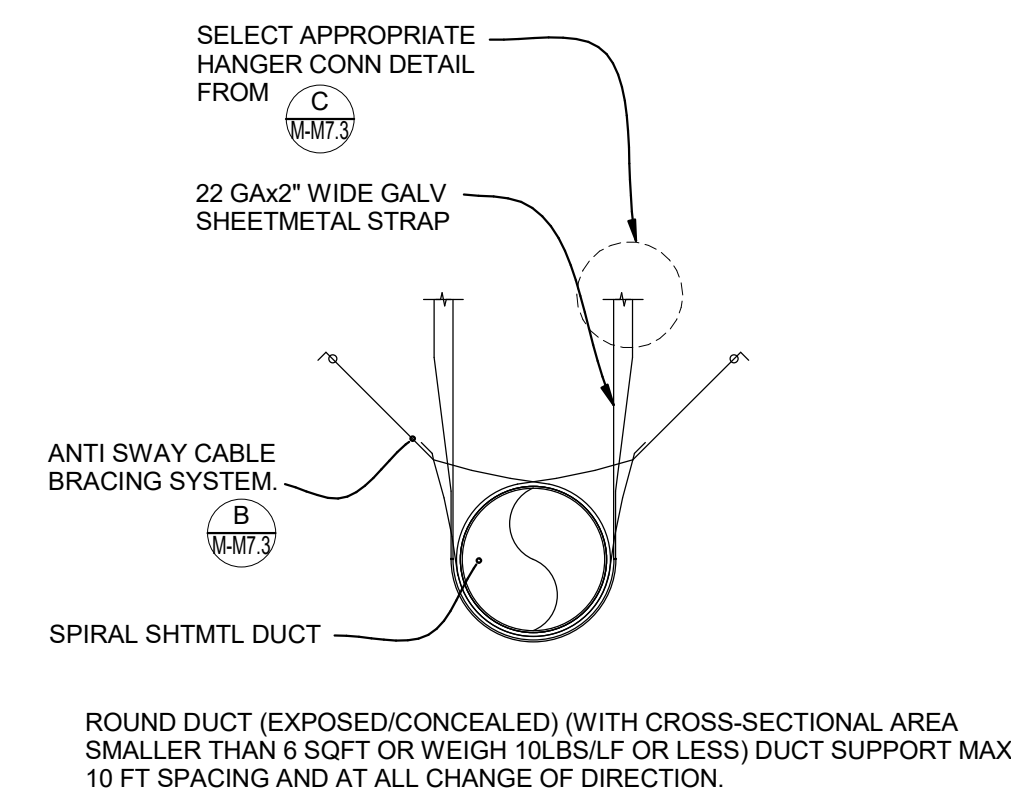

- DUCT SUPPORT NOTES:

- A. ALL STRAPS, RODS, TRAPEZE ANGLES AND TRAPEZE CHANNELS SHALL BE SIZED AND INSTALLED IN ACCORDANCE WITH OPM-0043-13
- B. ALL BOLTS, NUTS, SCREWS AND OTHER FASTENING DEVICES SHALL BE LOAD-RATED AND SHALL MEET ALL CODE REQUIREMENTS AND SAFETY FACTORS WHICH APPLY.
- C. WIRE, USED IN LIEU OF STRAPS AND RODS, IS NOT ALLOWED.
- D. WHERE APPLICABLE, INSTALL INSULATION AFTER INSTALLING DUCT HANGERS.
- E. CROSS BRACING NOT REQUIRED ON RECTANGULAR AND ROUND DUCT WITH GEOMETRIC PLATING AREA EQUAL TO 6 sq ft OR LESS, OR WEIGHT 10 lbs/ft OR LESS, AND ARE WITHIN 12' OF STRUCTURE PER OPM 0043-13 PAGE A4.0.
- F. SUPPORTS SHALL BE PLACED AT 10'-0" ON CENTER (MAX) FOR ROUND DUCTS AND AT ALL CHANGES IN DIRECTION. RECTANGULAR DUCT SUPPORTS SHALL BE PLACED AT 8'-0" ON CENTER (MAX) AND AT ALL CHANGES IN DIRECTION.
- G. DUCTS GREATER THAN 12" FROM STRUCTURE PER OPM 0043-13 PAGE A4.0 SHALL REQUIRE FOUR WAY SEISMIC CABLE SUPPORTS REQUIRED FOR TRAPEZE AT 40' MAX SPACING PER OPM 0043-13 PAGE D2.22. MIN (2) PER DUCT RUN. FOR RECTANGULAR DUCT LESS THAN 10LBS/FT, USE OPM 0043-13 PAGE D2.22. MIN (2) PER DUCT RUN. FOR ROUND DUCTS, USE OPM 0043-13 PAGE D2.22. MIN (2) PER DUCT RUN. AT 40 FT MAX SPACING PER OPM 0043-13 PAGE D6.12. MIN (2) PER DUCT RUN.

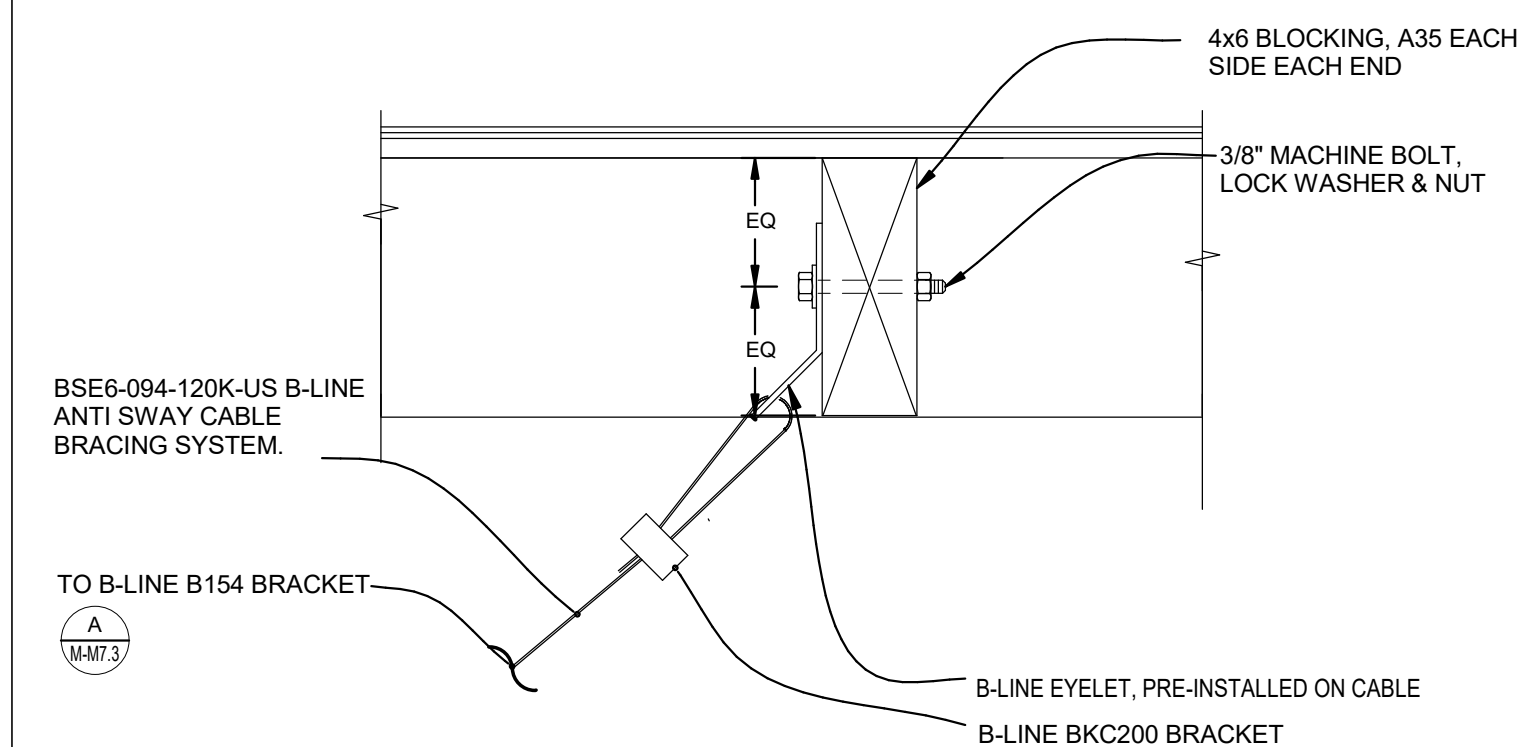


### **TYPICAL DUCT SUPPORT DETAIL**

SCALE: NTS

## ANTI SWAY CABLE BRACING SYSTEM


SCALE: NONE

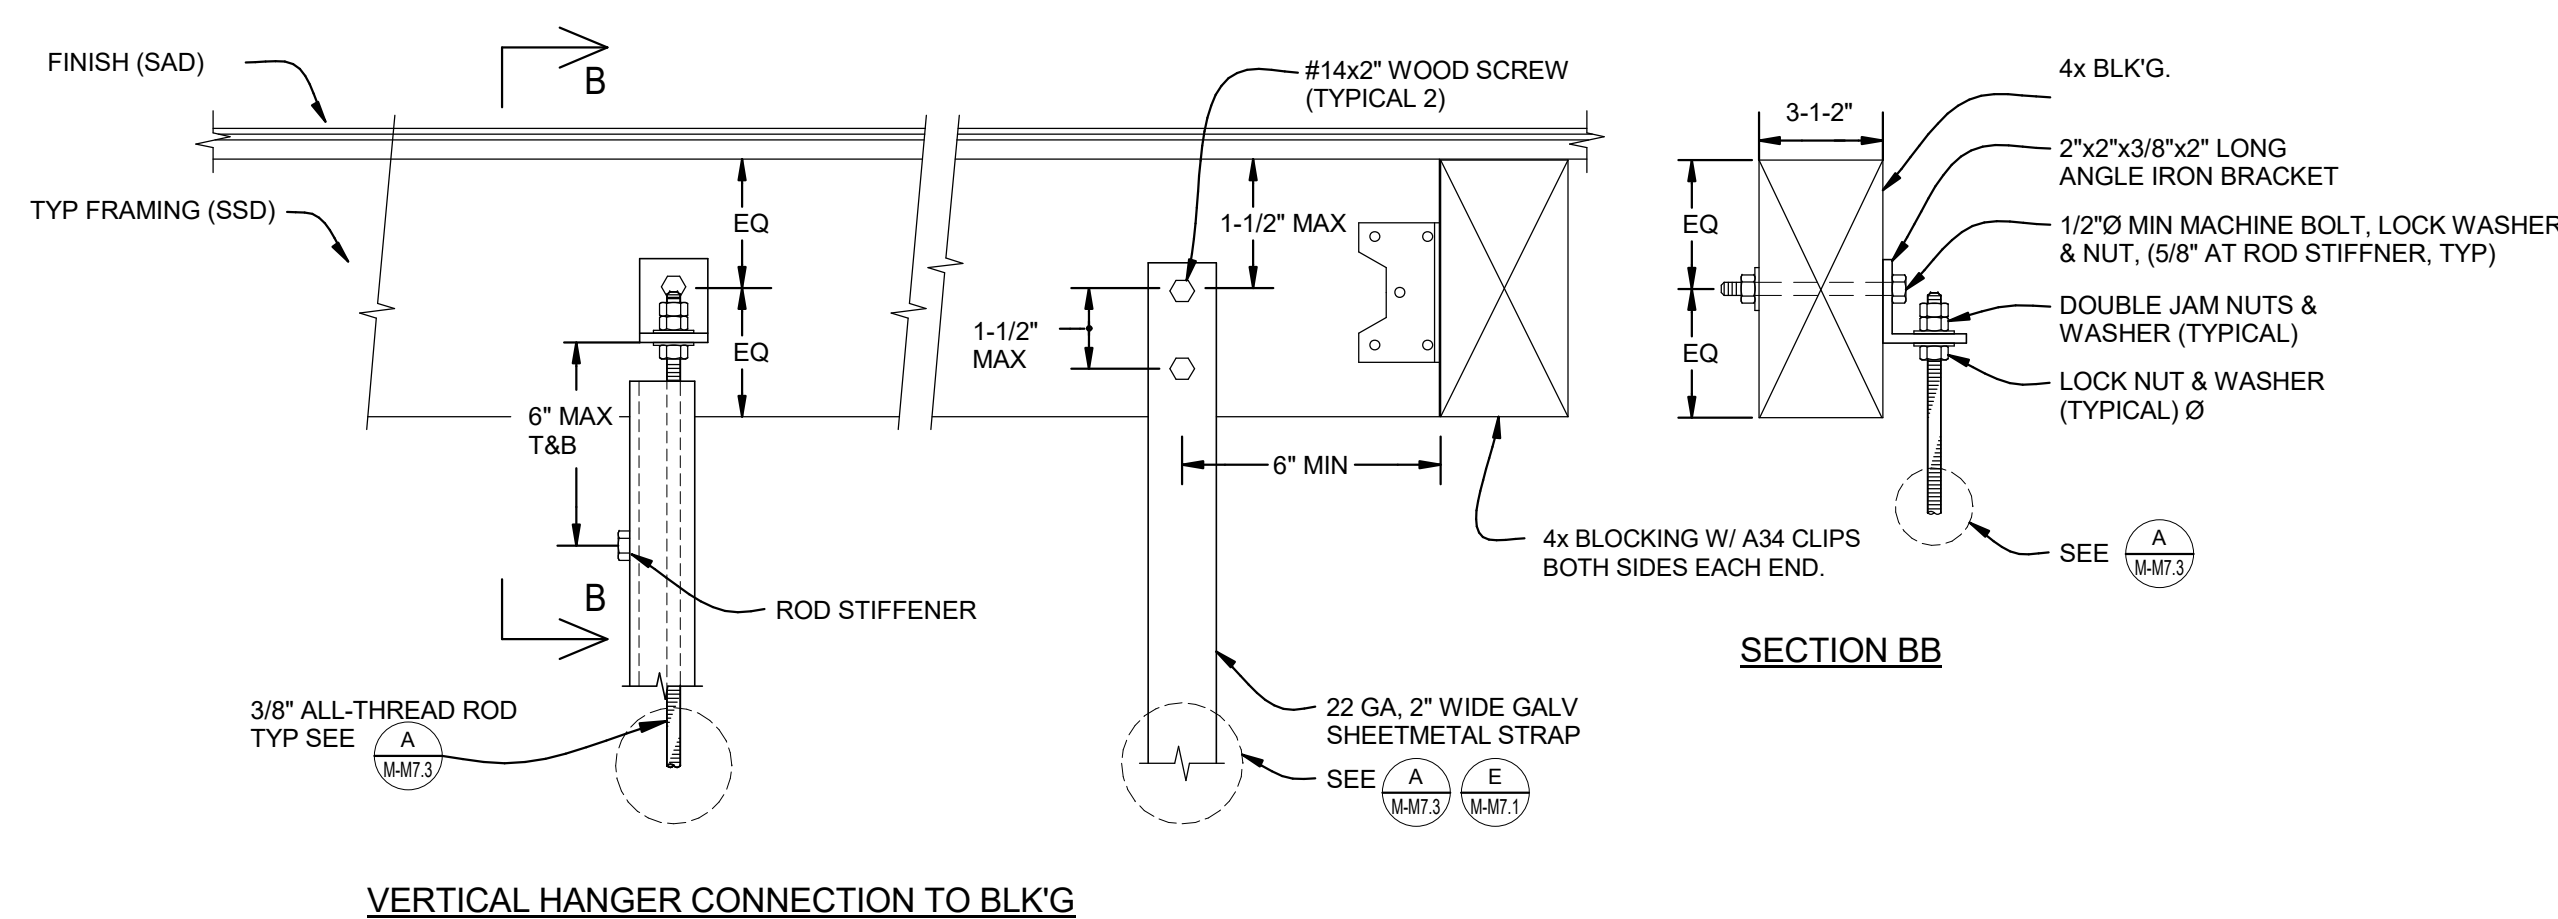

### VERTICAL HANGER CONNECTION TO BLK'G

## HANGER CONNECTION TO WOOD FRAMING

SCALE: NONE

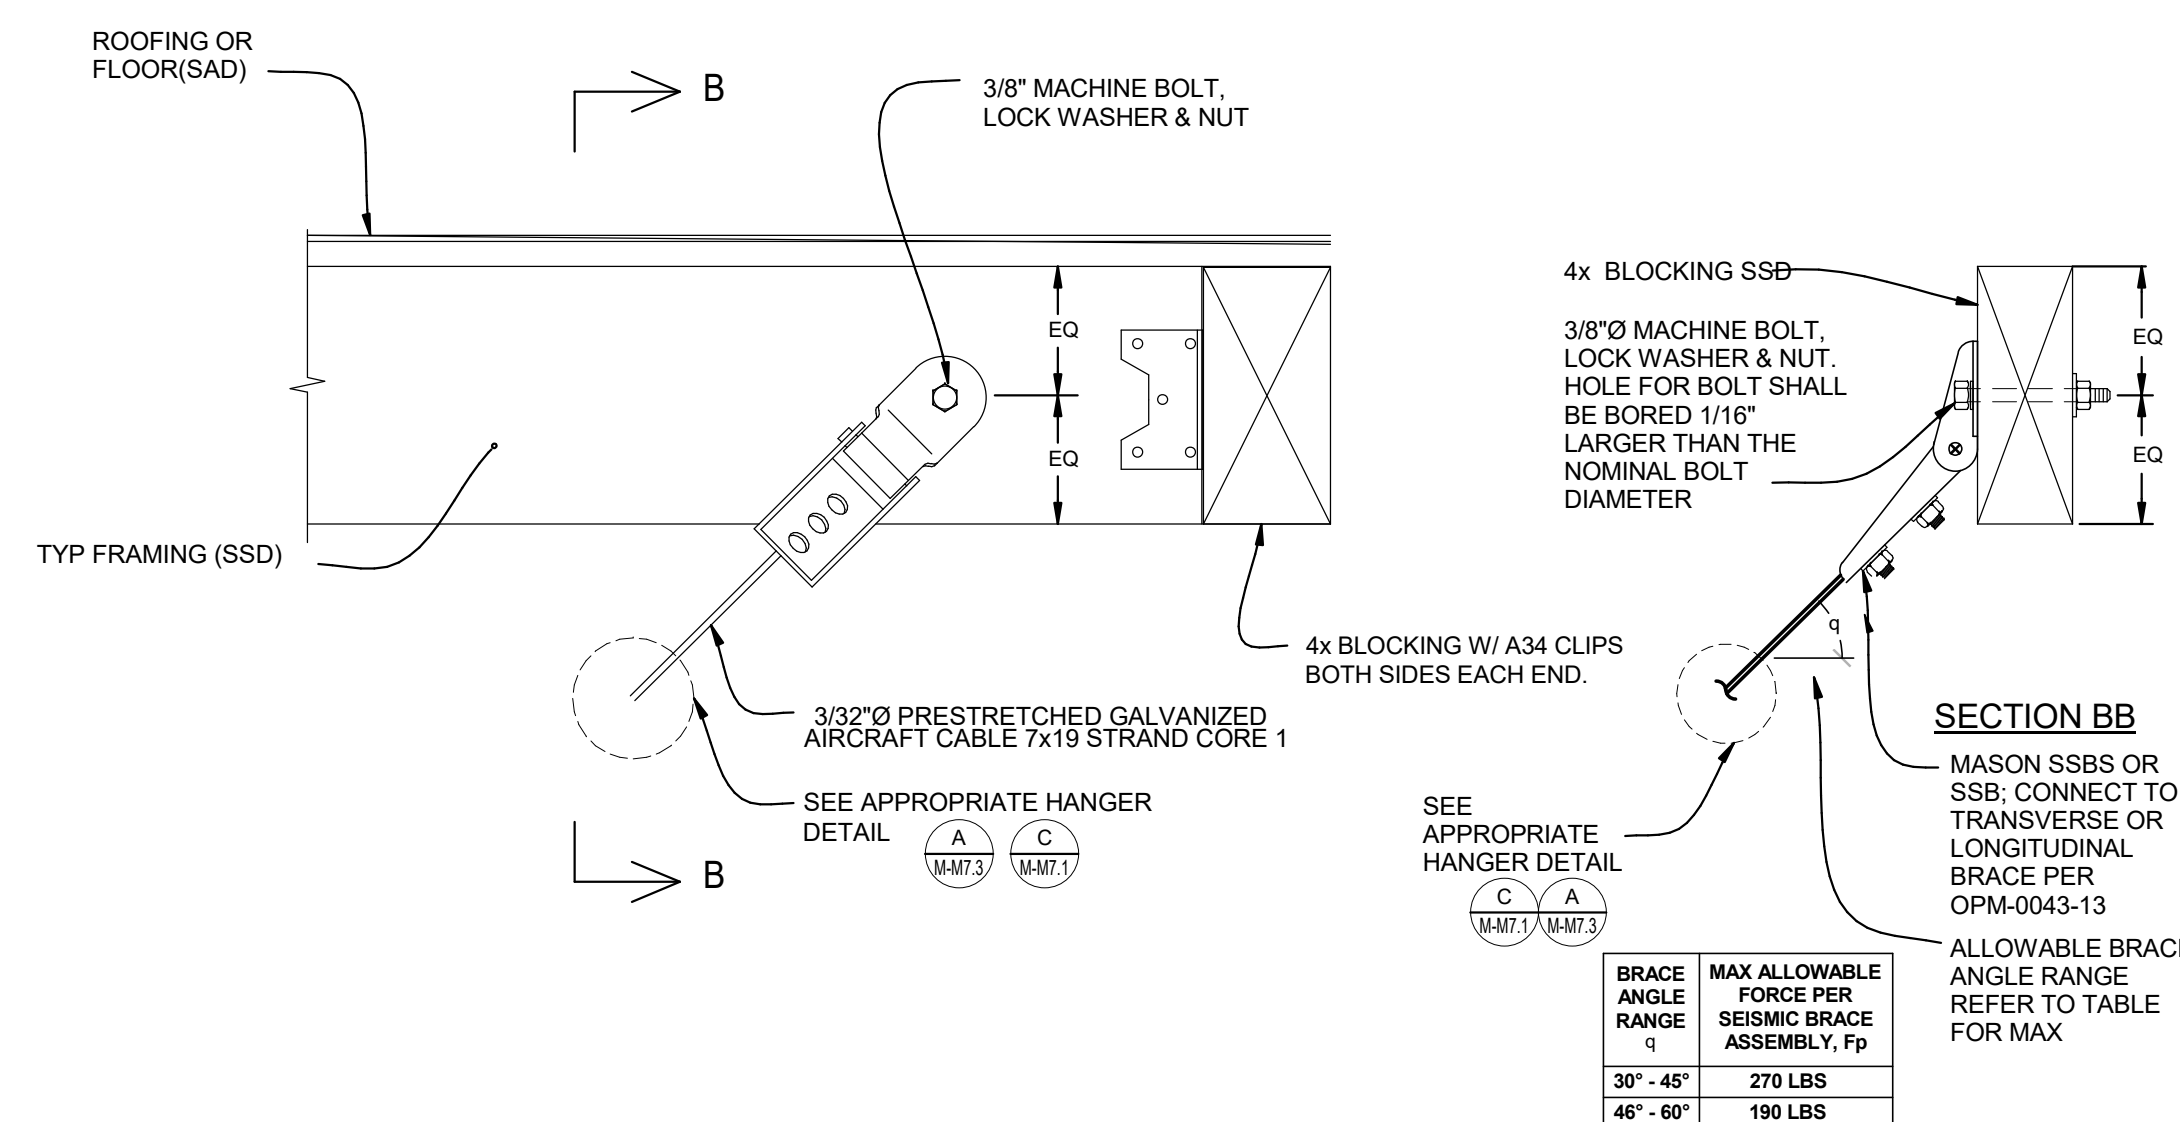

BRACE ANGLE RANGE $\phi$	MAX ALLOWABLE FORCE PER SEISMIC BRACE ASSEMBLY, $F_p$
30° - 45°	270 LBS
46° - 60°	190 LBS

## SEISMIC BRACING CONNECTIONS TO WOOD FRAMING

SCALE: NONE



QUATTROCCHI KWOK  
ARCHITECTS

Main Office:  
36 Fifth Street, Santa Rosa, CA 95404  
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DSA APP NO. 01-119278

RESEARCH PROJECT NO: 1869.00

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SHEET TITLE

## MECHANICAL DETAILS

SHEET NUMBER

## M-M7.3






4/27/2021 11:53:14 AM C:\Users\robert\Documents\20053 Freedom HS Auxiliary Gym RVT18 renland@costaengineers.com.rvt






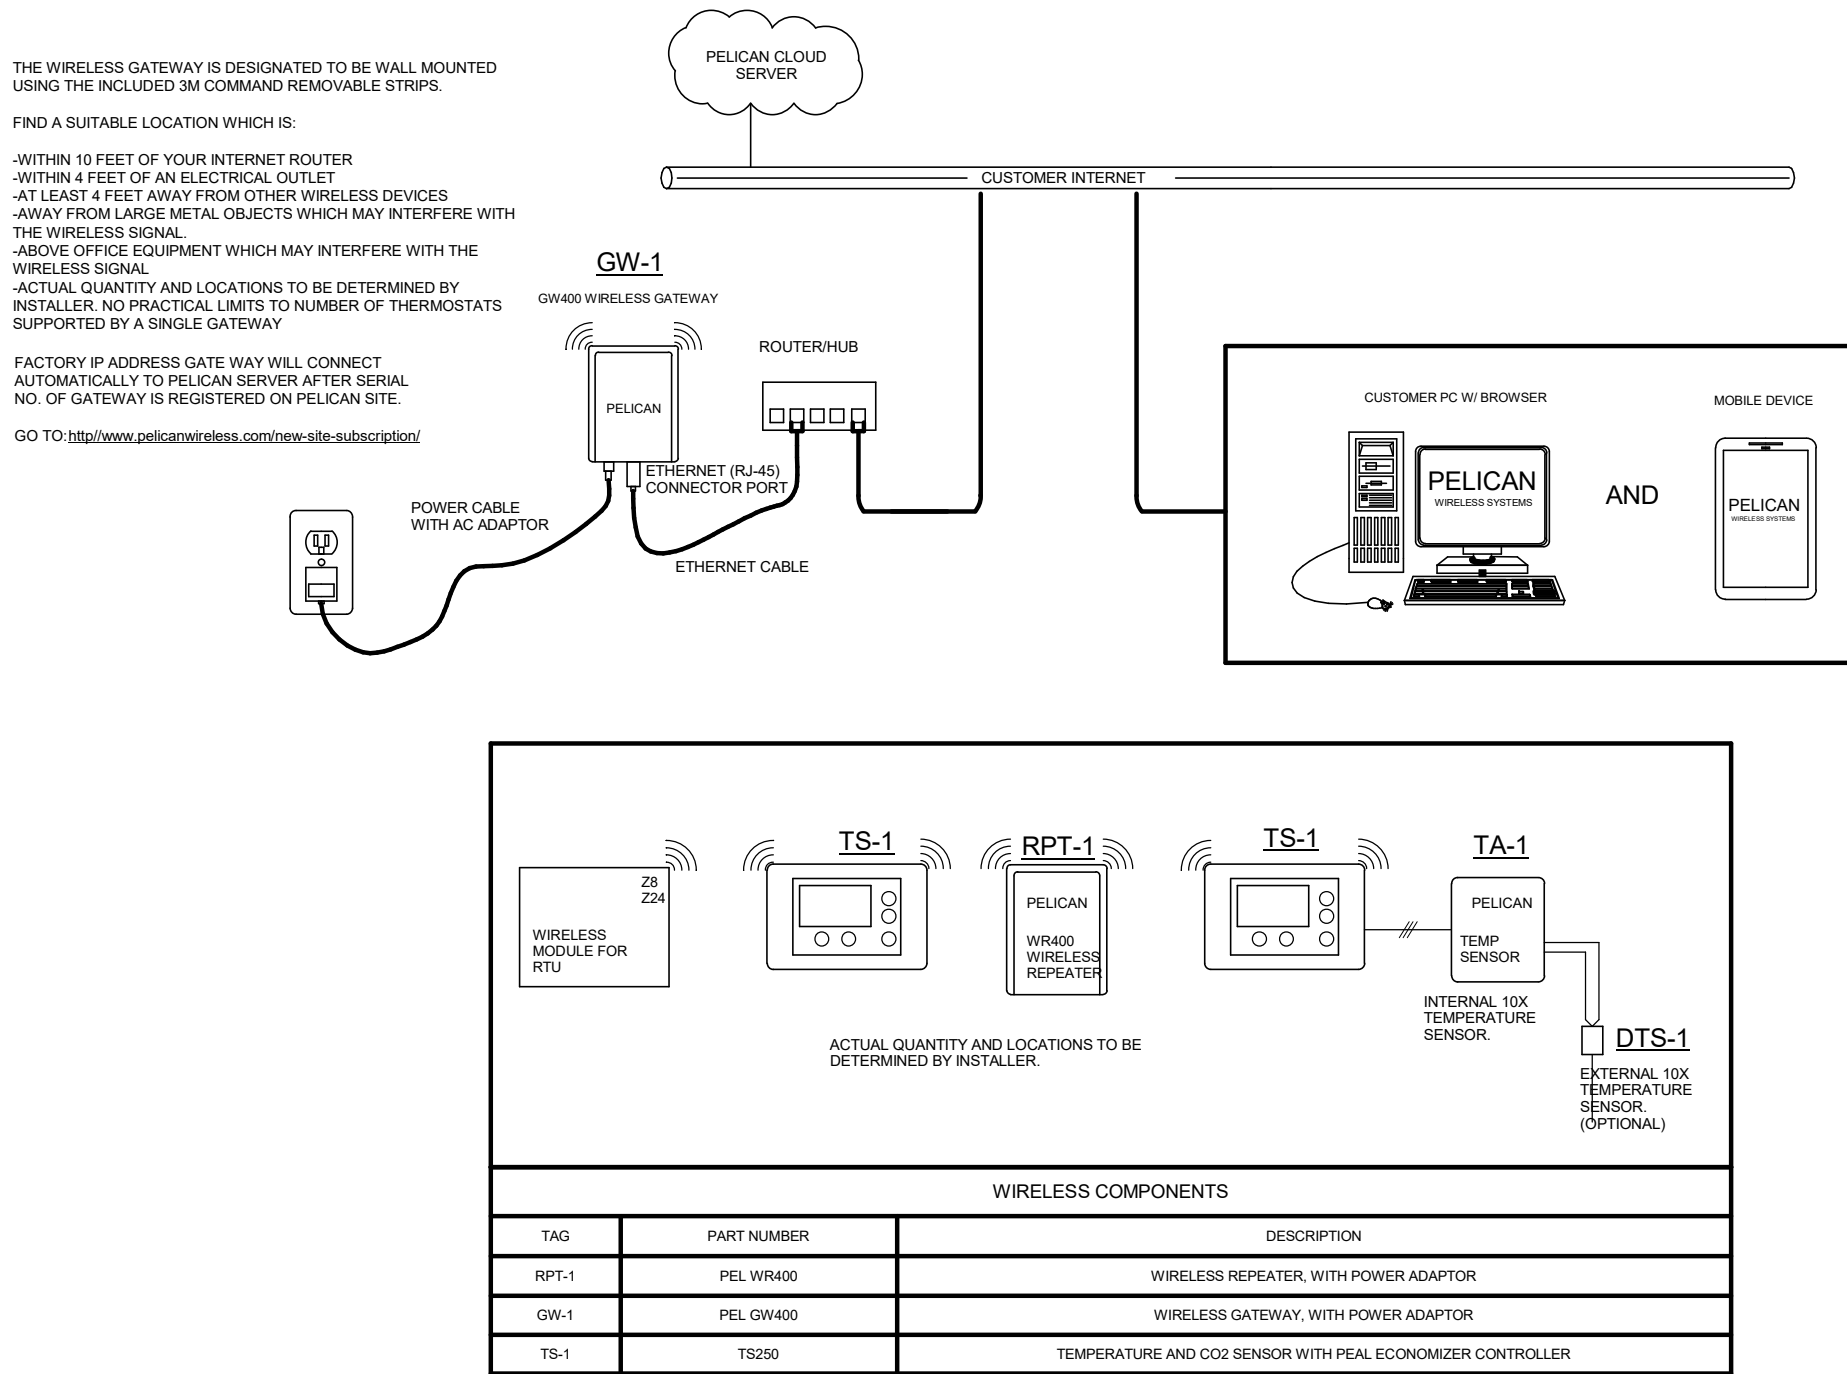


**A** EXISTING CAMPUS PELICAN WIRELESS LAN LAYOUT

SCALE: NONE

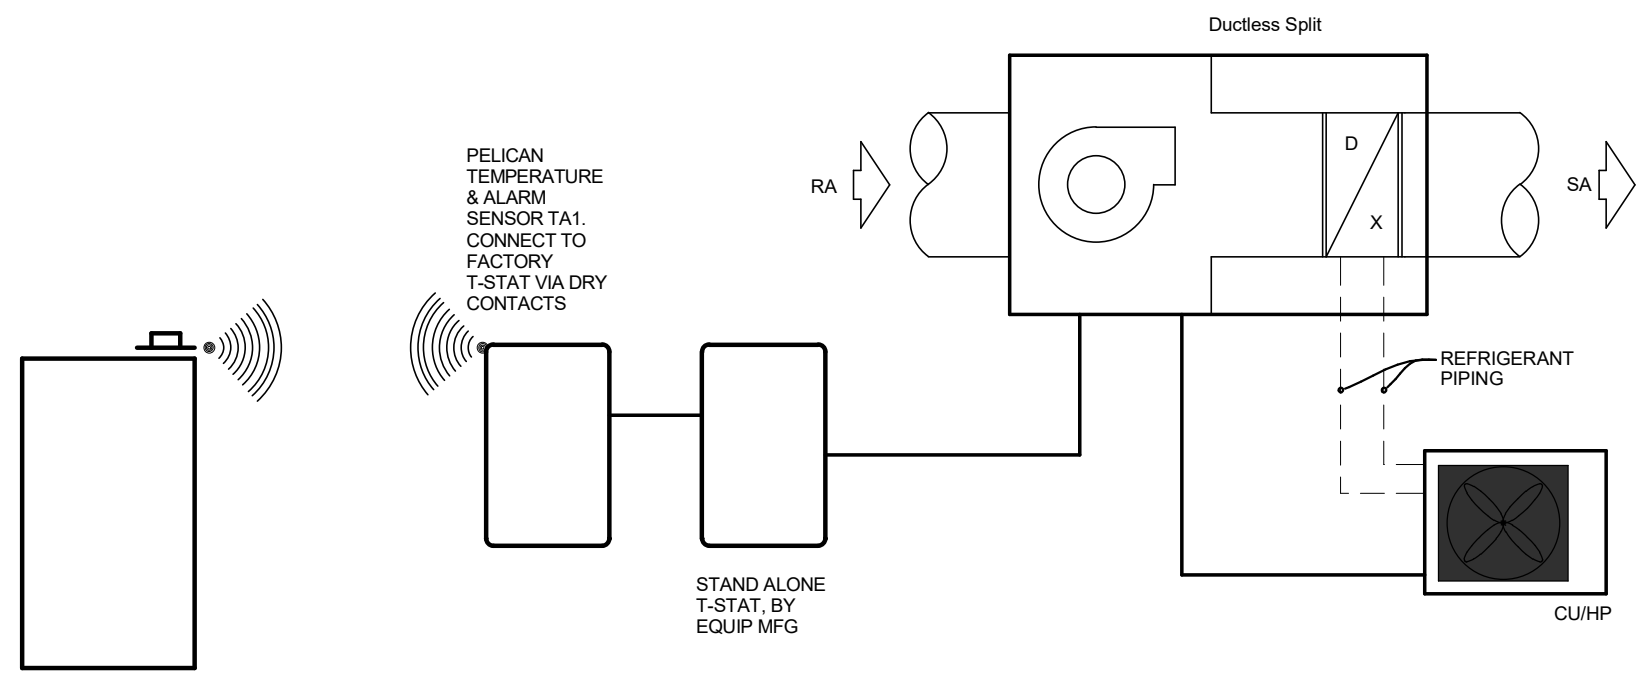

**B** SINGLE ZONE DUCTLESS SPLIT SYSTEM WIRELESS CONTROL DIAGRAM

SCALE: NONE

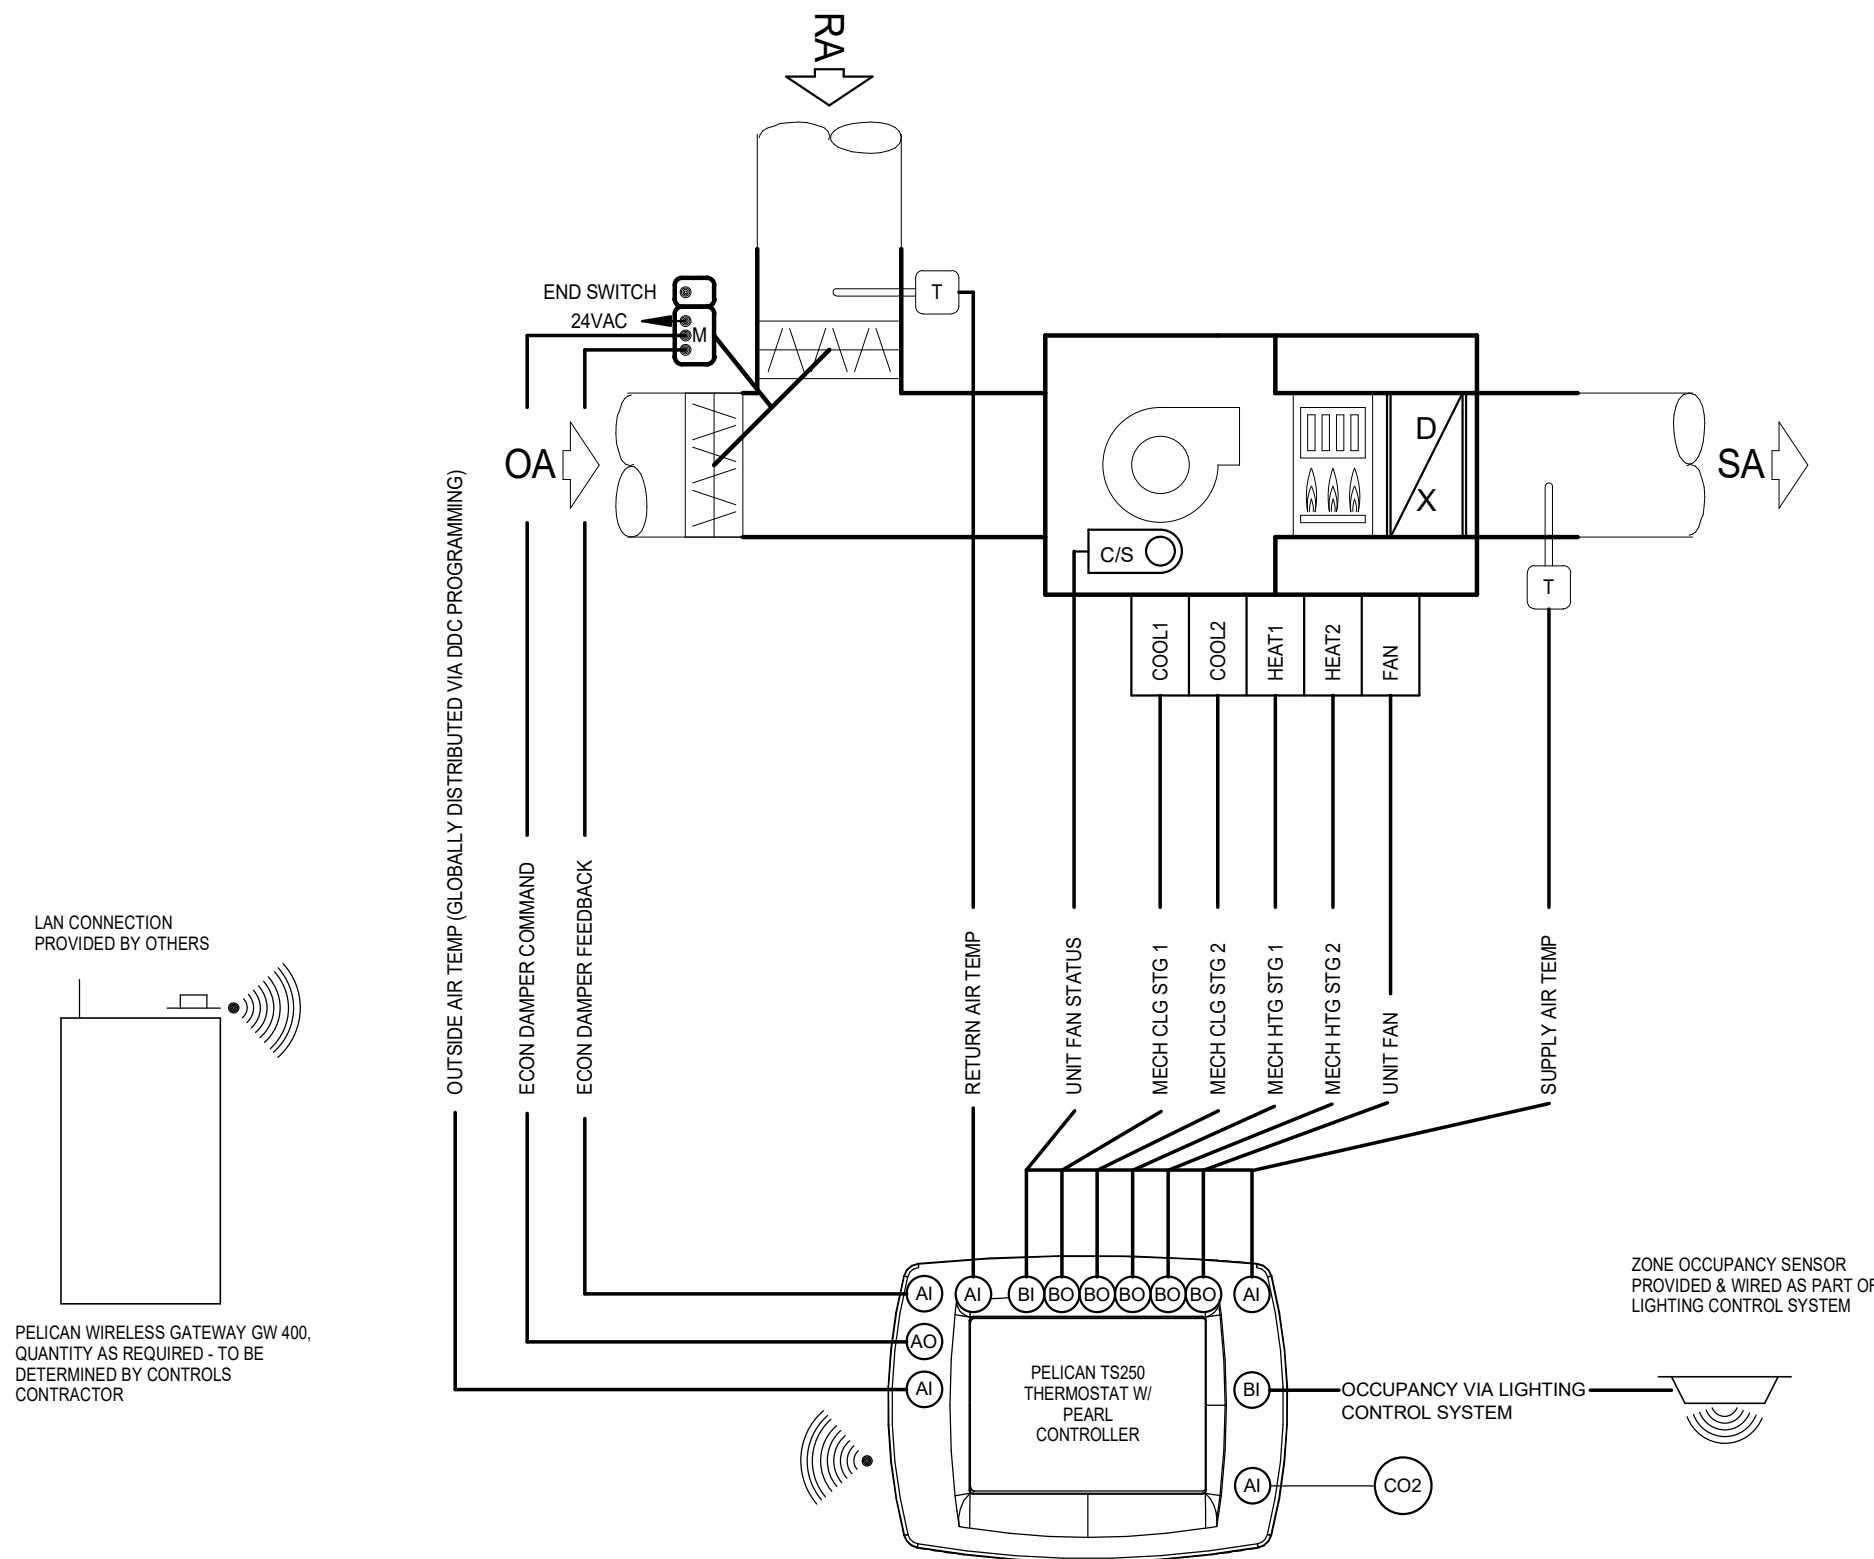


**C** PACKAGE AC UNIT W/ DEMAND CONTROL VENTILATION & OCCUPANCY MONITORING

SCALE: NONE

PACKAGED AC UNIT WITH ECONOMIZER, POWER EXHAUST, DEMAND CONTROL VENTILATION, ZONE OCCUPANCY MONITORING

- SYSTEM OVERVIEW
  - EACH AC UNIT WILL BE DIRECTLY CONTROLLED BY ITS OWN DEDICATED EMS (ENERGY MANAGEMENT SYSTEM) UNITARY CONTROLLER.
  - EMS UNITARY CONTROLLER WILL BE CONNECTED TO A WALL MOUNTED ELECTRONIC ZONE TEMPERATURE SENSOR WITH INTEGRAL RELATIVE HUMIDITY SENSOR AND CO2 SENSOR.
  - ELECTRONIC ZONE TEMPERATURE SENSOR SHALL HAVE A TOUCH SCREEN LCD INTERFACE WHICH INCLUDES: 1) DIGITAL PUSHBUTTONS FOR WARMER/COOLER SETPOINT CONTROL; 2) VISUAL DISPLAY OF ROOM TEMPERATURE, ROOM HUMIDITY, ROOM CO2 AND AMBIENT OSA TEMPERATURE; AND 3) DIGITAL PUSHBUTTON AFTER-HOURS OVERRIDE TIMER CONTROL, WITH USER ADJUSTABLE DURATION. THE AFTER-HOURS OVERRIDE DURATION SHALL HAVE THE ABILITY TO BE LIMITED FROM THE FRONT-END.
- OCCUPANCY/VACANCY MONITORING
  - ZONE OCCUPANCY AND VACANCY WILL BE ACTIVELY MONITORED BY CONNECTION TO LIGHTING CONTROL SYSTEM OCCUPANCY SENSOR(S). IF AVAILABLE, MONITORING SHALL BE ACCOMPLISHED VIA BACNET SYSTEM INTEGRATION. OTHERWISE, BAS CONTRACTOR SHALL MONITOR AUXILIARY CONTACTS ON LIGHTING CONTROL SYSTEM OCCUPANCY SENSOR(S).
- UNIT FAN OPERATION
  - WHEN THE ZONE IS IN OCCUPIED MODE OR IN AFTERHOURS MODE, THE FAN SHALL RUN CONTINUOUSLY, UNLESS VACANT MODE HAS BEEN TRIGGERED.
  - LOW SPEED AND HIGH SPEED FAN OPERATION TO BE CONTROLLED BY AC UNIT MANUFACTURER'S INTERNAL CONTROLS INDEPENDENT OF EMS BASED UPON CALL FOR HEATING, COOLING OR VENTILATION.
  - DURING THE UNOCCUPIED MODE AS DETERMINED BY EMS TIME SCHEDULE, THE UNIT FAN CYCLES WITH DEMAND AND THE TEMPERATURE IS CONTROLLED BY THE UNOCCUPIED SPACE TEMPERATURE HEATING AND COOLING SETPOINTS.
- MINIMUM OUTDOOR AIR VENTILATION
  - DURING OCCUPIED MODE OR AFTERHOURS MODE, THE ECONOMIZER DAMPER SHALL BE COMMANDED BY THE EMS UNITARY CONTROLLER TO MAINTAIN A POSITION WHICH SATISFIES THE MINIMUM OUTDOOR AIR VENTILATION REQUIREMENTS FOR THE ZONE. DAMPER POSITION(S) DETERMINED BY AIR BALANCING CONTRACTOR.
- DEMAND CONTROL VENTILATION
  - EMS UNITARY CONTROLLER WILL BE CONNECTED TO A WALL MOUNTED CO2 SENSOR TO MONITOR ZONE CO2 CONCENTRATION.
- DURING OCCUPIED MODE OR AFTERHOURS MODE, THE EMS UNITARY CONTROLLER SHALL RESET THE OUTSIDE AIR DAMPER MINIMUM POSITION TO MAINTAIN THE CO2 CONCENTRATION BELOW 1,000 PPM.
- AUTOMATIC DEMAND REDUCTION CONTROLS
  - EMS SHALL BE PROGRAMMED WITH CAPABILITY TO IMPLEMENT CENTRALIZED DEMAND SHED FOR ALL NON-CRITICAL ZONES UPON CALL FOR AUTOMATIC DEMAND REDUCTION. CRITICAL ZONES SHALL NOT BE IMPACTED BY DEMAND SHED CONSERVATION MEASURES.
- VACANT MODE CONTROL
  - WHEN THE ZONE HAS BEEN SCHEDULED FOR OCCUPANCY FOR AT LEAST ONE HOUR AND THE OCCUPANCY SENSOR HAS CONFIRMED THAT ZONE HAS BEEN VACANT FOR 5 MINUTES (ADJUSTABLE: MAXIMUM 30 MINUTES), ZONE SHALL BE PLACED INTO VACANT MODE.
  - RESET COOLING AND HEATING SETPOINTS UP AND DOWN BY 2°F (ADJUSTABLE) OR MORE.
  - MINIMUM OUTDOOR AIR VENTILATION REQUIREMENTS IN THE ZONE NEED ONLY BE MAINTAINED 15 MINUTES OUT OF EVERY 60 MINUTES WHILE THE ZONE IS IN VACANT MODE.
  - UPON DETECTION OF OCCUPANCY, VACANT MODE SHALL BE CLEARED.
- ZONE PRE-OCCUPANCY PURGE
  - THE EMS SHALL SCHEDULE THE ZONE TO BE IN OCCUPIED MODE ONE HOUR PRIOR TO THE ACTUAL TIME OF ANTICIPATED OCCUPANCY.
- HEATING OPERATION
  - THE CONTROLLER COMPARES THE HEATING SETPOINT WITH THE SPACE TEMPERATURE AND DETERMINES A NEED-HEATING CONTROL SIGNAL TO STAGE A GAS REGULATING VALVE ON THE UNIT.
- ECONOMIZER TO BE COMMANDED TO MIN CFM SETPOINT AND MECHANICAL COOLING TO BE LOCKED OUT DURING HEATING MODE.
- COOLING OPERATION
  - THE CONTROLLER COMPARES THE COOLING SETPOINT WITH THE SPACE TEMPERATURE AND DETERMINES A NEED-COOLING SIGNAL.
  - THE FIRST STAGE OF COOLING WILL ENABLE THE ECONOMIZER TO PROVIDE FREE COOLING FOR AS LONG AS POSSIBLE.
  - THE SECOND STAGE WILL ENABLE THE COMPRESSOR(S) TO MAINTAIN THE ROOM SET POINT.
  - MECHANICAL HEATING TO BE LOCKED OUT DURING COOLING MODE.
- FAULT DETECTION DIAGNOSTICS
  - THE EMS DDC CONTROLLER SHALL MONITOR THE FOLLOWING ECONOMIZER ACTUATOR FAULT DETECTION DIAGNOSTIC CONDITIONS AND BROADCAST RESULTS VIA EMS NETWORK:
    - TEMPERATURE SENSOR FAILURE/FAULT
    - ECONOMIZER NOT ECONOMIZING WHEN ENABLED
    - ECONOMIZER ECONOMIZING WHEN DISABLED
    - ECONOMIZER DAMPER MODULATION FAILURE
    - EXCESS OUTDOOR AIR
- MONITORING - THE FOLLOWING CONDITIONS SHALL BE MONITORED AND DISPLAYED AT EMS OPERATOR WORKSTATION/GRAPHICAL USER INTERFACE:
  - SUPPLY AIR TEMPERATURE.
  - ROOM TEMPERATURE.
  - ROOM CO2 CONCENTRATION.
  - ROOM OCCUPANCY STATUS.
  - CURRENT MODE (HEATING/COOLING/FAN).
  - SUPPLY AIR TEMPERATURE ATTAINED LAST TIME UNIT WAS IN HEATING.
  - SUPPLY AIR TEMPERATURE ATTAINED LAST TIME UNIT WAS IN COOLING.
  - CURRENT COMMAND STATUS OF FAN, ECONOMIZER, COMPRESSOR AND GAS VALVE.
  - RUN TIME METERS ON FAN, COMPRESSOR, AND HEAT.
  - FAN STATUS THRU CURRENT SWITCH.
  - ECONOMIZER ACTUATOR FEEDBACK STATUS.

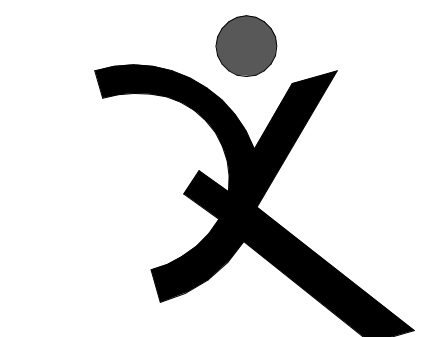

QUATTROCCHI KWOK  
ARCHITECTS  
Main Office:  
636 Fifth Street, Santa Rosa, CA 95404  
East Bay:  
55 Harrison Street, Suite 525,  
Oakland, CA 94607  
(707) 576-0629

SIGNED: OCTOBER 30, 2020



COSTA ENGINEERS INC.

3274 Villa Lane Suite, CA 94608 ph: 707-252-9177 fax: 707-252-9473



FREEDOM  
HIGH SCHOOL

NEW AUXILIARY  
GYMNASIUM

1050 NEROLY RD,  
OAKLEY, CA 94561

LIBERTY UNION  
HIGH SCHOOL  
DISTRICT


DSA APP NO. 01-119278

ARCH PROJECT NO: 1869.00

DRAWN BY: MQ

DRAWING SCALE:

PTN: 61721-78 FILE NO: 7-H4

BID DOCUMENT

APRIL 27, 2021

SHEET TITLE

CONTROL  
DIAGRAMS

SHEET NUMBER

M-M8.1





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PTN: 61721-78

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SHEET TITLE

## CONTROL DIAGRAMS

SHEET NUMBER

## M-M8.2



Applicable Code: 2019 CBC

02/05/2020

Revised: 02/14/2020

MEP Component Anchorage Note

All mechanical, plumbing, and electrical components shall be anchored and installed per the details on the DSA-approved construction documents. The following components shall be anchored or braced to meet the force and displacement requirements prescribed in the 2019 CBC Sections 1617A.1.18 through 1617A.1.26 and ASCE 7-16 Chapters 13, 26, and 30:

- All permanent equipment and components.
- Temporary, movable or mobile equipment that is permanently attached (e.g. hard wired) to the building utility services such as electricity, gas or water. "Permanently attached" shall include all electrical connections except plugs for 110/220 volt receptacles having a flexible cable.
- Temporary, movable or mobile which is heavier than 400 pounds or has a center of mass located 4 feet or more above the adjacent floor or roof level that directly support the component is required to be restrained in a manner approved by DSA.

The following mechanical and electrical components shall be positively attached to the structure but need not demonstrate design compliance with the references noted above. These components shall have flexible connections provided between the component and associated ductwork, piping, and conduit. Flexible connections must allow movement in both trasverse and longitudinal directions:

- Components weighing less than 400 pounds and having a center of mass located 4 feet or less above the adjacent floor or roof level that directly support the component.
- Components weighing less than 20 pounds, or in the case of distributed systems, less than 5 pounds per foot, which are suspended from a roof or floor or hung from a wall.

The anchorage of all mechanical, electrical and plumbing components shall be subject to the approval of the design professional in general responsible charge of structural engineer delegated responsibility and acceptance by DSA. The project inspector will verify that all components and equipment have been anchored in accordance with the above requirements.

Piping, Ductwork, and Electrical Distribution System Bracing Note

Piping, ductwork, and electrical distribution systems shall be braced to comply with the forces and displacements prescribed in ASCE 7-16 Section 13.3 as defined in ASCE 7-16 Sections 13.6.5, 13.6.6, 13.6.7, 13.6.8; and 2019 CBC, Sections 1617A.1.24, 1617A.1.25 and 1617A.1.26.

The method of showing bracing and attachments to the structure for the identified distribution system are as noted below. When bracing and attachments are based on a preapproved installation guide (e.g., OSHPD OPM for 2013 CBC or later), copies of the bracing system installation guide or manual shall be available on the jobsite prior to the start of and during the haging and bracing of the distribution systems. The Structural Engineer of Record shall verify the adequacy of the structure to support the hanger and brace loads.

Mechanical Piping (MP), Mechanical Ducts (MD), Plumbing Piping (PP), Electrical Distribution Systems (E):

- MP ☐ MD ☐ PP ☐ E ☐ Option 1: Detailed on the approved drawings with project specific notes and details
- MP ☐ MD ☐ PP ☒ E ☐ Option 2: Shall comply with the applicable OSHPD Pre-Approval (OPM #) #OPM-0043-13

APPLICABLE GOVERNING CODES:

2019 CALIFORNIA BUILDING CODE  
2019 CALIFORNIA ELECTRICAL CODE  
2019 CALIFORNIA MECHANICAL CODE  
2019 CALIFORNIA PLUMBING CODE  
2019 CALIFORNIA ENERGY CODE  
2019 CALIFORNIA FIRE CODE  
2019 CALIFORNIA GREEN BUILDING STANDARDS

PLUMBING FIXTURE SCHEDULE

MARK	W	V	CW	HW	FLOW RATE	FLUSH VOLUME	REMARKS
P-1	4"	2"	1 1/2"		-	1.28 GPF	WALL MOUNTED WATER CLOSET (ADA)
P-2	2"		3/4"	3/4"	0.5 GPM	-	WALL MOUNTED LAVATORY (SAD FOR MOUNTING HEIGHT)
P-4	2"	1 1/2"	3/4"	3/4"	2.5 GPM	-	FLOOR MOUNTED JANITOR SINK
P-6	2"	1 1/2"	3/4"	0"	0.14 GPM	-	HIGH LOW DRINKING FOUNTAIN WITH BOTTLE FILLER
RD					-	-	ROOF DRAIN SEE PLAN FOR PIPE SIZES
FD-1	3"	1 1/2"			-	-	FLOOR DRAIN WITH TRAP PRIMER
HB-1			3/4"		5.5 GPM	-	EXTERIOR HOSE BIBB

- CW FIXTURES AND VALVES SHALL BE AB1953 COMPLIANT.
- FOR FIXTURE LOCATION SAD

ELECTRIC WATER HEATER SCHEDULE

MARK	MANUF.	MODEL	TYPE	STORAGE CAPACITY	RECOVER Y @ 60F° RISE	ELECTRICAL			OPER. WEIGHT	LOCATION	REMARKS
EW H 1	A.O. SMITH	DEL 20	TANK	20 gal	20	208-1-60	1	3,000 W	240 lb	JANITORIAL	1-S

- REMARKS:
- PROVIDE FACTORY INSTALLED AUTOMATIC TEMPERATURE CONTROL WITH SAFETY CUTOFF TO PREVENT OVERHEATING.
  - PROVIDE WITH ST-12 EXPANSION TANK.
  - PROVIDE WITH HOLDRITE QUICK STAND #30-SWHP-WM WALL MOUNTED MANUFACTURER ENGINEERED EQUIPMENT PLATFORM ASSEMBLY.
  - PROVIDE WITH HOLDRITE QUICK STRAP #QS-U ASSEMBLY
  - PROVIDE WITH WATTS E-50 SEISMIC RESTRAINT T&B SYSTEM

PLUMBING LEGEND

SYMBOL	ABBREVIATION	DESCRIPTION
		EQUIPMENT TYPE
		EQUIPMENT NUMBER
		DETAIL / DRAWING NUMBER
		SHEET NUMBER
		FIXTURE TYPE/NUMBER
	SS	SANITARY WASTE BELOW GROUND
	V	VENT PIPE
	DCW	COLD WATER PIPE
	DHW	HOT WATER PIPE
	HWR	HOT WATER RETURN PIPE
	CD	CONDENSATE DRAIN
	G	NATURAL GAS PIPE
	RVD	RELIEF VALVE DISCHARGE
	RWL	RAIN WATER LEADER
	OD	OVERFLOW DRAIN PIPE
	GV	GATE VALVE
		GLOBE VALVE
	BV	BALL VALVE
	BVF	BUTTERFLY VALVE
	CV	CHECK VALVE
		BALANCING VALVE
		GAS COCK OR STOP
	PRV	PRESSURE REDUCING VALVE
	TV	TEMPERING VALVE
		STRAINER
		UNION
		PRESSURE GAUGE AND COCK
	P	PUMP
		THERMOMETER
	CO	CLEANOUT
	WCO	WALL CLEANOUT
	FCO	FLOOR CLEANOUT
	COTG	CLEANOUT TO GRADE
		PRESSURE GUAGE WELL ONLY (PETE'S PLUG)
	HB	HOSE BIBB
		PIPE UP
		PIPE DOWN
		BRANCH TOP CONNECTION
		BRANCH BOTTOM CONNECTION
		BRANCH SIDE CONNECTION
		CAP ON END OF PIPE
		CONCENTRIC REDUCER
		ECCENTRIC REDUCER
		VALVE IN RISER
		POINT OF CONNECTION
		POINT OF DEMOLITION
		CENTER LINE
	AFF	ABOVE FINISHED FLOOR
	AFG	ABOVE FINISHED GRADE
	AP	ACCESS PANEL
	BFF	BELOW FINISHED FLOOR
	CI	CAST IRON
	COTG	CLEANOUT TO GRADE
	DMV	DRAIN, WASTE, AND VENT
	DN	DOWN
	DW	DISHWASHER
	DWG	DRAWING
	(E)	EXISTING
	FCO	FLOOR CLEANOUT
	IE	INVERT ELEVATION
	IW	IN WALL
	MFR	MANUFACTURER
	(N)	NEW
	NIC	NOT IN CONTRACT
	NTS	NOT TO SCALE
	SA	SHOCK ABSORBER
	SAD	SEE ARCHITECTURAL DRAWINGS
	SCD	SEE CIVIL DRAWINGS
	SED	SEE ELECTRICAL DRAWINGS
	SMD	SEE MECHANICAL DRAWINGS
	SSD	SEE STRUCTURAL DRAWINGS
	TYP	TYPICAL
	UMC	UNIFORM MECHANICAL CODE
	UPC	UNIFORM PLUMBING CODE
	UNO	UNLESS NOTED OTHERWISE
	V	VENT
	VTR	VENT THROUGH ROOF
	WCO	WALL CLEANOUT
	WA	WATER HAMMER ARRESTOR

BLDG 'PLUMBING' SHEET LIST

P-M1.1	PLUMBING SCHEDULES & LEGENDS
P-M2.0	GAS SITE PLAN
P-M2.1	PLUMBING WASTE & VENT FLOOR PLAN
P-M2.2	PLUMBING WATER & GAS
P-M3.1	PLUMBING ROOF PLAN
P-M7.1	PLUMBING DETAILS
P-M7.2	PLUMBING DETAILS

QUATTROCCHI KWOK  
ARCHITECTS

Main Office:  
636 Fifth Street, Santa Rosa, CA 95404  
East Bay:  
55 Harrison Street, Suite 525,  
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SHEET TITLE

PLUMBING  
SCHEDULES &  
LEGENDS


SHEET NUMBER

P-M1.1



4/27/2021 11:53:16 AM C:\Users\robentDocuments\20053 Freedom HS Auxiliary Gym RVT18_rengland@costaengineers.com.rvt

1 UTILITIES SITE PLAN  
1" = 20'-0"

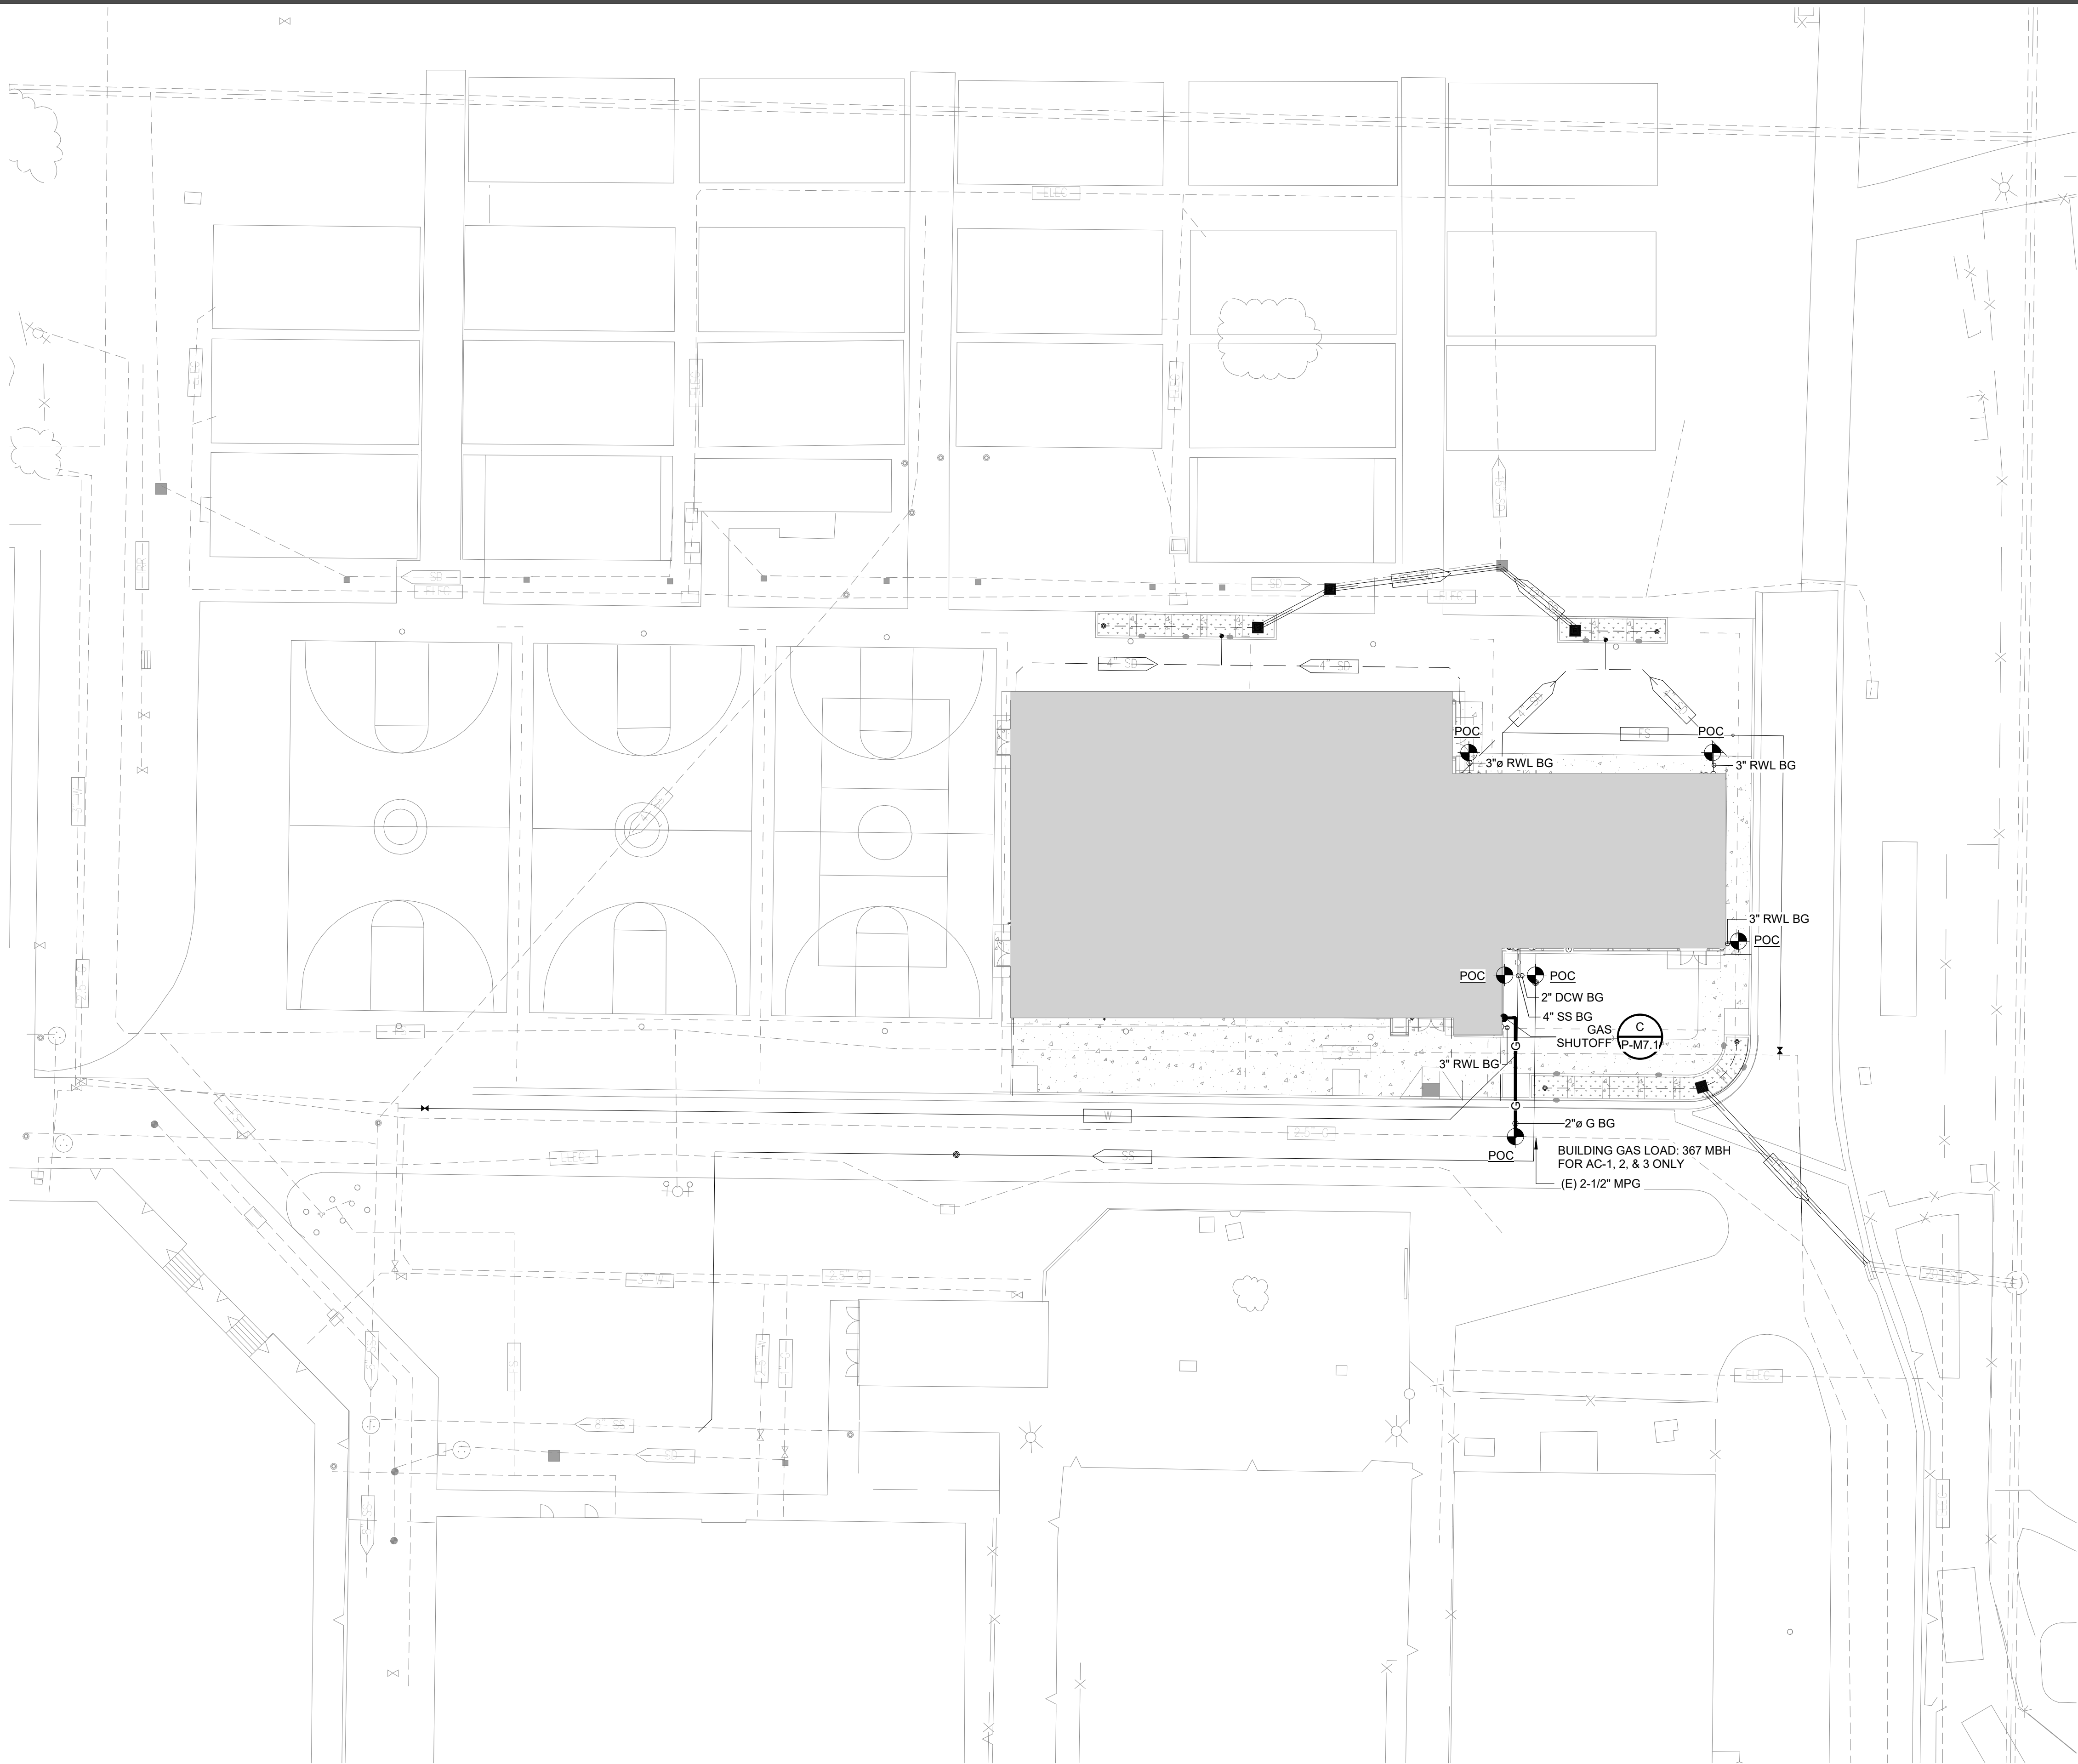

GENERAL NOTES



- A. FOR PLUMBING GENERAL NOTES, LEGENDS, AND SYMBOLS, REFER TO SHEET P-M1.1.
- B. PLUMBING CONTRACTOR SHALL BE RESPONSIBLE FOR COORDINATING THE PLUMBING WORK WITH OTHER TRADES. MAKE ANY OFFSETS AS REQUIRED TO AVOID CONFLICT WITH, LIGHT FIXTURES, SKYLIGHTS, HVAC ETC.
- C. CONTRACTOR SHALL COORDINATE ALL SHUT OFF VALVE LOCATIONS. SEE ARCHITECTURAL CEILING PLANS AND WALL PLANS.
- D. WHERE BRACING DETAILS ARE NOT SHOWN ON THE DRAWING OR IN THE GUIDELINES, THE FIELD INSTALLATION SHALL BE SUBJECT TO THE APPROVAL OF THE ARCHITECT, MECHANICAL ENGINEER AND FIELD INSPECTOR OF THE GOVERNING AUTHORITY.
- E. REFER TO ARCHITECTURAL GRAPHICS DRAWINGS FOR SIGNAGE NOT SHOW.
- F. SEE ARCHITECTURAL DRAWINGS FOR EXACT LOCATION OF PLUMBING FIXTURES.
- G. PROVIDE WALL CLEANOUTS FOR SINKS AND URINALS AS REQUIRED.
- H. FOR ACCESSIBLE WATER CLOSETS, LOCATE VALVE HANDLE ON THE ACCESSIBLE SIDE PER ACCESSIBLE REQUIREMENTS.
- J. ALL UNDERGROUND AND BELOW SLAB PIPING SHALL BE INSTALLED NO LESS THAN MINIMUM BURY PER CODE. ALL PIPING THROUGH SLAB, BURIED OR UNDERNEATH FOUNDATION SSD

WALL LEGENDS

NOTES:  
S.S.D. FOR WOOD FRAMING SIZES FOR ALL BEARING WALLS. ALL OTHER WALLS ARE 2X6 WOOD STUDS U.O.N.

WOOD FRAMING - NON RATED

KEYPLAN

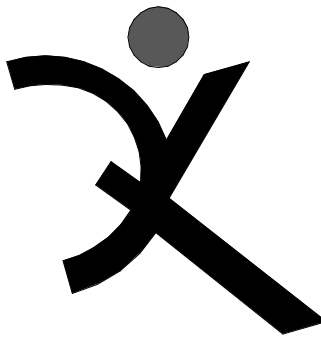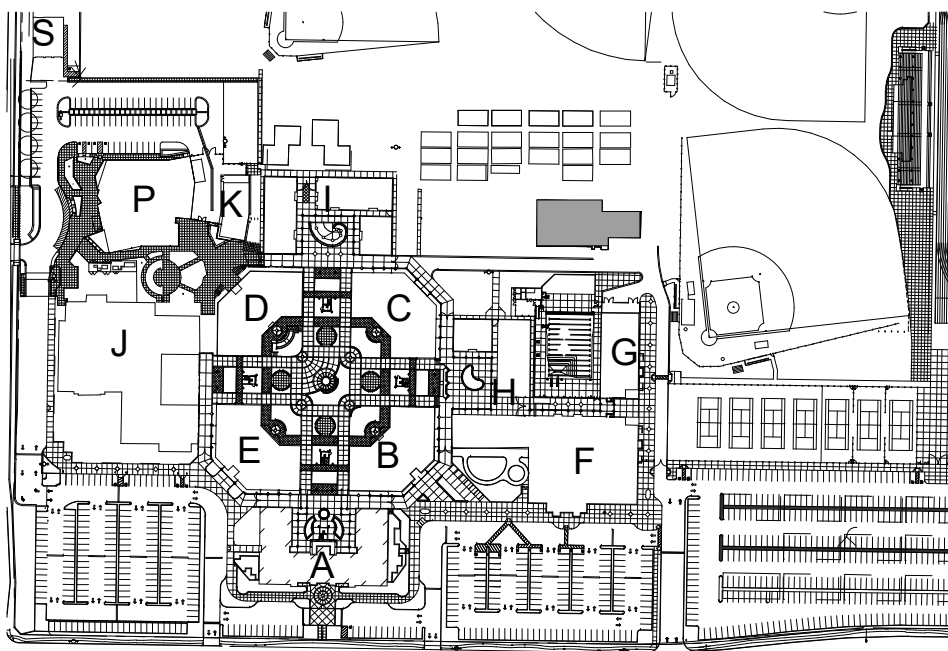

QUATTROCCHI KWOK  
ARCHITECTS  
Main Office:  
636 Fifth Street, Santa Rosa, CA 95404  
East Bay:  
55 Harrison Street, Suite 525,  
Oakland, CA 94607  
(707) 576-0829

SIGNED: OCTOBER 30, 2020



COSTA ENGINEERS INC.

3274 Villa Lane Suite, CA 94608 ph: 707-252-9177 fax: 707-252-9473



FREEDOM  
HIGH SCHOOL

NEW AUXILIARY  
GYMNASIUM

1050 NEROLY RD,  
OAKLEY, CA 94561

LIBERTY UNION  
HIGH SCHOOL  
DISTRICT

DSA APP NO. 01-119278

ARCH PROJECT NO: 1869.00

DRAWN BY: MQ

DRAWING SCALE: 1" = 20'-0"

PTN: 61721-78 FILE NO: 7-H4

BID DOCUMENT

APRIL 27, 2021

SHEET TITLE


GAS SITE  
PLAN

SHEET NUMBER

P-M2.0



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**1** **AUXILIARY GYM - PLUMBING WASTE & VENT FLOOR PLAN**  
1/8" = 1'-0"
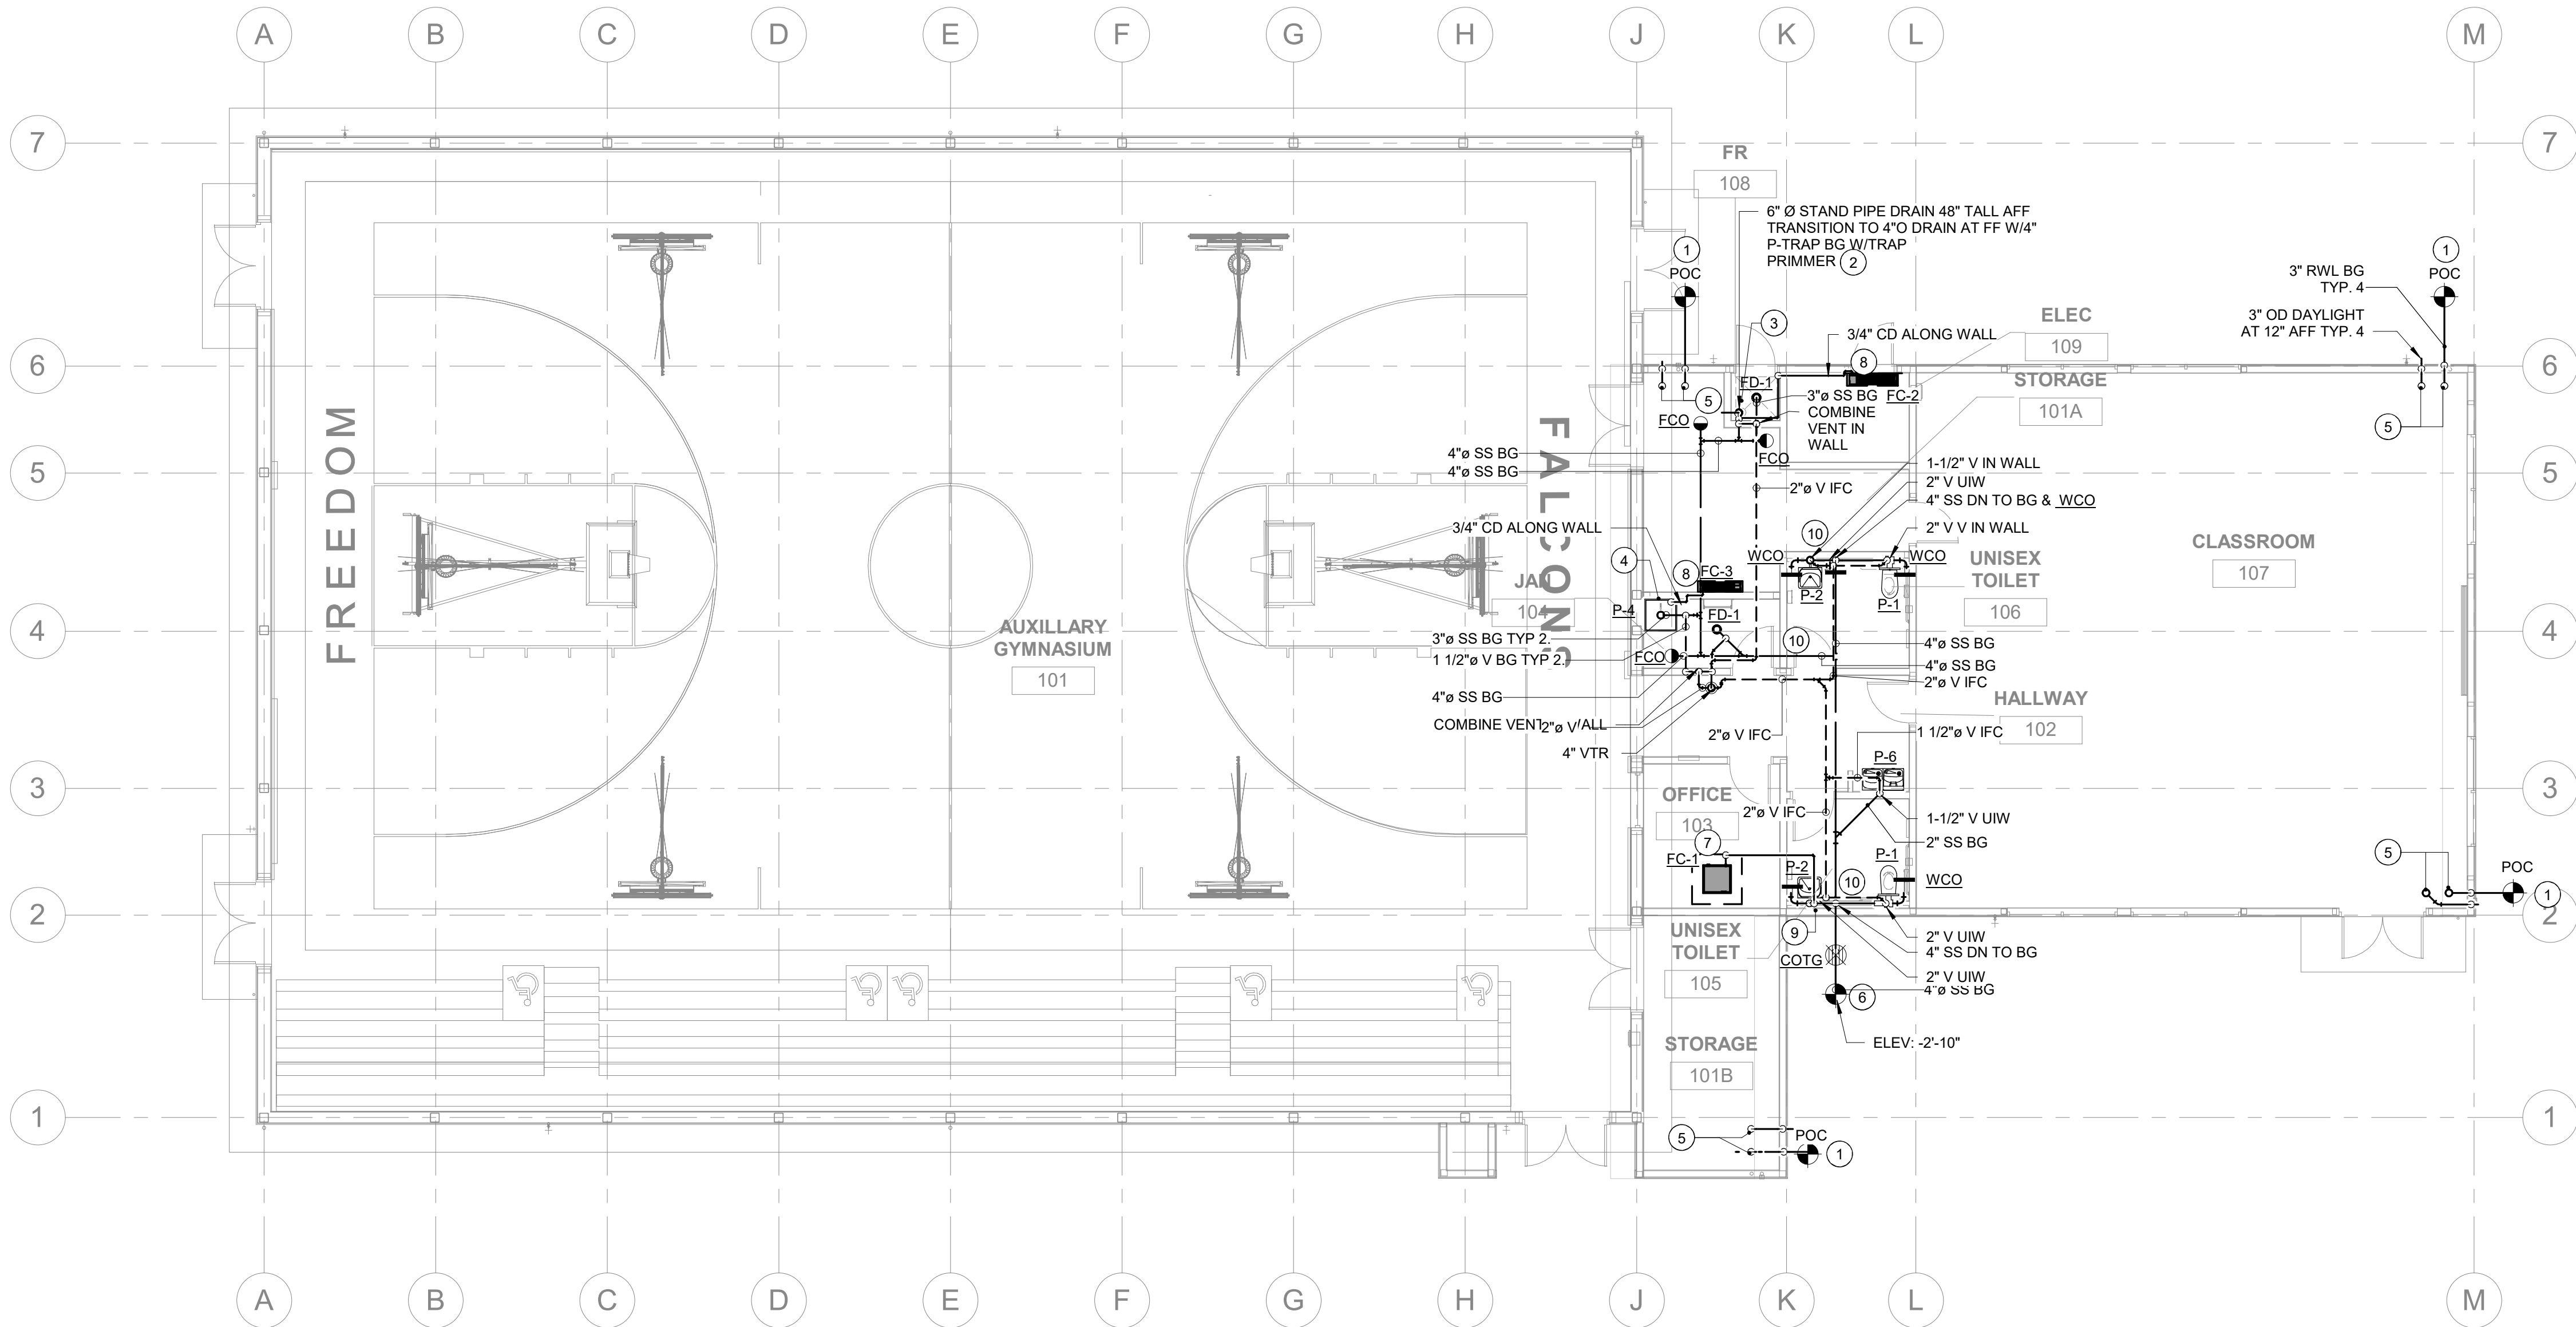
## GENERAL NOTES

- FOR PLUMBING GENERAL NOTES, LEGENDS, AND SYMBOLS, REFER TO SHEET P-M1.1.
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## SHEET NOTES



- POC RAIN WATER LEADER (RWL) TO POC 5'-0" OUTSIDE OF BUILDING. REFER TO SITE CIVIL DRAWINGS FOR CONTINUATION.
- FIRE STAND DRAIN SEE DETAIL. **(K P-M7.1)**
- 3/4" CD DIW TO FIRE STAND DRAIN
- 3/4" CD DIW TO JANITORIAL SINK
- 3" RWL & 3" OD UP THRU ROOF TO ROOF DRAIN
- 4" SANITARY SEWER (SS) TO POC AT 5'-0" OUTSIDE OF BUILDING WITH COTG. REFER TO SITE CIVIL DRAWINGS FOR CONTINUATION.
- CEILING CASSETTE CONDENSATE CONNECTION PER DETAIL. **(E P-M7.1)**
- WALL MOUNTED FAN COIL CONDENSATE.. SIMILAR CONNECTION PER DETAIL. **(D P-M7.1)** PIPE ALONG WALL AND THRU WALL.
- 3/4" CD DIW TO SINK TAIL PIECE PER DETAIL. **(B P-M7.2)**
- PIPE THRU FOOTING

## WALL LEGENDS

NOTES:  
S.S.D. FOR WOOD FRAMING SIZES FOR ALL BEARING WALLS. ALL OTHER WALLS ARE 2X6 WOOD STUDS U.O.N.

WOOD FRAMING - NON RATED

## KEYPLAN

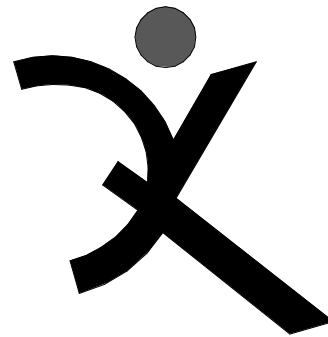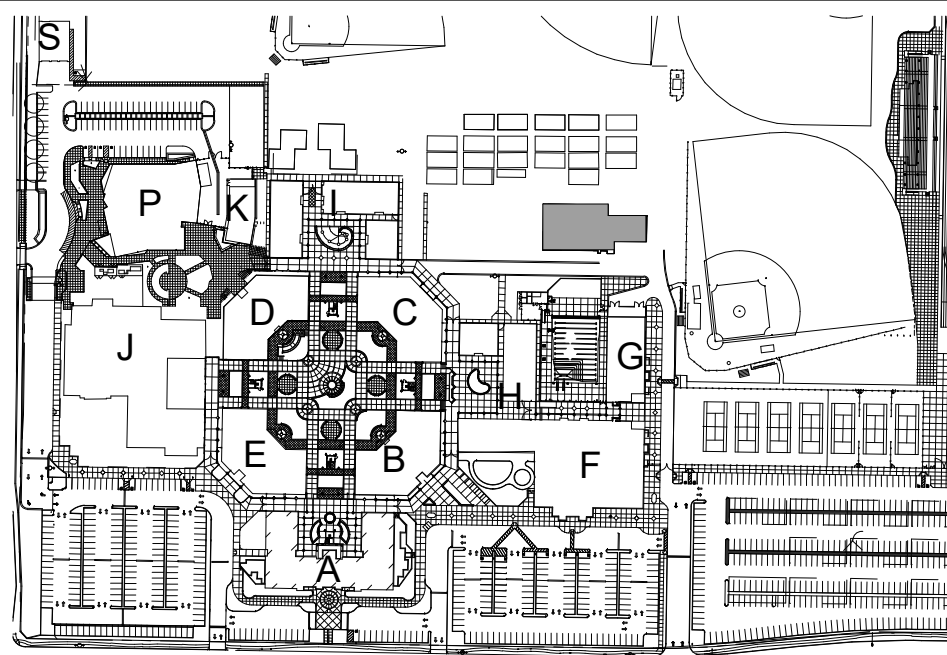

**QUATTROCCHI KWOK  
ARCHITECTS**  
Main Office:  
636 Fifth Street, Santa Rosa, CA 95404  
East Bay:  
55 Harrison Street, Suite 525,  
Oakland, CA 94607  
(707) 576-0829

SIGNED: OCTOBER 30, 2020



**COSTA ENGINEERS INC.**

3274 Villa Lane Suite, CA 94618 ph: 707-252-9177 fax: 707-252-0473



**FREEDOM  
HIGH SCHOOL**

**NEW AUXILIARY  
GYMNASIUM**

1050 NEROLY RD,  
OAKLEY, CA 94561

**LIBERTY UNION  
HIGH SCHOOL  
DISTRICT**

DSA APP NO. 01-119278

ARCH PROJECT NO: 1869.00

DRAWN BY: LM/MQ

DRAWING SCALE: 1/8" = 1'-0"

PTN: 61721-78 FILE NO: 7-H4

BID DOCUMENT

APRIL 27, 2021

SHEET TITLE


**PLUMBING  
WASTE &  
VENT FLOOR  
PLAN**

SHEET NUMBER

**P-M2.1**



4/27/2021 11:53:21 AM C:\Users\robent\Documents\20053 Freedom HS Auxiliary Gym RVT18_rengland@costaengineers.com.rvt

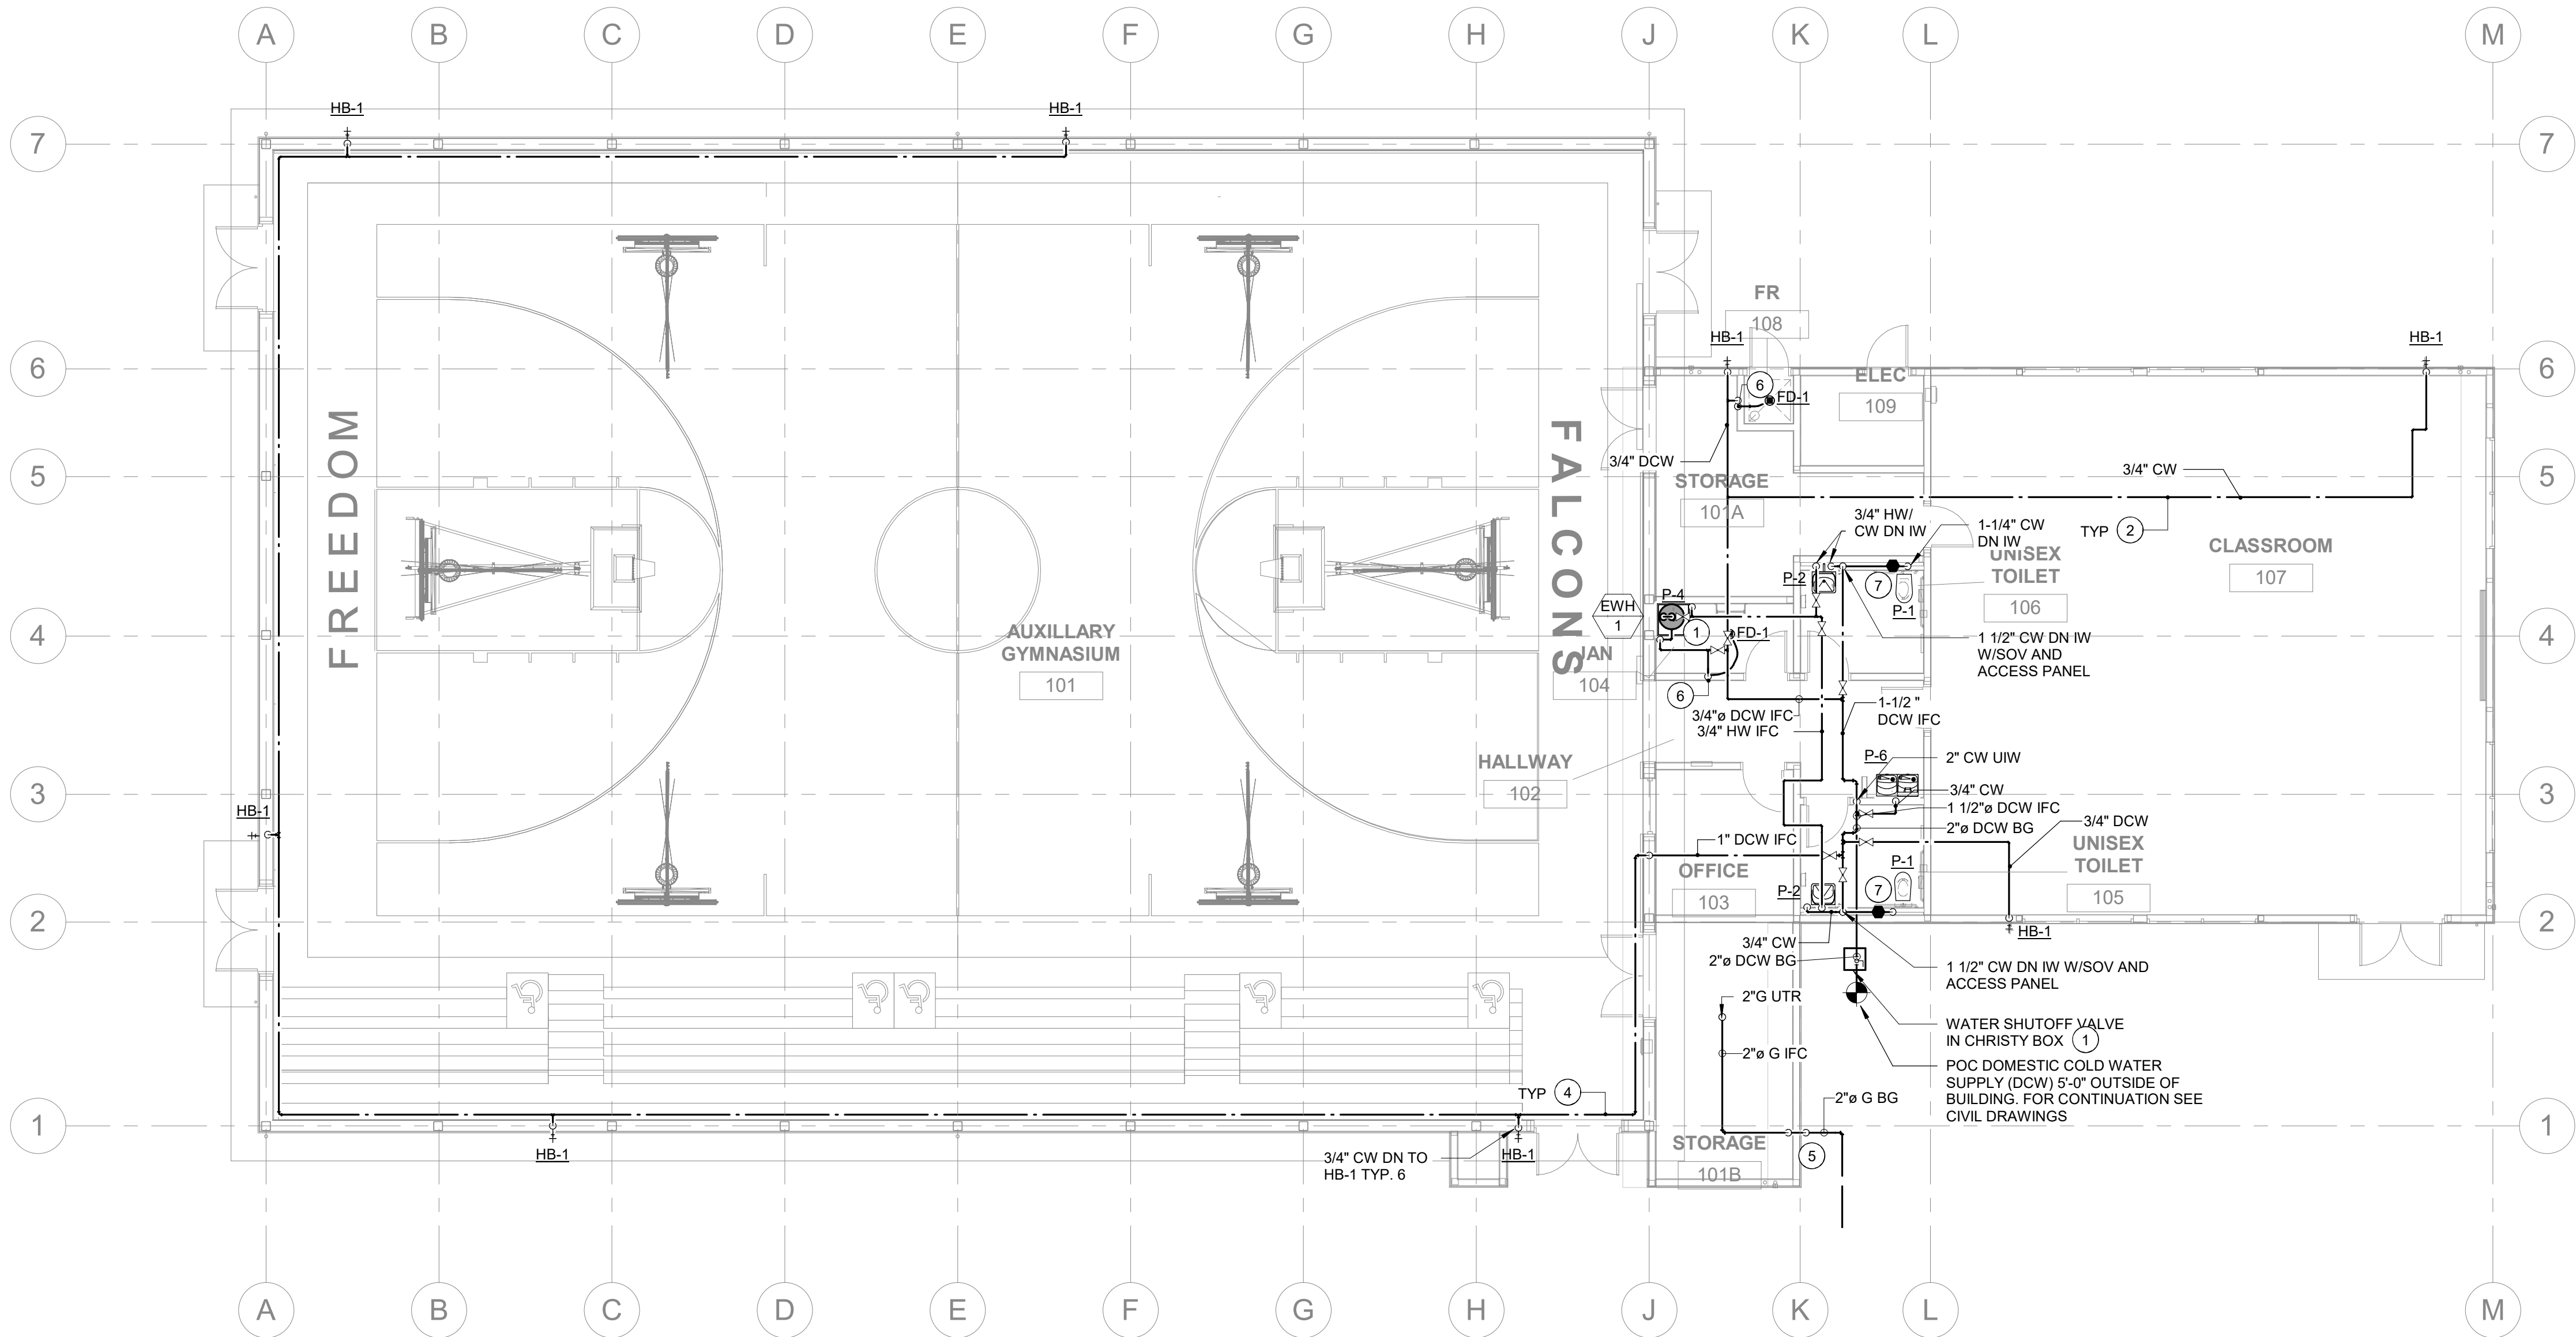

**1** **AUXILIARY GYM - PLUMBING WATER & GAS FLOOR PLAN**  
1/8" = 1'-0"

## GENERAL NOTES

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## SHEET NOTES



- WATER ENTRANCE VALVE IN CHRISTY BOX PER DETAIL **G** **P-M7.1**
- PIPE HANGER PER DETAIL **G** **P-M7.2**
- 20 GALLONS ELECTRIC WATER HEATER MOUNTED IN PRE-FABRICATED PLATFORM PER DETAIL **A** **P-M7.1**
- COLD WATER PIPE. HIGH AT GYM ALONG THE WALL. SEE DETAIL **F** **P-M7.2**
- GAS REGULATOR IN ENCLOSURE . SEE DETAIL **C** **P-M7.1**
- 1/2" CW DN IN WALL TO TRAP PRIMER WITH ACCESS PANEL. 1/2" FLEX COPPER TO P-TRAP.
- 1/2" CW DN IN WALL TO WATER HAMMER ARRESTOR WITH ACCESS PANEL.

## WALL LEGENDS

NOTES:  
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WOOD FRAMING - NON RATED

## KEYPLAN

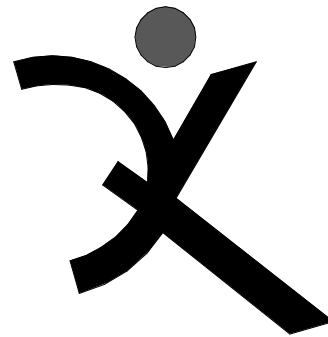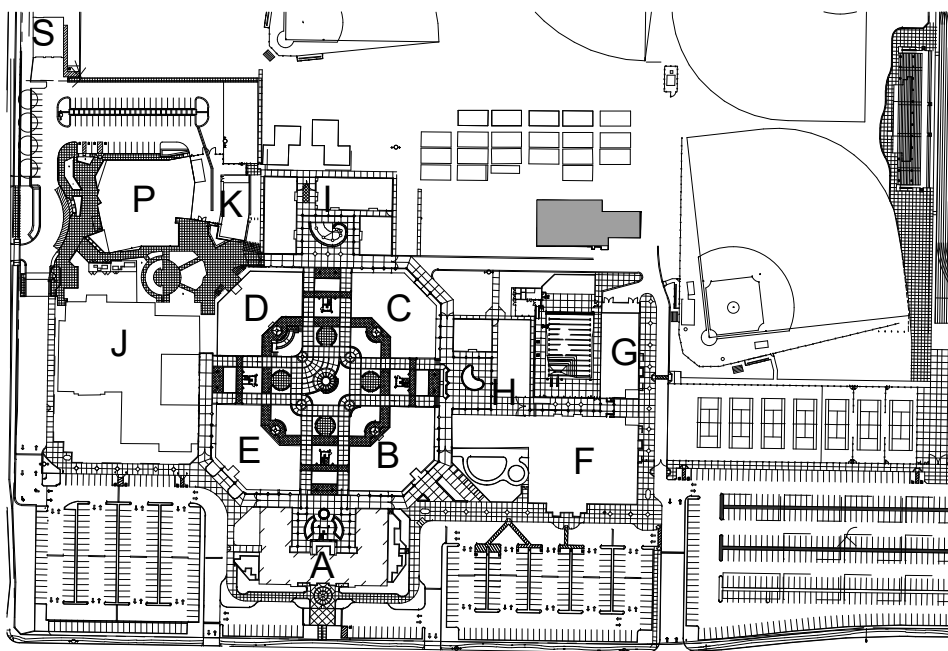

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**LIBERTY UNION  
HIGH SCHOOL  
DISTRICT**

DSA APP NO. 01-119278

ARCH PROJECT NO: 1869.00

DRAWN BY: LM/MQ

DRAWING SCALE: 1/8" = 1'-0"

PTN: 61721-78 FILE NO: 7-H4

BID DOCUMENT

APRIL 27, 2021

SHEET TITLE


**PLUMBING  
WATER & GAS**

SHEET NUMBER


**P-M2.2**



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**1** **AUXILIARY GYM - PLUMBING ROOF PLAN**  
1/8" = 1'-0"

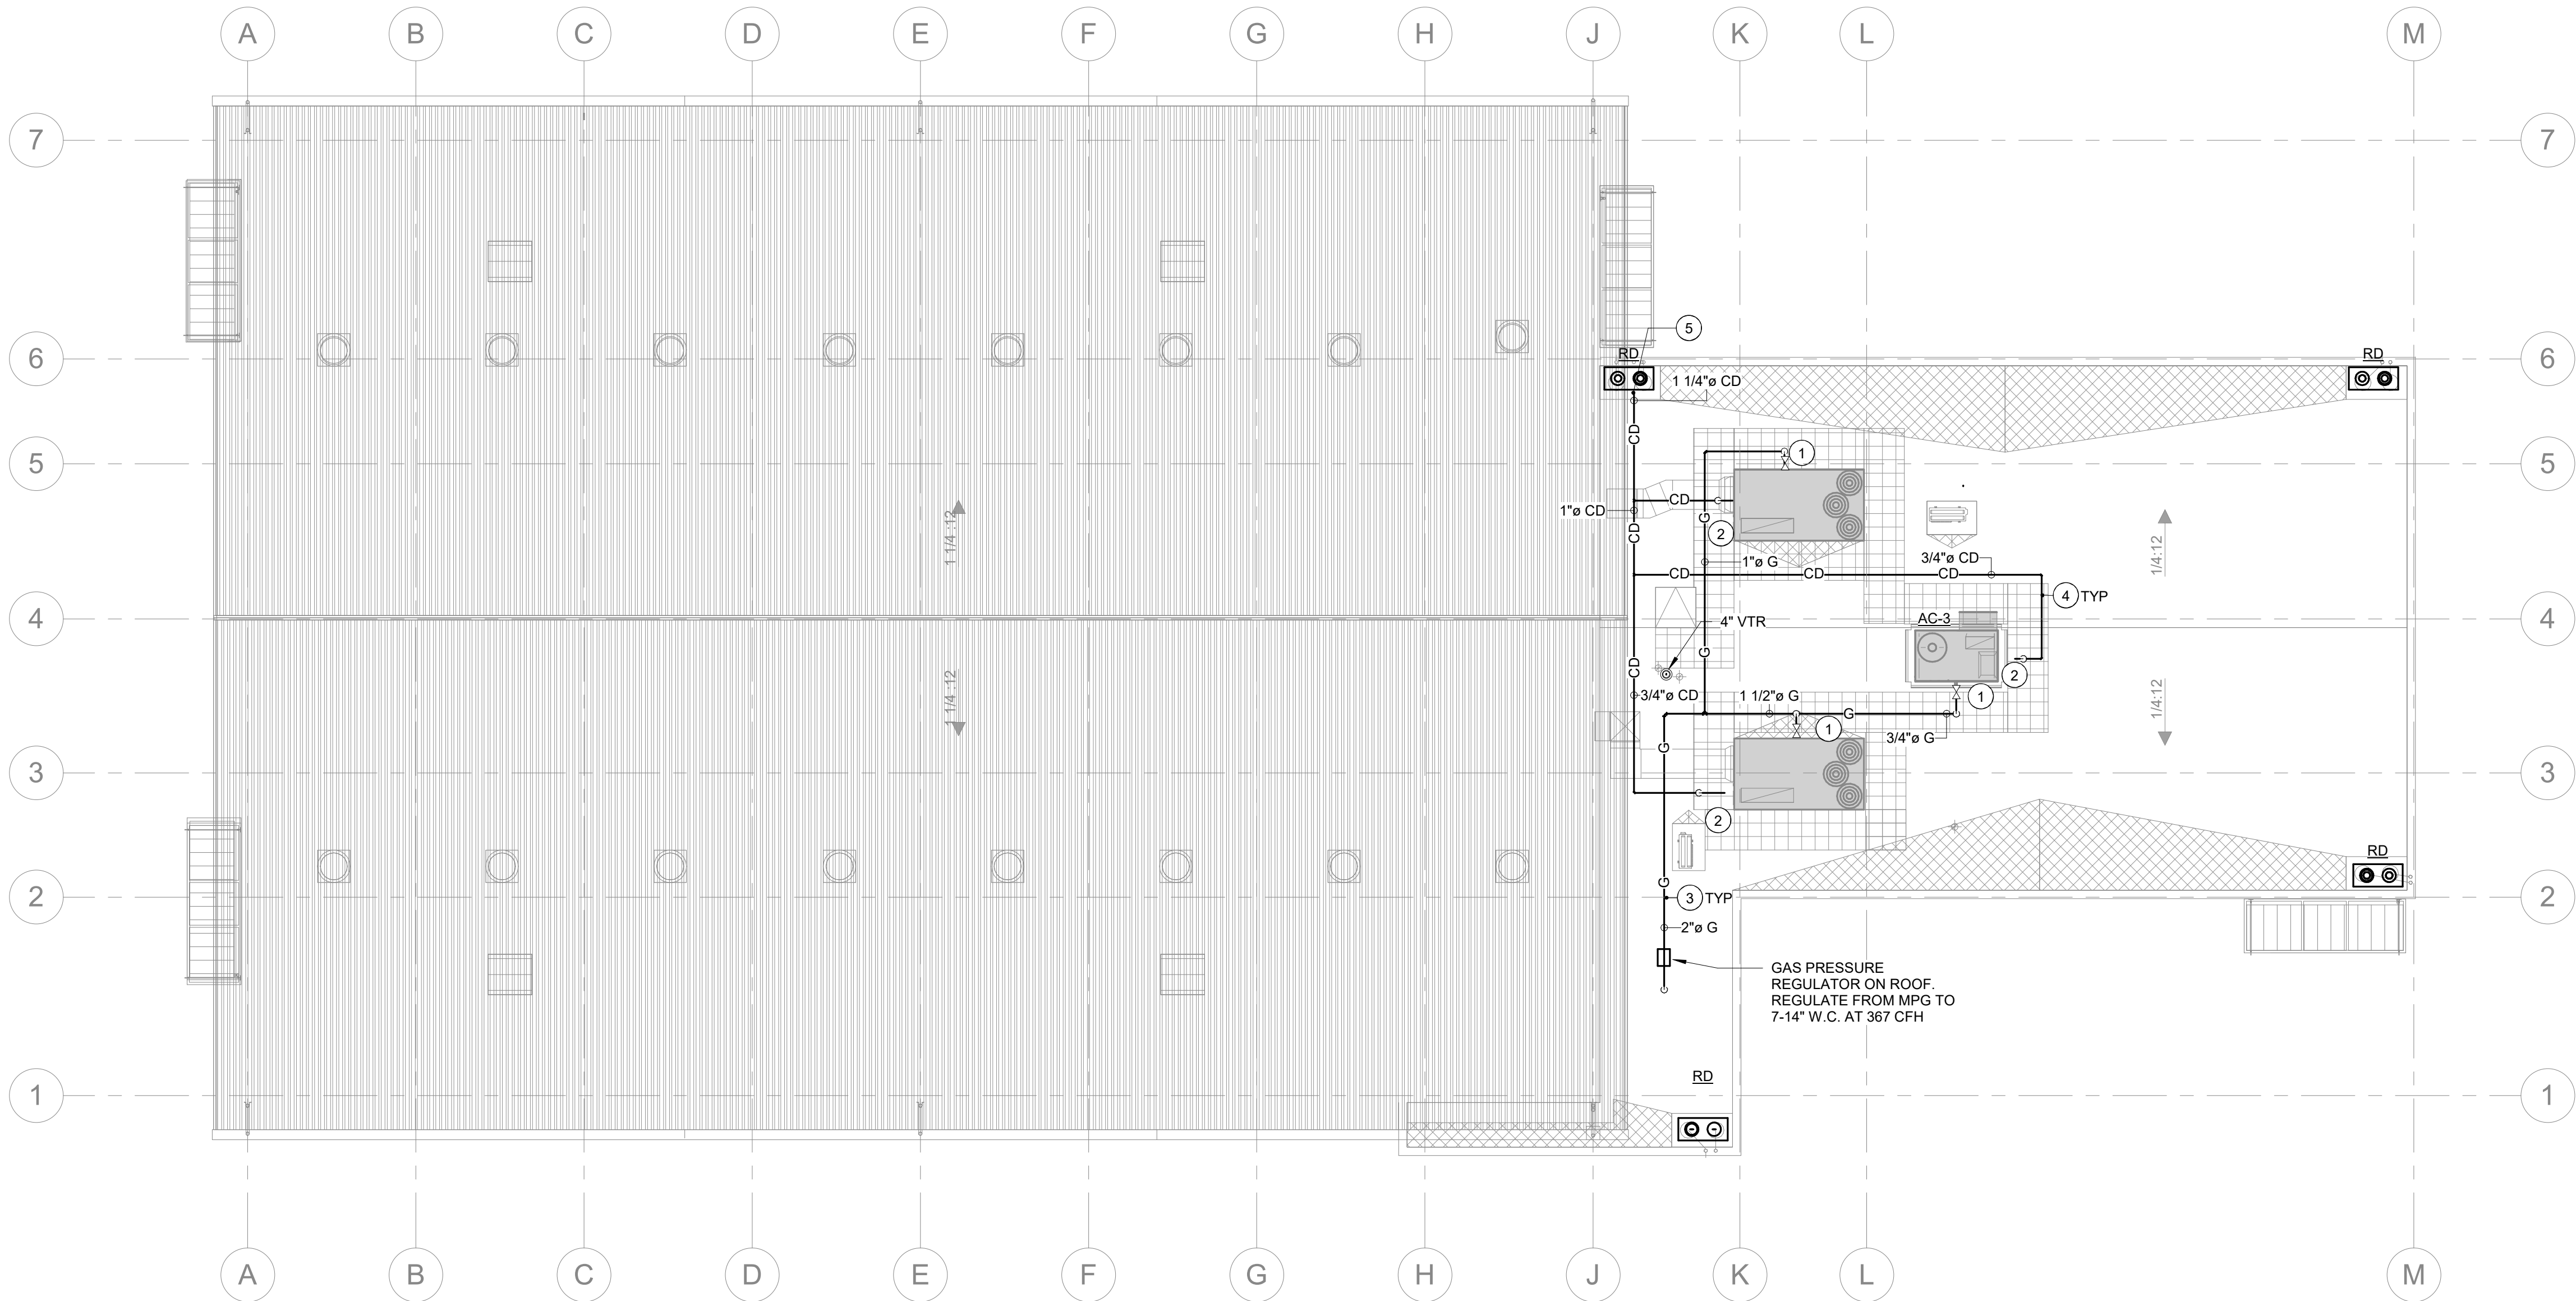

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## SHEET NOTES


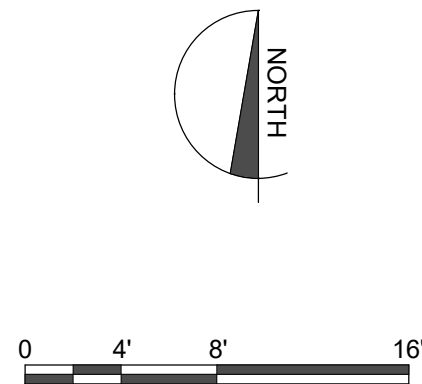
- GAS CONNECTION TO AC UNIT PER DETAIL **B** (P-M7.1)
- CONDENSATE CONNECTION FROM AC UNIT PER DETAIL **D** (P-M7.1)
- GAS PIPE ON ROOF PER DETAIL **H** (P-M7.1)
- CONDENSATE PIPE ON ROOF PER DETAIL **J** (P-M7.1)
- CONDENSATE PIPE TO ROOF DRAIN PER DETAIL **F** (P-M7.1)

## WALL LEGENDS

NOTES:  
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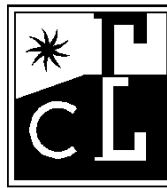
WOOD FRAMING - NON RATED

## KEYPLAN

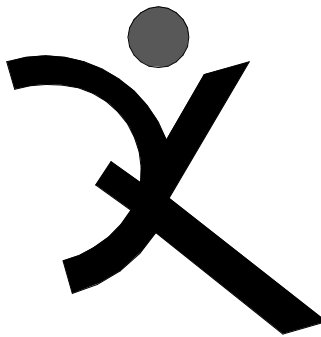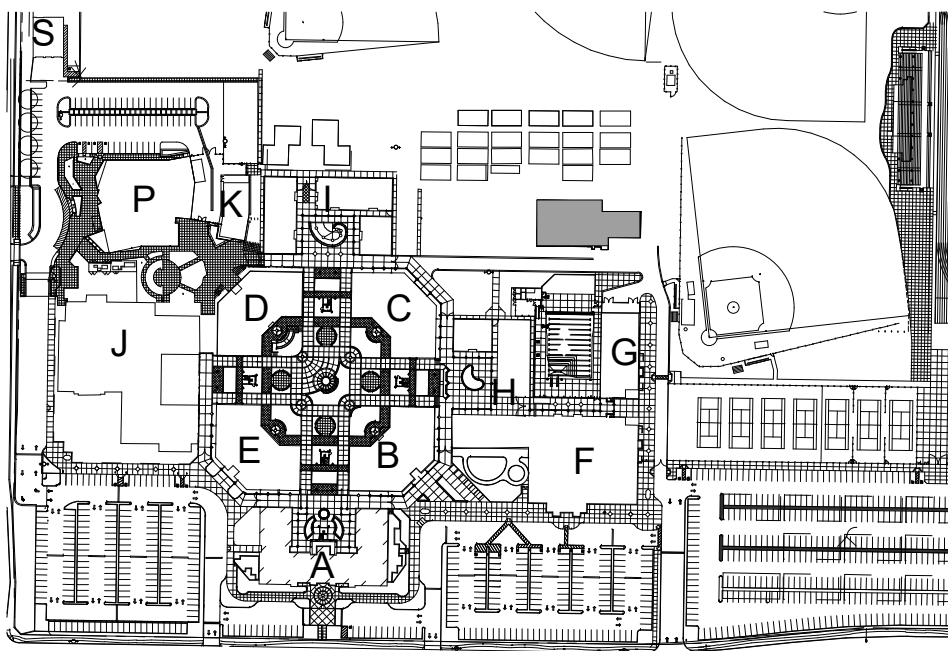

**QUATTROCCHI KWOK  
ARCHITECTS**  
Main Office:  
636 Fifth Street, Santa Rosa, CA 95404  
East Bay:  
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Oakland, CA 94607  
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SIGNED: OCTOBER 30, 2020



**COSTA ENGINEERS INC.**



**FREEDOM  
HIGH SCHOOL**

**NEW AUXILIARY  
GYMNASIUM**

1050 NEROLY RD,  
OAKLEY, CA 94561

**LIBERTY UNION  
HIGH SCHOOL  
DISTRICT**

DSA APP NO. 01-119278

ARCH PROJECT NO: 1869.00

DRAWN BY: MQ/LM

DRAWING SCALE: 1/8" = 1'-0"

PTN: 61721-78 FILE NO: 7-H4

**BID DOCUMENT**

**APRIL 27, 2021**


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**PLUMBING  
ROOF PLAN**


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**P-M3.1**






**A EWH MOUNTING DETAIL & PIPING DIAGRAM**  
SCALE: NONE

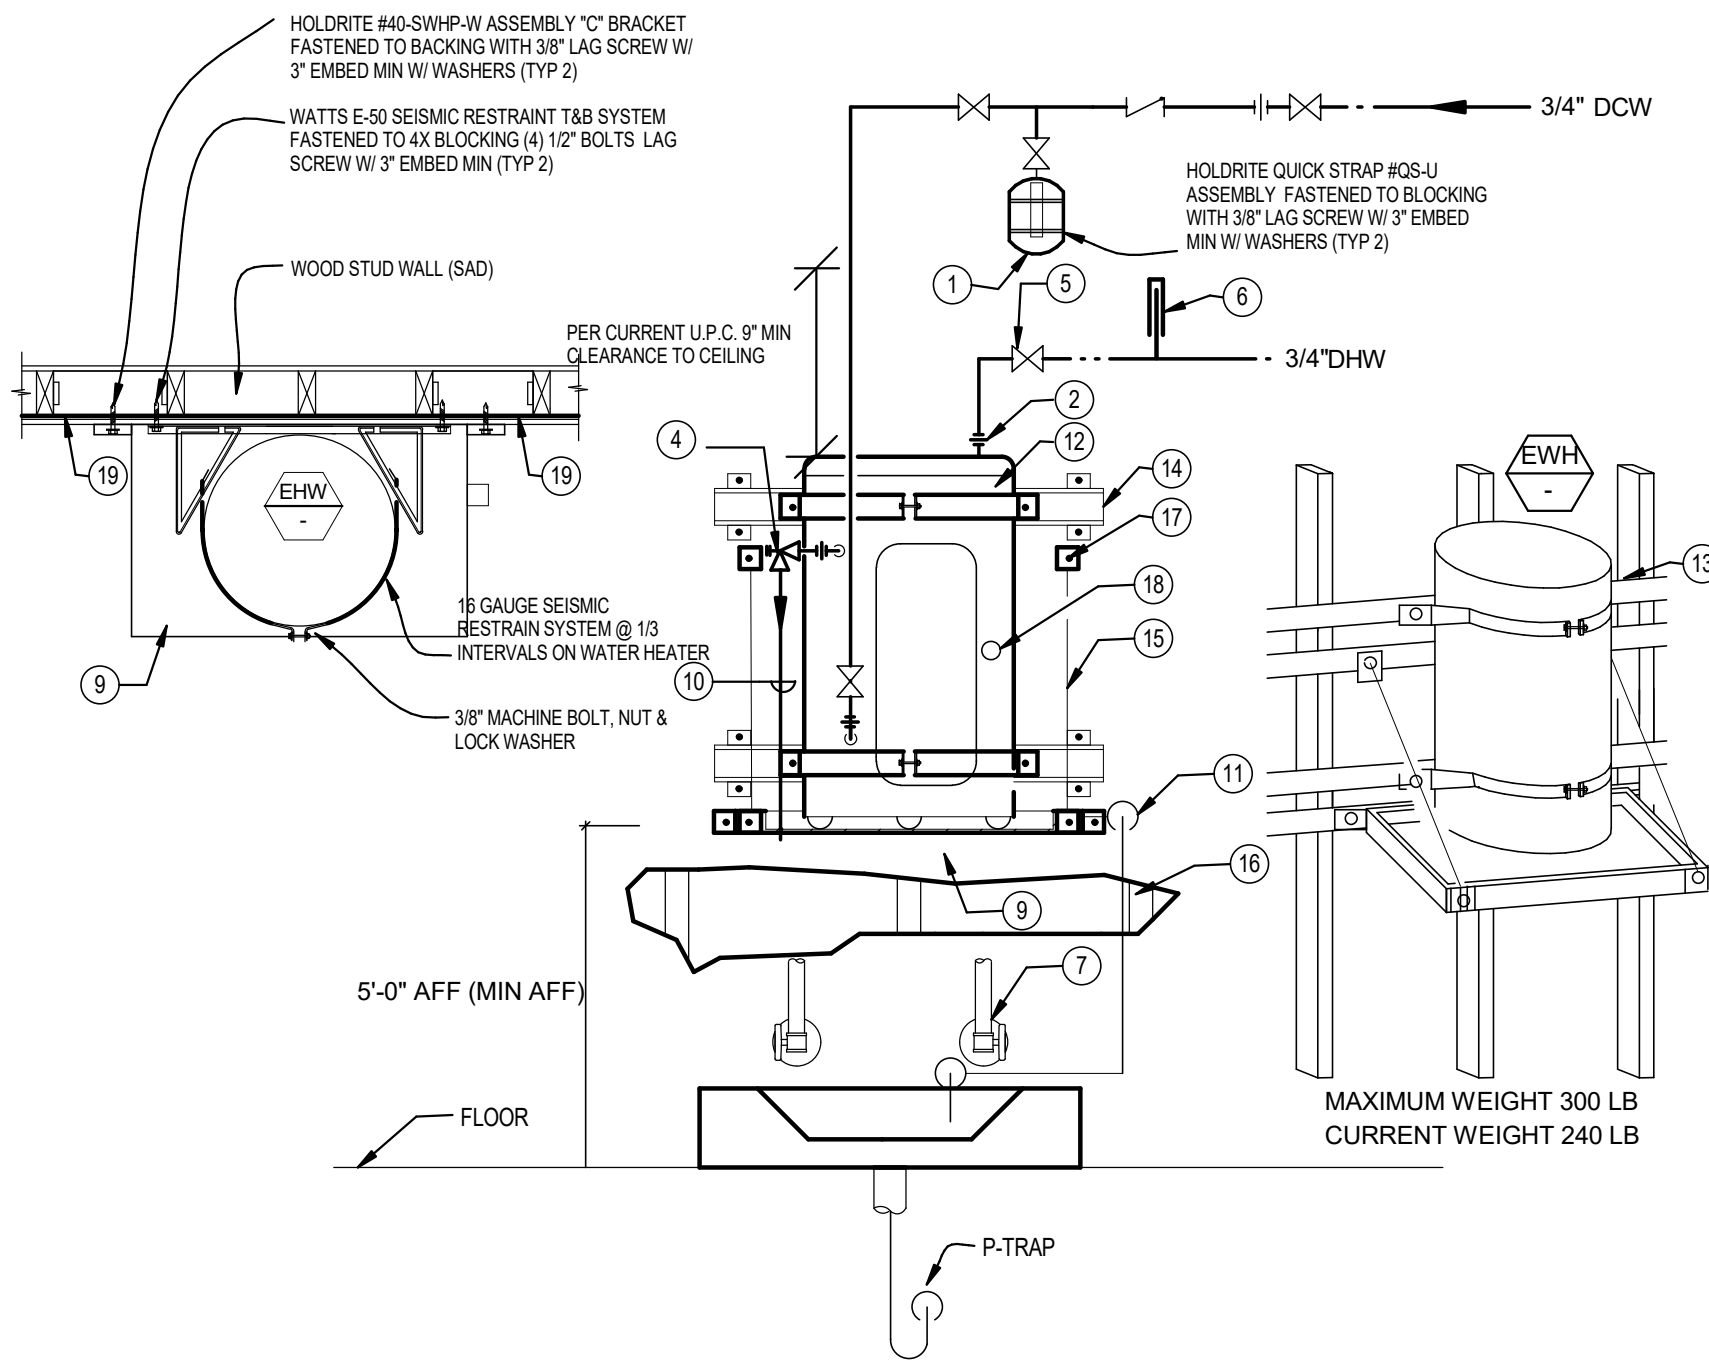


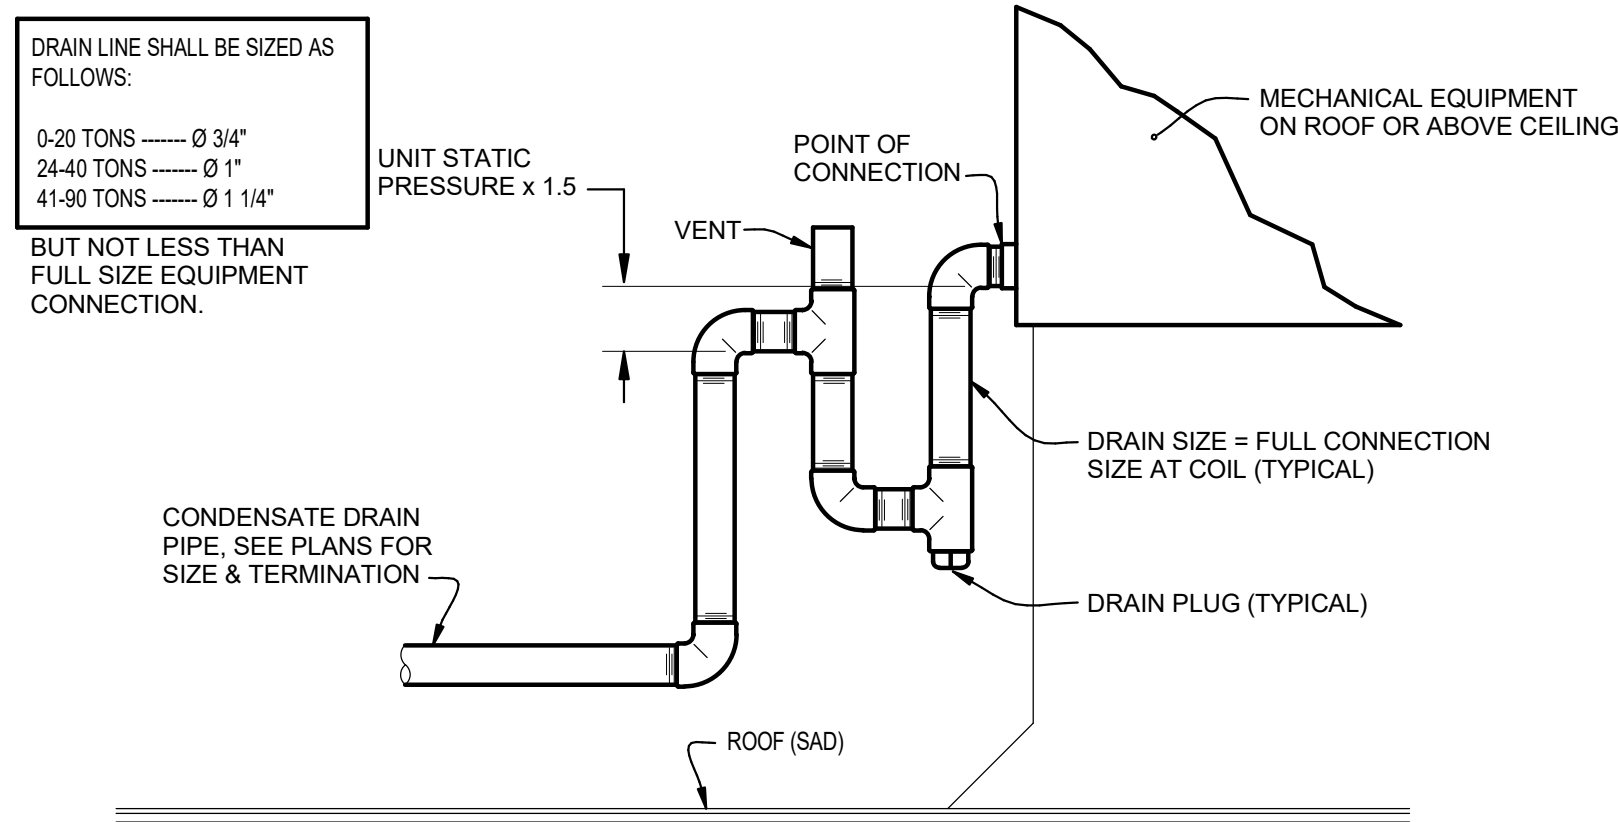**D TYPICAL CONDENSATE DRAIN DETAIL**  
SCALE: NONE


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|----------------------------------------------------------------------------------------------------------------------------------------------------------------------------------------------------------------------------------------------------------------------------------------------------------------------------------------------------------------------------------------------------------------------------------------------------------------------------------------------------------------------------------------------------------------------------------------------------------------------------------------|---------------------------------------------------------------------------------------------------------------------------------------------------------------------------------------------------------------------------------------------------------------------------------------------------------------------------------------------------------------------------------------------------------------------------------------------------------------------------------------------------------------------------------------------------------------------------------------------------------------------------------------------------------------------------------------------------------------------------------------------------------------------------------------------------------------------------------------------------------------------------------------|
| <ol style="list-style-type: none"><li>1 AMTROL ST-12 EXPANSION TANK</li><li>2 DIELECTRIC UNION (TYPICAL)</li><li>3 UNION (TYP.)</li><li>4 PRESSURE TEMPERATURE RELIEF VALVE</li><li>5 GATE VALVE (TYPICAL)</li><li>6 THERMOMETER (TYP)</li><li>7 3/4\"DCW/DHW WATER SUPPLY THRU WALL TO JANITORIAL SINK</li><li>8 NOT USED</li><li>9 HOLDRITE QUICK STAND #30-SWHP-WM WALL MOUNTED EQUIPMENT PLATFORM ASSEMBLY, MANUFACTURER ENGINEERED TO SUPPORT UP TO 20 US GALLONS OR EQUIPMENT UP TO 300 POUNDS TOTAL WEIGHT</li><li>10 FULL SIZE T &amp; PRV DRAIN CONT. DN TO DRAIN INDIRECTLY INTO PAN WATER HEATER SUPPORT ASSEMBLY</li></ol> | <ol style="list-style-type: none"><li>11 3/4\" CD DRAIN FROM DRAIN PAN, TO DRAIN INDIRECTLY INTO SERVICE SINK MIN. 1\" AIR GAP.</li><li>12 STORAGE-TYPE, ELECTRIC WATER HEATER, DISTANCE FROM WALL TO WATER HEATER PER CURRENT U.P.C. 9\" MIN CLEARANCE TO CEILING (MAX. 375 LBS)</li><li>13 (2) 1/4\" LAG SCREWS WITH 3\" EMBED AT EA. AT 4X BLOCKING</li><li>14 WATTS E-50 SEISMIC RESTRAINT T&amp;B SYSTEM FASTENED TO BACKING PLATE WITH (4) 1/2\" BOLTS (TYP 2)</li><li>15 THREADED ROD (2); LOW CARBON STEEL, ZINC PLATED, 3/8\" X29-3/4\" LONG BY MANUFACTURER.</li><li>16 WOOD STUD BEHIND GYP-BD WALL @16\" O.C (TYP)</li><li>17 HOLDRITE ASSEMBLY '45 DEGREE' BRACKET FASTENED TO BACKING WITH 3/8\" LAG SCREW WITH 3\" EMBED MIN W/ WASHERS (TYP 2)</li><li>18 ELECTRICAL CONNECTION</li><li>19 4x BLOCKING (AS REQUIRED) WITH A34 EACH END, EACH SIDE (TYPICAL)</li></ol> |
|----------------------------------------------------------------------------------------------------------------------------------------------------------------------------------------------------------------------------------------------------------------------------------------------------------------------------------------------------------------------------------------------------------------------------------------------------------------------------------------------------------------------------------------------------------------------------------------------------------------------------------------|---------------------------------------------------------------------------------------------------------------------------------------------------------------------------------------------------------------------------------------------------------------------------------------------------------------------------------------------------------------------------------------------------------------------------------------------------------------------------------------------------------------------------------------------------------------------------------------------------------------------------------------------------------------------------------------------------------------------------------------------------------------------------------------------------------------------------------------------------------------------------------------|

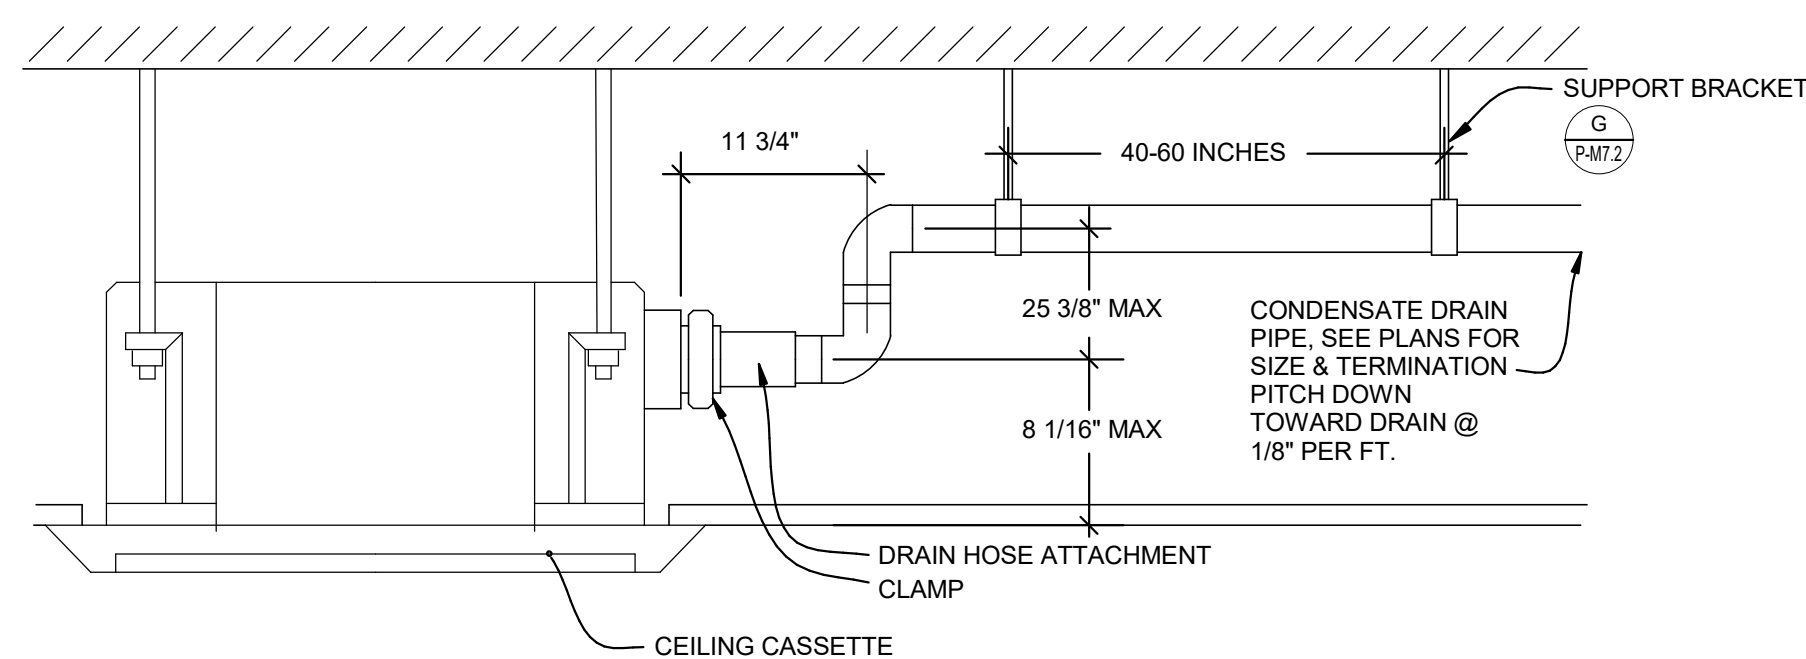


**E TYPICAL CONDENSATE DRAIN FOR CEILING CASSETTE**  
SCALE: NONE

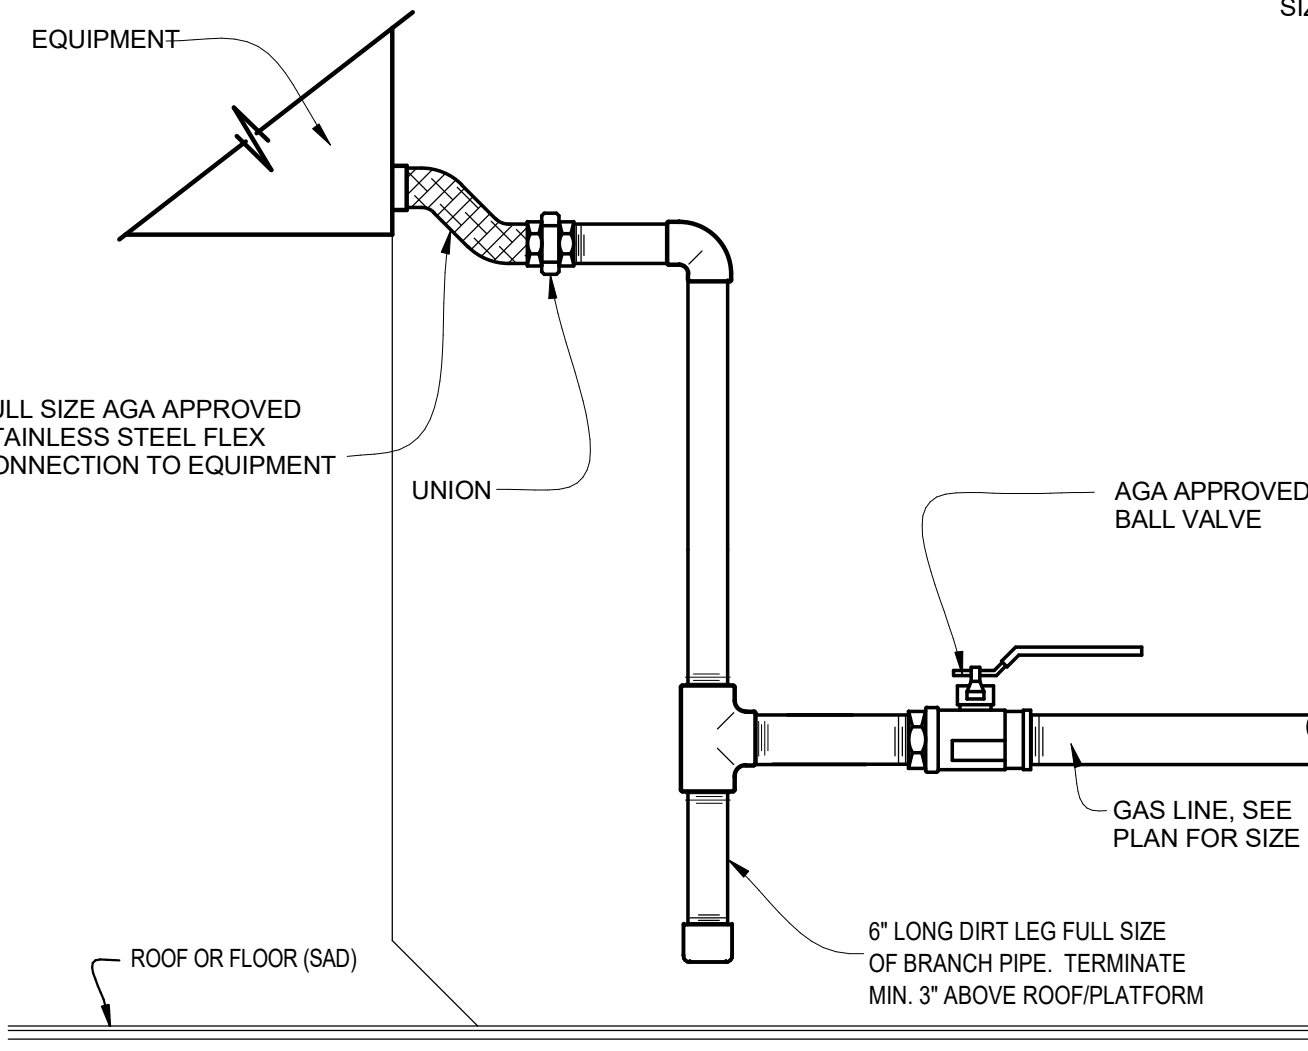


**B GAS CONNECTION DETAIL**  
SCALE: NONE

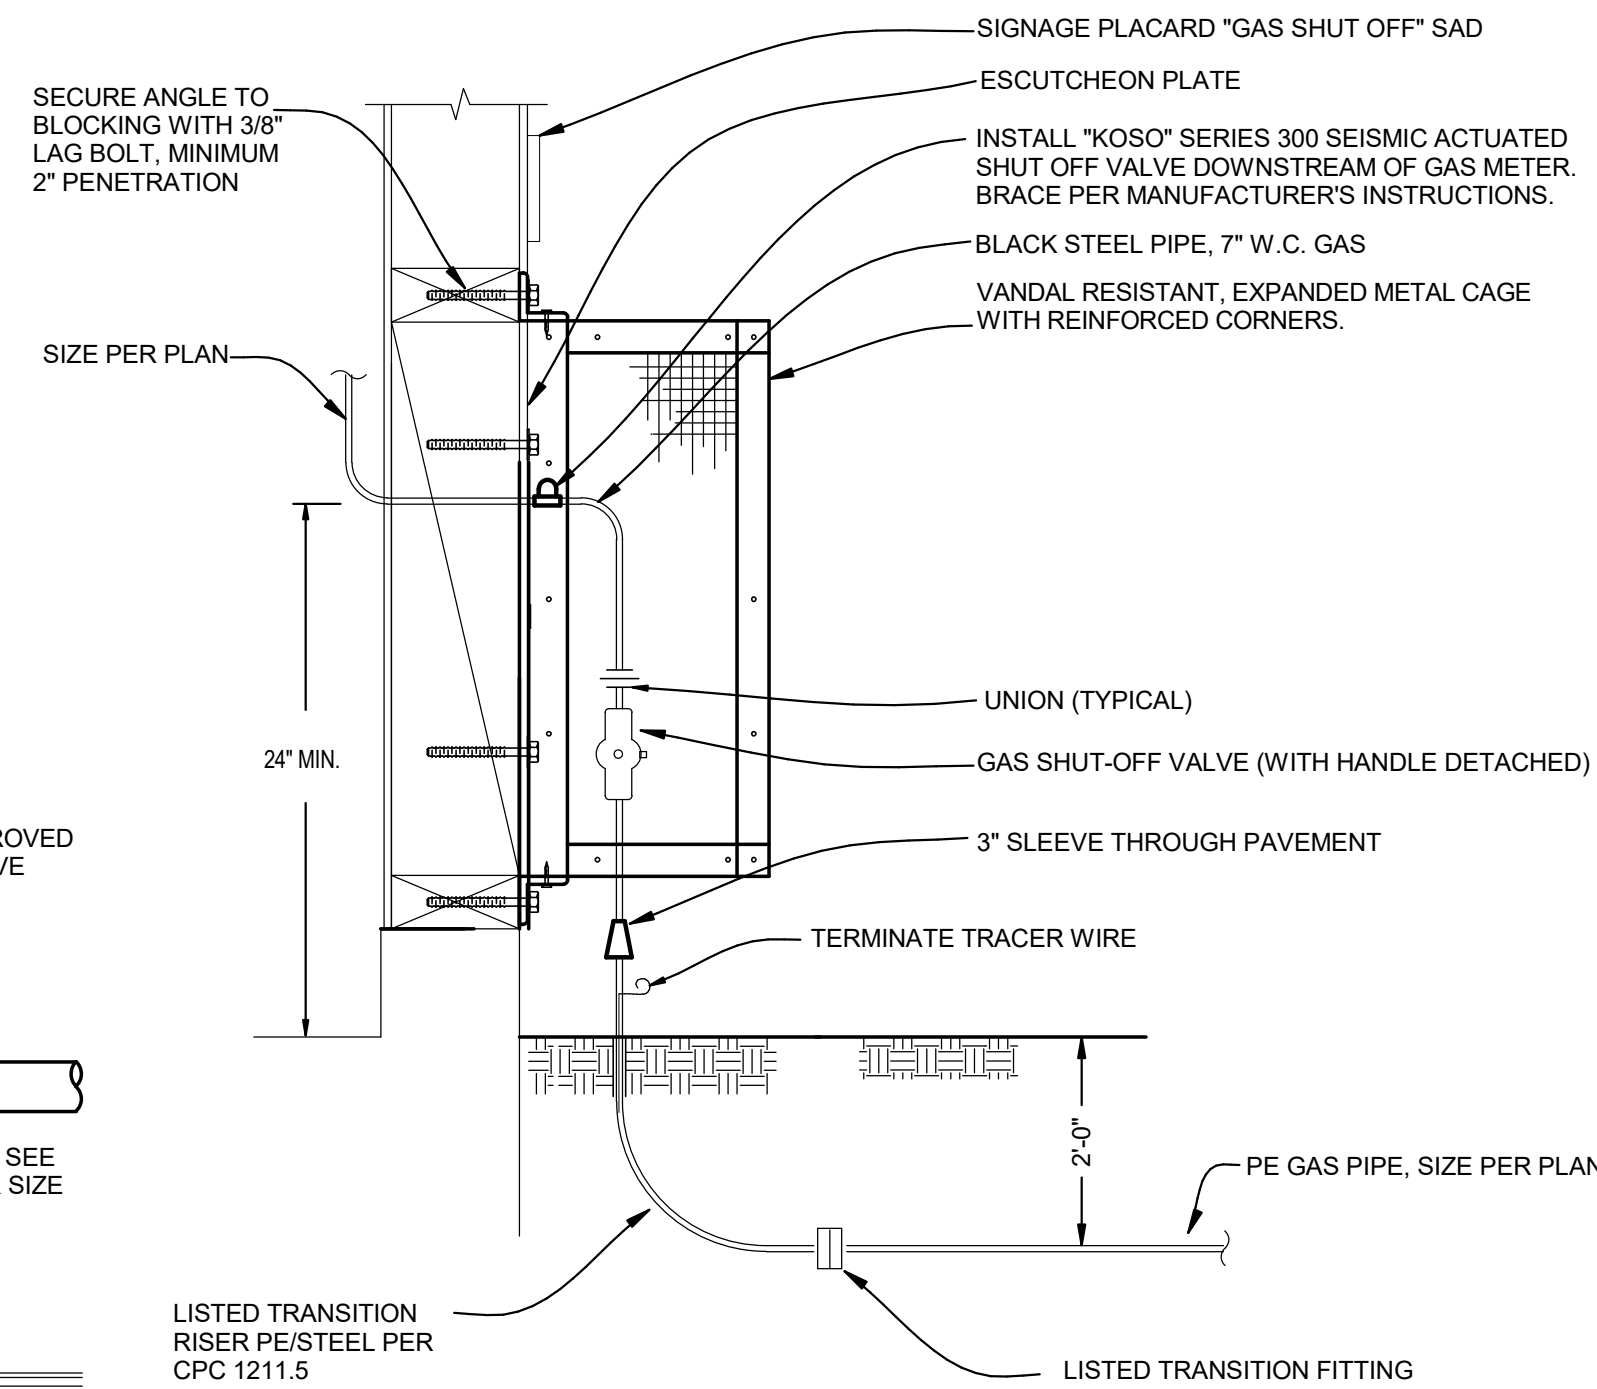


**C GAS REGULATOR IN ENCLOSURE CAGE**  
SCALE: NONE

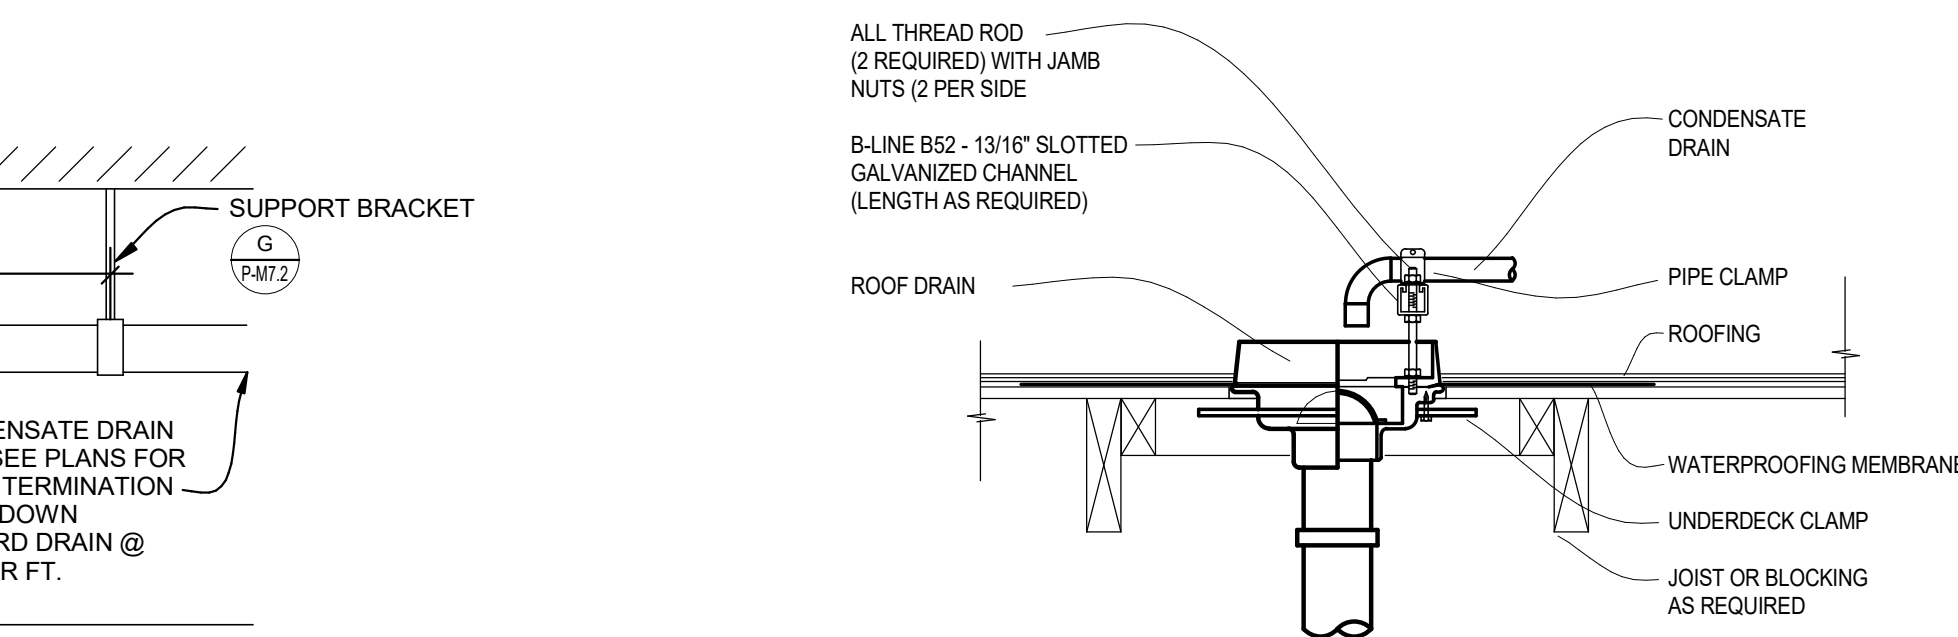


**F CONDENSATE TO ROOF DRAIN**  
SCALE: NONE

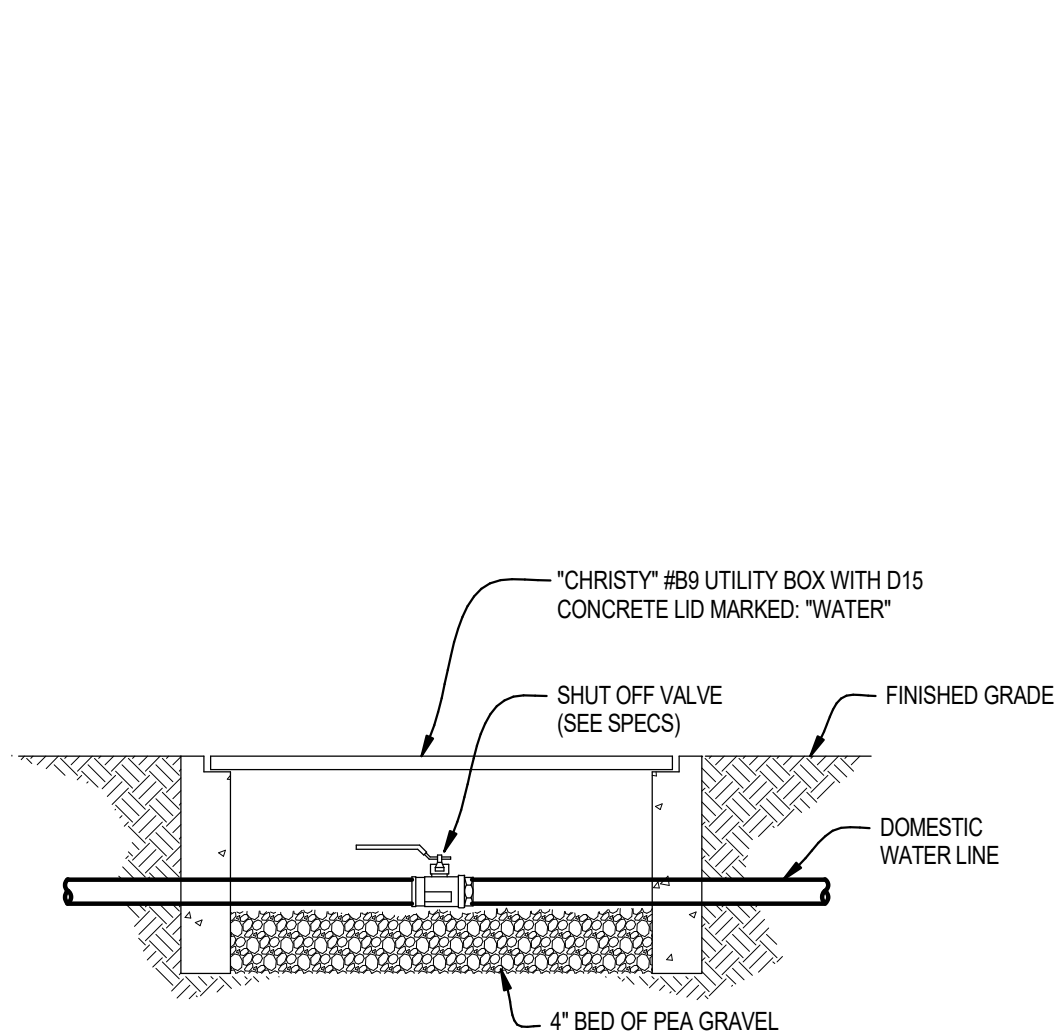


**G DOMESTIC WATER SHUT-OFF**  
SCALE: NONE

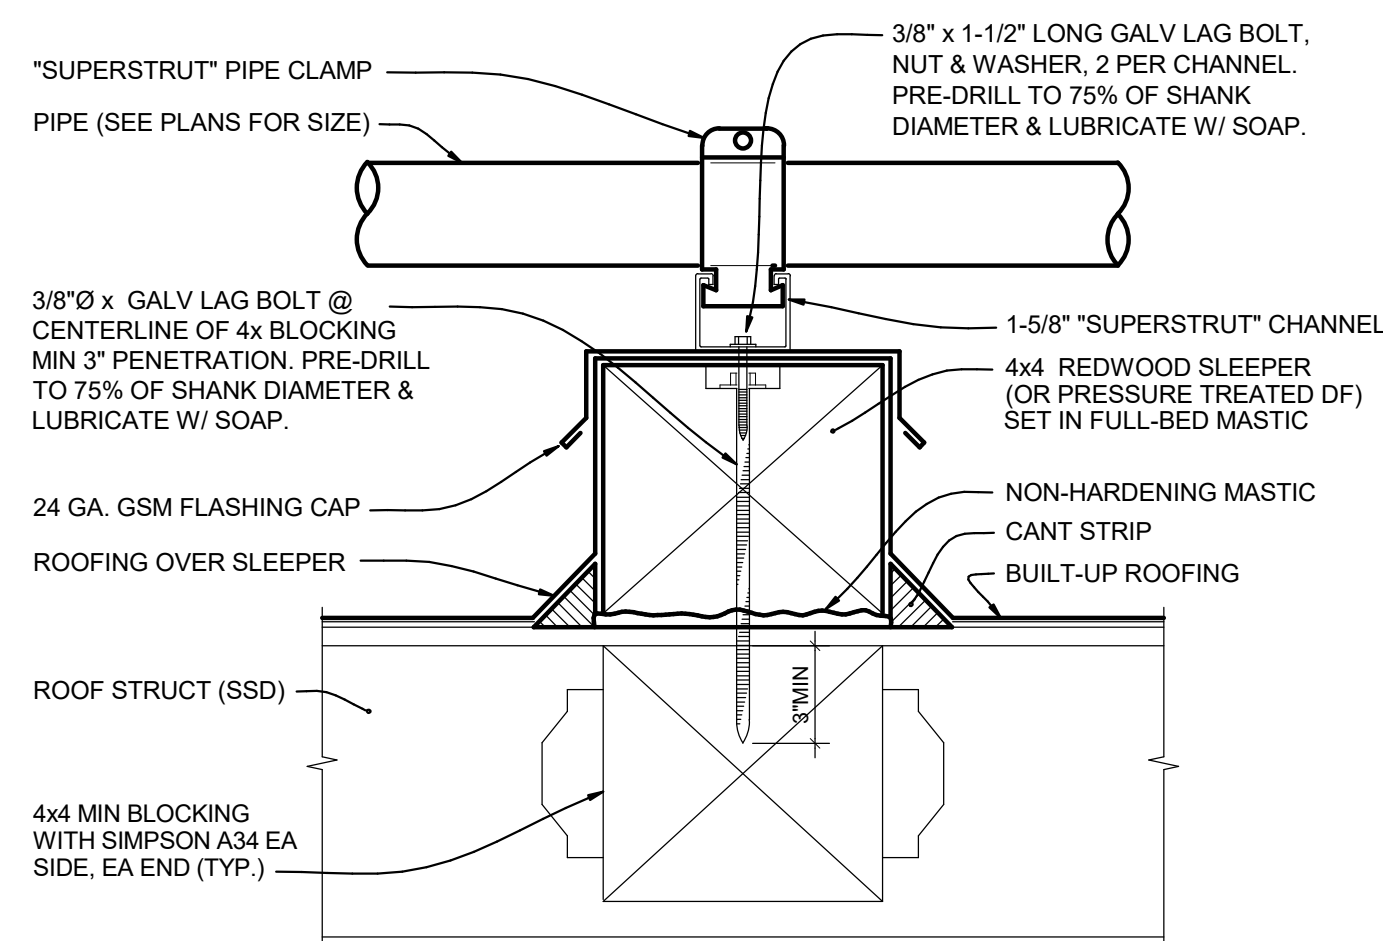


**H GAS PIPE ON ROOF**  
SCALE: NONE

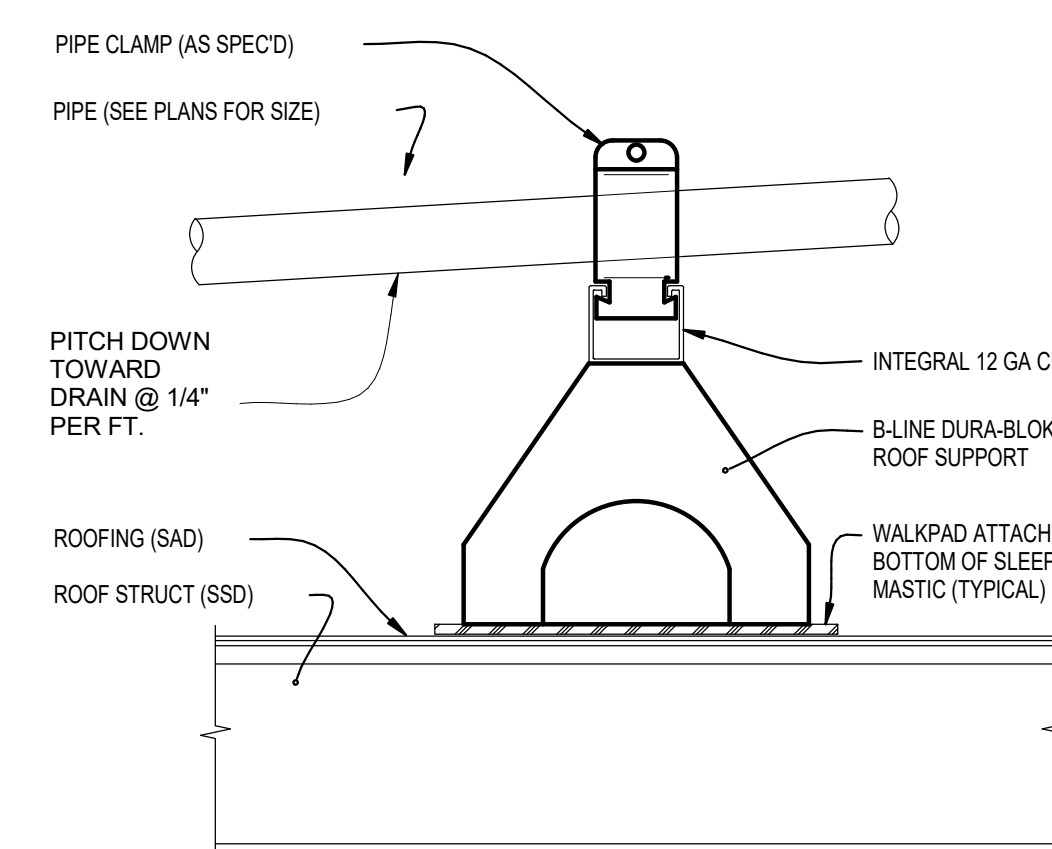

**J PIPE SUPPORT ON ROOF DETAIL**  
SCALE: NONE

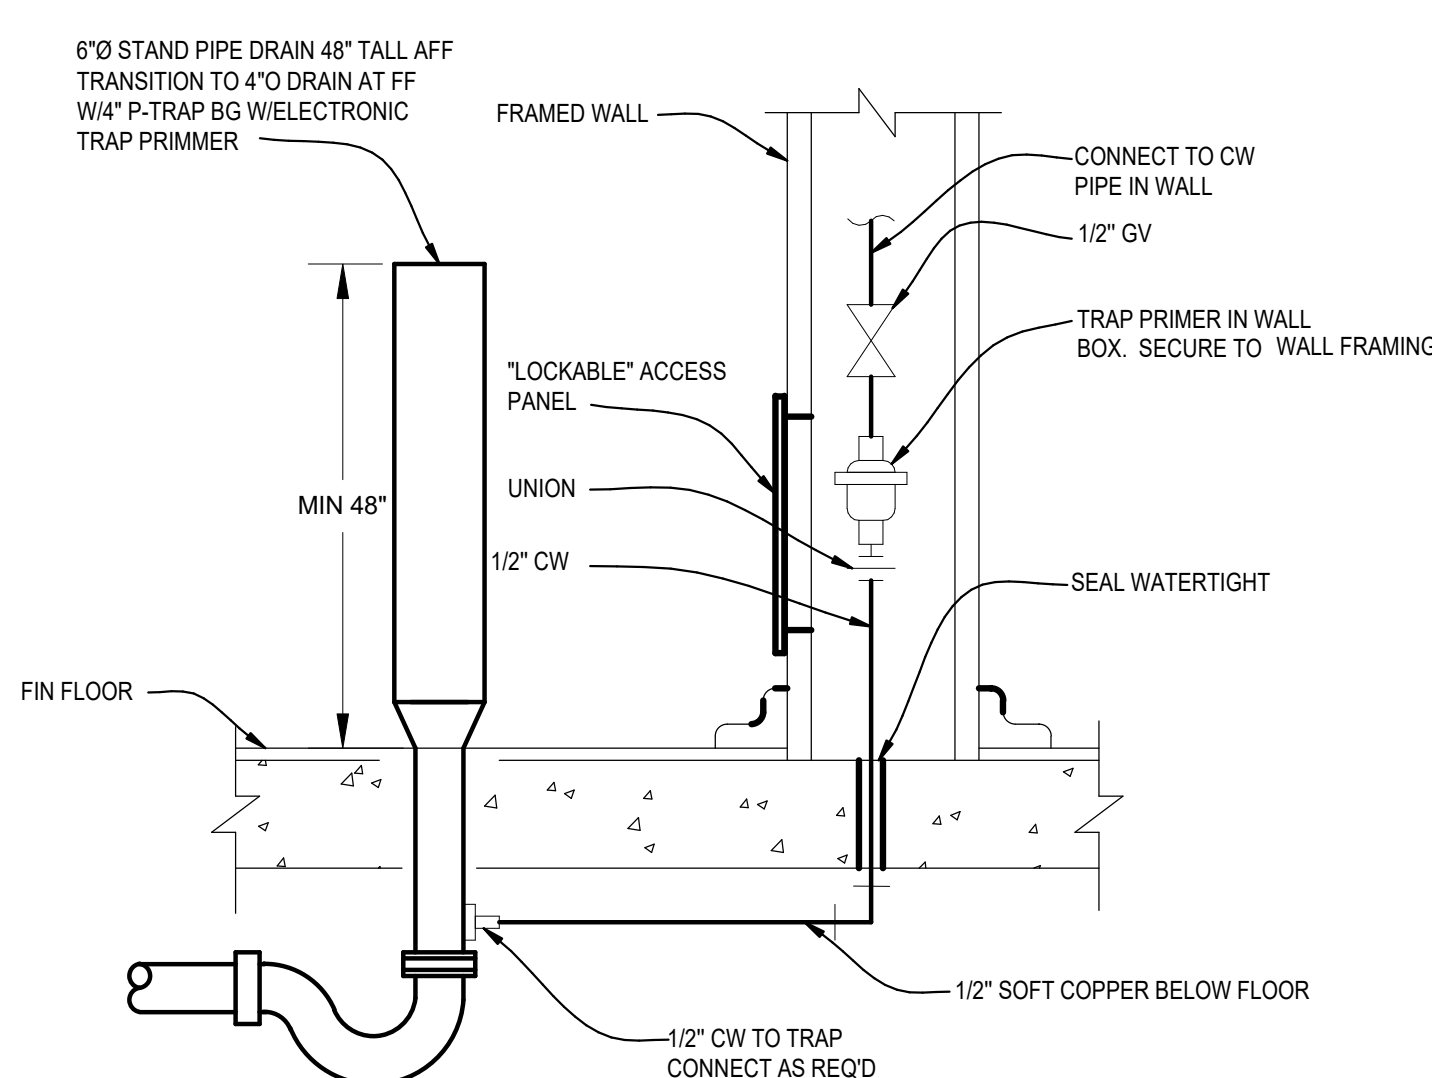


**K FIRE STAND DRAIN**  
SCALE: NONE

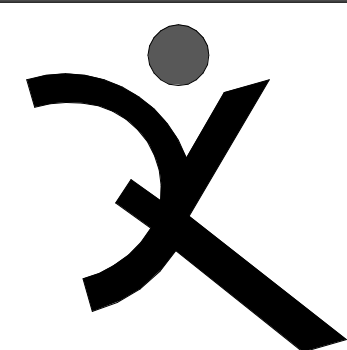

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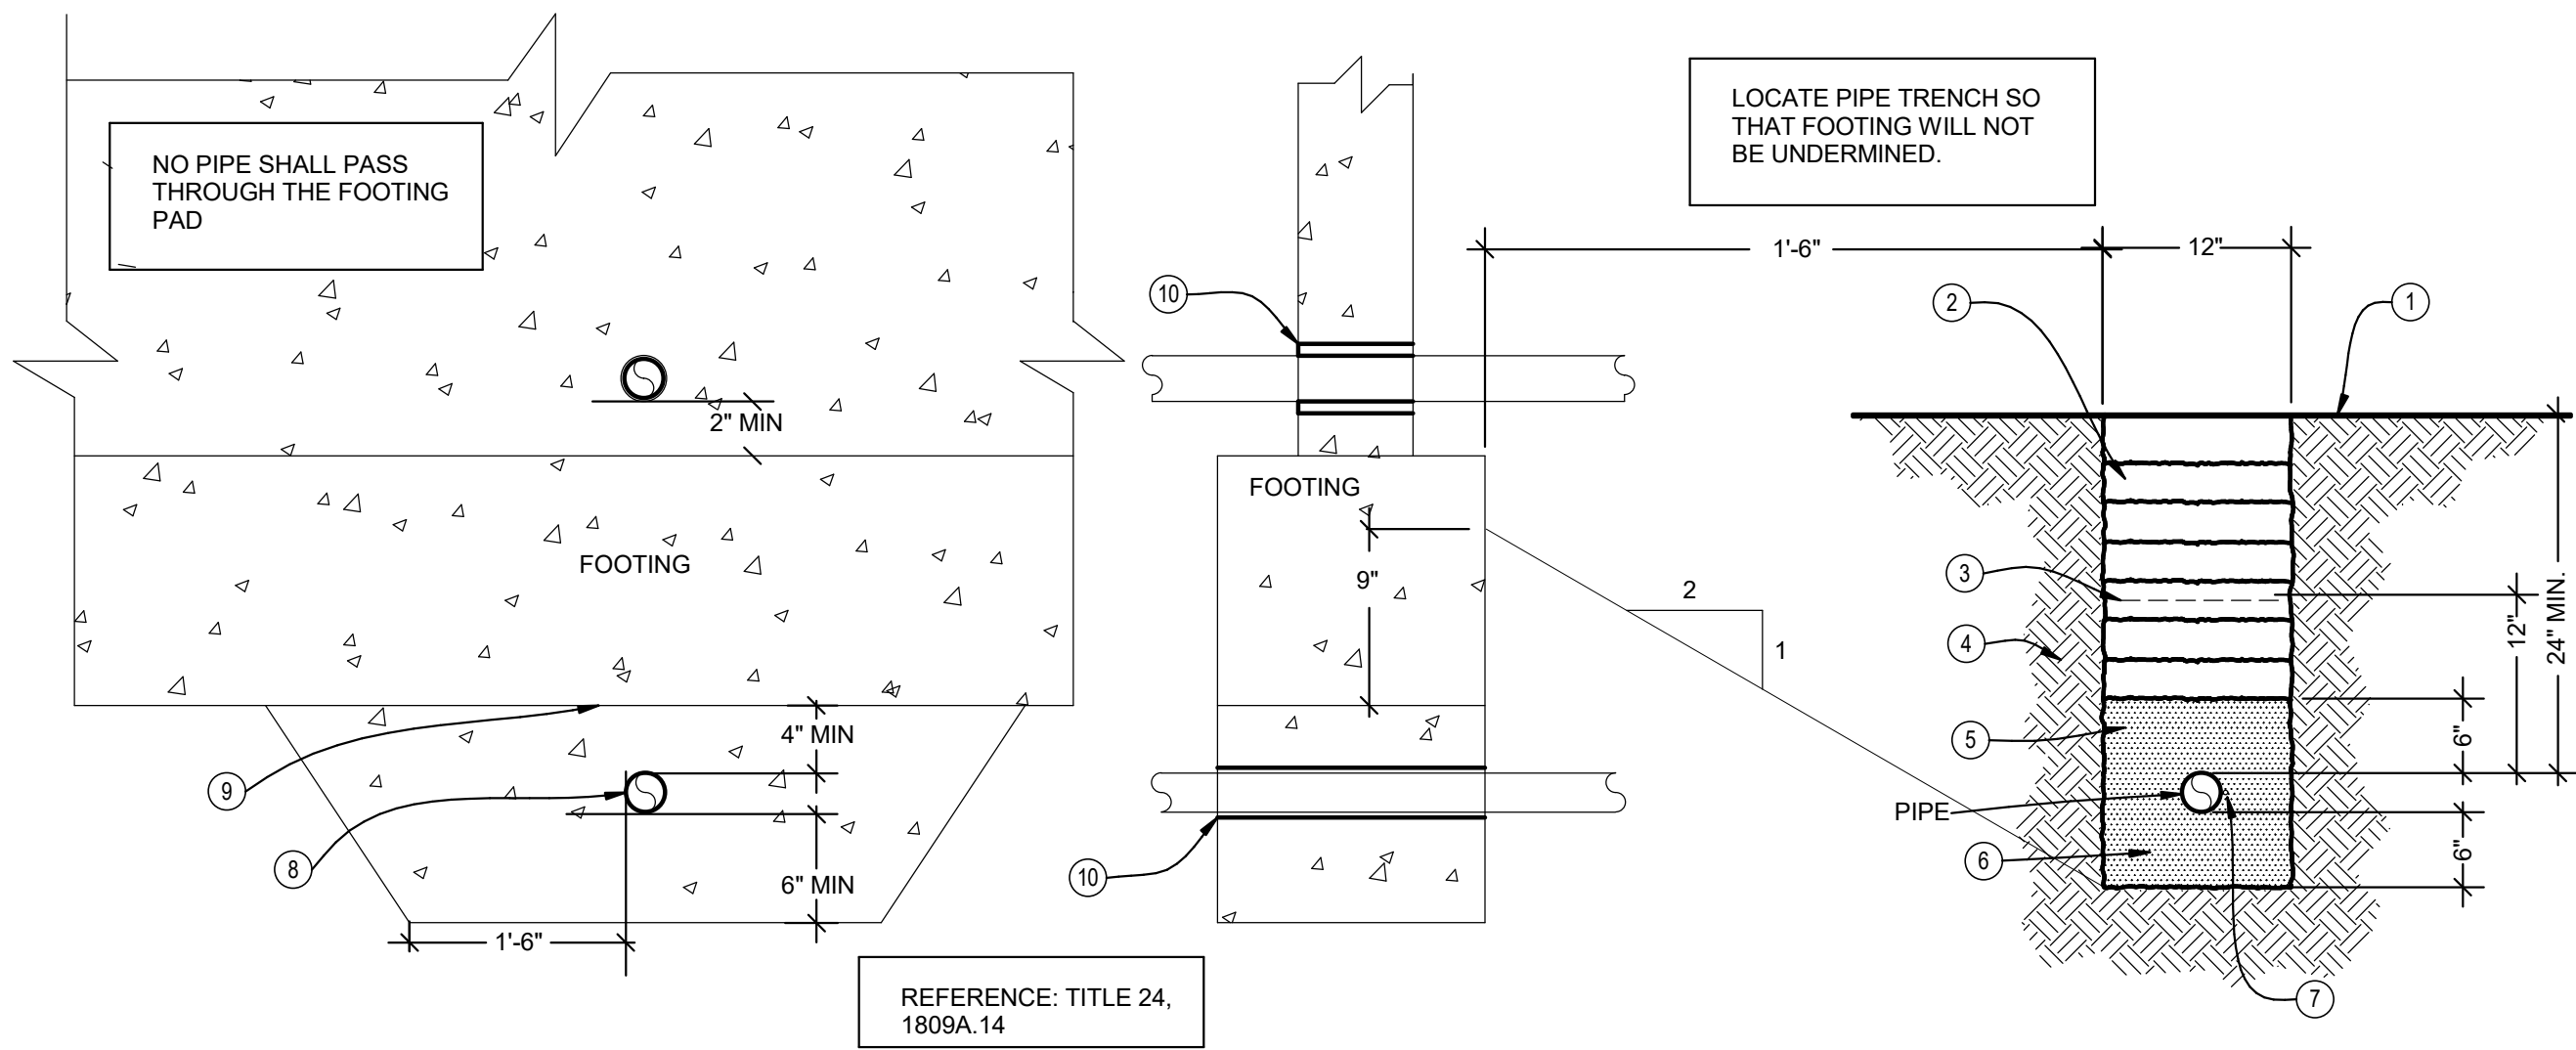
**PLUMBING DETAILS**

SHEET NUMBER

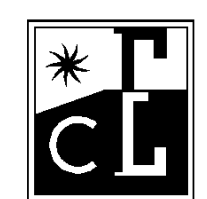
**P-M7.1**



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- REPAIR ASPHALT PAVING OR CONCRETE TO MATCH EXISTING
- BACK FILL IN 6" LAYERS. EACH LAYER TAMPED TO 95% MAX. DRY DENSITY PER ASTM D-1557-64T
  - WARNING TAP, 6" WIDE MINIMUM
  - UNDISTURBED EARTH
  - CLEAN SAND 6" ABOVE & BELOW PIPE
  - 6" CLEAR ALL AROUND
  - #12 SOLID COPPER TRACER WIRE ALONG ALL NONMETALLIC PIPING. ATTACH TO PIPE W/ "TY-WRAP" @ "TY-WRAP 8'-0" O.C.
  - PLACE CONCRETE FILL AROUND SLEEVES BEFORE POURING FOOTING PADS. FILL SHALL BE SAME WIDTH AS FOOTING AND FULL PLACE CONCRETE FILL.
  - POUR JOINT
  - PROVIDE METAL SLEEVES WITH I.D. 2" GREATER THAN THE O.D. OF THE PIPE.




## A PIPE TRENCH DETAIL & FOOTING PENETRATIONS

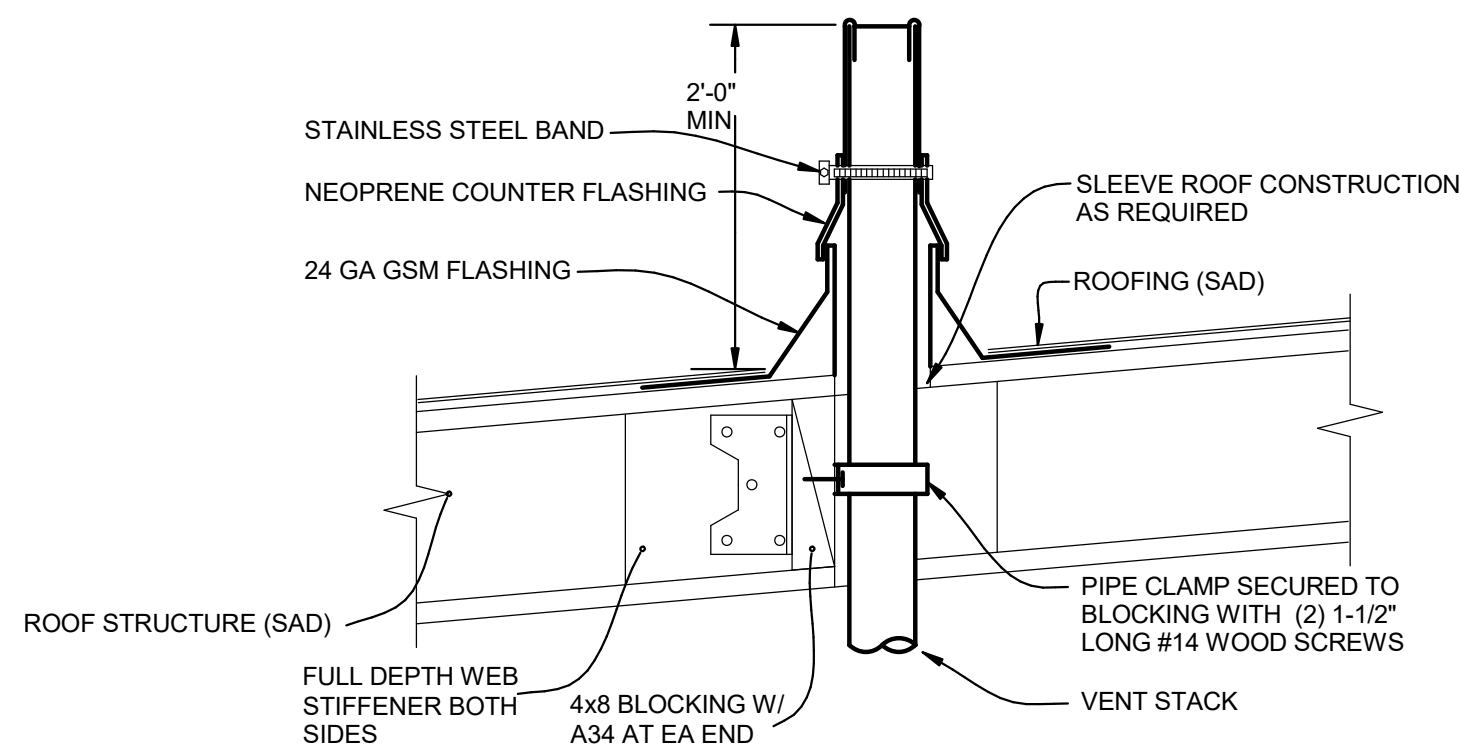SCALE: NONE

## B VENT THRU ROOF DETAIL

SCALE: NONE

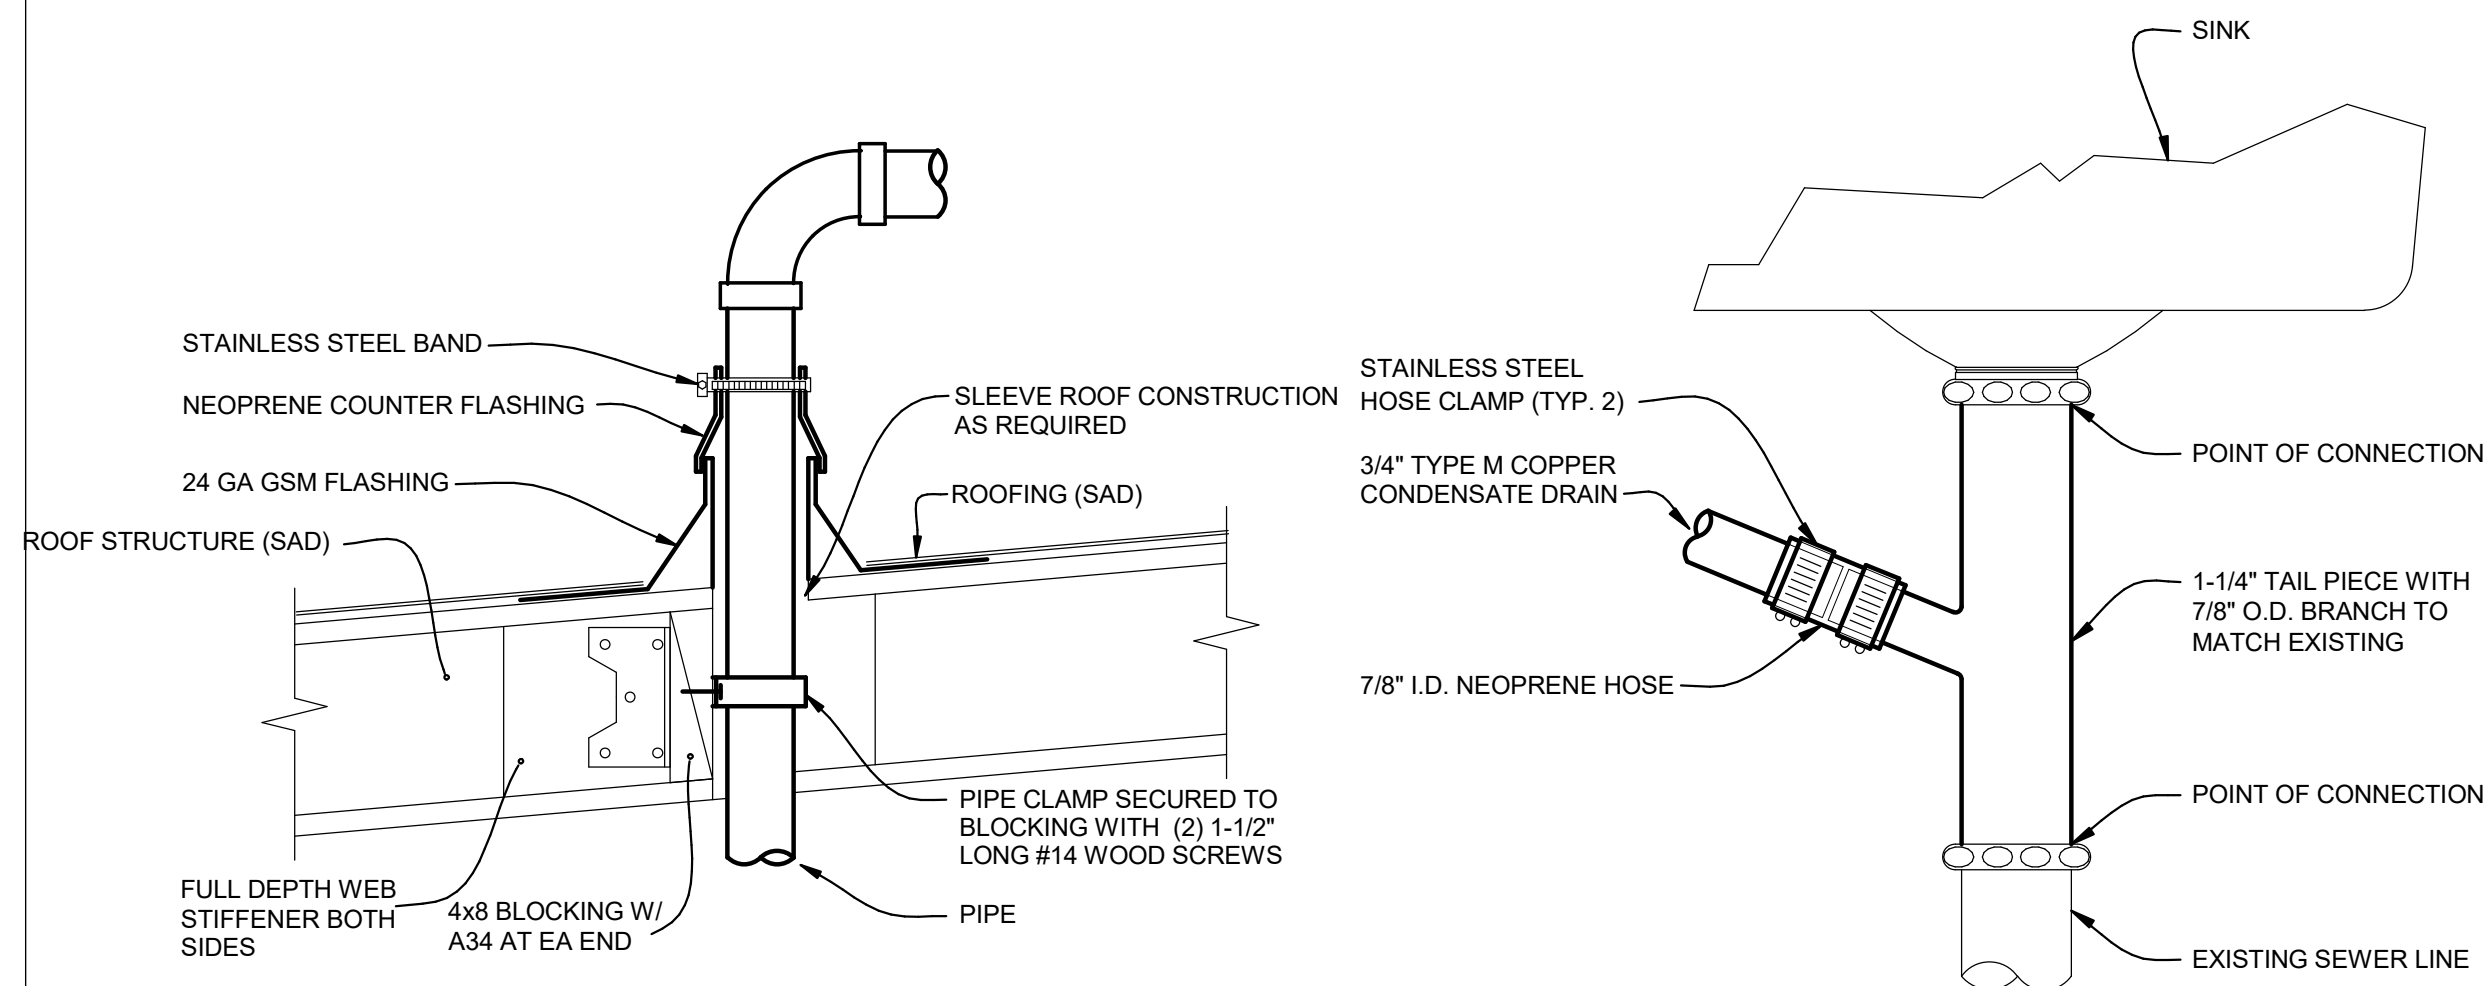


## C PIPE THRU ROOF

SCALE: NONE

## D CONDENSATE TERMINATIONS

SCALE: NONE

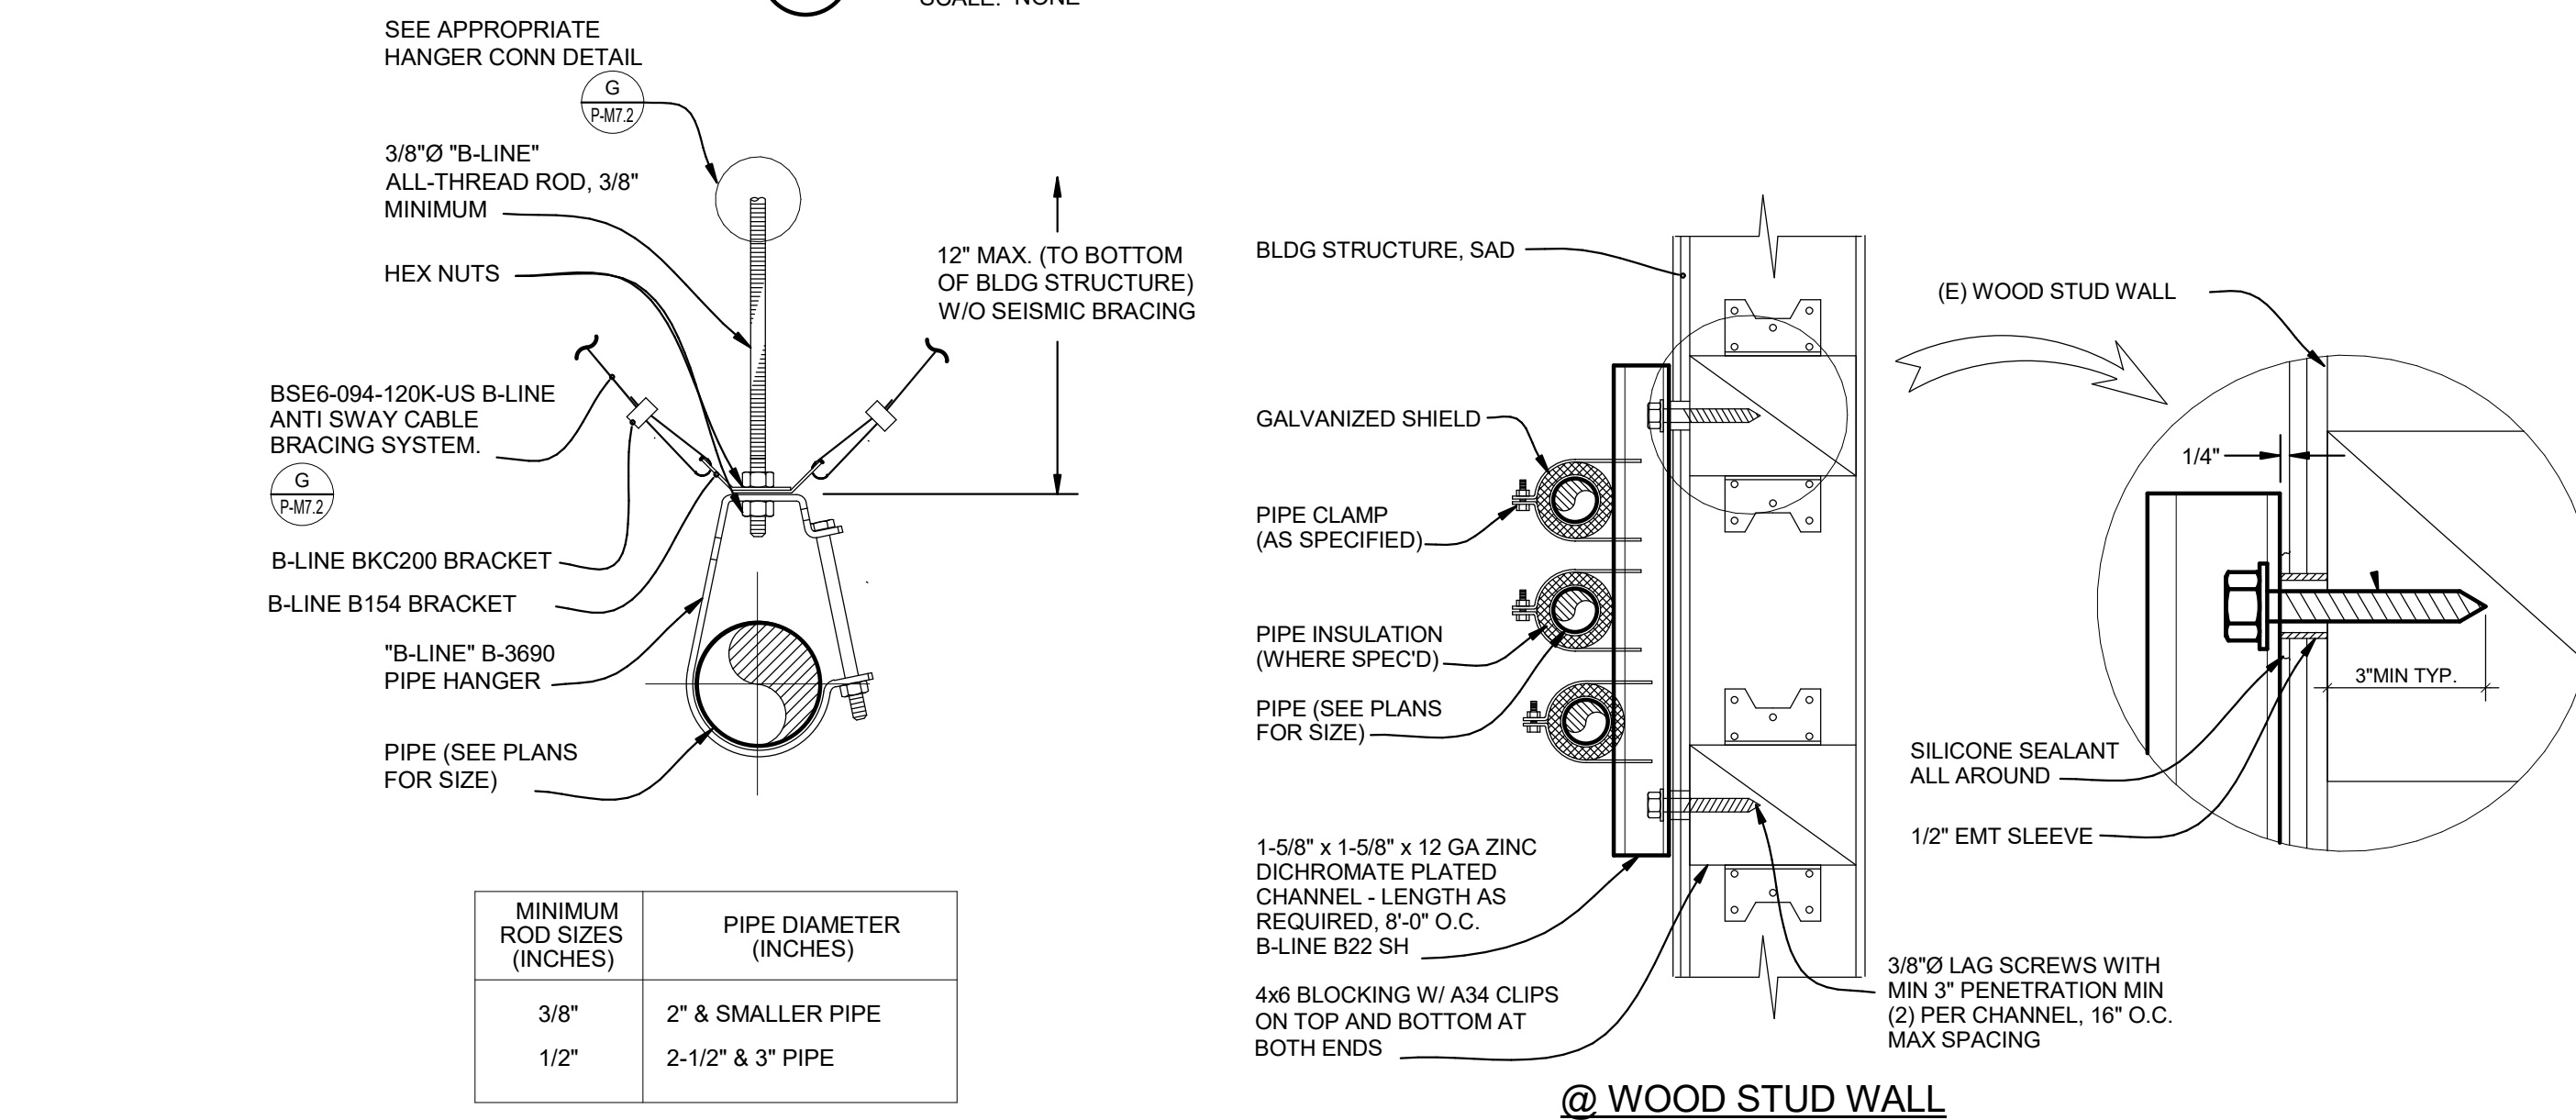


## E TYPICAL PIPE HANGER DETAILS

SCALE: NONE


## F PLUMBING CHANNEL SUPPORT DETAIL

SCALE: NONE

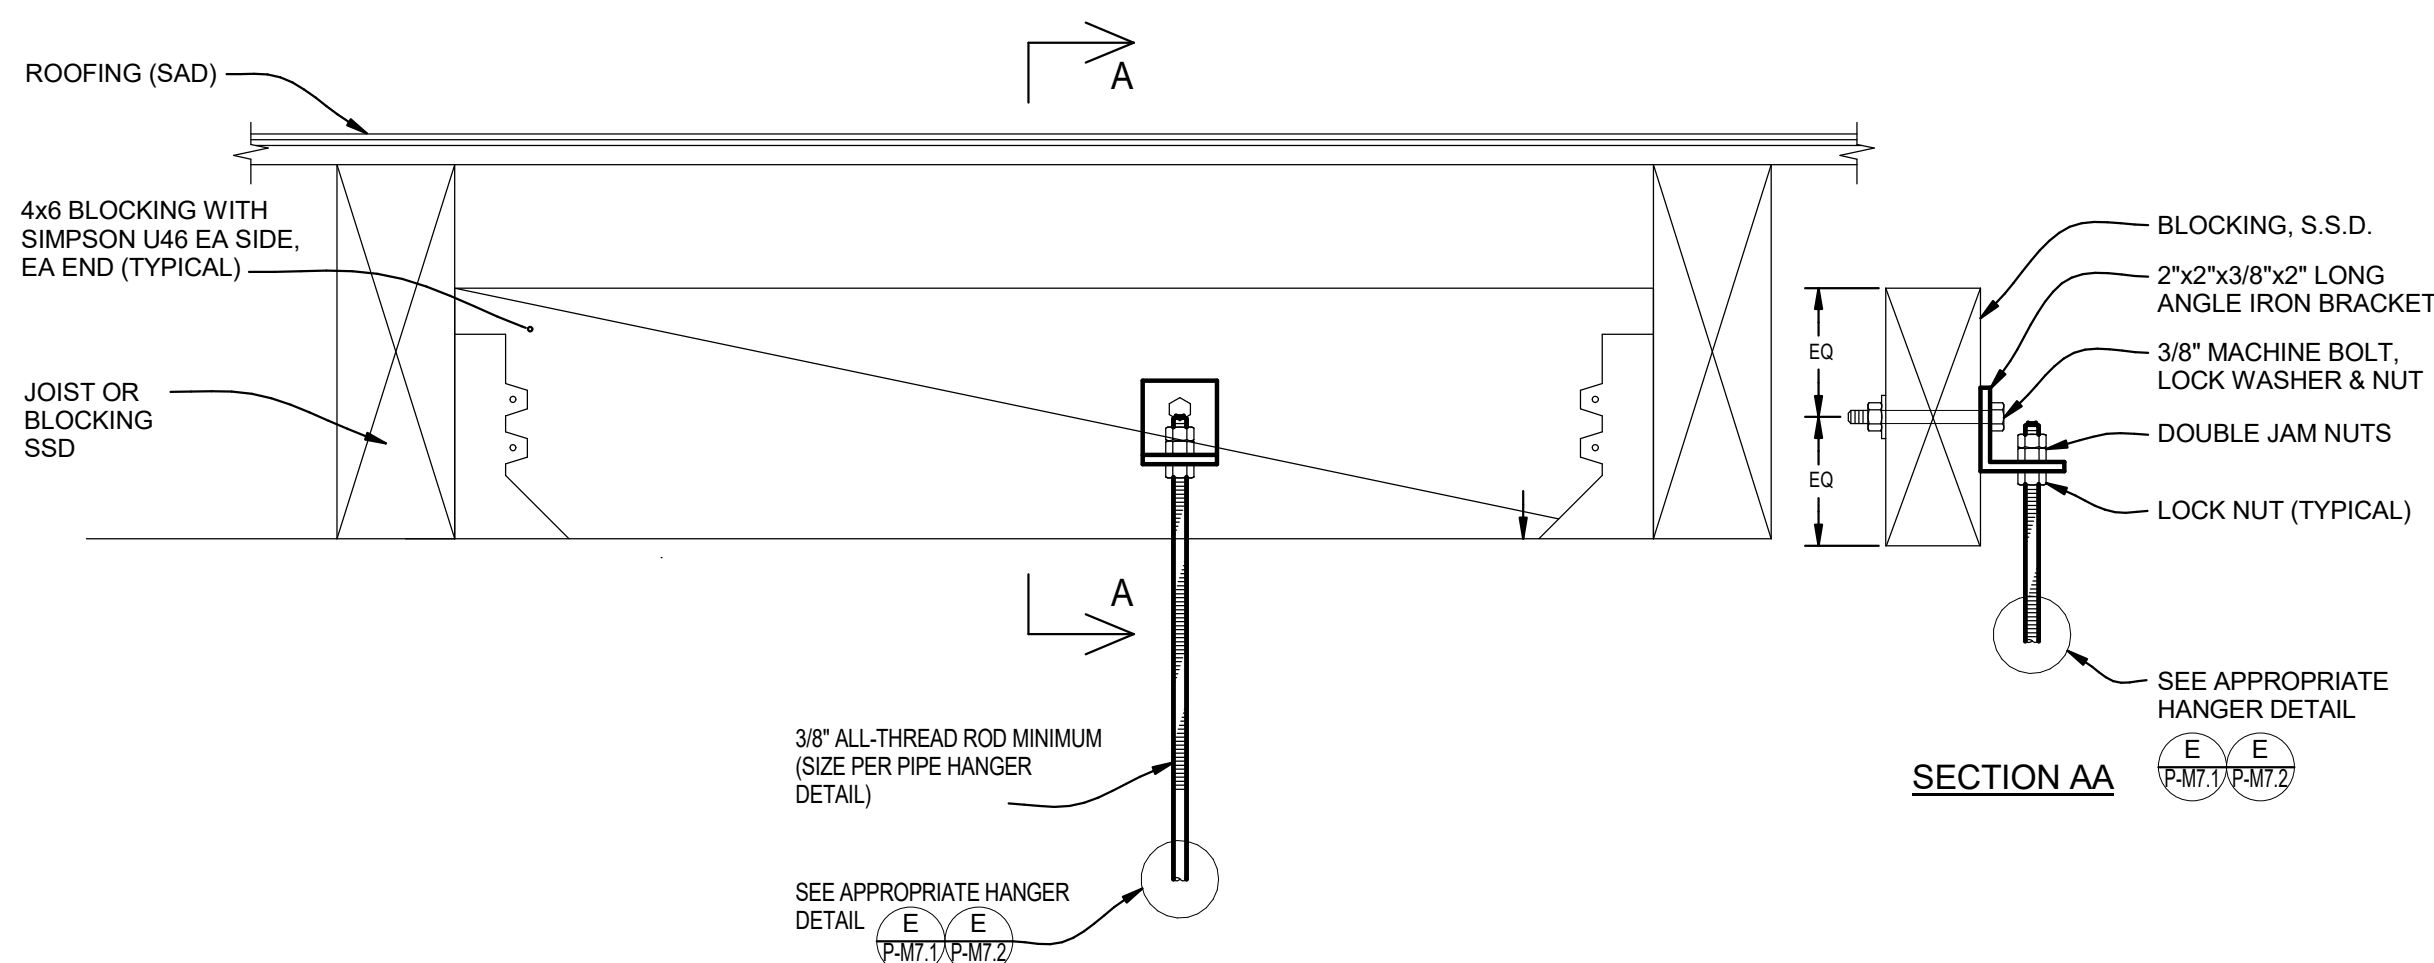


## G HANGER CONNECTION DETAILS

SCALE: NONE

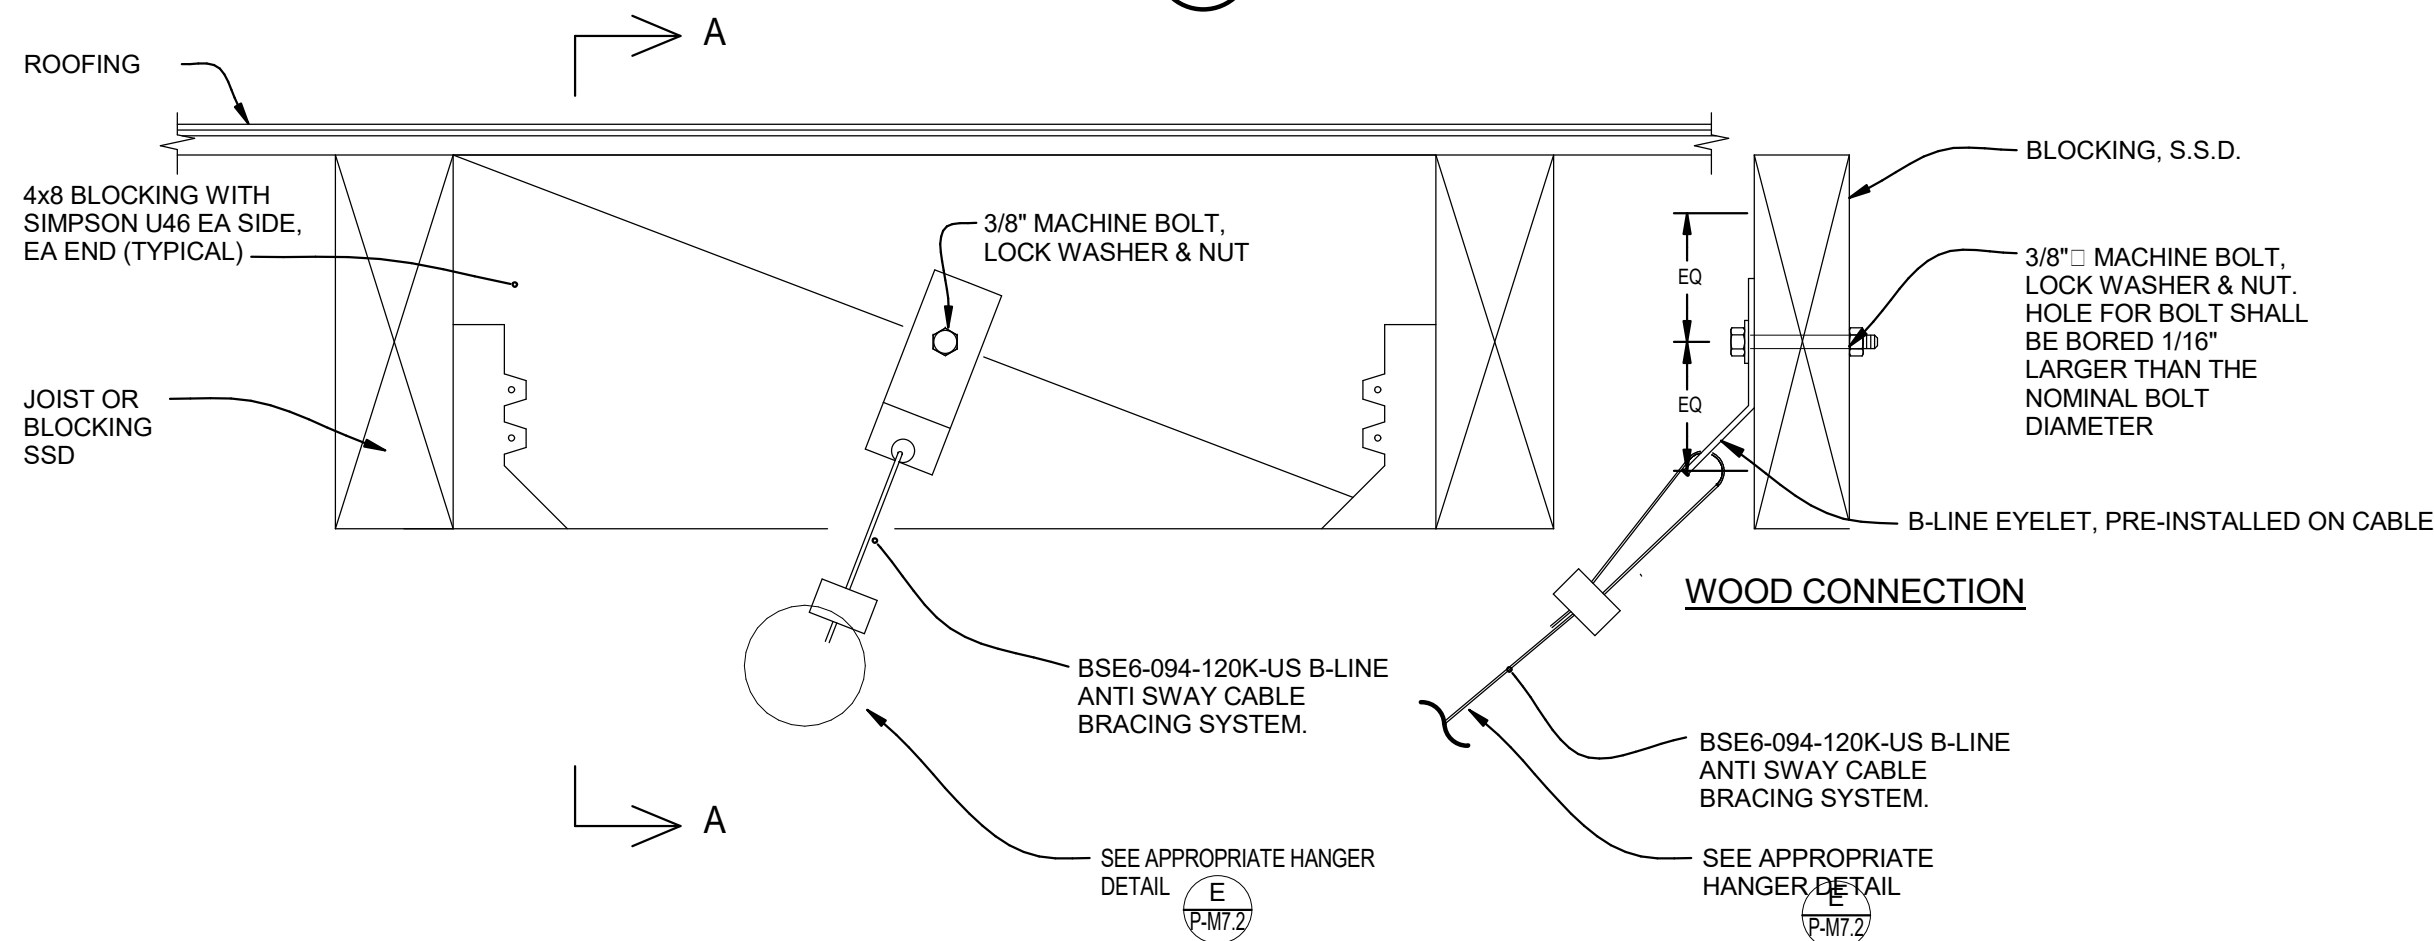


## H ANTI SWAY CABLE CONNECTION DETAIL

SCALE: NONE

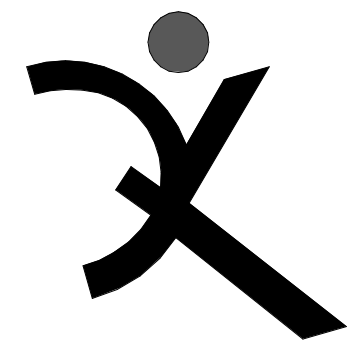

QUATTROCCHI KWOK  
ARCHITECTS  
Main Office:  
636 Fifth Street, Santa Rosa, CA 95404  
East Bay:  
55 Harrison Street, Suite 525,  
Oakland, CA 94607  
(707) 576-0829

SIGNED: OCTOBER 30, 2020

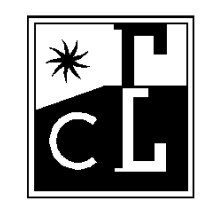

COSTA ENGINEERS INC.

3274 Villa Lane Suite, CA 94608 ph: 707-252-9177 fax: 707-252-0473



FREEDOM  
HIGH SCHOOL

NEW AUXILIARY  
GYMNASIUM

1050 NEROLY RD,  
OAKLEY, CA 94561

LIBERTY UNION  
HIGH SCHOOL  
DISTRICT


DSA APP NO. 01-119278  
ARCH PROJECT NO: 1869.00  
DRAWN BY: MQ  
DRAWING SCALE:  
PTN: 61721-78 FILE NO: 7-H4

BID DOCUMENT

APRIL 27, 2021

SHEET TITLE

PLUMBING  
DETAILS

SHEET NUMBER

P-M7.2



## ELECTRICAL EQUIPMENT ANCHORAGE

### ELECTRICAL ANCHORAGE NOTES:

ALL ELECTRICAL COMPONENTS SHALL BE ANCHORED AND INSTALLED PER THE DETAILS ON THE DSA APPROVED CONSTRUCTION DOCUMENTS. THE FOLLOWING COMPONENTS SHALL BE ANCHORED OR BRACED TO MEET THE FORCE AND DISPLACEMENT REQUIREMENTS PRESCRIBED IN THE 2019 CBC, SECTIONS 1617A.1.18 THROUGH 1617A.1.26 AND ASCE 7-16, CHAPTER 13, 26, AND 30.

- ALL PERMANENT EQUIPMENT AND COMPONENTS.
- TEMPORARY, MOVABLE OR MOBILE EQUIPMENT THAT IS PERMANENTLY ATTACHED (e.g. HARD WIRED) TO THE BUILDING UTILITY SERVICES SUCH AS ELECTRICITY, GAS OR WATER. "PERMANENTLY ATTACHED" SHALL INCLUDE ALL ELECTRICAL CONNECTIONS EXCEPT PLUGS FOR 110/220 VOLT RECEPTACLES HAVING A FLEXIBLE CABLE.
- TEMPORARY, MOVABLE OR MOBILE EQUIPMENT THAT IS HEAVIER THAN 400 POUNDS OR HAS A CENTER OF MASS LOCATED 4 FEET OR MORE ABOVE THE ADJACENT FLOOR OR ROOF LEVEL THAT DIRECTLY SUPPORT THE COMPONENT IS REQUIRED TO BE RESTRAINED IN A MANNER APPROVED BY DSA.

THE FOLLOWING ELECTRICAL COMPONENTS SHALL BE POSITIVELY ATTACHED TO THE STRUCTURE, BUT NEED NOT DEMONSTRATE DESIGN COMPLIANCE WITH THE REFERENCES NOTED ABOVE. THESE COMPONENTS SHALL HAVE FLEXIBLE CONNECTIONS PROVIDED BETWEEN THE COMPONENT AND ASSOCIATED CONDUIT. FLEXIBLE CONNECTIONS MUST ALLOW MOVEMENT IN BOTH TRANSVERSE AND LONGITUDINAL DIRECTIONS.

- COMPONENT WEIGHING LESS THAN 400 POUNDS AND HAVE A CENTER OF MASS LOCATED 4 FEET OR LESS ABOVE THE ADJACENT FLOOR OR ROOF LEVEL THAT DIRECTLY SUPPORT THE COMPONENT.
- COMPONENTS WEIGHING LESS THAN 20 POUNDS, OR IN THE CASE OF DISTRIBUTED SYSTEMS, LESS THAN 5 POUNDS PER FOOT, WHICH ARE SUSPENDED FROM A ROOF OR FLOOR OR HUNG FROM WALL.

THE ANCHORAGE OF ALL ELECTRICAL COMPONENTS SHALL BE SUBJECT TO THE APPROVAL OF THE DESIGN PROFESSIONAL. IN GENERAL, RESPONSIBLE CHARGE OR STRUCTURAL ENGINEER DELEGATED RESPONSIBILITY AND ACCEPTANCE BY DSA. THE PROJECT INSPECTOR WILL VERIFY THAT ALL COMPONENTS AND EQUIPMENT HAVE BEEN ANCHORED IN ACCORDANCE WITH THE ABOVE REQUIREMENTS.

### ELECTRICAL DISTRIBUTION SYSTEM BRACING NOTE:

ELECTRICAL DISTRIBUTION SYSTEMS SHALL BE BRACED TO COMPLY WITH THE FORCES AND DISPLACEMENTS PRESCRIBED IN ASCE 7-16 SECTION 13.3 AS DEFINED IN ASCE 7-16 SECTION 13.6.5, 13.6.6, 13.6.7, 13.6.8, AND 2019 CBC, SECTIONS 1617A.1.24, 1617A.1.25, AND 1617A.1.26.

THE METHOD OF SHOWING BRACING AND ATTACHMENTS TO THE STRUCTURE FOR THE IDENTIFIED DISTRIBUTION SYSTEM ARE AS NOTED BELOW. WHEN BRACING AND ATTACHMENTS ARE BASED ON A PREAPPROVED INSTALLATION GUIDE (e.g., OSHIP OPM FOR 2013 CBC), COPIES OF THE BRACING SYSTEM INSTALLATION GUIDE OR MANUAL SHALL BE AVAILABLE ON THE JOBSITE PRIOR TO THE START OF AND DURING THE HANGING AND BRACING OF THE DISTRIBUTION SYSTEMS. THE STRUCTURAL ENGINEER OF RECORD SHALL VERIFY THE ADEQUACY OF THE STRUCTURE TO SUPPORT THE HANGER AND BRACE LOADS.

ELECTRICAL DISTRIBUTION SYSTEMS ARE: DETAILED ON THE APPROVED DRAWINGS WITH PROJECT SPECIFIC NOTES AND DETAILS.

### LIGHT FIXTURES:

ALL LIGHT FIXTURES SHALL BE POSITIVELY ATTACHED TO THE CEILING SUSPENSION SYSTEMS BY MECHANICAL MEANS TO RESIST A HORIZONTAL FORCE EQUAL TO THE WEIGHT OF THE FIXTURE. A MINIMUM OF TWO SCREWS OR APPROVED FASTENERS ARE REQUIRED AT EACH LIGHT FIXTURE, PER ASTM E580, SECTION 9.3.1.

SURFACE-MOUNTED LIGHT FIXTURES SHALL BE ATTACHED TO THE MAIN RUNNER WITH AT LEAST TWO POSITIVE CLAMPING DEVICES. THE CLAMPING DEVICE SHALL COMPLETELY SURROUND THE SUPPORTING CEILING RUNNER AND BE MADE OF STEEL WITH A MINIMUM THICKNESS OF #14 GAGE. ROTATIONAL SPRING CATCHES DO NOT COMPLY. A #12 GAGE SLACK SAFETY WIRE SHALL BE CONNECTED FROM EACH CLAMPING DEVICE TO THE STRUCTURE ABOVE. PROVIDE ADDITIONAL SUPPORTS WHEN LIGHT FIXTURES ARE EIGHT (8) FEET OR LONGER OR EXCEED 56 LB. MAXIMUM SPACING BETWEEN SUPPORTS SHALL NOT EXCEED EIGHT (8) FEET.

LIGHT FIXTURES WEIGHING LESS THAN OR EQUAL TO 10 LB. SHALL HAVE A MINIMUM OF ONE (1) #12 GAGE SLACK SAFETY WIRE CONNECTED FROM THE FIXTURE HOUSING TO THE STRUCTURE ABOVE.

LIGHT FIXTURES WEIGHING GREATER THAN 10 LB. BUT LESS THAN OR EQUAL TO 56 LBS. MAY BE SUPPORTED DIRECTLY ON THE CEILING RUNNERS, BUT THEY SHALL HAVE A MINIMUM OF TWO (2) #12 GAGE SLACK SAFETY WIRES CONNECTED FROM THE FIXTURE HOUSING AT DIAGONAL CORNERS TO THE STRUCTURE ABOVE. EXCEPTION: ALL LIGHT FIXTURES GREATER THAN TWO BY FOUR FEET WEIGHING LESS THAN 56 LBS. SHALL HAVE A #12 GAGE SLACK SAFETY WIRE AT EACH CORNER.

ALL LIGHT FIXTURES WEIGHING GREATER THAN 56 LB. SHALL BE INDEPENDENTLY SUPPORTED BY NOT LESS THAN FOUR (4) TAUT #12 GAGE HANGER WIRES (ONE AT EACH CORNER) ATTACHED FROM THE FIXTURE HOUSING TO THE STRUCTURE ABOVE OR OTHER APPROVED HANGERS. THE FOUR (4) TAUT #12 GAGE WIRES OR OTHER APPROVED HANGERS, INCLUDING THEIR ATTACHMENT TO THE STRUCTURE ABOVE, SHALL BE CAPABLE OF SUPPORTING FOUR (4) TIMES THE WEIGHT OF THE FIXTURE.

## GENERAL DEMOLITION NOTES

- THE CONTRACTOR SHALL VERIFY IN THE FIELD ALL LINES, LEVELS, DIMENSIONS AND EXISTING CONDITION. THE INFORMATION ON THE DRAWINGS REGARDING EXISTING ELECTRICAL EQUIPMENT AND BRANCH CIRCUITS IS THE RESULT OF FIELD SURVEY AND IS ACCURATE TO THE BEST OF OUR KNOWLEDGE. IT IS INTENDED, HOWEVER, AS A GUIDE FOR USE IN VERIFICATION ONLY.
- ANY EXISTING ELECTRICAL EQUIPMENT IN THE AREA OF NEW CONSTRUCTION NOT SHOWN ON THE EXISTING PLANS SHALL BE DOCUMENTED AND SUBMITTED TO THE ENGINEER FOR DETERMINATION OF ACTION REQUIRED.
- WHEREVER THE REMOVAL OF EXISTING ELECTRICAL EQUIPMENT IS CALLED FOR AND ALL EQUIPMENT ON A PARTICULAR BRANCH CIRCUIT IS TO BE REMOVED, ALL CONDUIT AND WIRE BACK TO THE PANEL SHALL BE ENTIRELY REMOVED. THE EXISTING ELECTRICAL EQUIPMENT, MARKED "SPARE," THIS APPLIES TO SIGNAL AND COMMUNICATIONS SYSTEMS EQUIPMENT, CONDUIT, AND WIRE AS WELL.
- WHEREVER THE REMOVAL OF EXISTING ELECTRICAL EQUIPMENT IS CALLED FOR AND ALL EQUIPMENT ON A PARTICULAR BRANCH CIRCUIT IS NOT TO BE REMOVED, THE CIRCUIT SHALL BE MAINTAINED CONTINUOUS TO THE EXISTING EQUIPMENT IN USE WITH MINIMUM INTERRUPTIONS OF POWER. THIS APPLIES TO SIGNAL AND COMMUNICATIONS SYSTEMS EQUIPMENT, CONDUIT, AND WIRE AS WELL.
- WHENEVER THE REMOVAL OF EXISTING CONSTRUCTION REVEALS ELECTRICAL WORK THAT IS TO REMAIN, BUT IS IN CONFLICT WITH NEW CONSTRUCTION, RELOCATE THE EXISTING ELECTRICAL WORK AS NECESSARY TO AVOID ANY CONFLICT. RELOCATION WORK SHALL BE DONE TO MINIMIZE ANY INTERRUPTIONS OF POWER.
- CARE SHALL BE TAKEN IN ORDER TO IDENTIFY AND PROTECT ALL EXISTING ELECTRICAL WORK THAT IS TO REMAIN.
- ENSURE RECONNECTION OF EXISTING DEVICES WHERE CIRCUITS HAVE BEEN INTERRUPTED BY DEMOLITION BY PROVIDING NEW CONNECTION TO ANOTHER EXISTING TO REMAIN DEVICE OR PANEL.
- ALL EXISTING ELECTRICAL EQUIPMENT SHOWN ON THE PLANS FOR NEW WORK ARE THOSE WHICH ARE TO BE REUSED DURING SOME PHASE OF THE NEW CONSTRUCTION OR REQUIRE SOME SPECIAL CONSIDERATIONS.
- WHENEVER THE REMOVAL OF EXISTING ELECTRICAL PANELBOARDS ARE CALLED FOR AND ALL EXISTING BRANCH CIRCUITS ARE NOT TO BE REMOVED, THE EXISTING BRANCH CIRCUITS SHALL BE CONNECTED TO OTHER EXISTING ELECTRICAL EQUIPMENT OR PANELS STILL IN USE WITH MINIMUM INTERRUPTIONS OF POWER. ALSO, IF REQUIRED, THESE SAME BRANCH CIRCUITS SHALL BE RECONNECTED TO RELOCATED EXISTING OR NEW PANELBOARDS AS PART OF THE NEW CONSTRUCTION. THIS APPLIES TO SIGNAL AND COMMUNICATIONS SYSTEMS EQUIPMENT, CONDUIT AND WIRE AS WELL.
- THE ELECTRICAL CONTRACTOR SHALL REVISE EXISTING PANEL SCHEDULES TO CORRESPOND TO ACTUAL CONDITIONS AFTER ALL DEMOLITION AND NEW WORK IS COMPLETED.
- REMOVE ALL ABANDONED CONDUIT AND WIRE ABOVE CEILINGS.
- WHEN ELECTRICAL EQUIPMENT OR DEVICE IS REMOVED FROM AN EXISTING WALL OR CEILING WHICH IS TO REMAIN, PATCH ABANDONED OPENINGS TO MATCH EXISTING FINISH.
- IN GENERAL, THE DEMOLITION PLANS SHOW ALL EXISTING EQUIPMENT THAT IS TO BE REMOVED UNLESS NOTED OTHERWISE. HOWEVER, ELECTRICAL EQUIPMENT, WHETHER SHOWN ON THIS DRAWING OR NOT, WHERE LOCATED IN THE AREA SCHEDULED TO BE DEMOLISHED, SHALL BE REMOVED COMPLETELY (INCLUDING CONDUIT AND WIRES BACK TO THE LAST REMAINING FIXTURE, OUTLET, DEVICE, ETC.) UNLESS OTHERWISE NOTED. COORDINATE DEMOLITION WORK WITH ARCHITECT AND GENERAL CONTRACTOR.
- EXISTING CONDUIT FEEDS UP THROUGH FLOOR SHALL BE CUT OFF AND PLUGGED FLUSH WITH FLOOR WHERE EXISTING WALLS, ETC., ARE REMOVED. REMOVE CONDUCTORS FROM THE POINT BACK TO LAST OUTLET REMAINING IN SERVICE.
- IT SHALL BE THE RESPONSIBILITY OF THIS CONTRACTOR TO MAINTAIN CONTINUITY OF ALL ELECTRICAL SYSTEMS, EQUIPMENT, ETC. REMAINING IN OPERATION WHICH IS BEING FED BY AN ABANDONED OUTLET. MAINTAINING CONTINUITY SHALL CONSIST OF REROUTING OF CONDUIT, WIRE, ETC. AS REQUIRED.
- THE ELECTRICAL CONTRACTOR SHALL COORDINATE WITH THE OWNER PRIOR TO REMOVAL OF EXISTING ELECTRICAL EQUIPMENT AND TURN OVER REMOVED EQUIPMENT THAT THE OWNER REQUESTS, IN AS-FOUND CONDITION. EQUIPMENT THAT IS TO BE TURNED OVER SHALL BE BOXED AND TAGGED TO IDENTIFY THE SPECIFIC EQUIPMENT. EQUIPMENT TO BE TEMPORARILY REMOVED DUE TO THE CONSTRUCTION SHALL BE CLEANED AND RE-INSTALLED IN ITS ORIGINAL CONDITION OR AS REQUIRED.
- WHERE EXISTING WALLS HAVE BEEN REMOVED, AND THERE ARE EXISTING CONDUIT FEEDS WHICH HAVE BEEN CUT OFF AND CAPPED FLUSH WITH THE FLOOR, IT IS THE CONTRACTOR'S RESPONSIBILITY TO IDENTIFY AND DIMENSION ALL SUCH CONDUITS ON THE "AS-BUILT" DRAWINGS.
- IF ANY EQUIPMENT THAT IS SCHEDULED TO REMAIN IN OPERATION IS DAMAGED BY THE CONTRACTOR, IT SHALL BE REPLACED TO ITS ORIGINAL CONDITION SATISFACTORY TO THE OWNER AT CONTRACTOR'S EXPENSE.

## SYMBOLS LIST

	FIRE ALARM SYSTEM MAGNETIC DOOR HOLD-OPEN
	WALL-MOUNTED BEAM SMOKE DETECTOR - TRANSMITTING UNIT; MOUNT 18" BELOW CEILING LEVEL, U.O.N.
	WALL-MOUNTED BEAM SMOKE DETECTOR - RECEIVING UNIT; MOUNT IN EXACT HORIZONTAL & VERTICAL ALIGNMENT WITH CORRESPONDING TRANSMITTING UNIT
	CEILING-MOUNTED BEAM SMOKE DETECTOR - TRANSMITTING UNIT
	CEILING-MOUNTED BEAM SMOKE DETECTOR - RECEIVING UNIT; MOUNT IN EXACT HORIZONTAL & VERTICAL ALIGNMENT WITH CORRESPONDING TRANSMITTING UNIT
	FIRE ALARM SYSTEM END-OF-LINE RESISTOR
	FIRE SMOKE DAMPER BY MECHANICAL. COORDINATE WITH MECHANICAL FOR MONITORING TO FIRE ALARM SYSTEM (INCLUDING SMOKE DETECTOR PROVISIONS). CONTROL OF DAMPER TO BE BY MECHANICAL, U.O.N. PROVIDE TOGGLE TYPE DISCONNECT SWITCH
	FIRE ALARM CONTROL PANEL
	FIRE ALARM ANNUNCIATOR PANEL
	WEATHERPROOF ENCLOSURE
	CONDUIT AND WIRE CONCEALED IN CEILING OR WALL
	CONDUIT AND WIRE CONCEALED IN OR UNDER SLAB OR UNDERGROUND
	CONDUIT AND WIRE RUN EXPOSED
	CROSSMARKS INDICATE QUANTITY OF #12 CONDUCTORS PLUS PARITY SIZED GROUND CONDUCTOR. NO HASHMARKS INDICATES (2) #12 CONDUCTORS PLUS PARITY SIZED GROUND CONDUCTOR, U.O.N.
	GROUND WIRE
	WIRE SIZE 10 AWG FOR ALL CONDUCTORS, INCLUDING GROUND WIRE, THROUGHOUT THE COMPLETE CIRCUIT
	FLEXIBLE METALLIC CONDUIT
	HOMERUN TO PANELBOARD OR TERMINAL BOARD, AS NOTED ON PLANS
	COMPLETE CONNECTION OF EQUIPMENT
	CONDUIT STUBBED OUT, CAPPED AND MARKED
	CONDUIT TURNED UP
	CONDUIT TURNED DOWN
	TELEPHONE SYSTEM CONDUIT AND PULLWIRE; 3/4" U.O.N.
	COMPUTER/DATA SYSTEM CONDUIT AND PULLWIRE; 3/4" U.O.N.
	TELEPHONE/DATA SYSTEM CONDUIT AND PULLWIRE; 3/4" U.O.N.
	#4/0 COPPER GROUNDING ELECTRODE CONDUIT, U.O.N.
	MECHANICAL EQUIPMENT DESIGNATION - SEE MECHANICAL PLANS
	DETAIL DESIGNATION - SEE DETAIL 3, SHEET E-6
	NUMBERED SHEET NOTE
	UTILITY METER
	CURRENT TRANSFORMERS
	CIRCUIT BREAKER. NUMBER INDICATES 30A 3-POLE
	FEEDER SIZE - SEE POWER SINGLE LINE DIAGRAMS & FEEDER SCHEDULE
	AV OUTLET / DEVICE DESIGNATION. SEE AV DRAWINGS.

## ABBREVIATIONS

AFB	ABOVE FINISHED FLOOR
AFG	ABOVE FINISHED GRADE
C	CONDUIT
CATV	CABLE TV
CO	CONDUIT ONLY
CU	COPPER
EC	ELECTRICAL CONTRACTOR
E	EMERGENCY LIGHT FIXTURE ON EMERGENCY GENERATOR OR INVERTER, SWITCHABLE, U.O.N.
EMS	EMERGENCY LIGHT FIXTURE WITH BATTERY PACK, SWITCHABLE
EMS	ENERGY MANAGEMENT SYSTEM
(E)	EXISTING
EQPT	EQUIPMENT
(EXT)	EXISTING EQUIPMENT TO BE RELOCATED
(EX)	EXISTING EQUIPMENT TO BE DISCONNECTED AND REMOVED
EXT	EXTERIOR
FMC	FLEXIBLE METALLIC CONDUIT
FTL	FEED THROUGH LUGS
GFL	GROUND FAULT CIRCUIT INTERRUPTING TYPE RECEPTACLE
IDF	INTERMEDIATE DISTRIBUTION FRAME
L	LOCKABLE
LV	LOW VOLTAGE
MCB	MAIN CIRCUIT BREAKER
MDF	MAIN DISTRIBUTION FRAME
MFR	MANUFACTURER
MLO	MAIN LUGS ONLY
MLD	MOUNTED
(N)	NEW
N.E.C.	NATIONAL ELECTRICAL CODE
NEU	NEUTRAL
N.I.E.C.	NOT IN ELECTRICAL CONTRACT
O.A.H.	OVERALL HEIGHT
O.F.C.I.	OWNER FURNISHED, CONTRACTOR INSTALLED
P	INDICATES FIXTURES ON PHOTOCELL CONTROL
PA	PUBLIC ADDRESS
PNL	PANEL
S.A.D.	SEE ARCHITECTURAL DRAWINGS
STC	SIGNAL TERMINAL CABINET
TE	INDICATES FIXTURES ON TIMELOCK CONTROL
TEL	TELEPHONE
TVSS	TRANSIENT VOLTAGE SURGE SUPPRESSION
U.O.N.	UNLESS OTHERWISE NOTED
VAV	VAV BOX, SEE MECHANICAL DIVISION DRAWINGS FOR LOCATIONS. PROVIDE TOGGLE TYPE DISCONNECT SWITCH
WP	WEATHER PROOF, NEMA 3R
WPU	WEATHER PROOF WHILE IN USE

## SYMBOLS LIST

	MAIN SWITCHBOARD, DISTRIBUTION PANEL OR MOTOR CONTROL CENTER
	FLUSH MOUNTED PANELBOARD, 6'-6" TO TOP
	SURFACE MOUNTED PANELBOARD, 6'-6" TO TOP
	FUSED EQUIPMENT DISCONNECT SWITCH WITH FUSE SIZE AS RECOMMENDED BY EQUIPMENT MANUFACTURER
	MOTOR DISCONNECT SWITCH; HORSEPOWER RATED, NON FUSE
	COMBINATION MAGNETIC MOTOR STARTER & MOTOR CIRCUIT PROTECTOR
	MAGNETIC MOTOR STARTER
	VARIABLE FREQUENCY DRIVE, FURNISHED BY MECHANICAL, INSTALLED & CONNECTED COMPLETE BY ELECTRICAL
	MANUAL MOTOR STARTER WITH OVERLOAD PROTECTION
	MOTOR WITH FLEXIBLE CONDUIT CONNECTION AND DISCONNECT
	TRANSFORMER
	CONCRETE PULLBOX, SIZE AS REQUIRED OR SHOWN - CHRISTY OR EQUAL WITH LABELED LID PER USE
	COPPER GROUND ROD
	FLUSH CEILING MOUNTED JUNCTION BOX, U.O.N.
	FLUSH WALL MOUNTED JUNCTION BOX, UP 18" U.O.N.
	JUNCTION BOX FLUSH FLOOR MOUNTED
	20A 3PG 125V DUPLEX RECEPTACLE, UP 18" U.O.N.
	20A 3PG 125V DUPLEX RECEPTACLE, WEATHERPROOF, UP 18" U.O.N.
	20A 3PG 125V DUPLEX RECEPTACLE, GROUND FAULT CIRCUIT INTERRUPTER TYPE, UP 18" U.O.N.
	20A 3PG 125V DUPLEX RECEPTACLE, ISOLATED GROUND TYPE, UP 18" U.O.N.
	20A 3PG 125V DUPLEX RECEPTACLE, MOUNTED ABOVE COUNTER, U.O.N.
	20A 3PG 125V DOUBLE DUPLEX RECEPTACLE, MOUNTED ABOVE COUNTER, U.O.N.
	20A 3PG 125V SINGLE RECEPTACLE, UP 18" U.O.N.
	20A 3PG 125V SINGLE TWISTLOCK RECEPTACLE, NEMA LS-20R, UP 18" U.O.N.
	SPECIAL RECEPTACLE AS INDICATED ON PLANS
	CONTROLLED AND IDENTIFIED (SPLIT-WIRED) DUPLEX RECEPTACLE, WITH ONE HALF OF RECEPTACLE WIRE THROUGH LOCAL PLUG-LOAD CONTROLLER, UP 18" U.O.N.
	CONTROLLED DUPLEX RECEPTACLE WIRED THROUGH LOCAL PLUG-LOAD CONTROLLER, UP 18" U.O.N.
	FLUSH IN FLOOR OUTLET BOX WITH QUANTITY OF 20A 3PG 125V DUPLEX RECEPTACLES AS INDICATED ON PLANS
	FLUSH CEILING MTD. DUPLEX OUTLET, 20A 3PG
	SURFACE MOUNTED WIREHOLD RACEWAY WITH RECEPTACLES AS INDICATED ON PLANS
	TERMINAL MOUNTING BACKBOARD; 3/4" PLYWOOD, DIMENSIONS AS NOTED ON PLANS. PAINT TO MATCH ADJACENT WALL SURFACE, MAINTAINING UL FIRE LABEL VISIBLE
	COMBINED TELEPHONE/DATA OUTLET, UP 18" U.O.N.
	NUMBER INDICATES QUANTITY OF DATA OUTLET JACKS
	COMBINED VOICE/DATA OUTLET, MOUNTED ABOVE COUNTER U.O.N.
	INTERCOM HANDSET, UP 48" U.O.N.
	COMBINED VOICE/DATA OUTLET, CEILING MOUNTED
	WALL MOUNTED SIGNAL SYSTEM CLOCK, UP 96" U.O.N.
	WALL MOUNTED VIDEO OUTLET, UP 18" U.O.N.
	FLUSH WALL MOUNTED INDOOR PUBLIC ADDRESS SPEAKER, UP 96" U.O.N.
	FLUSH WALL MOUNTED OUTDOOR WEATHERPROOF PUBLIC ADDRESS SPEAKER
	FLUSH CEILING MOUNTED INDOOR PUBLIC ADDRESS SPEAKER
	FLUSH WALL MOUNTED INDOOR PUBLIC ADDRESS SPEAKER & SIGNAL SYSTEM CLOCK, UP 96" U.O.N.
	FIRE ALARM SYSTEM STROBE, UP 80" U.O.N. NUMBER ADJACENT INDICATES CANDELA VALUE FOR STROBE
	FIRE ALARM SYSTEM STROBE, CEILING MOUNTED. NUMBER ADJACENT INDICATES CANDELA VALUE FOR STROBE
	WEATHERPROOF FIRE ALARM SYSTEM HORN, UP 90" U.O.N.
	FIRE ALARM SYSTEM SPEAKER/STROBE, UP 80" U.O.N. NUMBER ADJACENT INDICATES CANDELA VALUE FOR STROBE
	FIRE ALARM SYSTEM SPEAKER/STROBE, CEILING MOUNTED. NUMBER ADJACENT INDICATES CANDELA VALUE FOR STROBE
	FIRE ALARM SYSTEM SPEAKER, UP 90" U.O.N.
	WEATHERPROOF FIRE ALARM SYSTEM SPEAKER, UP 90" U.O.N.
	FIRE ALARM SYSTEM SPEAKER, CEILING MOUNTED
	WALL MOUNTED ELECTROMAGNETIC DOOR HOLD-OPEN DEVICE, FURNISHED BY DIV. 8, INSTALLED & CONNECTED COMPLETE TO FIRE ALARM SYSTEM BY DIV. 28
	FIRE ALARM SYSTEM SPRINKLER FLOW SWITCH. PROVIDE MONITOR MODULE
	FIRE ALARM SYSTEM SPRINKLER VALVE SUPERVISORY SWITCH. PROVIDE MONITOR MODULE
	POST INDICATING VALVE
	SPRINKLER FLOW ALARM (PROVIDE BY SPRINKLER CONTRACTOR). CONNECT COMPLETE VIA WATER FLOW SWITCH AUX. CONTACTS
	FIRE ALARM SYSTEM SMOKE DETECTOR
	FIRE ALARM SYSTEM CEILING MOUNTED SMOKE DETECTOR PROGRAMMED FOR AUTOMATIC RECALL OF ELEVATOR
	FIRE ALARM SYSTEM HEAT DETECTOR
	FIRE ALARM SYSTEM HVAC DUCT MOUNTED SMOKE DETECTOR. COORDINATE WITH MECHANICAL FOR SUPPLY, INSTALL AND COMPLETE CONNECTION (INCLUDING CONTROL OF HVAC EQUIPMENT) - SEE SPECIFICATIONS
	FIRE ALARM SYSTEM MONITOR MODULE
	FIRE ALARM SYSTEM CONTROL MODULE
	FIRE ALARM SYSTEM RELAY MODULE
	FIRE ALARM SYSTEM CEILING MOUNTED CARBON MONOXIDE DETECTOR WITH SOUNDER BASE
	ROOM CONTROLLER
	PLUG LOAD ROOM CONTROLLER
	NETWORK BRIDGE
	MASTER WIRELESS BORDER ROUTER & NB - SWITCH IN NETWORK CABINET; SEE DETAILS FOR TYPE
	SECONDARY WIRELESS BORDER ROUTER
	ISOLATED RELAY INTERFACE
	EMERGENCY LIGHTING CONTROL MODULE
	OCCUPANCY SENSOR POWER PACK MOUNTED IN CONCEALED ACCESSIBLE LOCATION
	SEISMIC BRACING FOR PENDANT LUMINAIRE

### CALIFORNIA GREEN BUILDING STANDARDS COMPLIANCE

ALL EXTERIOR LUMINAIRES SPECIFIED IN THESE CONTRACT DOCUMENTS COMPLY WITH THE REQUIREMENTS OF THE CALIFORNIA ENERGY CODE AND THE CALIFORNIA GREEN BUILDING STANDARDS CODE, SECTION A5.106.8 LIGHT POLLUTION REDUCTION. EXTERIOR LUMINAIRES COMPLY WITH BACKLIGHT, UPLIGHT, AND GLARE (BUG) RATINGS AS DEFINED IN IESNA TM-15-11 AND BUG RATINGS DO NOT EXCEED THE MAXIMUM ALLOWABLE RATINGS FOR THIS PROJECT.

## SYMBOLS LIST

	INDICATES LUMINAIRE TYPE, SEE LUMINAIRE SCHEDULE
	RECESSED 2'x2', 2'x4' OR 1'x4' LUMINAIRE, FULLY LENSED
	RECESSED 2'x2', 2'x4' LUMINAIRE WITH DECORATIVE ARTICULATED OPTICAL SHIELD
	INDICATES EMERGENCY LUMINAIRE. SEE ABBREVIATIONS FOR TYPE OF EMERGENCY SOURCE
	SUSPENDED LINEAR LUMINAIRE
	INDICATES AIRCRAFT CABLE SUPPORT POINT (VERIFY WITH MANUFACTURER)
	INDICATES COMBINATION AIRCRAFT CABLE/ELECTRICAL FEED POINT (VERIFY WITH MANUFACTURER)
	SURFACE CEILING, WALL OR COVE MOUNTED LUMINAIRE
	UNDER CABINET LUMINAIRE
	SURFACE OR SUSPENDED STRIP LUMINAIRE
	SURFACE CEILING MOUNTED LUMINAIRE
	PENDANT MOUNTED LUMINAIRE
	DECORATIVE CEILING MOUNTED LUMINAIRE
	SURFACE MOUNTED LIGHTING TRACK WITH TRACK LUMINAIRES
	RECESSED ADJUSTABLE ACCENT LUMINAIRE. ARROW INDICATES AIMING DIRECTION
	RECESSED DOWNLIGHT LUMINAIRE
	RECESSED WALLWASH LUMINAIRE
	RECESSED OR SURFACE MOUNTED LINEAR WALLWASHER, OPEN AREA INDICATES DIRECTION OF ILLUMINATION
	RECESSED DOWNLIGHT WITH DECORATIVE TRIM
	WALL MOUNTED LUMINAIRE
	STEPLIGHT RECESSED FLUSH IN WALL
	POLE ARM-MOUNTED AREA LUMINAIRE; ARROW INDICATES DIRECTION OF LIGHT DISTRIBUTION WHEN NOT PARALLEL TO ARM ORIENTATION
	POLE ARM-MOUNTED PEDESTRIAN-SCALE WALKWAY OR AREA LUMINAIRE; ARROW INDICATES DIRECTION OF LIGHT DISTRIBUTION
	POST-TOP PEDESTRIAN-SCALE AREA LUMINAIRE; ARROW INDICATES DIRECTION OF LIGHT DISTRIBUTION
	BOLLARD LUMINAIRE; ARROW INDICATES DIRECTION OF LIGHT DISTRIBUTION
	FLUSH IN-GROUND LANDSCAPE OR BUILDING UPLIGHT, NON-ADJUSTABLE AIMING
	FLUSH IN-GROUND LANDSCAPE OR BUILDING UPLIGHT WITH ADJUSTABLE AIMING FEATURE; ARROW INDICATES AIMING DIRECTION
	FLUSH IN-GROUND WALLWASH UPLIGHT; OPEN AREA INDICATES DIRECTION OF ILLUMINATION
	STEM MOUNTED SIGN LIGHT
	WALL MOUNTED EXIT SIGN, ARROWS AS NOTED ON PLANS. SHADED AREA INDICATES NUMBER OF FACES
	CEILING MOUNTED EXIT SIGN, ARROWS AS NOTED ON PLANS. SHADED AREA INDICATES NUMBER OF FACES
	LOW LEVEL WALL MOUNTED EXIT SIGN
	WALL MOUNTED EMERGENCY BATTERY EGRESS LUMINAIRE WITH NUMBER OF ADJUSTABLE LAMP HEADS INDICATED
	LINE VOLTAGE SINGLE POLE TOGGLE SWITCH, LETTER ADJACENT INDICATES RESPECTIVE ZONE CONTROLLED, UP 48" U.O.N.
	LINE VOLTAGE TWO POLE TOGGLE SWITCH, UP 96" U.O.N.
	LINE VOLTAGE THREE-WAY TOGGLE SWITCH, UP 48" U.O.N.
	LINE VOLTAGE KEY OPERATED TOGGLE SWITCH
	LINE VOLTAGE MOTOR RATED TOGGLE SWITCH INSTALLED AT EQPT SHOWN
	LINE VOLTAGE TOGGLE SWITCH WITH PILOT LIGHT, LIGHT IS ON WHEN CIRCUIT IS CLOSED, UP 48" U.O.N.
	LOW VOLTAGE MOMENTARY CONTACT SWITCH - SEE LOW VOLTAGE RELAY SCHEDULE, LOWER CASE LETTER ADJACENT INDICATES RESPECTIVE ZONE CONTROLLED, UP 48" U.O.N.
	LOW VOLTAGE KEYED MOMENTARY CONTACT SWITCH - SEE LOW VOLTAGE RELAY SCHEDULE, LOWER CASE LETTER ADJACENT INDICATES RESPECTIVE ZONE CONTROLLED, UP 48" U.O.N.
	WALL MOUNTED SWITCH TYPE INFRARED OCCUPANCY SENSOR; UP 48" U.O.N.; SINGLE OR DUAL AS NOTED BY LETTERS ADJACENT. SET TO FIXED 20 MINUTE TIME DELAY AND MAX SENSITIVITY
	WALL MOUNTED SWITCH TYPE INFRARED OCCUPANCY SENSOR; UP 48" U.O.N.; SINGLE OR DUAL AS NOTED BY LETTERS ADJACENT. SET TO FIXED 20 MINUTE TIME DELAY AND MAX SENSITIVITY
	WALL MOUNTED DIGITAL DUAL TECHNOLOGY DIMMING OCCUPANCY SENSOR SWITCH; UP 48" U.O.N.
	WALL MOUNTED DIGITAL SWITCH, UP 48" U.O.N.; LOWER CASE LETTER ADJACENT INDICATES RESPECTIVE ZONE CONTROLLED
	WALL MOUNTED SINGLE OR MULTI-ZONE DIGITAL DIMMER SWITCH, UP 48" U.O.N.; LOWER CASE LETTERS ADJACENT INDICATE RESPECTIVE ZONES TO BE SIMULTANEOUSLY MANUALLY CONTROLLED; NUMERAL DESIGNATES NUMBER OF ZONES ASSIGNED TO THE DEVICE
	CEILING MOUNTED DUAL TECHNOLOGY DIGITAL OCCUPANCY SENSOR
	WALL MOUNTED DUAL TECHNOLOGY DIGITAL OCCUPANCY SENSOR
	LOW VOLTAGE COLD TEMPERATURE PIR OCCUPANCY SENSOR
	CEILING MOUNTED LINE VOLTAGE DUAL TECHNOLOGY OCCUPANCY SENSOR
	SINGLE OR MULTI-ZONE SWITCHING OR DIMMING OPEN LOOP DIGITAL DAYLIGHTING SENSOR; NOTATIONS ADJACENT IDENTIFY DAYLIGHT ZONES ASSIGNED TO THE DEVICE. VERIFY EXACT LOCATION PRIOR TO ROUGH-IN
	SINGLE ZONE SWITCHING OR DIMMING CLOSED LOOP DIGITAL DAYLIGHTING SENSOR; NOTATIONS ADJACENT IDENTIFY DAYLIGHT ZONES ASSIGNED TO THE DEVICE. VERIFY EXACT LOCATION PRIOR TO ROUGH-IN
	DAYLIGHT CONTROL PHOTOCELL - BRACKET MOUNTED; NOTATIONS ADJACENT IDENTIFY DAYLIGHT ZONES ASSIGNED TO THE DEVICE. VERIFY EXACT LOCATION PRIOR TO ROUGH-IN
	ROOM CONTROLLER
	ADJACENT NUMERAL REFERS TO THE NUMBER OF ZONES TO BE CONTROLLED. VENDOR OR CONTRACTOR TO PROVIDE QUANTITY OF ROOM CONTROLLERS REQUIRED FOR THE NUMBER OF CONTROLLED ZONES.
	PLUG LOAD ROOM CONTROLLER
	NETWORK BRIDGE
	MASTER WIRELESS BORDER ROUTER & NB - SWITCH IN NETWORK CABINET; SEE DETAILS FOR TYPE
	SECONDARY WIRELESS BORDER ROUTER
	ISOLATED RELAY INTERFACE
	EMERGENCY LIGHTING CONTROL MODULE
	OCCUPANCY SENSOR POWER PACK MOUNTED IN CONCEALED ACCESSIBLE LOCATION
	SEISMIC BRACING FOR PENDANT LUMINAIRE

### CALIFORNIA GREEN BUILDING STANDARDS COMPLIANCE

ALL EXTERIOR LUMINAIRES SPECIFIED IN THESE CONTRACT DOCUMENTS COMPLY WITH THE REQUIREMENTS OF THE CALIFORNIA ENERGY CODE AND THE CALIFORNIA GREEN BUILDING STANDARDS CODE, SECTION A5.106.8 LIGHT POLLUTION REDUCTION. EXTERIOR LUMINAIRES COMPLY WITH BACKLIGHT, UPLIGHT, AND GLARE (BUG) RATINGS AS DEFINED IN IESNA TM-15-11 AND BUG RAT




LUMINAIRE SCHEDULE

TYPE	MOUNTING	DESCRIPTION	MANUFACTURER CATALOG #	LIGHT SOURCE	POWER SUPPLY	VOLTS	INPUT WATTS	REMARKS
BC1	SURFACE WALL MOUNTED	DECORATIVE EXTERIOR DOWNLIGHT WALL SCONCE SIMILAR TO TYPE BA1 ABOVE, BUT WITH LARGER HOUSING, HIGHER OUTPUT, IES TYPE II DISTRIBUTION PATTERN WITH FULL CUTOFF, INTEGRAL ELECTRONIC DRIVER, PREMIUM FINISH AS SELECTED BY THE ARCHITECT, UL WET LOCATION.	AAL #CY2-45-3K8-1-2-120-(FINISH)-T-FPP	LED 3000K 80+ CRI 4100LM	INTEGRAL ELECTRONIC LED DRIVER	UNIV.	50	1) VERIFY MOUNTING HEIGHT WITH THE ARCHITECT, PRIOR TO ROUGH-IN. 2) COORDINATE PROVISION OF BLOCKING IN WALL TO PREVENT 'SAGGING' AFTER INSTALLATION.
BC2	SURFCE WALL MOUNTED	SAME AS BC1, EXCEPT REDUCED OUTPUT, 'DIFFUSED' TYPE III DISTRIBUTION PATTERN.	AAL #CY2-25-3K8-1-3D-120-(FINISH)-T-FPP	LED 3000K 80+ CRI 4100LM	INTEGRAL ELECTRONIC LED DRIVER	UNIV.	25	ALL REMARKS LISTED ABOVE FOR TYPE 'BC1' APPLY TO TYPE 'BC2' LUMINAIRES.
BC3	SURFACE WALL MOUNTED	SAME AS BC1, EXCEPT REDUCED OUTPUT, TYPE III DISTRIBUTION PATTERN.	AAL #CY2-25-3K8-1-2-120-(FINISH)-T-FPP	LED 3000K 80+ CRI 4100LM	INTEGRAL ELECTRONIC LED DRIVER	UNIV.	25	ALL REMARKS LISTED ABOVE FOR TYPE 'BC1' APPLY TO TYPE 'BC3' LUMINAIRES.
EX1	SURFACE WALL	SINGLE-FACE EDGELIT LED EXIT SIGN FIXTURE, WITH GREEN STENCIL LETTERS, DIECAST ALUMINUM HOUSING, UNIVERSAL CANOPY FOR BACK/END OR TOP MOUNTING, ARROWS AS INDICATED ON THE PLANS. FINISH TO BE DETERMINED BY THE ARCHITECT. WEIGHT	EVENLIGHT #RZR3-AC-G-1-BA-1B-RS	GREEN LED	INTEGRAL ELECTRONIC LED POWER SUPPLY	UNIV.	2	

LUMINAIRE SCHEDULE

TYPE	MOUNTING	DESCRIPTION	MANUFACTURER CATALOG #	LIGHT SOURCE	POWER SUPPLY	VOLTS	INPUT WATTS	REMARKS
AA1	PENDANT SUSPENDED	PENDANT MOUNTED LED HIGH BAY LUMINAIRE, WITH NOM. 20" DIA x 5"H BOROSCILLICATE GLASS, MEDIUM-SPREAD, PRISMATIC REFRACTOR / REFLECTOR, DIECAST ALUMINUM DRIVER HOUSING W/STANDARD FINISH AS SELECTED BY THE ARCHITECT. CUSTOM-LENGTH, 5-WIRE, POWER/CONTROL S.O. TYPE FEED CORD, CONTRACTOR-PROVIDED BRAIDED S.S. AIRCRAFT SAFETY CABLE, IN LIEU OF FACTORY-STANDARD SAFETY CHAIN, ANTI-ROTATIONAL SAFETY HOOK, WIREGUARD, INTEGRAL ELECTRONIC DIMMING DRIVER, STANDARD FINISH AS SELECTED BY THE ARCHITECT. WIRE GUARD OPTION; SEISMIC BRACING PROVIDED AT UNITS NOT FREE TO SWAY 45 DEG. IN ALL DIRECTIONS WITHOUT OBSTRUCTION (INCLUDING ADJACENT SWAYING UNITS); CONTRACTOR-SUPPLIED & INSTALLED R.S.C. STEM, OUTLET BOX, & MISC. HARDWARE SHALL BE FIELD PAINTED AS DIRECTED BY THE ARCHITECT.	ACUITY BRANDS / HOLOPHANE: #PHG-15L-35K80CRI-AS-(FINISH)-MGG-PF 129-CW5/6-WG- C6" *HARDWARE ONLY, FOR CONTACTOR-SUPPLIED S.S. BRAIDED AIRCRAFT SAFETY CABLE	LED 3500K 80 CRI 13,416 LM	INTEGRAL ELECTRONIC LED DIMMING DRIVER 0-10V, 100%-10%	UNIV.	113	1) SEE DETAIL ON SHEET E-7.2 FOR MOUNTING. 2) SEISMIC BRACING INDICATED TO BE PROVIDED AT UNITS NOT FREE TO SWAY 45 DEG. IN ALL DIRECTIONS WITHOUT OBSTRUCTION. 3) CONTRACTOR-PROVIDED, FIELD CUT & THREADED R.S.C. STEM, OUTLET BOX, & MISC. MOUNTING / BRACING HARDWARE SHALL BE FIELD PAINTED AS DIRECTED BY THE ARCHITECT. 4) FIELD-VERIFY POWER & CONTROL DROP CORD LENGTHS REQUIRED FOR EACH LUMINAIRE, PRIOR TO RELEASE OF ORDER 5) PROVIDE ALL 'AA'-SERIES LUMINAIRE WITH FACTORY FITTINGS AS REQUIRED TO ALLOW PROPER INSTALLATION OF CONTRACTOR-SUPPLIED S.S. AIRCRAFT SAFETY CABLE.
AA2	PENDANT SUSPENDED	SAME AS 'AA1', EXCEPT NARROW BEAM PATTERN GLASS REFLECTOR & REFRACTOR OPTICS,	ACUITY BRANDS / HOLOPHANE: #PHG 15L-35K80CRI-AS-(FINISH)-NGG-PF129-CW5/6-WG- C6" *HARDWARE ONLY, FOR CONTACTOR-SUPPLIED S.S. BRAIDED AIRCRAFT SAFETY CABLE	LED 3500K 80 CRI 13,416 LM	INTEGRAL ELECTRONIC LED DIMMING DRIVER 0-10V, 100%-10%	UNIV.	113	ALL REMARKS LISTED ABOVE FOR TYPE 'AA1' APPLY TO TYPE 'AA2' LUMINAIRES.
AA3	PENDANT SUSPENDED	SAME AS 'AA1', EXCEPT REDUCED OUTPUT AND WATTAGE,	ACUITY BRANDS / HOLOPHANE: #PHG 9L-35K80CRI-AS-(FINISH)-MGG-PF129-CW5/6-WG- C6" *HARDWARE ONLY, FOR CONTACTOR-SUPPLIED S.S. BRAIDED AIRCRAFT SAFETY CABLE	LED 3500K 80 CRI 8,590 LM	INTEGRAL ELECTRONIC LED DIMMING DRIVER 0-10V, 100%-10%	UNIV.	71	ALL REMARKS LISTED ABOVE FOR TYPE 'AA1' APPLY TO TYPE 'AA3' LUMINAIRES.
AB1	S.S. AIRCRAFT CABLE SUSPENDED	SUSPENDED LINEAR LED DIRECT/INDIRECT LUMINAIRE ASSEMBLY, WITH NOM. 2"W x 4"H x 32"L EXTRUDED ALUMINUM HOUSING, 'BOOSTED' DOWN / 'HIGH UP' OUTPUTS, STANDARD FLAT ACRYLIC DOWNLIGHT DIFFUSER, WIDE-SPREAD UPLIGHT OPTICS, INTEGRAL ELECTRONIC DIMMING DRIVERS, 2-CIRCUIT CONFIGURATION - WITH SEPARATE HOT/NEUTRAL & CONTROL CONDUCTOR(S) DROP CORD PROVIDED FOR ALL DOWNLIGHT DIODES IN (1) 4FT LONG END SECTION; ALL REMAINING UP & DOWN DIODES CONNECTED TO SECOND (SEP. NEUTRAL) CIRCUIT FEED DROP CORD; STANDARD FINISH AS SELECTED BY THE ARCHITECT	FINELITE #HP2P-P-ID-32"-H/B-8 35-WSO-BG-96LG-(VOLTAGE)-DC-FC/10%-FA50-C1(VERIFY)-SW-EM/GEN	LED 3500K 90+ CRI 1207LM/FT	0-10V, 100%-10% DIMMING	UNIV.	11.5W/LF	
AB2	S.S. AIRCRAFT CABLE SUSPENDED	SAME AS 'AB1', EXCEPT MULTI-CIRCUIT CONTROL PROVISIONS: (3) NORMAL POWER CONTROL GROUPS; (2) - AUTO-DAYLIGHT DIMMED UP & DOWN SECTIONS AS SHOWN, (1) FOR MANUAL DIMMED UPLIGHT ONLY @ 4FT EMERGENCY SECTION INDICATED), AND: (1) - EMERGENCY INVERTER POWERED 4FT DOWNLIGHT DIODE SECTION INDICATED, NORMALLY MANUALLY DIMMED WITH ALL OTHER SECTIONS / AUTO 'FULL-ON' UPON FAILURE OF UTILITY POWERVIA UL924 CONTROL MODULE. SEE PLANS FOR EXACT CONFIGURATION OF CONTROL ZONES REQUIRED4.	FINELITE #HP2P-P-ID-32"-H/B-8 35-WSO-BG-96LG-(VOLTAGE)-MC/4-FC/10%-FA50-C1(VERIFY)-SW-EM/GEN	LED 3500K 90+ CRI 1207LM/FT	0-10V, 100%-10% DIMMING	UNIV.	11.5W/FT	1) VERIFY MOUNTING HEIGHT WITH THE ARCHITECT, PRIOR TO ROUGH-IN. 2) COORDINATE PROVISION OF BLOCKING IN WALL TO PREVENT 'SAGGING' AFTER INSTALLATION.
AC1	SURFACE WALL MOUNTED OVER MIRRORS	8'L x 3'H x 3" D LINEAR LED OVER-MIRROR UNIT, WITH EXTRUDED ALUMINUM HOUSING, DECORATIVE ENDCAPS, INTEGRAL ELECTRONIC DIMMING DRIVER, DECORATIVE JUNCTION BOX COVERPLATE, RAL FINISH AS SELECTED BY THE ARCHITECT.	PRIMUS #ALX1-RLR-LED-H-35-SM/JP-AEB-C-8'	LED 3500K 85 CRI 1220LM/FT	0-10V, 100%-10% DIMMING	UNIV.	11.5W/LF	
AD1	SURFACE MOUNTED	2" H x 2 3/4" W x 8" L LED 'STRIPLIGHT', WITH 22 GAUGE DIE FORMED C.R.S. HOUSING W/ WHITE POLYESTER POWDER COAT 'PAINTED AFTER FABRICATION' FINISH, 'ROUNDED HIGH STRENGTH DR ACRYLIC 'WRAP-AROUND' DIFFUSER, INTEGRAL NON-DIMMING ELECTRONIC DRIVER,	WILLIAMS #75R-8-L130-835-WG-75-RA-75	LED 3500K 80+ CRI 13000LM	INTEGRAL ELECTRONIC LED DIMMING DRIVER 0-10V, 100%-10%	120	88	
AD2	SURFACE MOUNTED	SAME AS AD1, EXCEPT 4' L, MOUNTED IN CONTINUOUS ROW WITH 4' AD1 UNIT.	WILLIAMS #75R-4-L65-835-WG-75-RA-75	LED 3500K 80+ CRI 6500 LM	INTEGRAL ELECTRONIC LED DIMMING DRIVER 0-10V, 100%-10%	120	42	
AF1	SURFACE MOUNTED	DECORATIVE CEILING MOUNTED LED 'DRUM' DOWNLIGHT, WITH PRESSED WHITE GLASS DIFFUSER, DIE-CAST ALUMINUM HOUSING AND TRIM. PAINTED GR-94 METALLIC HOUSING AND TRIM. 15.62" DIAMETER 3.62" DEEP. FINISH: STANDARD TEXTURED WHITE.	PERFORMANCE in LIGHTING #71434	LED 3500K 80+ CRI 2740LM	INTEGRAL ELECTRONIC LED DIMMING DRIVER 0-10V, 100%-10%	120	40	
AG1	RECESSED	2' L x 2' W x 2" D RECESSED LED TROFFER DOWNLIGHT UNIT WITH ANGLED EDGELIT ACRYLIC DIFFUSING PANELS, DECORATIVE CENTER JOINER BAND, INTEGRAL ELECTRONIC DIMMING DRIVER.	COLUMBIA #VSY22-35-MLHE-G-ED-U	LED 3500K 80+ CRI 3280LM	INTEGRAL ELECTRONIC LED DIMMING DRIVER 0-10V, 100%-10%	UNIV.	24	
BA1	SURFACE WALL MOUNTED	DECORATIVE EXTERIOR DOWNLIGHT WALL SCONCE WITH FORMED ALUMINUM BODY AND DECORATIVE 'TRIANGULAR WEDGE' SHROUD, IES TYPE III DISTRIBUTION PATTERN WITH FULL CUTOFF, INTEGRAL ELECTRONIC DRIVER, PREMIUM FINISH AS SELECTED BY THE ARCHITECT, UL WET LOCATION LISTED.	AAL #CY1-25-3K8-1-3D-120-(FINISH)-T-FPP	LED 3000K 80+ CRI 2200LM	INTEGRAL ELECTRONIC LED DRIVER	UNIV.	25	1) VERIFY MOUNTING HEIGHT WITH THE ARCHITECT, PRIOR TO ROUGH-IN. 2) COORDINATE PROVISION OF BLOCKING IN WALL TO PREVENT 'SAGGING' AFTER INSTALLATION.
BB1	CEILING RECESSED	RECESSED LED WALL-WASH UNIT WITH FORMED ALUMINUM HOUSING, 6"DIA CLEAR ALZAK ALUMINUM REFLECTOR, ANGLED PRISMATIC GLASS SPREAD LENS, INTEGRAL ELECTRONIC DIMMING DRIVER, MODIFIED FOR EXTRA THICK EXTERIOR SOFFIT, UL WET LOCATION LISTED.	KIRLIN #LRR-06425-2500L-120-30K-99 (DEEP TRIM FOR THICK SOFFIT)	LED 3000K 80+ CRI 2780LM	INTEGRAL ELECTRONIC LED DIMMING DRIVER 0-10V, 100%-10%	120	35	

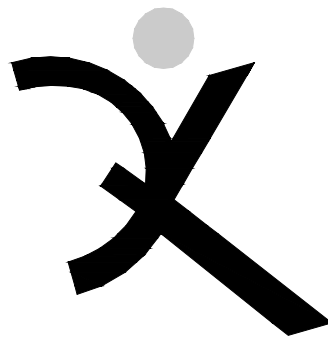

QUATTROCCHI KWOK  
ARCHITECTS  
Main Office:  
636 Fifth Street, Santa Rosa, CA 95404  
East Bay:  
55 Harrison Street, Suite 525  
Oakland, CA 94607  
(707) 576-0829



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ARCHITECTS, ENGINEERS AND INTERIOR DESIGNERS  
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SAN RAFAEL, CALIFORNIA 94903  
(415) 492-0800 / FAX (415) 492-0666  
www.omconsulting.com  
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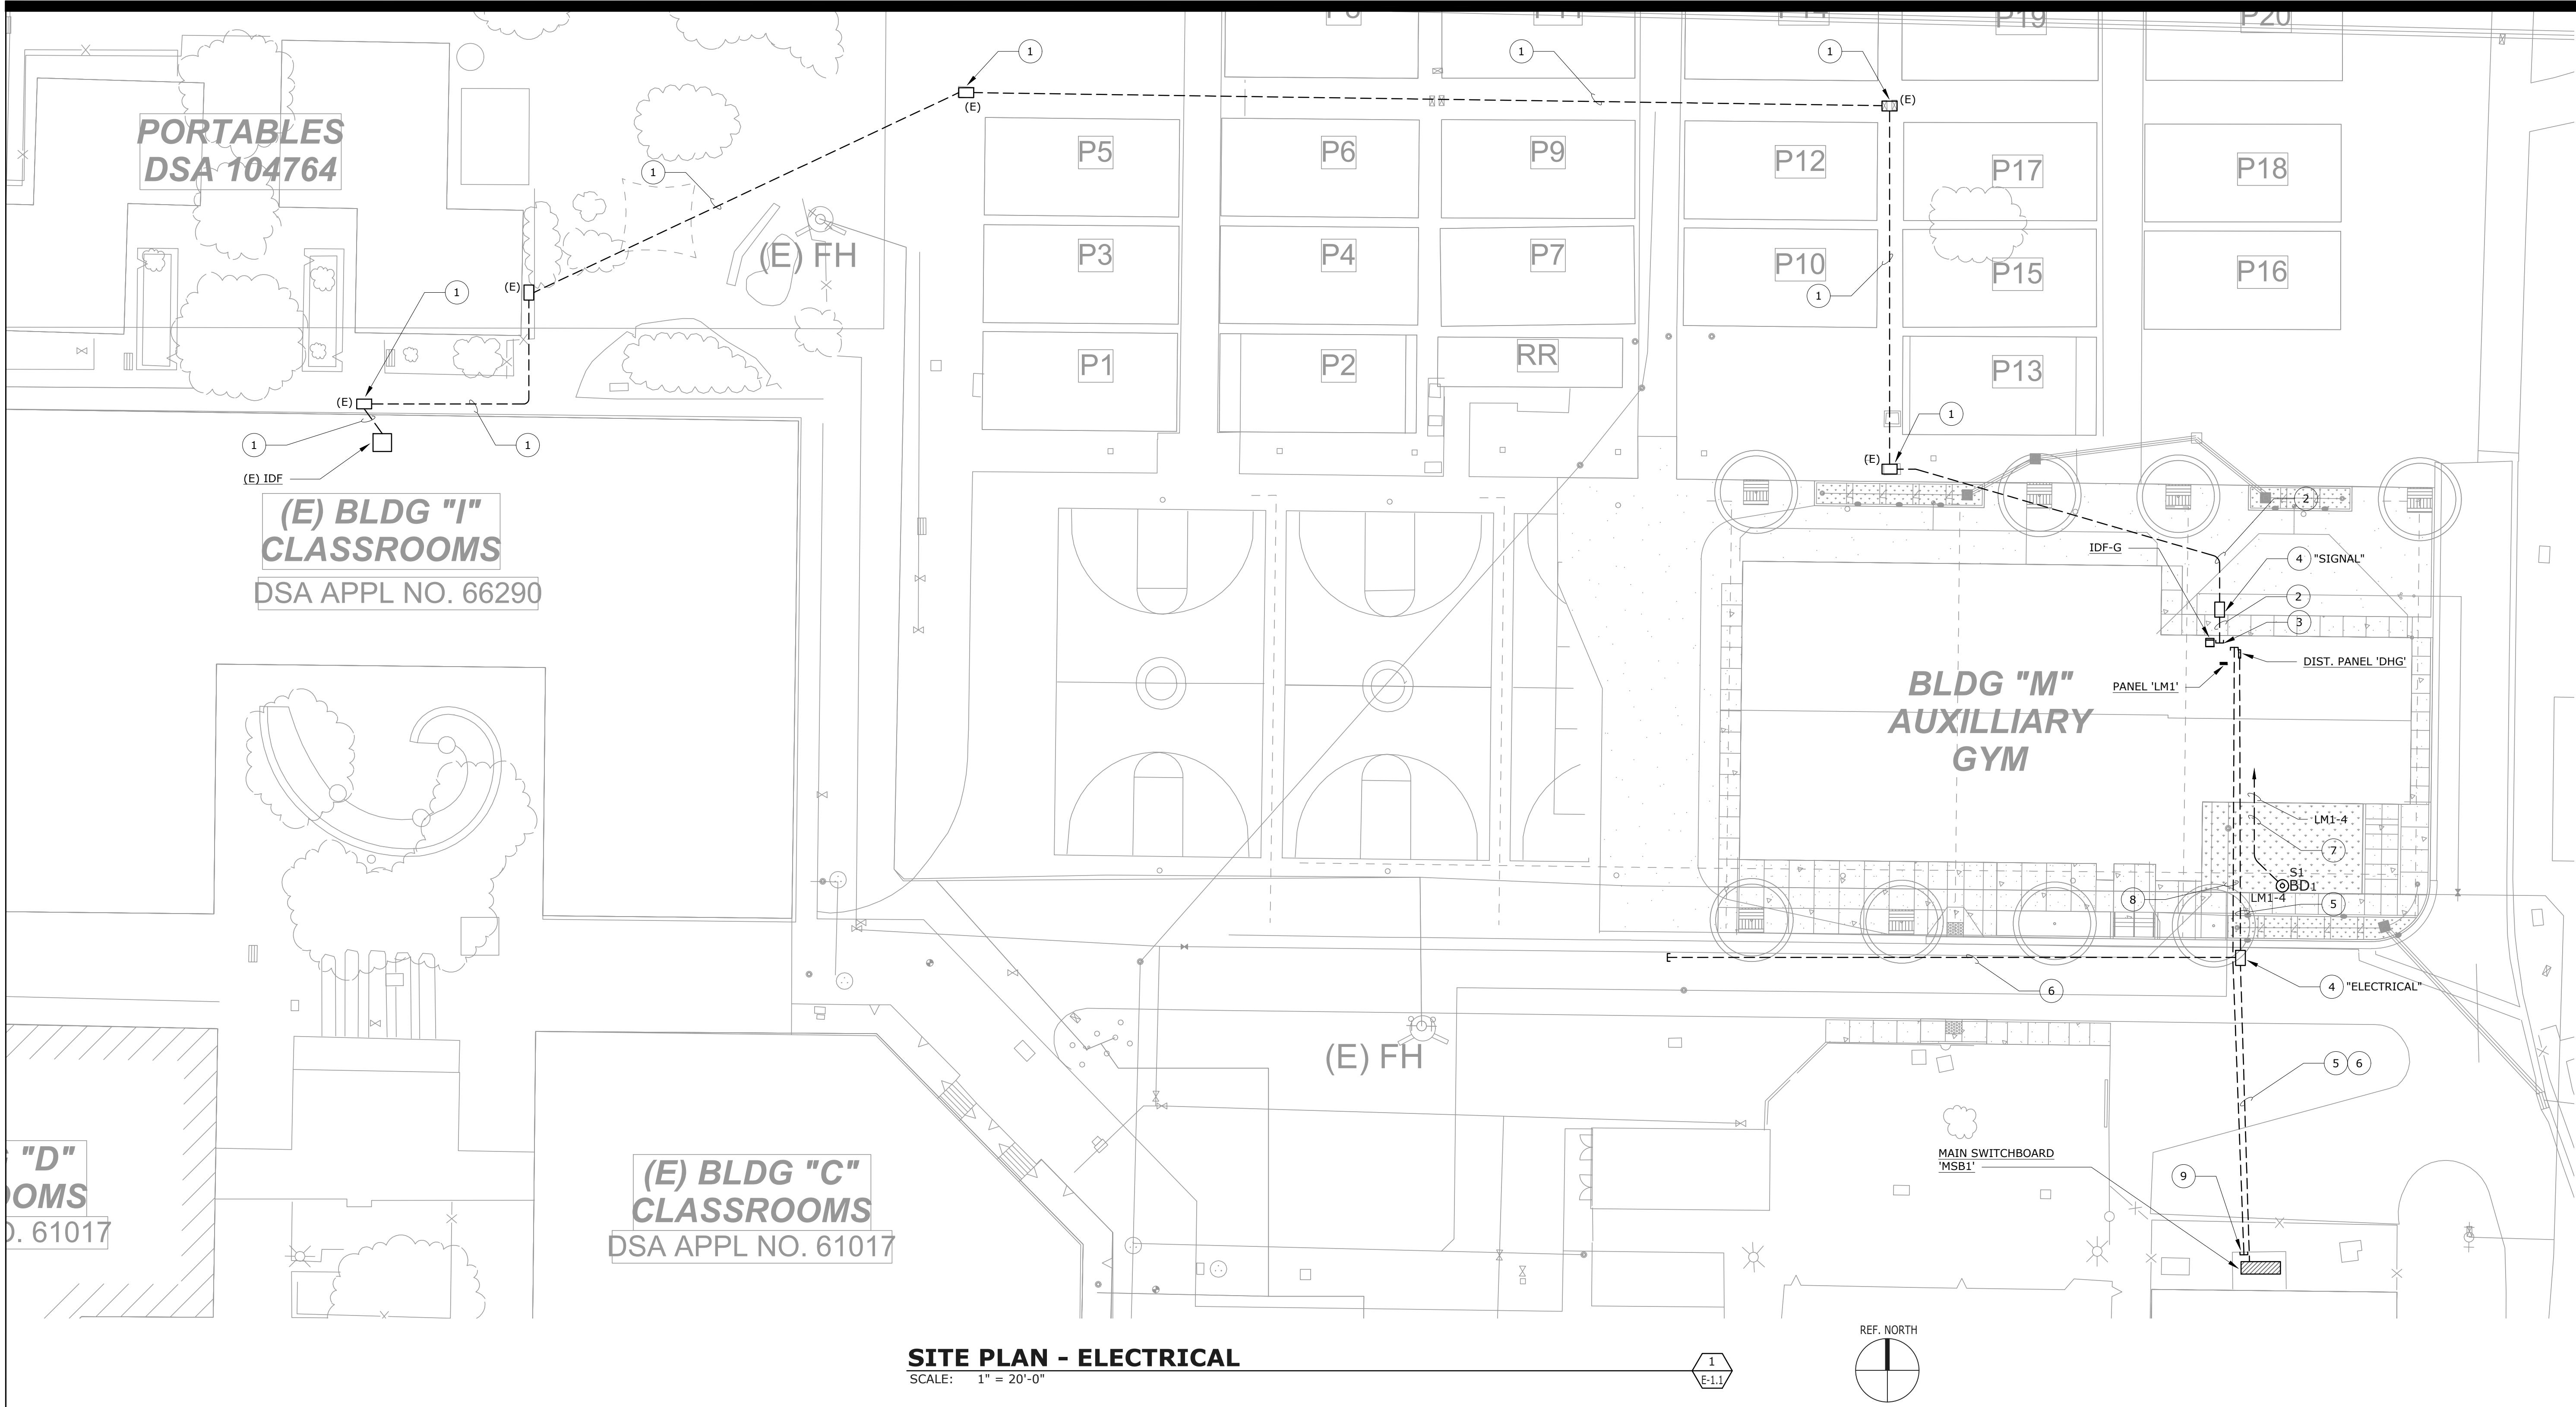
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LUMINAIRE  
SCHEDULE

SHEET NUMBER

E-0.2






NUMBERED SHEET NOTES	
7	ROUTE ALL EXTERIOR LIGHTING CIRCUITS HOME VIA BMS-CONTROLLED RELAY CONTRACTS LOCATED IN ELECTRIC ROOM. RELAY CONTRACTS AND BYPASS SWITCHES TO BE PROVIDED BY DIVISION 23. TYPICAL ALL EXTERIOR BUILDING-MOUNTED AND POLE-MOUNTED LUMINAIRES. SEE DETAIL 5/E-5.3.
8	PROVIDE AND INSTALL 2" UNDERGROUND SCHEDULE 40 PVC RACEWAY ONLY FOR FUTURE PV SYSTEM CONNECTION TO (E) MSB. STUB UP IN ELEC 109, DIRECTLY UNDER LOCATION RESERVED FOR FUTURE PV SYSTEM DISCONNECT SWITCH. SEE E-3.1.
9	STUB, CAP AND MARK RACEWAY FOR FUTURE PV SYSTEM IN FRONT OF (E) MSB, AT THE END OF THE DISTRIBUTION SECTION THAT IS THE FURTHEST DISTANCE FROM WHERE THE (E) MSB BUS RECEIVES ITS SUPPLY. SEE E-5.1 AND 9/E-7.1.


NUMBERED SHEET NOTES	
1	ROUTE (N) SIGNAL CABLING IN AVAILABLE (E) PULLBOXES AND UNDERGROUND RACEWAY. INCLUDE SUFFICIENT LABOR IN BID TO INVESTIGATE THE (E) CONDUIT ROUTE FROM (E) IDF TO (N) AUXILIARY GYM IDF-G. SEE E-5.2 FOR CABLE QUANTITIES AND TYPES.
2	PROVIDE AND INSTALL UNDERGROUND SCHEDULE 40 PVC RACEWAY AS FOLLOWS: (1) 4" C. - FIBER OPTIC (TELECOM, CLOCK/SPEAKER) - SEE 2/E-5.2. (1) 2" C. - SPARE - STUB CONDUIT AT BACKBOARD.
3	STUB RACEWAY INTO ELEC 109, ADJACENT TO IDF-G.
4	PROVIDE AND INSTALL FLUSH, IN-GRADE PULLBOX, CHRISTY (OR EQUAL), WITH COVER LABELED AS NOTED ON PLAN. PULLBOX SHALL BE "TRAFFIC RATED" REINFORCED CONCRETE WITH STEEL FRAME AND STEEL COVER. SIZE PULLBOX PER NEC. SEE 2/E-7.2.
5	PROVIDE AND INSTALL UNDERGROUND SCHEDULE 40 PVC RACEWAY. SEE E-5.1 FOR CONDUIT AND CONDUCTOR SIZES.
6	PROVIDE AND INSTALL (2) 4" UNDERGROUND SCHEDULE 40 PVC RACEWAY TO SERVE FUTURE CONSTRUCTION. STUB OUT, CAP AND MARK AS SHOWN. SEE 9/E-7.1.



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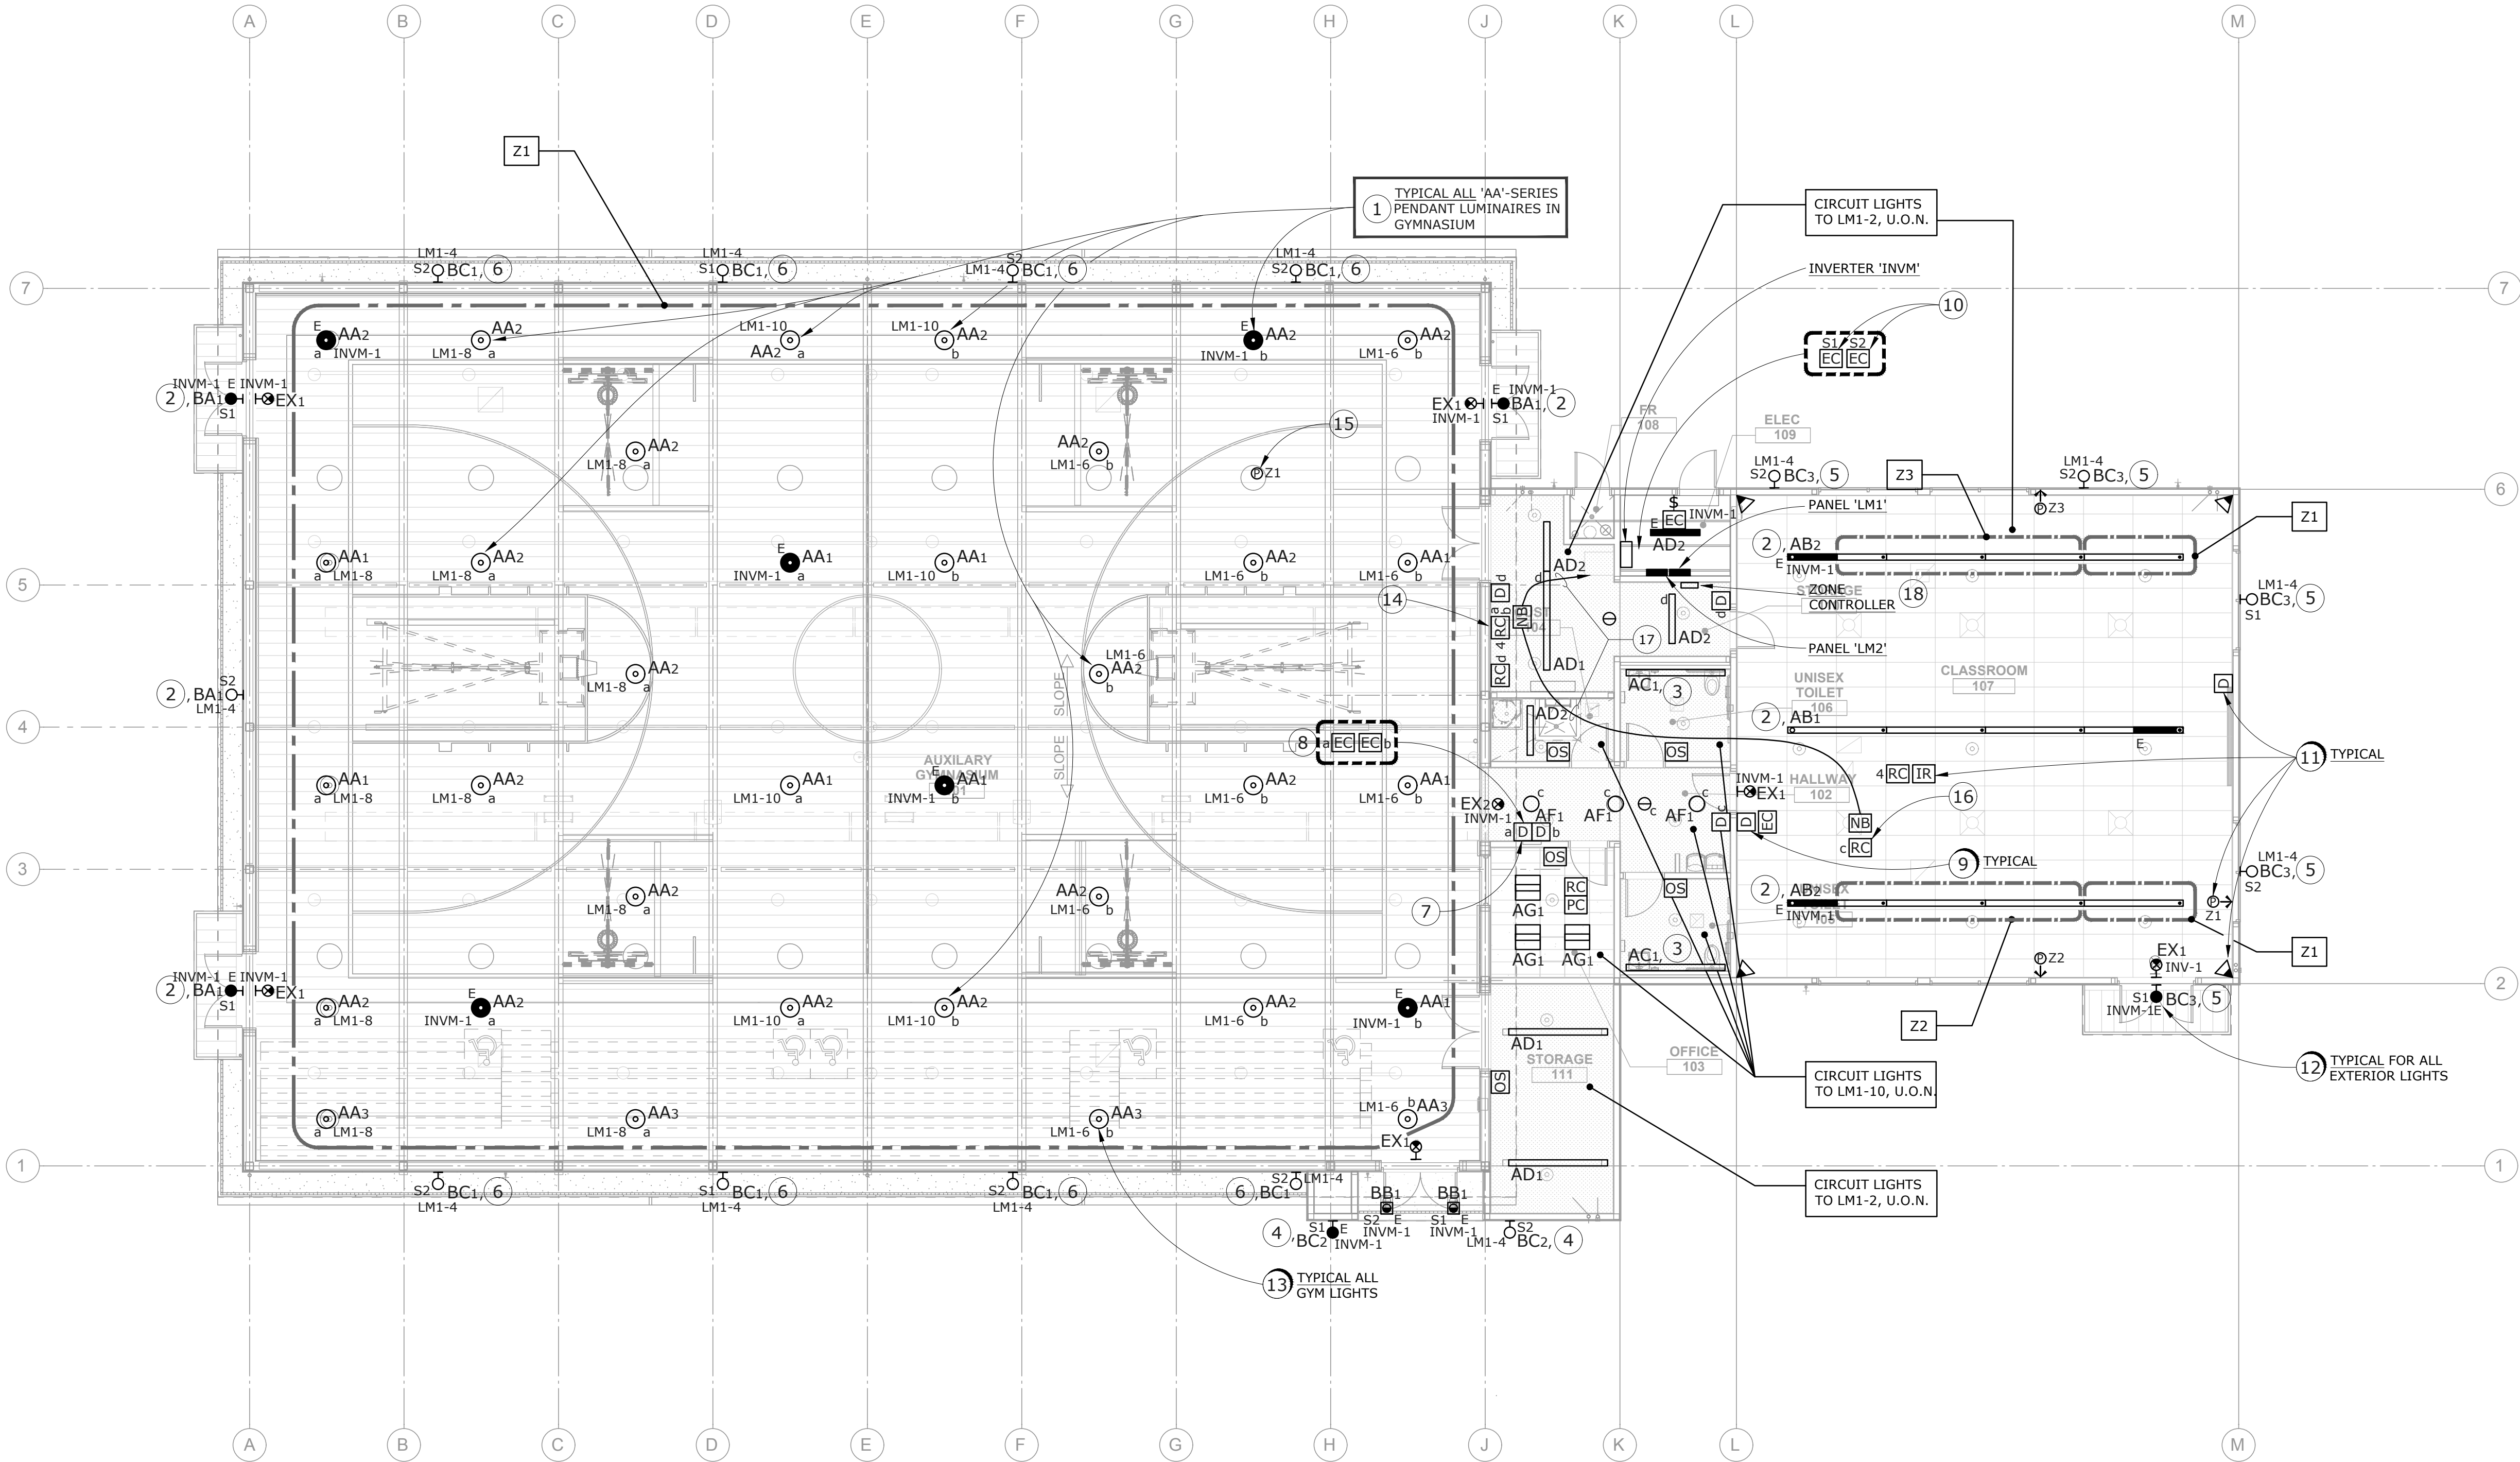
SHEET TITLE

**SITE PLAN -  
ELECTRICAL**

SHEET NUMBER

**E-1.1**





**FLOOR PLAN - LIGHTING**  
SCALE: 1/8" = 1'-0"

NUMBERED SHEET NOTES

- 1 BOTTOMS OF ALL 'AA' - SERIES SUSPENDED GYM LUMINAIRES TO ALIGN WITH BOTTOM OF LOWER TRUSS CHORDS; VERIFY EXACT STEM LENGTH REQUIRED FOR EACH UNIT AT LOCATIONS INDICATED, AND ORDER FACTORY - SUPPLIED POWER & CONTROL CONDUCTOR LEADS IN LENGTHS AS REQUIRED. SEE MOUNTING DETAIL 1/E-7.
- 2 MOUNT ALL EXTERIOR WALL MOUNTED 'BA' - SERIES LUMINAIRES AT +8'-3" A.F.F., TO BOTTOM OF LUMINAIRE.
- 3 MOUNT ALL 'AC1' UNITS IN RESTROOMS AT +3" ABOVE TOP OF MIRROR TO BOTTOM OF LUMINAIRE, PROVIDE POWER SUPPLY J-BOX W/2-GANG MUD RING, ORIENTED HORIZONTALLY, FOR FACTORY-SUPPLIED DECORATIVE COVERPLATE.
- 4 MOUNT THESE 'BC2' UNITS AT +7'-6" TO BOTTOM OF LUMINAIRE.
- 5 MOUNT 'BC3' UNITS AT +14'-8" TO BOTTOM OF LUMINAIRE.
- 6 MOUNT 'BC1' UNITS AT +24'-6" TO BOTTOM OF LUMINAIRE.
- 7 MOUNT LIGHTING CONTROLS INSIDE FLUSH CABINET ALONG WITH OTHER GYM CONTROLS AS DESCRIBED IN NOTE 1 ON SHEET E-M3.1.
- 8 MOUNT EMERGENCY CONTROL MODULE FLUSH IN WALL AT 7'-6" A.F.F., CENTERED ON GYM CONTROLS ENCLOSURE BELOW. PROVIDE AND INSTALL STEEL COVER, SOLID, NO WINDOW, #WB-MRXG AS MANUFACTURED BY FST METALS GROUP, WWW.FSRINC.COM. PROVIDE AND INSTALL ENGRAVED NAMEPLATE OF LAMINATED PLASTIC, "GYM EM LIGHTS TEST", WHITE WITH BLACK LETTERING, SECURED WITH STAINLESS STEEL SCREWS.
- 9 WATTSTOPPER LMDM-101 U.O.N.
- 10 LABEL THIS EMERGENCY LIGHTING CONTROL MODULE "EXTERIOR". MOUNT ABOVE ZONE CONTROLLER.
- 11 PROVIDE AND INSTALL DIMMER SWITCHES, OCCUPANCY SENSORS, PHOTOSENSORS, ROOM CONTROLLERS, PLUG CONTROLLERS AND NETWORK BRIDGES WHERE SHOWN. SEE DETAILS ON SHEET E-5.3. MOUNT ROOM AND PLUG CONTROLLERS ABOVE ACCESSIBLE CEILING WHEREVER POSSIBLE.
- 12 ROUTE ALL EXTERIOR LIGHTING CIRCUITS HOME VIA BMS-CONTROLLED RELAY CONTRACTS LOCATED IN ELECTRIC ROOM. RELAY CONTRACTS AND BYPASS SWITCHES TO BE PROVIDED BY DIVISION 23. TYPICAL ALL EXTERIOR BUILDING-MOUNTED AND POLE-MOUNTED LUMINAIRES. SEE DETAIL 5/E-5.3.
- 13 ROUTE ALL GYM LIGHTING CIRCUITS HOME VIA ROOM CONTROLLER LOCATED IN STORAGE RM. 110. TIMECLOCK SCHEDULE CONTROL PROVIDED BY ZONE CONTROLLER IN ELECTRIC ROOM VIA LOW VOLTAGE DATA CONNECTION. SEE DETAIL 2/E-5.3 AND SEQUENCE OF OPERATION ON E-5.3.
- 14 ROOM CONTROLLERS FOR GYM LIGHTS. MOUNT ROOM CONTROLLERS AND ASSOCIATED DEVICES TO WALL PER DETAIL 4/E-5.3.
- 15 MOUNT SENSOR TO WALL OF LIGHT WELL USING LMLS-MB2 MOUNTING BRACKET.
- 16 ROOM CONTROLLER FOR HALLWAY RM. 102.
- 17 LM-MSTP DATA LINE BETWEEN NETWORK BRIDGES AND ZONE CONTROLLER. SEE DETAIL 2/E-5.3.
- 18 WATTSTOPPER LMZC-301 ZONE CONTROLLER FOR SCHEDULING GYM LIGHTS.

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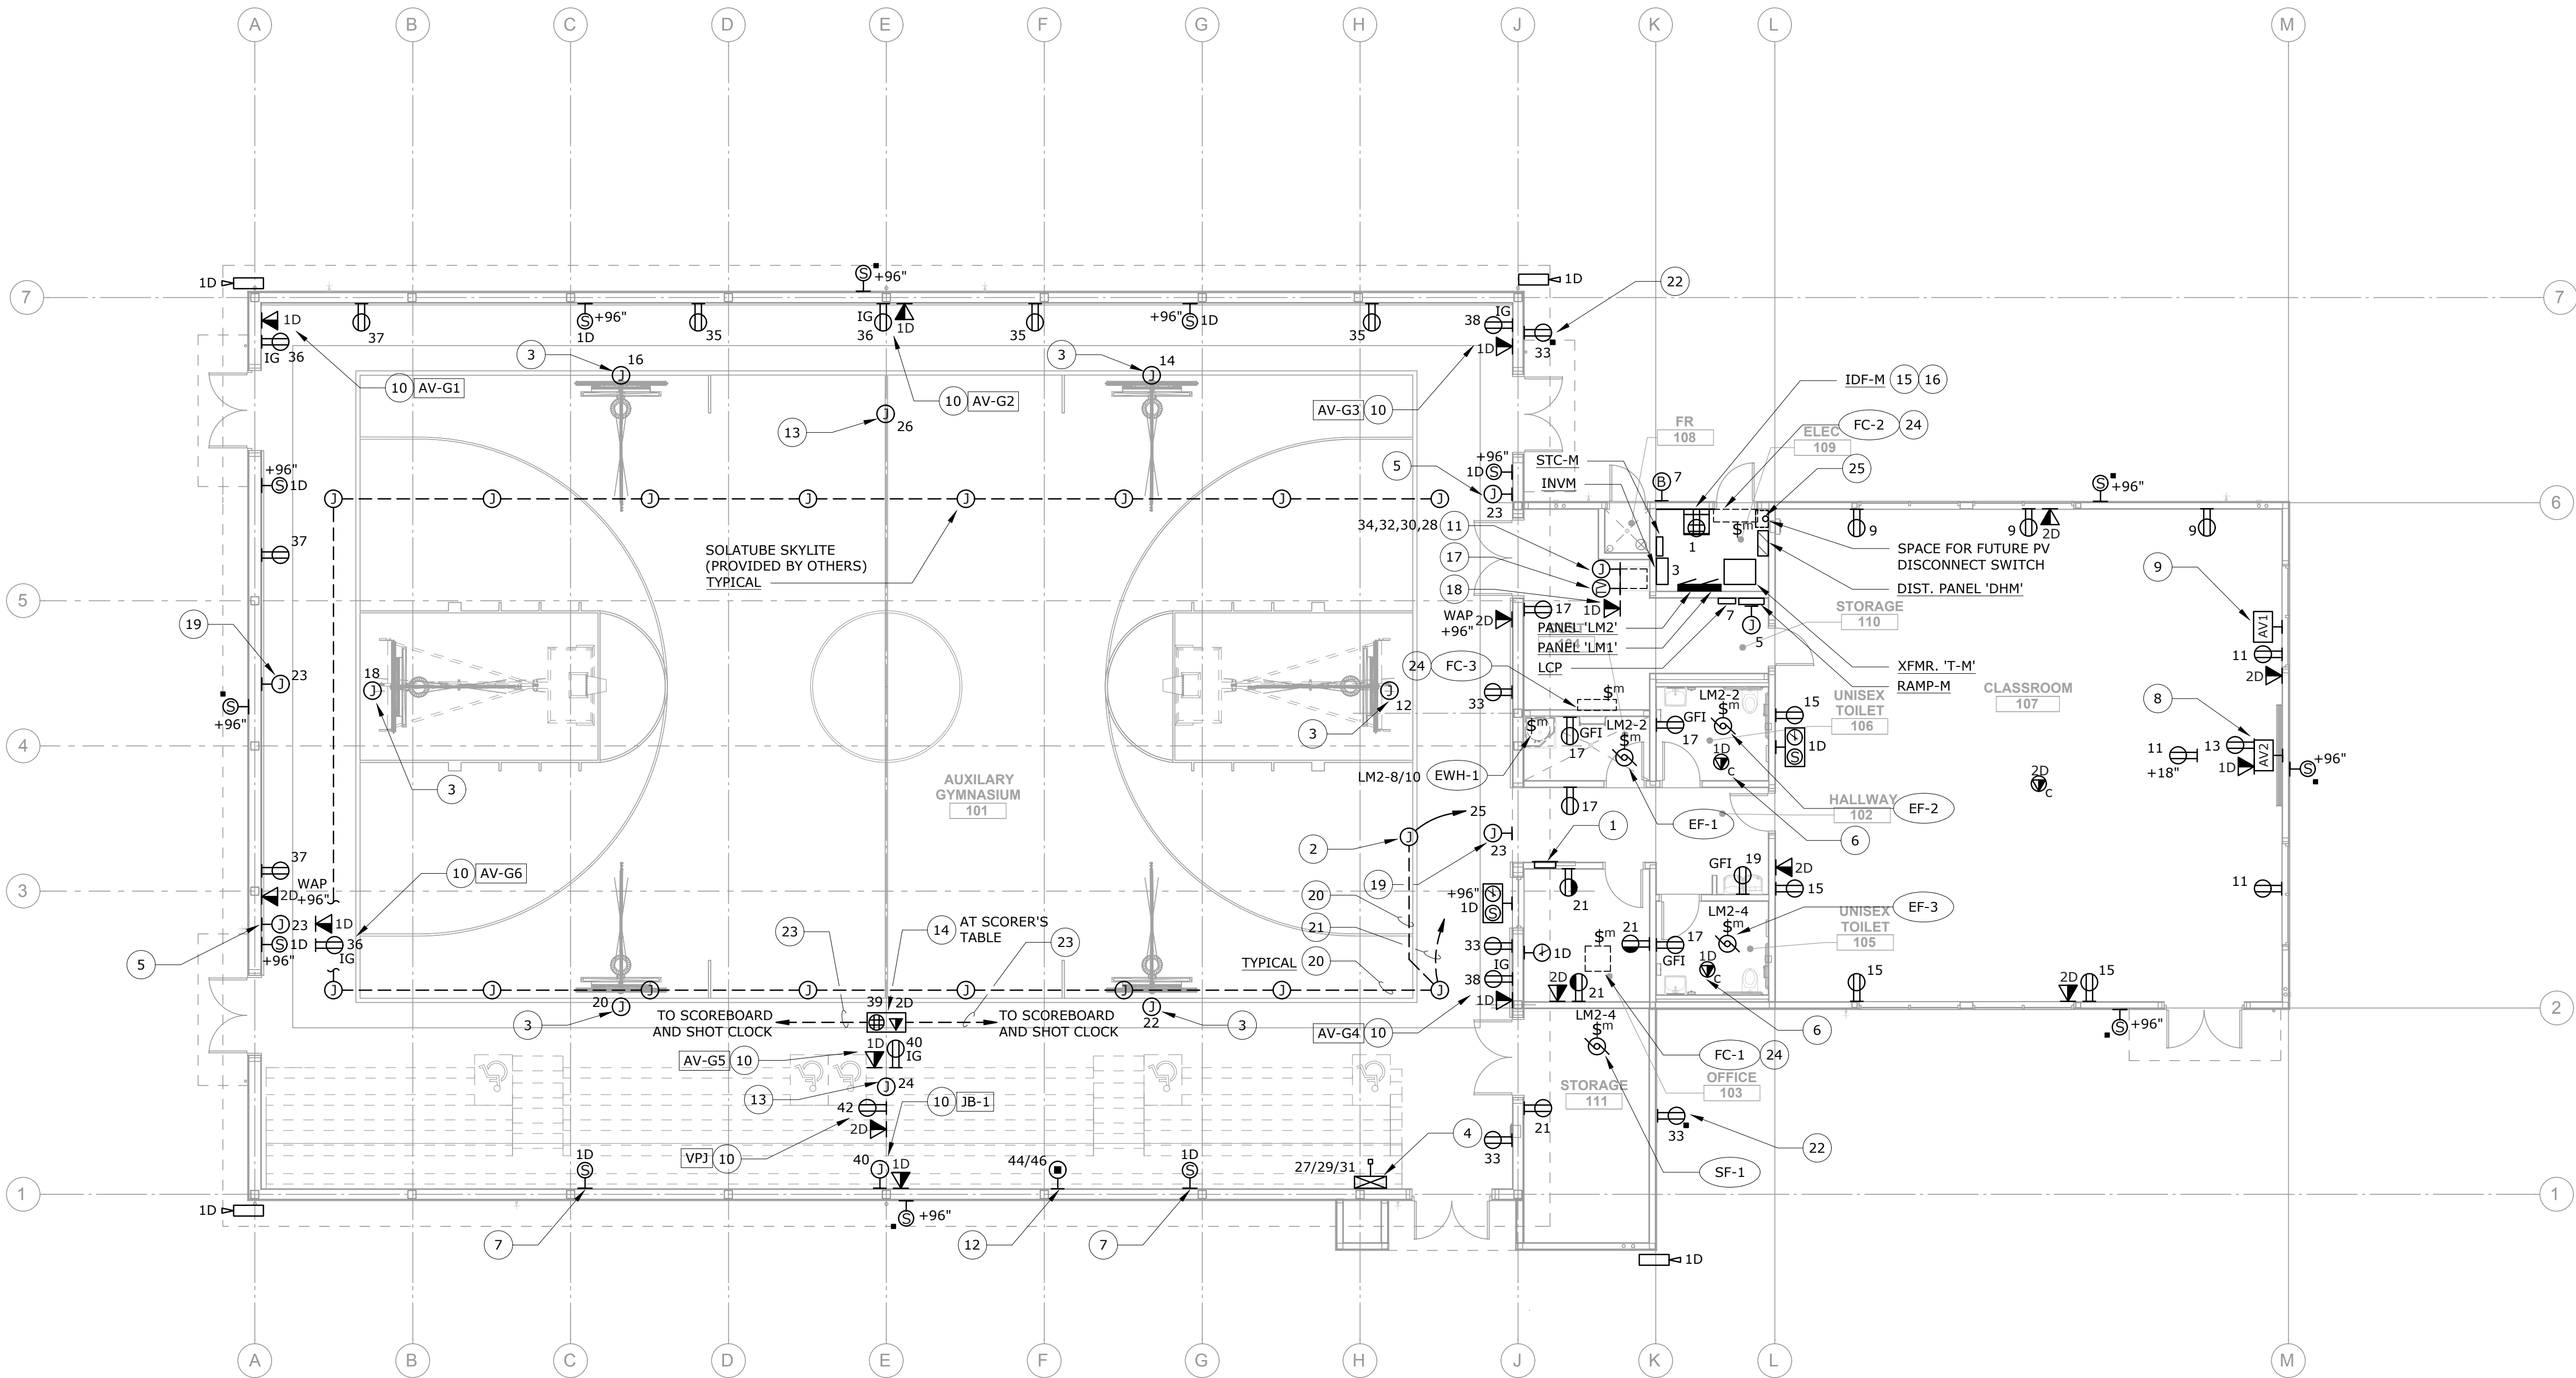
SHEET TITLE

**FLOOR PLAN - LIGHTING**

SHEET NUMBER

**E-M2.1**





FLOOR PLAN - POWER & SIGNAL

SCALE: 1/8" = 1'-0"

A/V SYSTEM NOTES

- SEE THE AV CONSULTANT'S DRAWINGS AND SPECIFICATIONS FOR ALL AV EQUIPMENT, PANEL, AND DEVICE LOCATIONS AND REQUIREMENTS.
- THE AV CONTRACTOR WILL PROVIDE AND INSTALL ALL AV EQUIPMENT, RACKS, DEVICES, PANELS AND AV SYSTEMS WIRING.
- DIVISION 26 SHALL PROVIDE ALL BACKBOXES, CONDUITS AND RACEWAYS REQUIRED FOR THE AV SYSTEM IN COORDINATION WITH THE AV DRAWINGS - SEE AV DRAWINGS FOR ALL AV BACKBOX & CONDUIT REQUIREMENTS.
- MAINTAIN ALL SEPARATIONS BETWEEN AV SYSTEM CONDUITS AND BETWEEN AV SYSTEM AND POWER CONDUITS.

GENERAL SHEET NOTES

- ALL BRANCH CIRCUITS SHOWN SHALL HOMERUN TO BRANCH PANEL 'LM1', U.O.N.
- PROVIDE WIRE GUARD PROTECTIVE COVERS OVER ALL EXPOSED ELECTRICAL / LIGHTING DEVICES IN THE GYMNASIUM SUBJECT TO BALL DAMAGE. COVERS TO BE PROVIDED FOR EXIT SIGNS, FIRE ALARM DEVICES, ANY EXPOSED SWITCHES, AV AND PRODUCTION LIGHTING, OR ANY OTHER DEVICES SUBJECT TO BALL DAMAGE.
- DEDICATED NEUTRALS REQUIRED FOR ALL BRANCH CIRCUITS.
- PROVIDE ISOLATED GROUND IN ADDITION TO STANDARD GROUND CONDUCTOR IN ALL CIRCUITING TO I.G RECEPTACLES. ALL I.G. BRANCH CIRCUITS #10AWG; ALL WITH DEDICATED NEUTRAL.

NUMBERED SHEET NOTES

- 25 PROVIDE AND INSTALL 2" CONDUIT FROM ABOVE FUTURE PV SYSTEM DISCONNECT SWITCH LOCATION TO ROOF. EXTEND FROM APPROXIMATELY 36" BELOW ROOF TO STUB OUT HEIGHT ABOVE ROOF. SEE NOTE 2 ON SHEET E-3.2.

NUMBERED SHEET NOTES

- 18 PROVIDED (1) DATA DROP IN A 1-GANG BOX AT AV RACK. EXTEND 1" CONDUIT UP FROM BOX FOR DATA CABLING.
- 19 SHOT CLOCK POWER CONNECTION. COORDINATE EXACT CONNECTION LOCATION WITH SHOT CLOCK INSTALLER PRIOR TO ROUGH-IN.
- 20 PROVIDE AND INSTALL 3/4" CONDUIT FOR SOLATUBE CONTROL WIRING. COORDINATE SOLATUBE LOCATIONS WITH SOLATUBE INSTALLER. CONTROL WIRING BY OTHERS.
- 21 PROVIDE AND INSTALL 3/4" CONDUIT BETWEEN SOLATUBE HOUSING AND CONTROLS CABINET, FOR CONTROL WIRING, CONTROLS AND CONTROL WIRING BY OTHERS. SEE NOTE 1.
- 22 PROVIDED FLUSH WALL MOUNTED WEATHERPROOF COVER WITH LOCKING LATCH, PASS & SEYMOUR 4600 SERIES, OR EQUAL. REQUIRES SPECIAL ROUGH-IN.
- 23 PROVIDE AND INSTALL (2) 3/4" CONDUITS FOR SCOREBOARD AND SHOT CLOCK CONTROL WIRES, (1) CONDUIT TO EACH. SEE NOTES 5 AND 19.
- 24 OUTDOOR UNIT SUBFEEDS LINE VOLTAGE POWER TO INDOOR UNIT. PROVIDE, INSTALL AND CONNECT COMPLETE INTERCONNECTING CONDUCTORS PER MFR. REQUIREMENTS IN CONDUIT SIZED PER NEC REQUIREMENTS. SEE E-3.2 FOR OUTDOOR UNIT. VERIFY AND COORDINATE WITH DIVISION 23.

NUMBERED SHEET NOTES

- 1 PROVIDE FLUSH MOUNTED NEMA 1 STAINLESS STEEL CABINET WITH HINGED, LOCKABLE, LATCHED, FLUSH DOOR, TOP AT 6" A.F. MIN. 36"H x 24"W. ENCLOSURE TO INCLUDE CONTROLS FOR GYM LIGHTING, BACKSTOPS AND MOTORIZED SOLATUBES. MOUNT CONTROLS IN SEPARATE J-BOXES INSIDE ENCLOSURE WITH EMT CONDUIT BETWEEN (NO EXPOSED WIRING INSIDE CABINET). CLEARLY LABEL ALL CONTROLS FOR FUNCTION WITH PERMANENT ENGRAVED LAMINATED NAMEPLATES AFFIXED WITH STAINLESS STEEL SCREWS (NO P-TOUCH LABELS).
- 2 PROVIDE J-BOX FOR SOLATUBE 24VAC/96VA TRANSFORMER (TRANSFORMER PROVIDED BY OTHERS). COORDINATE EXACT LOCATION WITH SOLATUBE INSTALLER. CONNECT 120V CIRCUIT SHOWN COMPLETE TO TRANSFORMER.
- 3 PROVIDE AND INSTALL J-BOX FOR BACKSTOP TWIST-LOCK PLUG (BY OTHERS). SEE 3/E-7.2. INSTALL J-BOX AT STRUCTURE ABOVE, WITHIN 3' OF THE BACKSTOP WINCH MOTOR. COORDINATE EXACT LOCATION WITH VENDOR SHOP DRAWINGS PRIOR TO ROUGH-IN. LOCATE CONTROLS IN GYM CONTROLS CABINET. SEE NOTE 1.
- 4 MOTORIZED BLEACHER POWER CONNECTION. VERIFY EXACT LOCATION AND ROUGH-IN REQUIREMENTS WITH BLEACHER MANUFACTURER PRIOR TO ROUGH-IN. LOCATE WITHIN PROXIMITY TO MOTOR AND CONTROL BOX.
- 5 SCOREBOARD POWER CONNECTION. COORDINATE EXACT CONNECTION LOCATION WITH SCOREBOARD INSTALLER PRIOR TO ROUGH-IN.
- 6 PROVIDE AND INSTALL DATA PORT FLUSH IN CEILING FOR VAPE DETECTOR, PROVIDED BY OTHERS.
- 7 AT +60" ABOVE TOP BLEACHER LEVEL.
- 8 FLUSH WALL MOUNTED AV / POWER BOX ASSEMBLY (ABOVE SHORT-THROW PROJECTOR). HUBBELL netSELECT FPTV 2-GANG BOX #NSAV62M, OR EQUAL, WITH DUPLEX RECEPTACLE AND (1) DATA JACK. PROVIDE WITH STEEL COVER #NSAV6C. COORDINATE MOUNTING HEIGHT OF SHORT-THROW PROJECTOR WITH ARCHITECT.
- 9 FLUSH 2-GANG J-BOX FOR HDMI AND AUDIO FACEPLATE AND PASS-THRU CABLE ASSEMBLY. PROVIDE AND INSTALL 1.25" CONCEALED CONDUIT BETWEEN J-BOX AND RECESSED AV / POWER BOX ABOVE SHORT-THROW PROJECTOR. SEE NOTE 8.
- 10 PROVIDE AND INSTALL POWER AND DATA OUTLETS FOR AV EQUIPMENT. SEE AV DRAWINGS FOR COORDINATION.
- 11 PROVIDE AND INSTALL (4) DEDICATED 120V, 20A CIRCUITS TO RACK. COORDINATE EXACT CONNECTION POINT ON RACK WITH AV INSTALLER. CIRCUIT TO BE (2)#12 + (1)#12G. IN 1" NON-METALLIC FLEX CONDUIT, FROM J-BOX TO AV RACK.
- 12 PROVIDE AND INSTALL NEMA L6-30 RECEPTACLE FOR AV EQUIPMENT. COORDINATE EXACT LOCATION WITH AV INSTALLER.
- 13 MOTORIZED DIVIDER CURTAIN POWER CONNECTION. LOCATE J-BOX WITHIN 3' OF CURTAIN MOTOR. VERIFY EXACT LOCATION AND ROUGH-IN REQUIREMENTS WITH MANUFACTURER PRIOR TO ROUGH-IN.
- 14 FLUSH IN-FLOOR POWER/DATA BOX WITH QUAD RECEPTACLE AND DATA JACKS AS INDICATED. COORDINATE FLUSH ROUGH-IN AND TRIM WITH SPORTS FLOOR INSTALLER PRIOR TO ROUGH-IN.
- 15 PROVIDE AND INSTALL WALL MOUNTED IDF. IDF SHALL BE CHATSWORTH CUBE-IT PLUS, #11900-748, OR EQUAL. PROVIDE WITH POWER STRIP (#12820-705) AND FAN/FILTER KIT (#40972-001) MOUNTED INSIDE CABINET. SEE E-5.2 AND 5/E-7.1 FOR MOUNTING.
- 16 PROVIDE DEDICATED QUAD RECEPTACLE AND J-BOX WITH #2AWG G. TO NEAREST BUILDING ELECTRODE. LOCATE EQUIPMENT WITHIN IDF CABINET.
- 17 PROVIDED (1) CCTV OUTLET IN A 1-GANG BOX AT AV RACK. EXTEND 1" CONDUIT UP FROM BOX FOR CCTV CABLING.


SECURITY SYSTEM SYMBOLS

- ▬ - PROVIDE AND INSTALL A 2-GANG BOX WITH A 1-GANG RING AND 1/2" C. WITH STRING STUBBED IN TO ACCESSIBLE CEILING SPACE. COORDINATE MOUNTING HEIGHT WITH SECURITY SYSTEM INSTALLER.

NOTES:

1. COORDINATE ALL SECURITY DEVICES EXACT LOCATION & WIRING WITH DISTRICT SECURITY CONTRACTOR PRIOR TO ROUGH-IN, TYP., U.O.N.

KEYPLAN

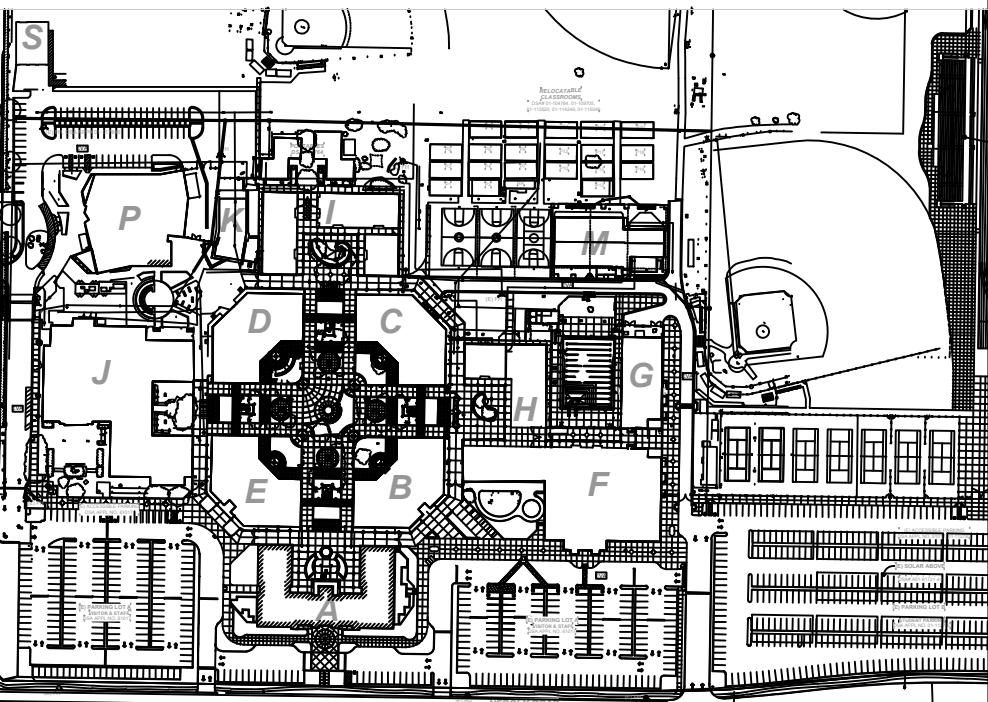

**QUATTROCCHI KWOK ARCHITECTS**  
Main Office:  
636 Fifth Street, Santa Rosa, CA 95404  
East Bay:  
55 Harrison Street, Suite 525  
Oakland, CA 94607  
(707) 576-0829

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490 REDWOOD HWY., SUITE 245  
SAN RAFAEL, CALIFORNIA 94903  
(415) 492-0807 FAX (415) 492-0662  
www.omahonyandmyer.com

**P. O'Mahony**  
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DSA APP NO. 01-119278

ARCH PROJECT NO. 1869.00

DRAWN BY: LN,TV,JW,OOM

DRAWING SCALE: AS NOTED

PTN: 61721-78 FILE NO: 7-H4

**BID DOCUMENT**

**APRIL 27, 2021**


SHEET TITLE

**FLOOR PLAN - POWER & SIGNAL**

SHEET NUMBER


**E-M3.1**



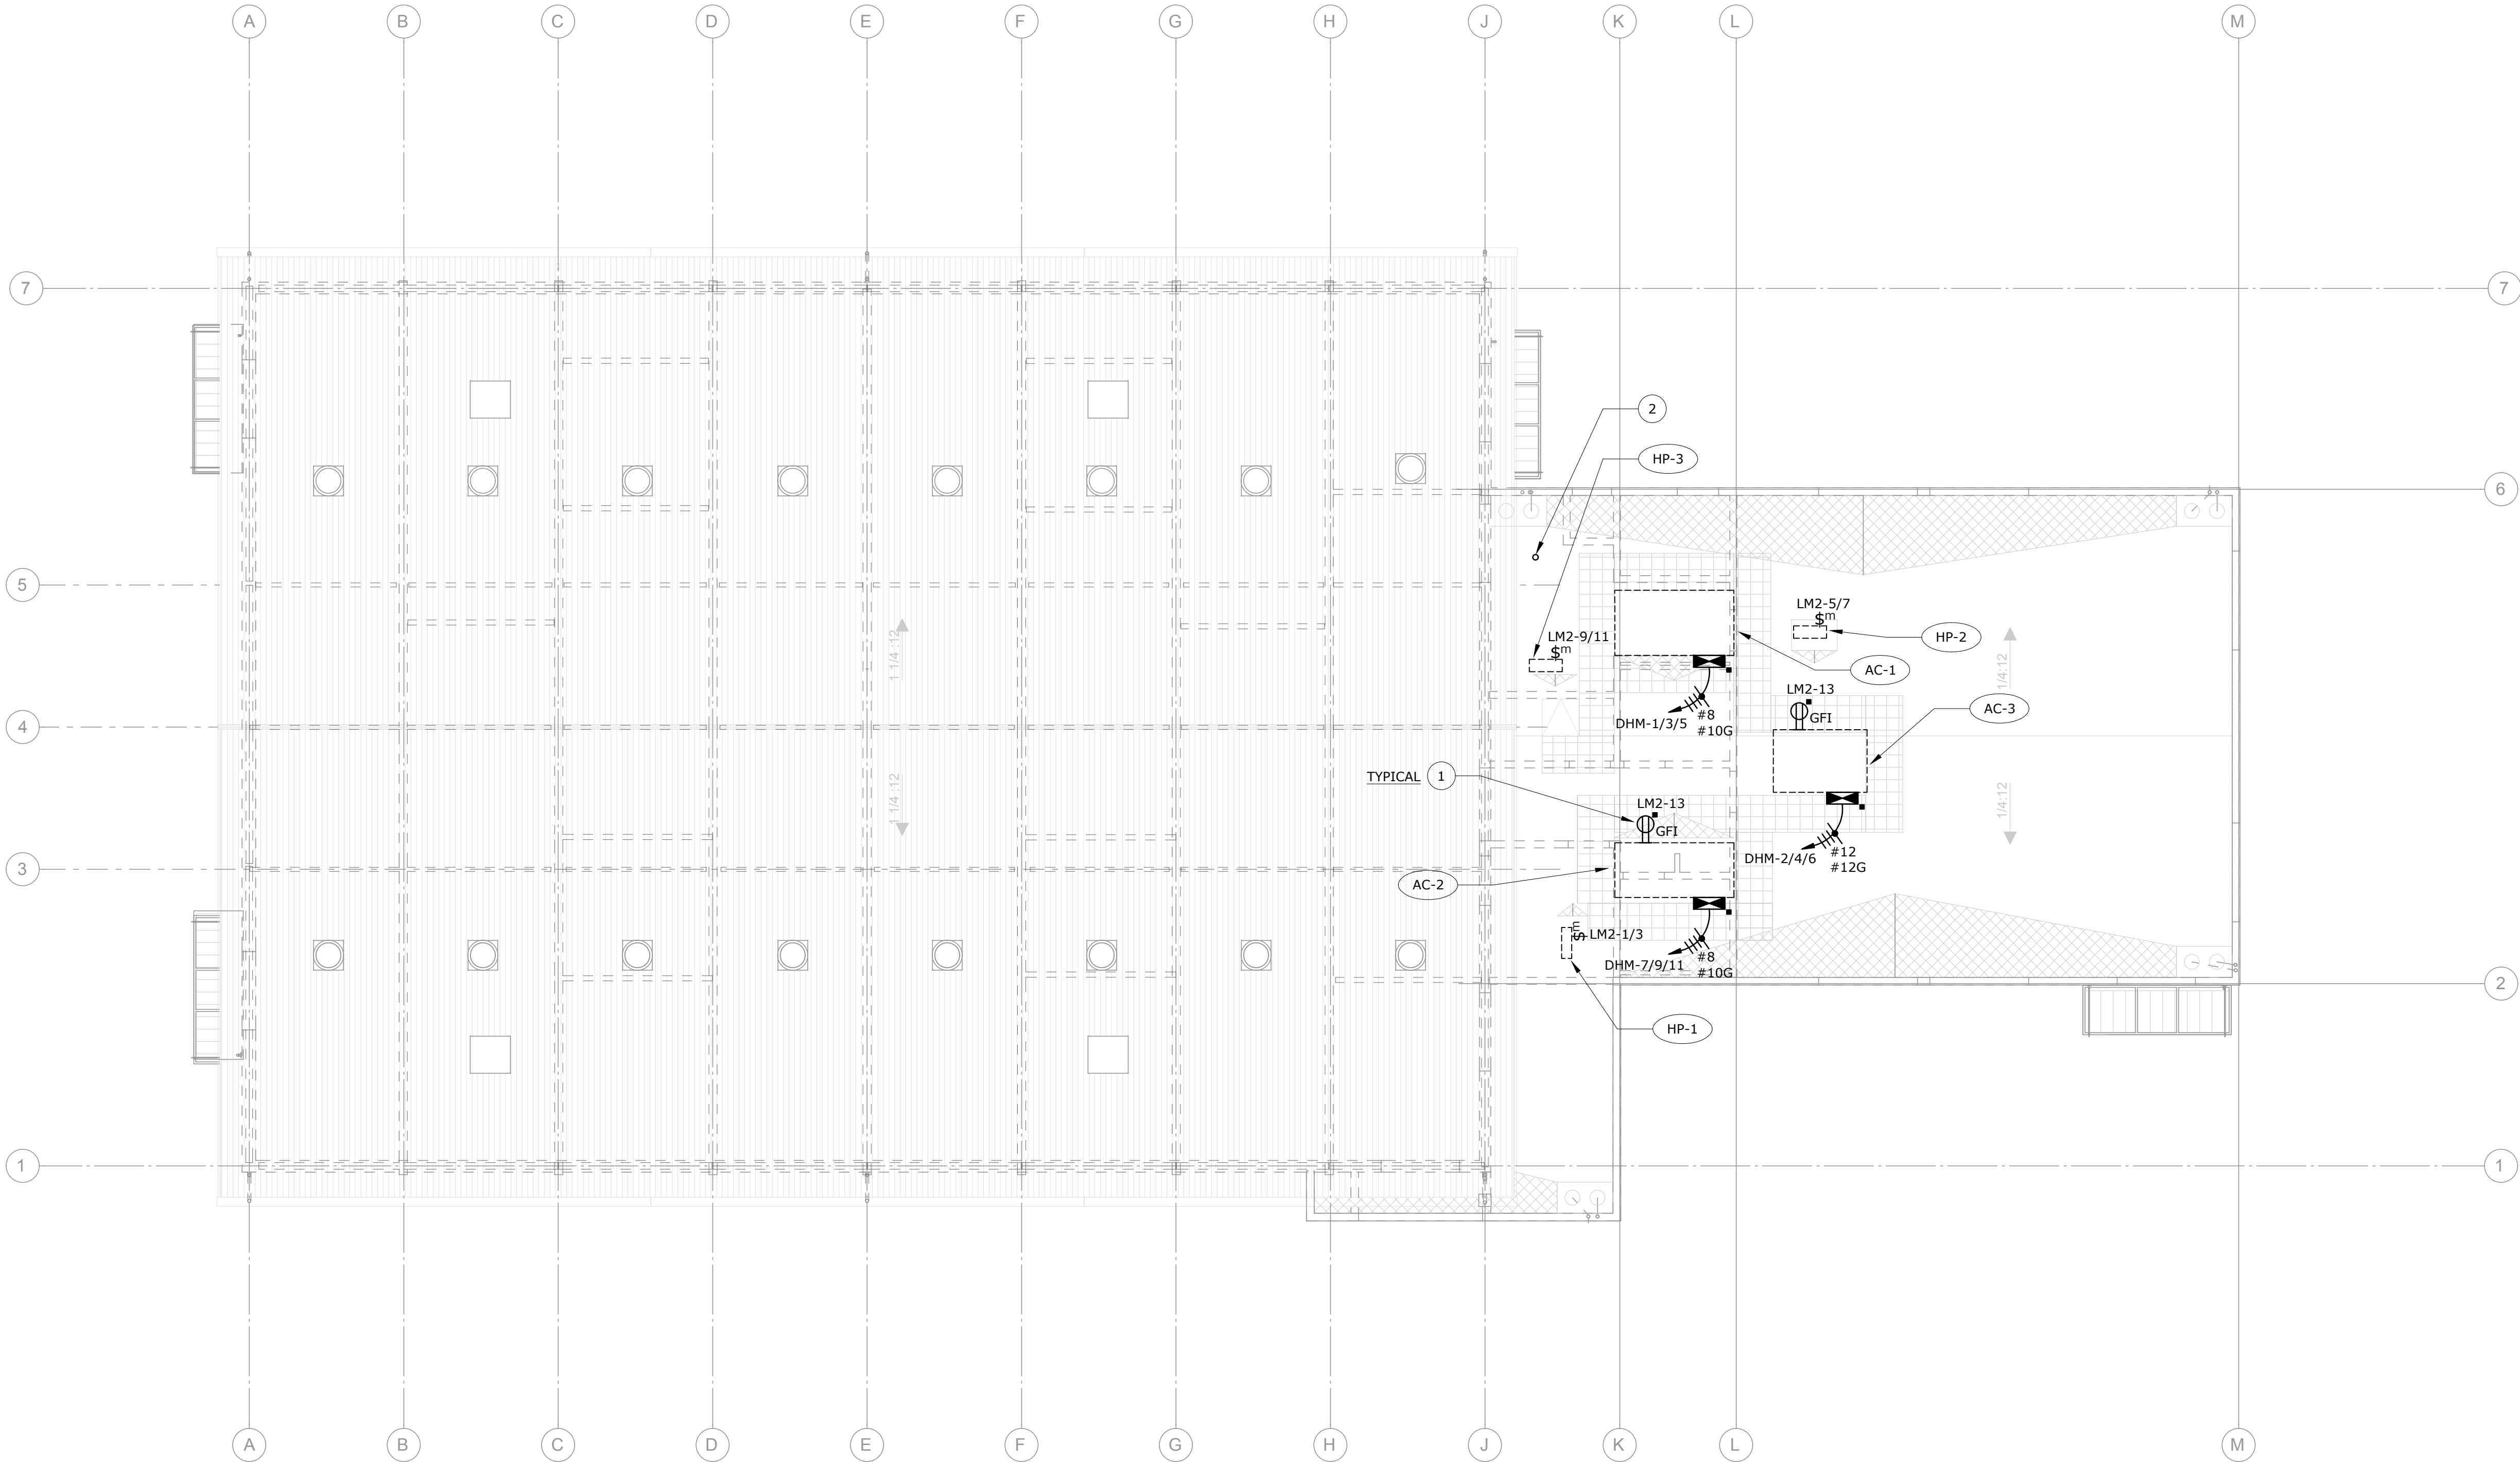

ROOF PLAN - ELECTRICAL


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
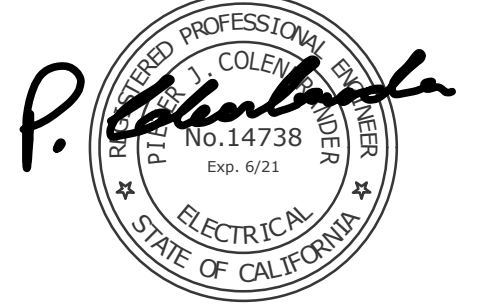
NUMBERED SHEET NOTES

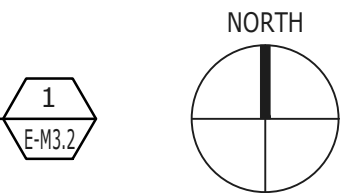- 1 PROVIDE AND INSTALL ROOF MOUNTED SERVICE OUTLET SUCH THAT THE DISTANCE BETWEEN AN OUTLET AND ANY SERVICABLE MECHANICAL EQUIPMENT IS NO GREATER THAN 25'.
- 2 STUB OUT AND CAP 2" CONDUIT FOR FUTURE PV SYSTEM AT THIS LOCATION. SEE 2/E-7.1. AND NOTE 25 ON SHEET E-3.1.

KEYPLAN



  
QUATTROCCHI KWOK  
ARCHITECTS  
Main Office:  
636 Fifth Street, Santa Rosa, CA 95404  
East Bay:  
55 Harrison Street, Suite 525  
Oakland, CA 94607  
(707) 576-0829

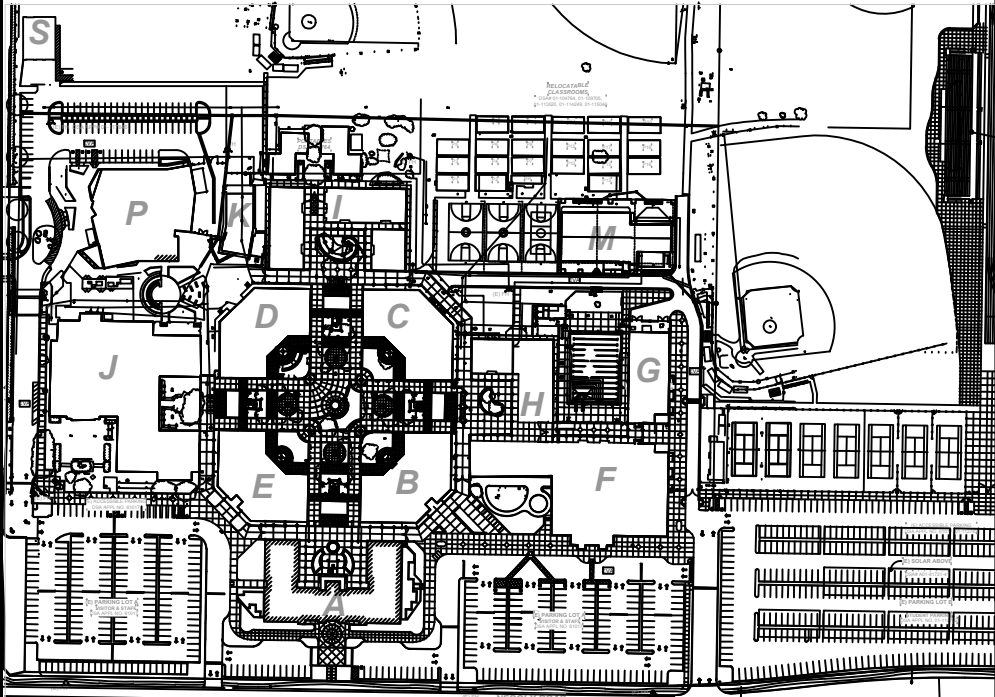  
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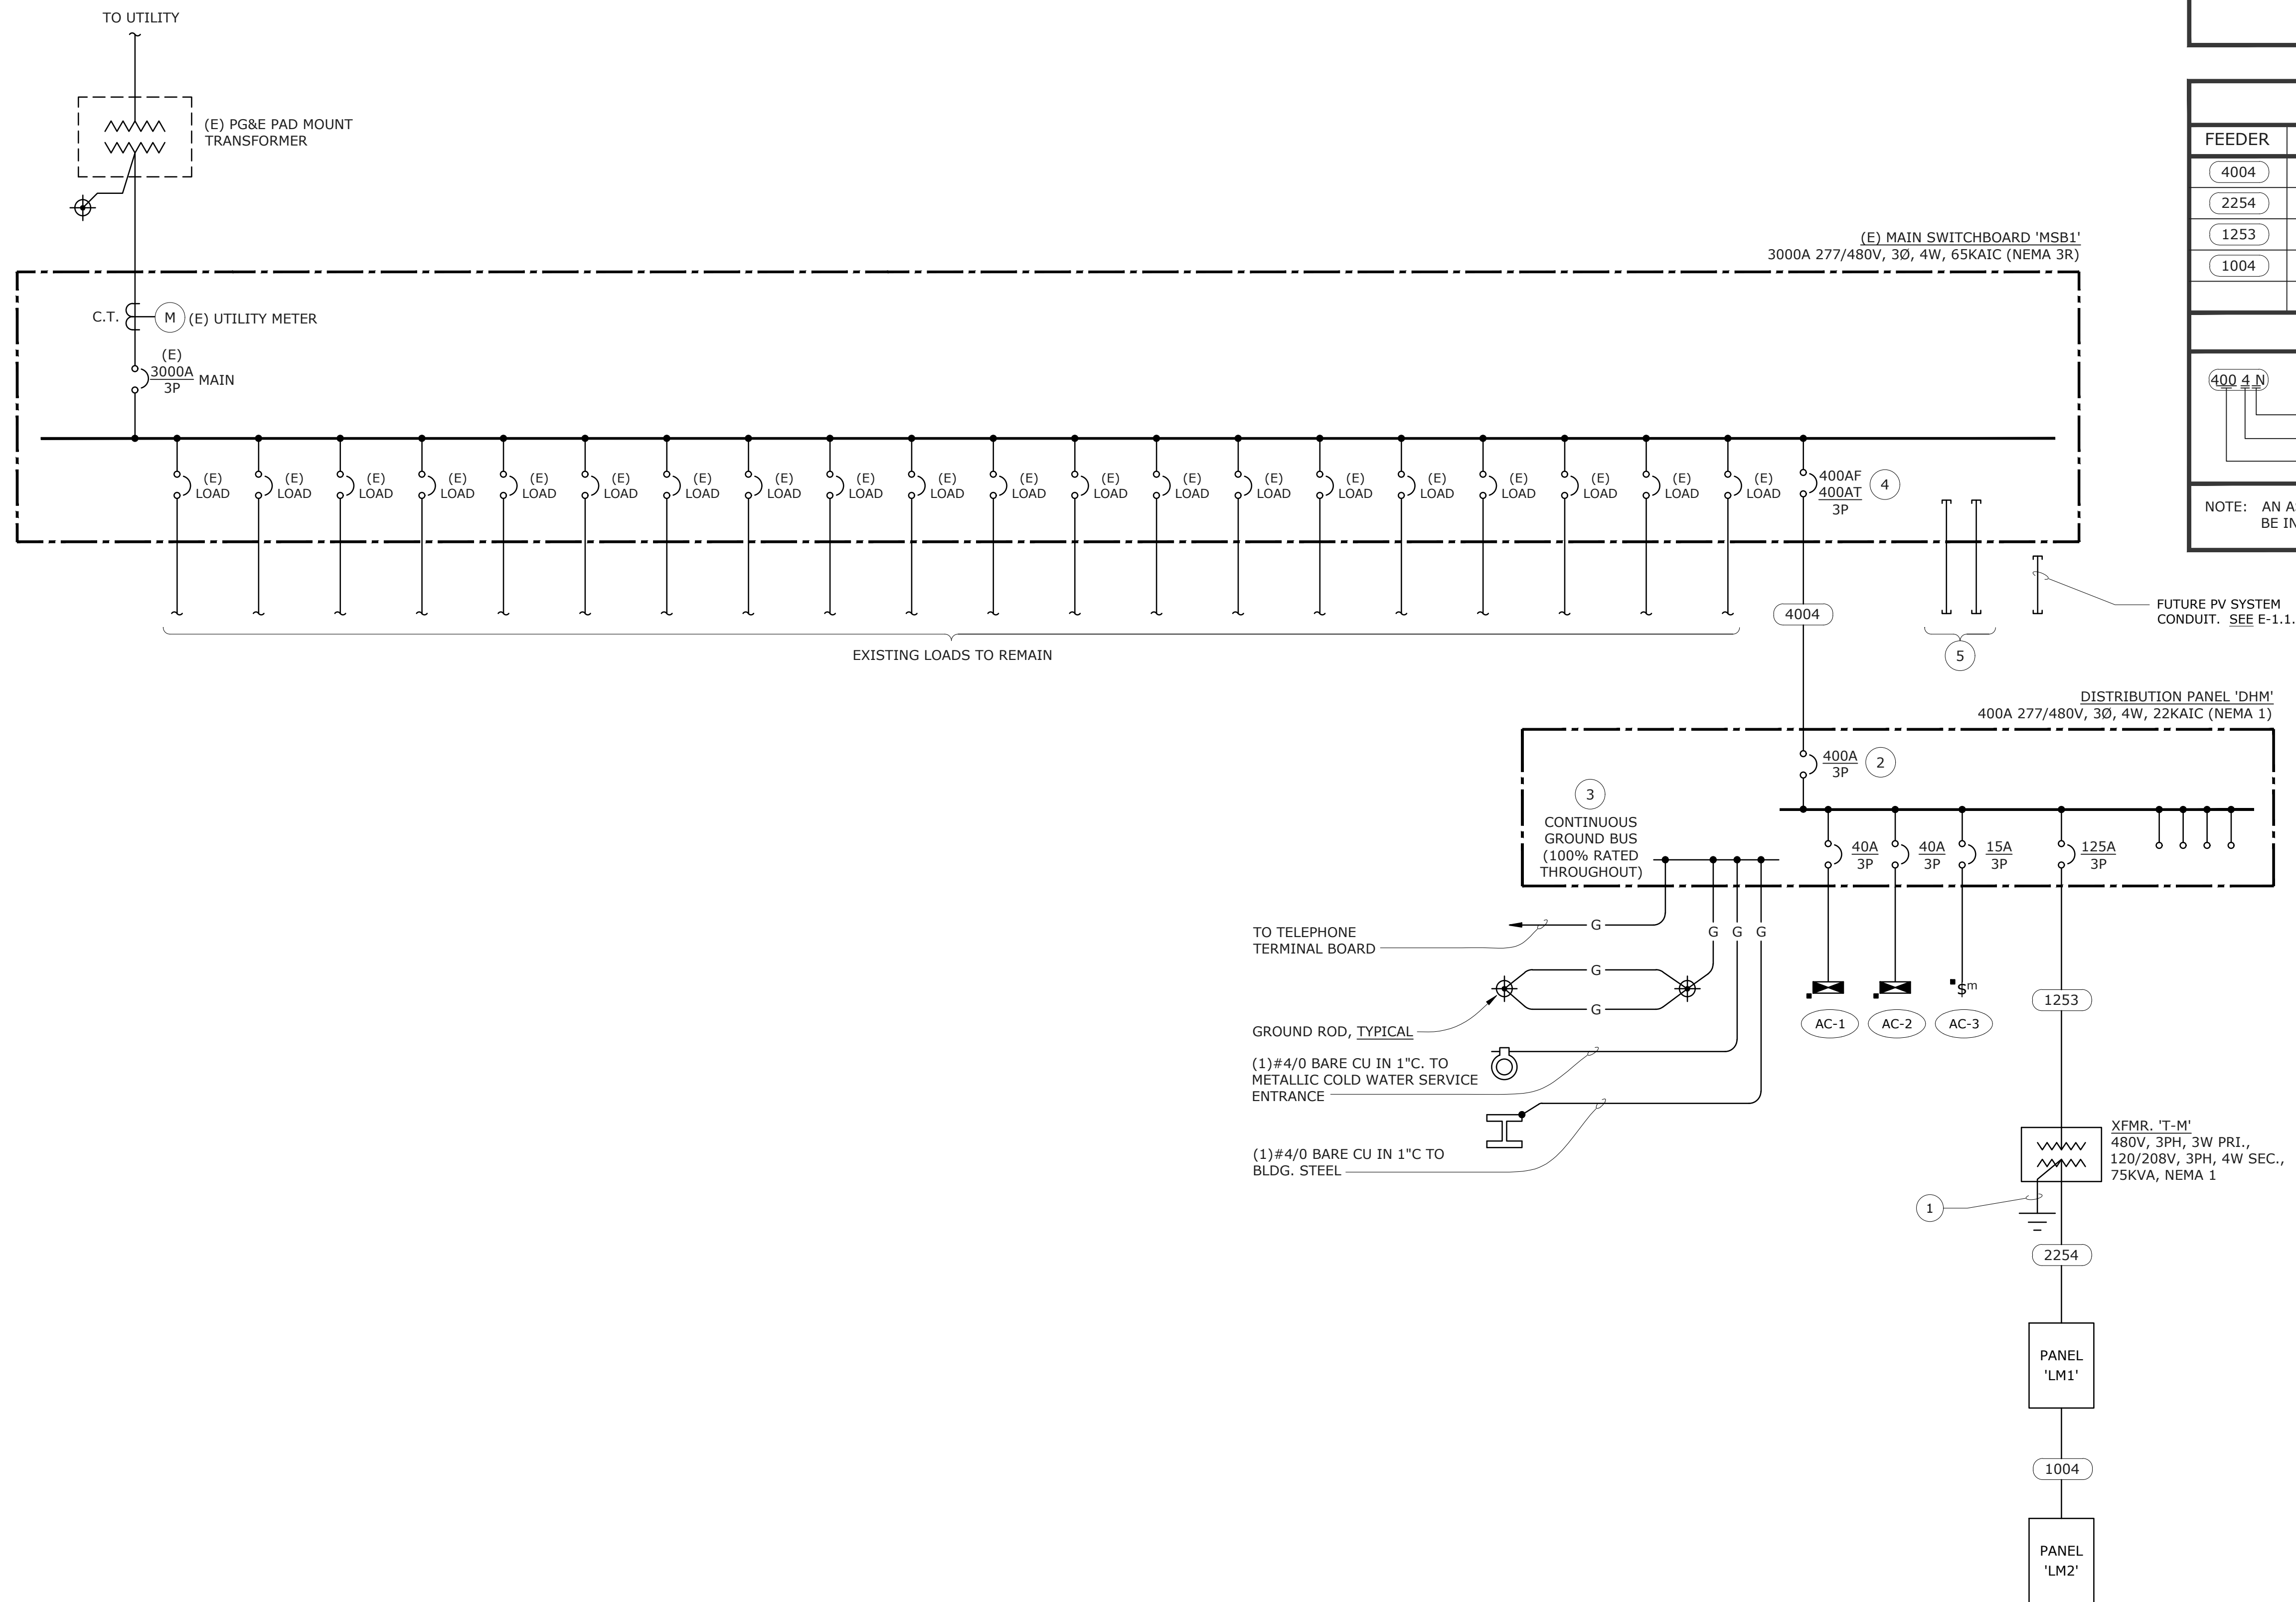
DSA APP NO. 01-119278	
ARCH PROJECT NO.	1869.00
DRAWN BY:	LN,TV,JW,OOM
DRAWING SCALE:	AS NOTED
PTN: 61721-78	FILE NO: 7-H4

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APRIL 27, 2021
SHEET TITLE

ROOF PLAN -  
ELECTRICAL

SHEET NUMBER  
**E-M3.2**





## SINGLE LINE DIAGRAM - POWER

SCALE: NONE


## NUMBERED SHEET NOTES

- 1 PROVIDE AND INSTALL (1) #4/0 G. IN 1-1/2" C. TO GROUNDING ELECTRODE.
- 2 LABEL AS 'MAIN BUILDING DISCONNECT'.
- 3 IN ADDITION TO GROUNDING INDICATED, BOND ALL COLD WATER PIPING SYSTEM, GAS PIPING SYSTEMS, AND SPRINKLER PIPING SYSTEMS TO THE BUILDING GROUNDING ELECTRODE SYSTEM WITH CODE SIZED BONDING CONDUCTOR IN (1) 3/4 INCH CONDUIT. BOND WHEREVER THERE IS A BREAK IN THE CONTINUITY OF THESE SYSTEMS THROUGHOUT THE PROJECT.
- 4 (N) CIRCUIT BREAKER TO MATCH (E) IN MANUFACTURER AND AIC RATING.
- 5 PROVIDE AND INSTALL (2) 4" UNDERGROUND SCHEDULE 40 PVC RACEWAYS FOR FUTURE CONSTRUCTION. SEE E-1.1.


## COPPER FEEDER SCHEDULE

FEEDER	CONDUIT	CONDUCTORS
4004	(1) 4"	(4) #500 KCMIL & (1) #1/0 G.
2254	(1) 3"	(4) #4/0 & (1) #4 G.
1253	(1) 1-1/2"	(3) #1/0 & (1) #6 G.
1004	(1) 2"	(4) #1 & (1) #6 G.


### FEEDER TAG KEY

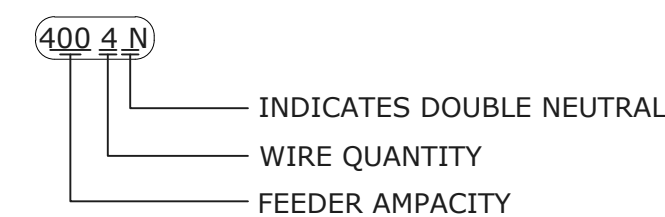

NOTE: AN ASTERIK IN THE "FEEDER" COLUMN SYMBOL INDICATES NEW CONDUIT TO BE INSTALLED.

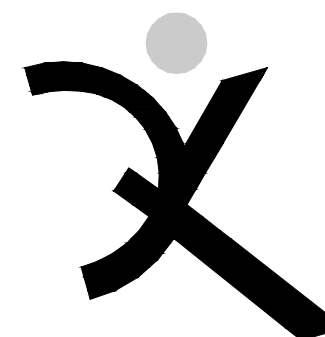

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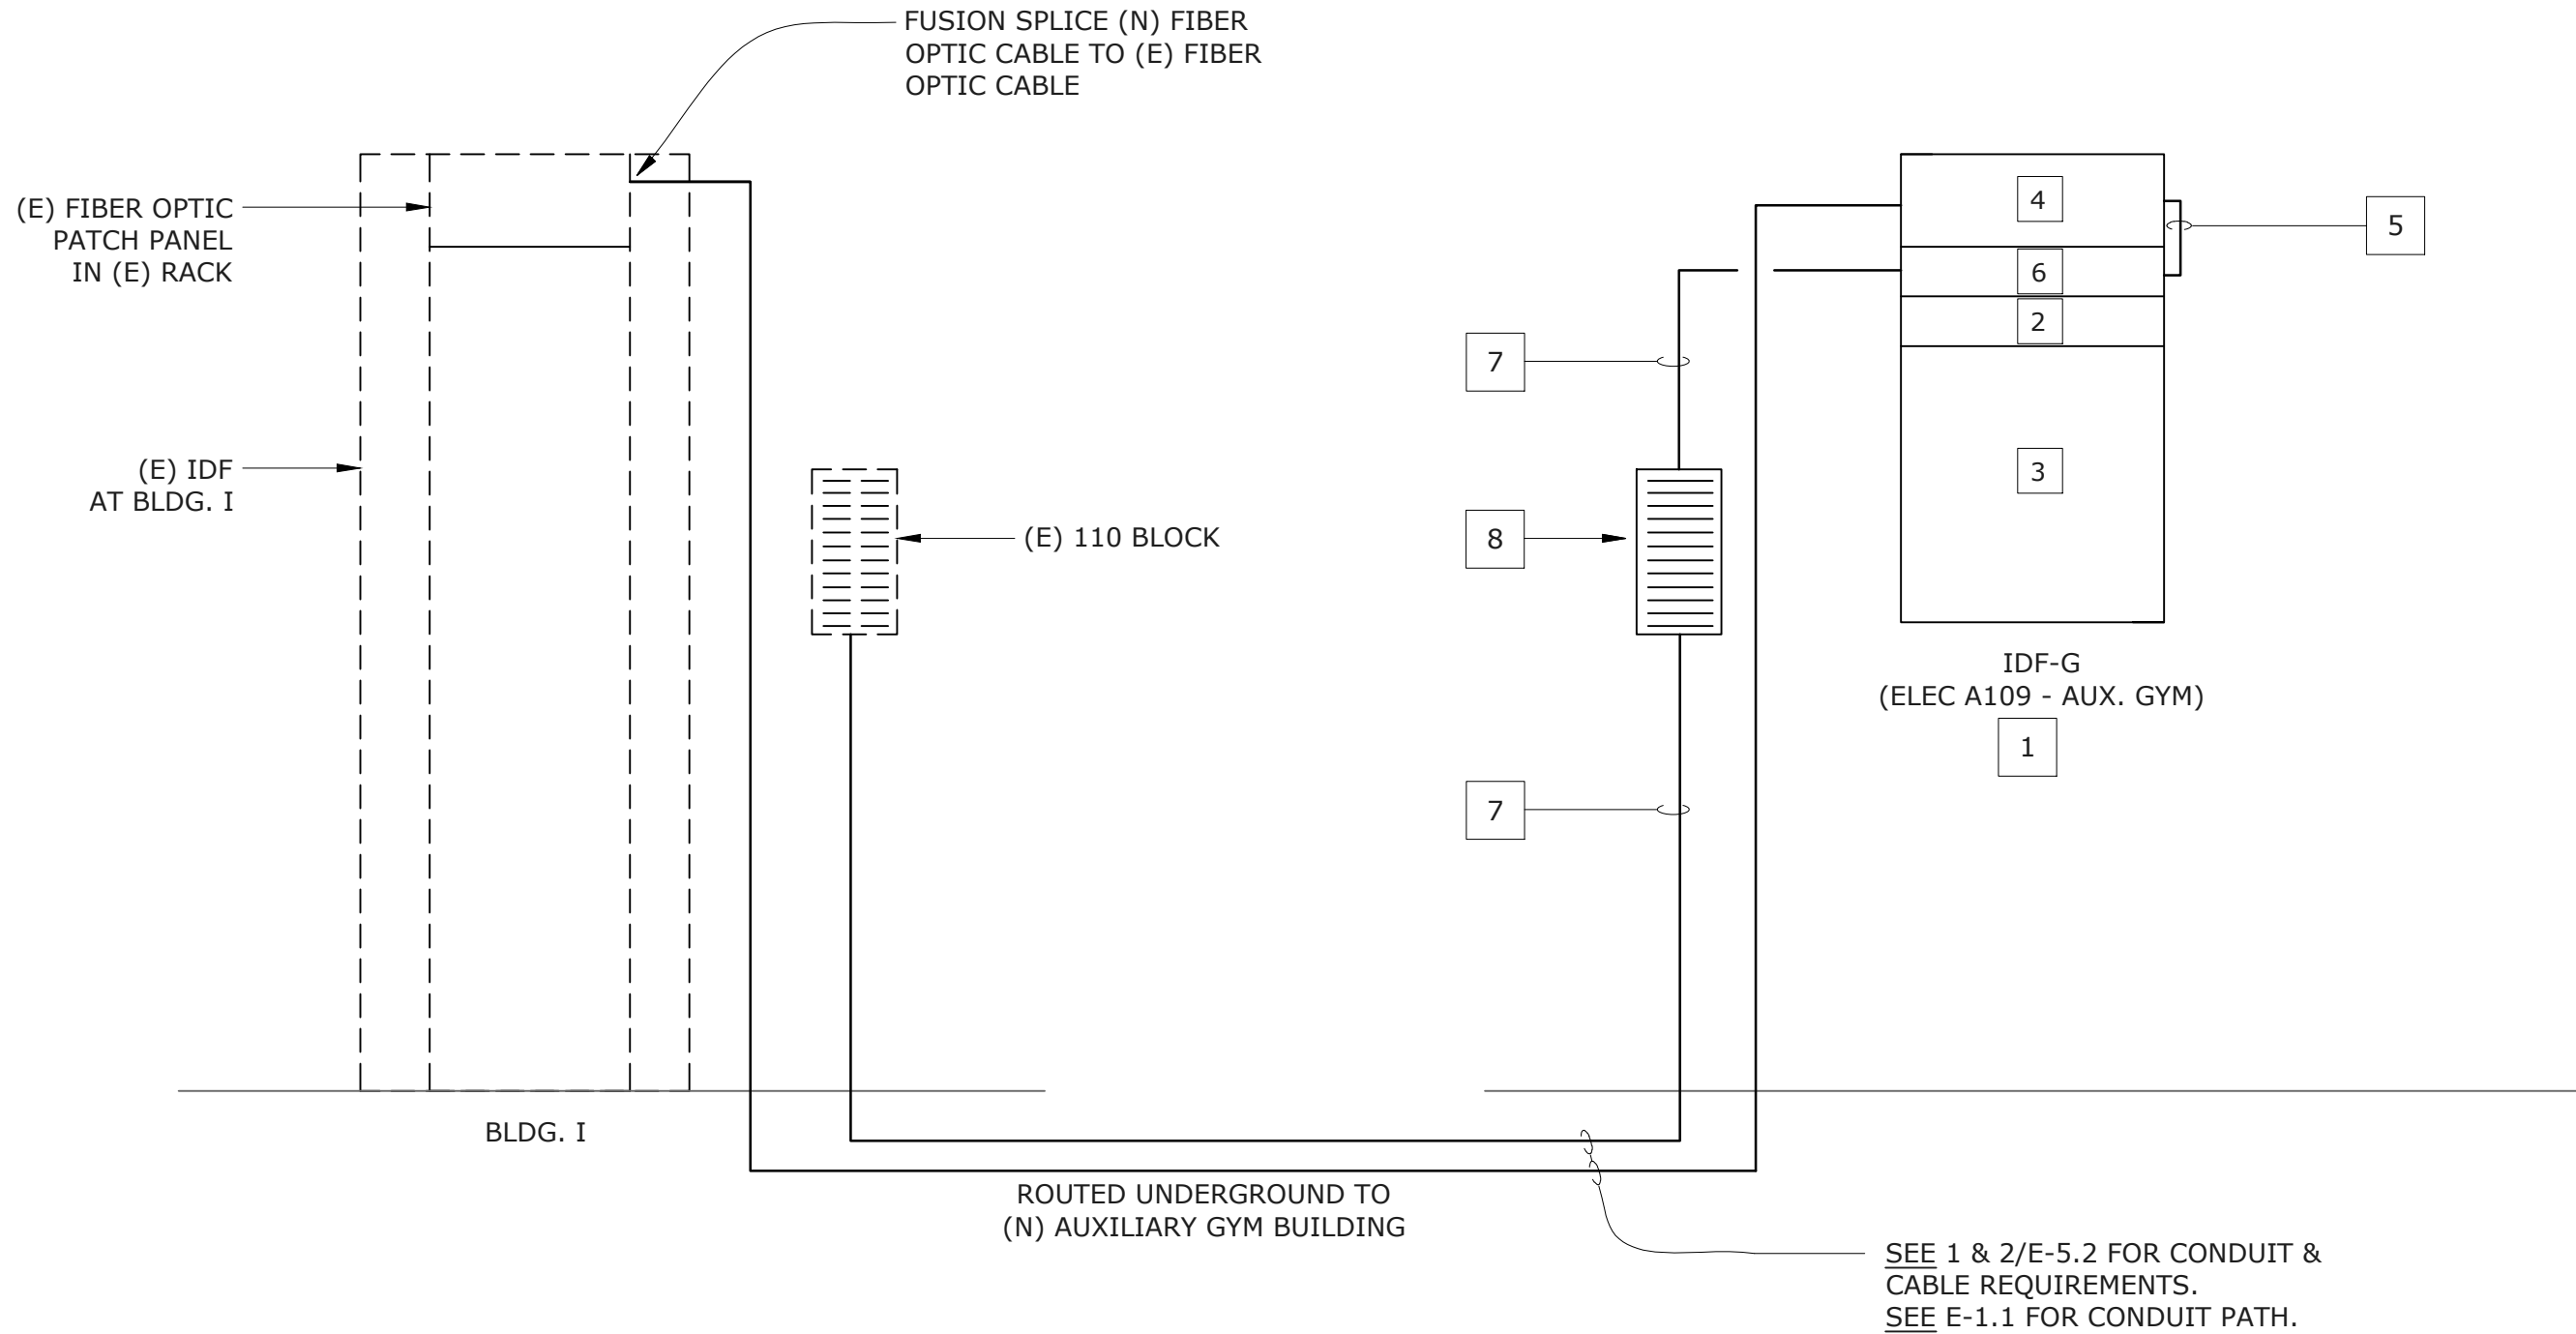
## SINGLE LINE DIAGRAM - POWER

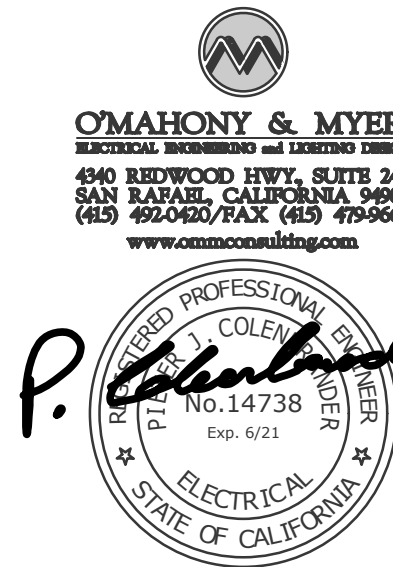SHEET NUMBER

## E-5.1



DATA EQUIPMENT LIST		
1	WALL MOUNTED, ENCLOSED, 48" HIGH, DATA CABINET WITH LATCHING DOOR (EATON OR EQUAL)	SEE SPECIFICATIONS
2	WIRE MANAGEMENT	SEE SPECIFICATIONS
3	ACTIVE DISTRICT NETWORK EQUIPMENT	BY NETWORK INTEGRATOR OR OWNER
4	FIBER OPTIC PATCH PANEL	SEE SPECIFICATIONS
5	CATEGORY 6A MODULAR PATCH CORDS	SEE SPECIFICATIONS
6	CATEGORY 6 PATCH PANEL	48-PORT MODULAR TO 110 - SEE SPECIFICATIONS
7	25-PAIR FEEDER CABLE WITH FEMALE AMP END/ PIGTAIL TO 110 BLOCKS	CABLE EXCHANGE #253-X90-50F
8	110 BLOCK FOR COPPER PAIR TERMINATIONS	SEE SPECIFICATIONS



TYPICAL TELECOM CABINET ELEVATIONS  
SCALE: NONE

3  
E-5.2


### GENERAL CLOCK/SPEAKER NOTES

- ALL CLOCK/SPEAKER DEVICES SHALL BE IP, AND ARE OWNER FURNISHED, CONTRACTOR INSTALLED ('OFCI').
- PROVIDE ALL REQUIRED PROGRAMMING MODIFICATIONS TO THE EXISTING PA AND CLOCK SYSTEM TO ACCOMMODATE THESE ADDITIONS. PRIOR TO BID, VERIFY THAT THE EXISTING PROGRAM FILES FOR THIS SITE ARE AVAILABLE. INCLUDE IN THE BID ALL COSTS REQUIRED TO RECREATE ANY MISSING OR DEFECTIVE FILES.
- ALL RELOCATIONS AND ADDITIONS TO THE EXISTING SYSTEM SHALL BE PERFORMED BY A CURRENTLY AUTHORIZED AND FACTORY-TRAINED DEALER.

### SIGNAL SYSTEM NUMBERED NOTES

- TELECOM CABLING TO BE FULLY TERMINATED ON JACKS AND LOCATED AT A CONCEALED LOCATION FOR CABLE PATCHING TO CLOCK/SPEAKER DEVICE. PROVIDE QUANTITIES AS SHOWN ON THE FLOOR PLANS AND DIAGRAMS. COORDINATE EXACT LOCATION AND REQUIREMENTS PRIOR TO ROUGH-IN.
- DATA JACK SYMBOLS NOT SHOWN ON FLOOR PLANS FOR CLOCK/SPEAKER DEVICES, ONLY THE CLOCK/SPEAKER SYMBOL. CONTRACTOR SHALL PROVIDE AND INSTALL ALL JACKS, PER THE REQUIREMENTS OF NUMBERED NOTE 1, IN QUANTITIES AS SHOWN ON THE FLOOR PLANS AND DIAGRAMS.

NOTE:  
REFER TO FLOOR PLANS FOR QUANTITY AND  
LOCATION OF ALL DEVICES AND EQUIPMENT.

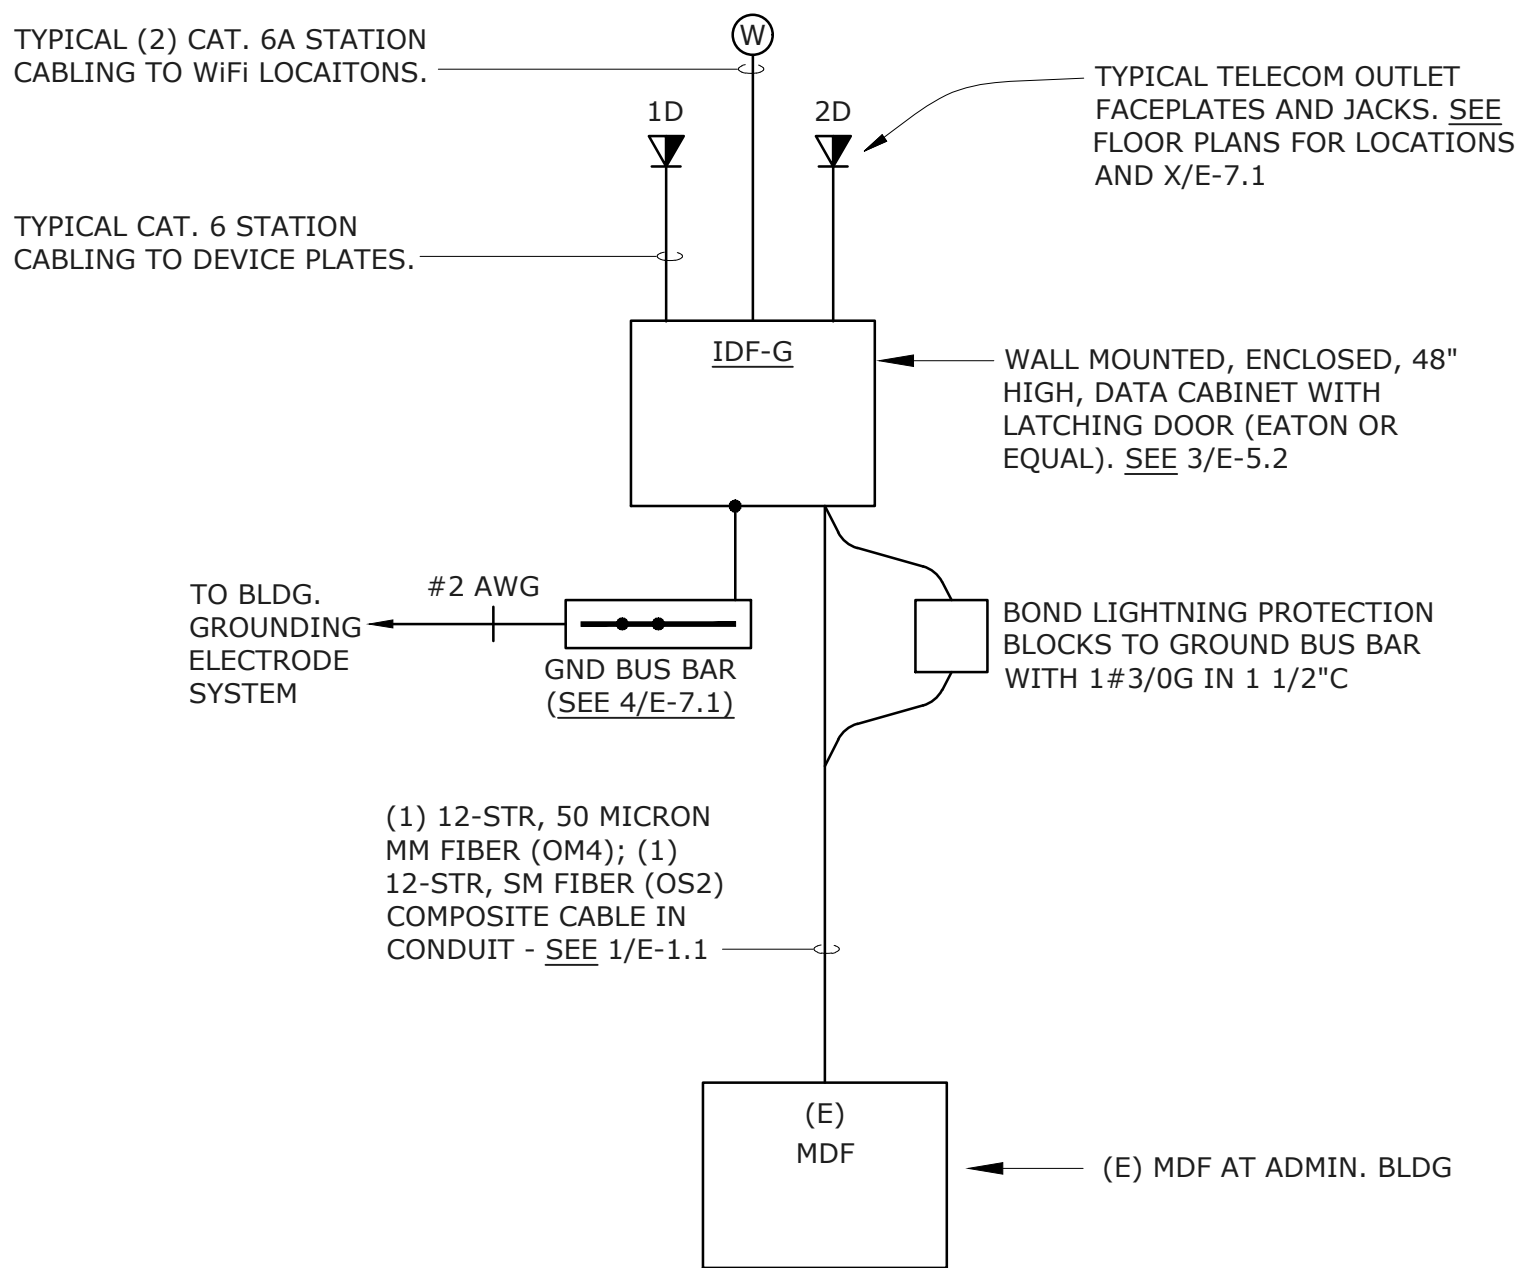


IP TELEPHONE AND DATA SYSTEM RISER DIAGRAM  
SCALE: NONE

2  
E-5.2

### CLOCK / SPEAKER SYSTEM RISER DIAGRAM

SCALE: NONE

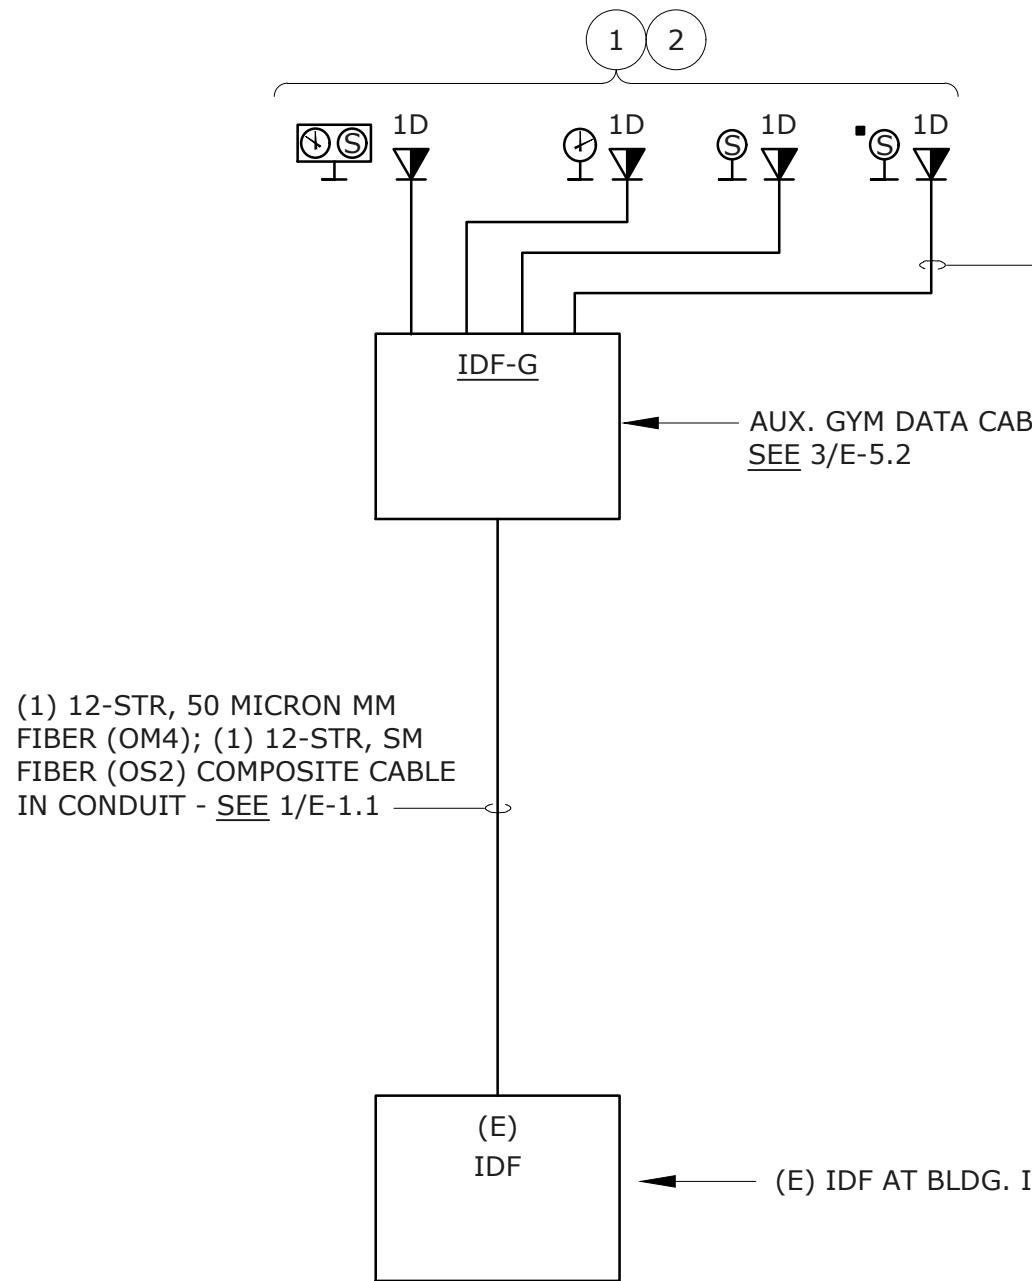

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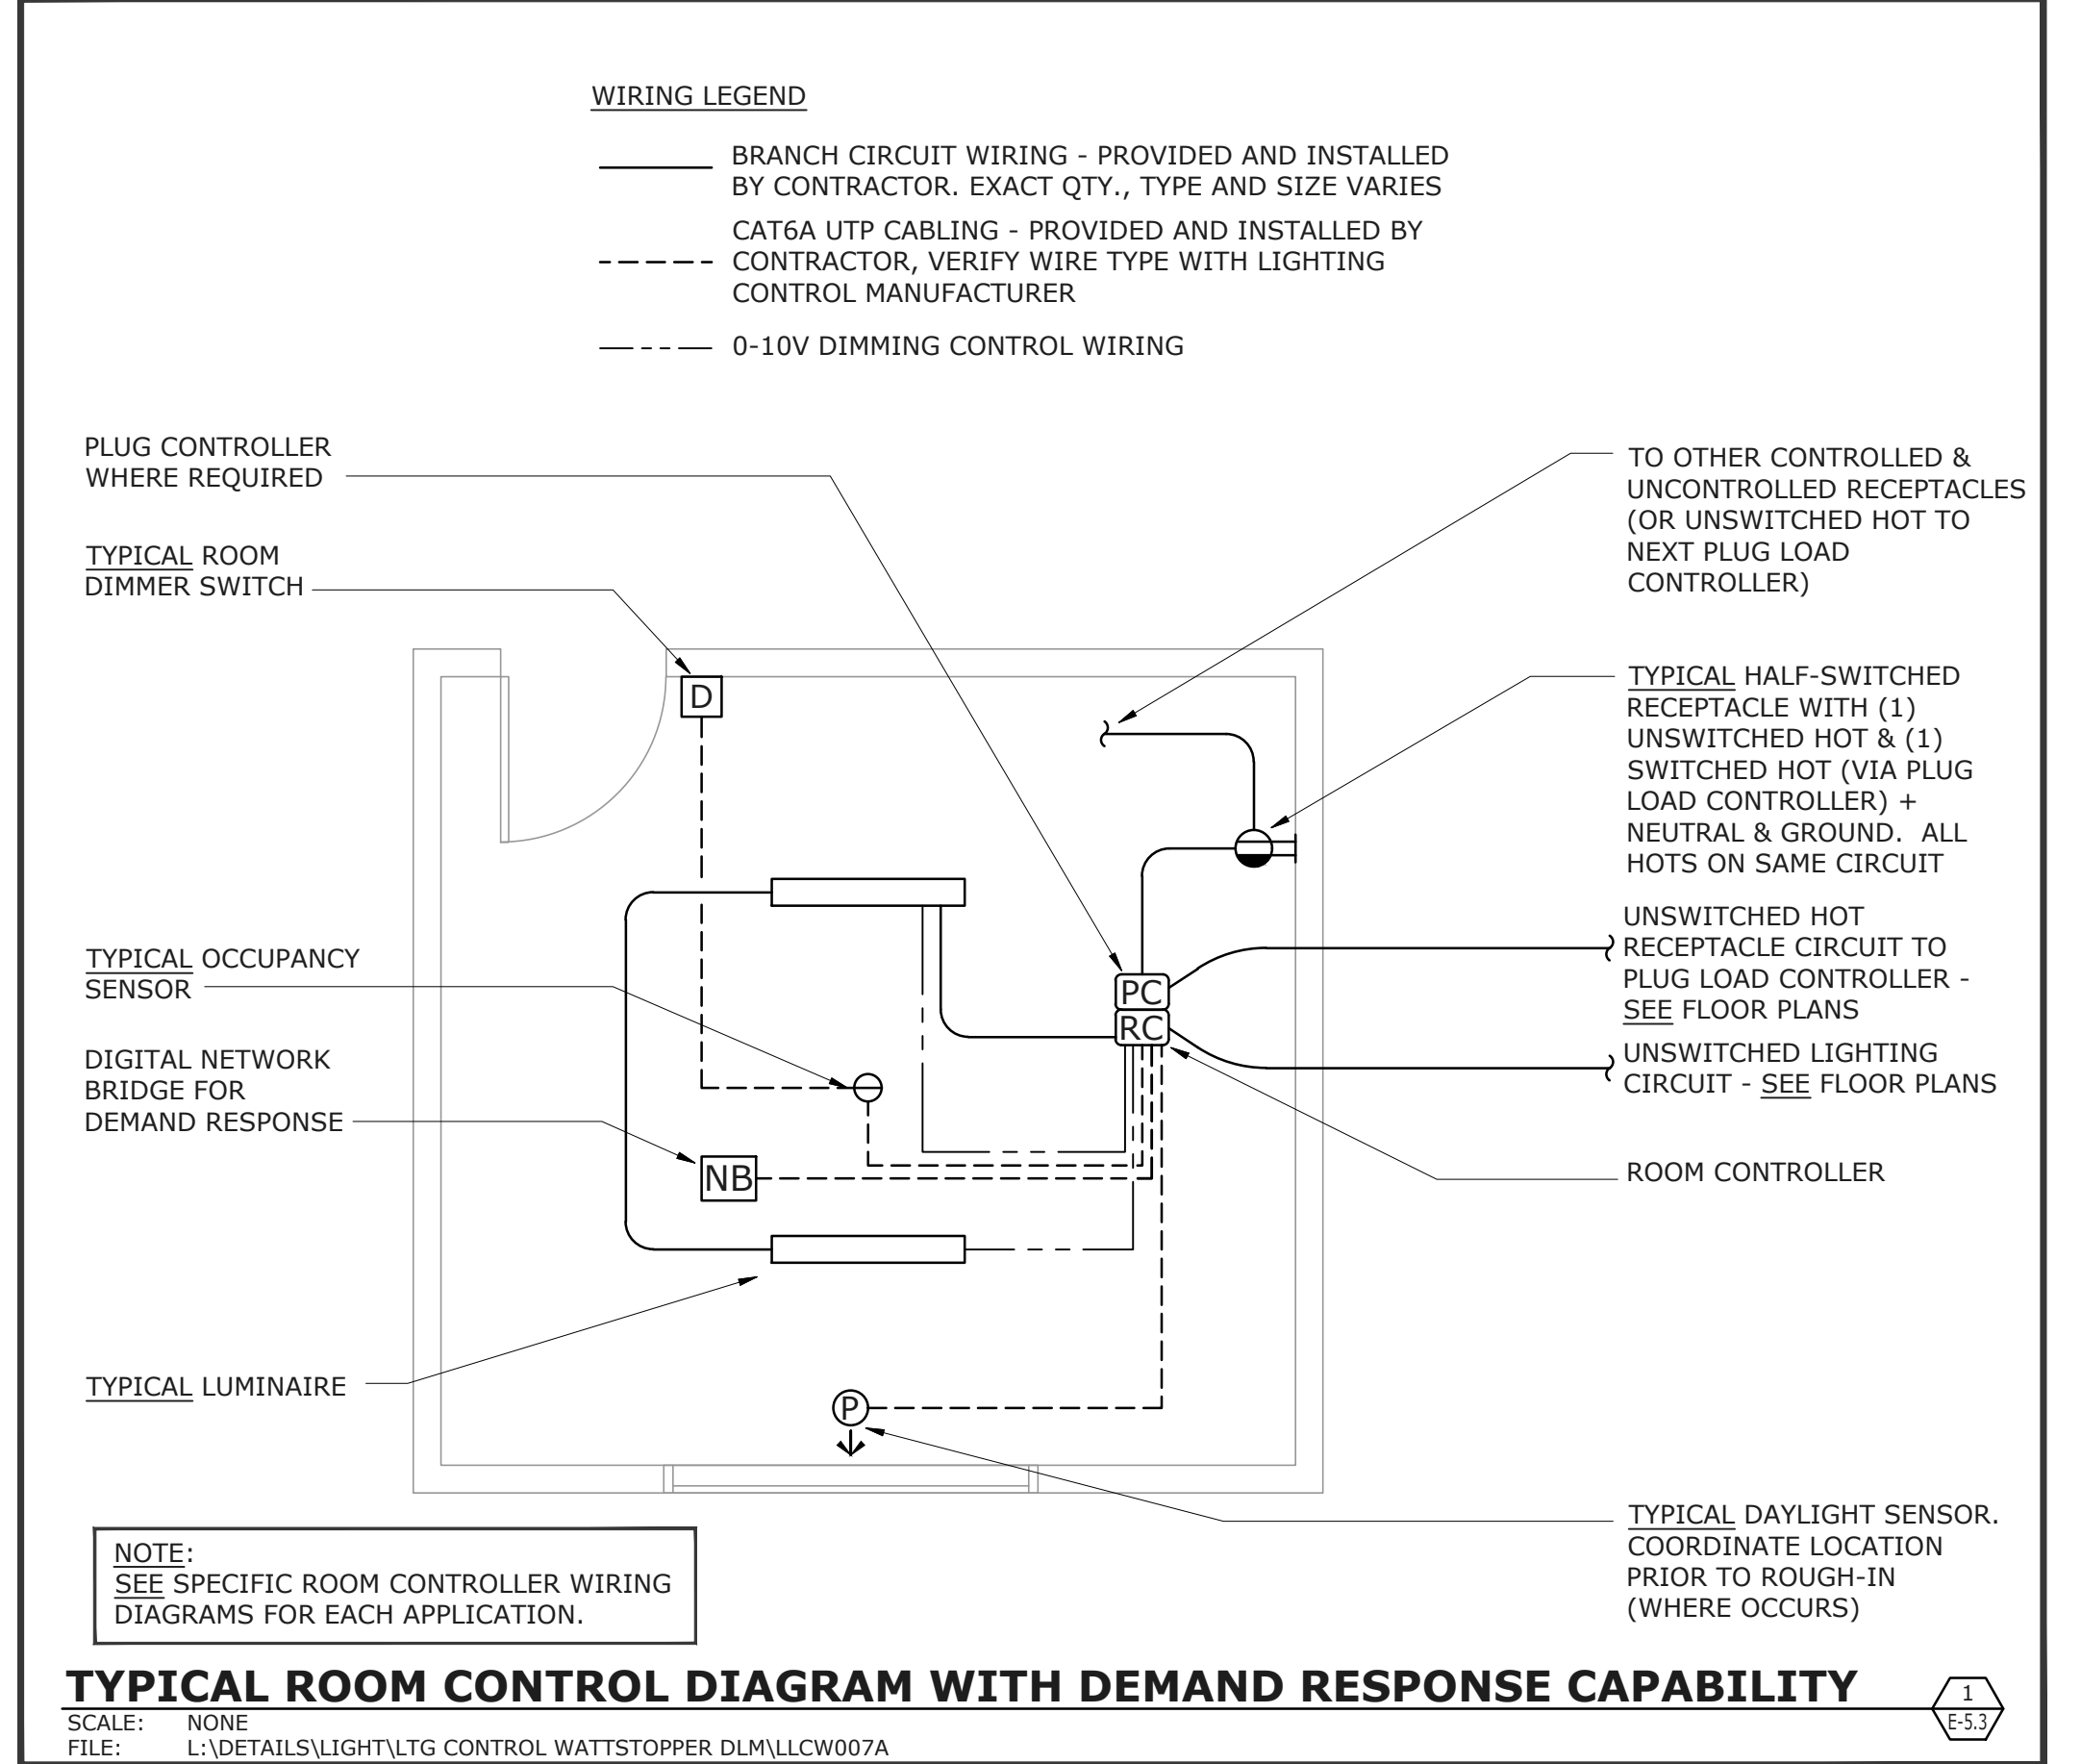
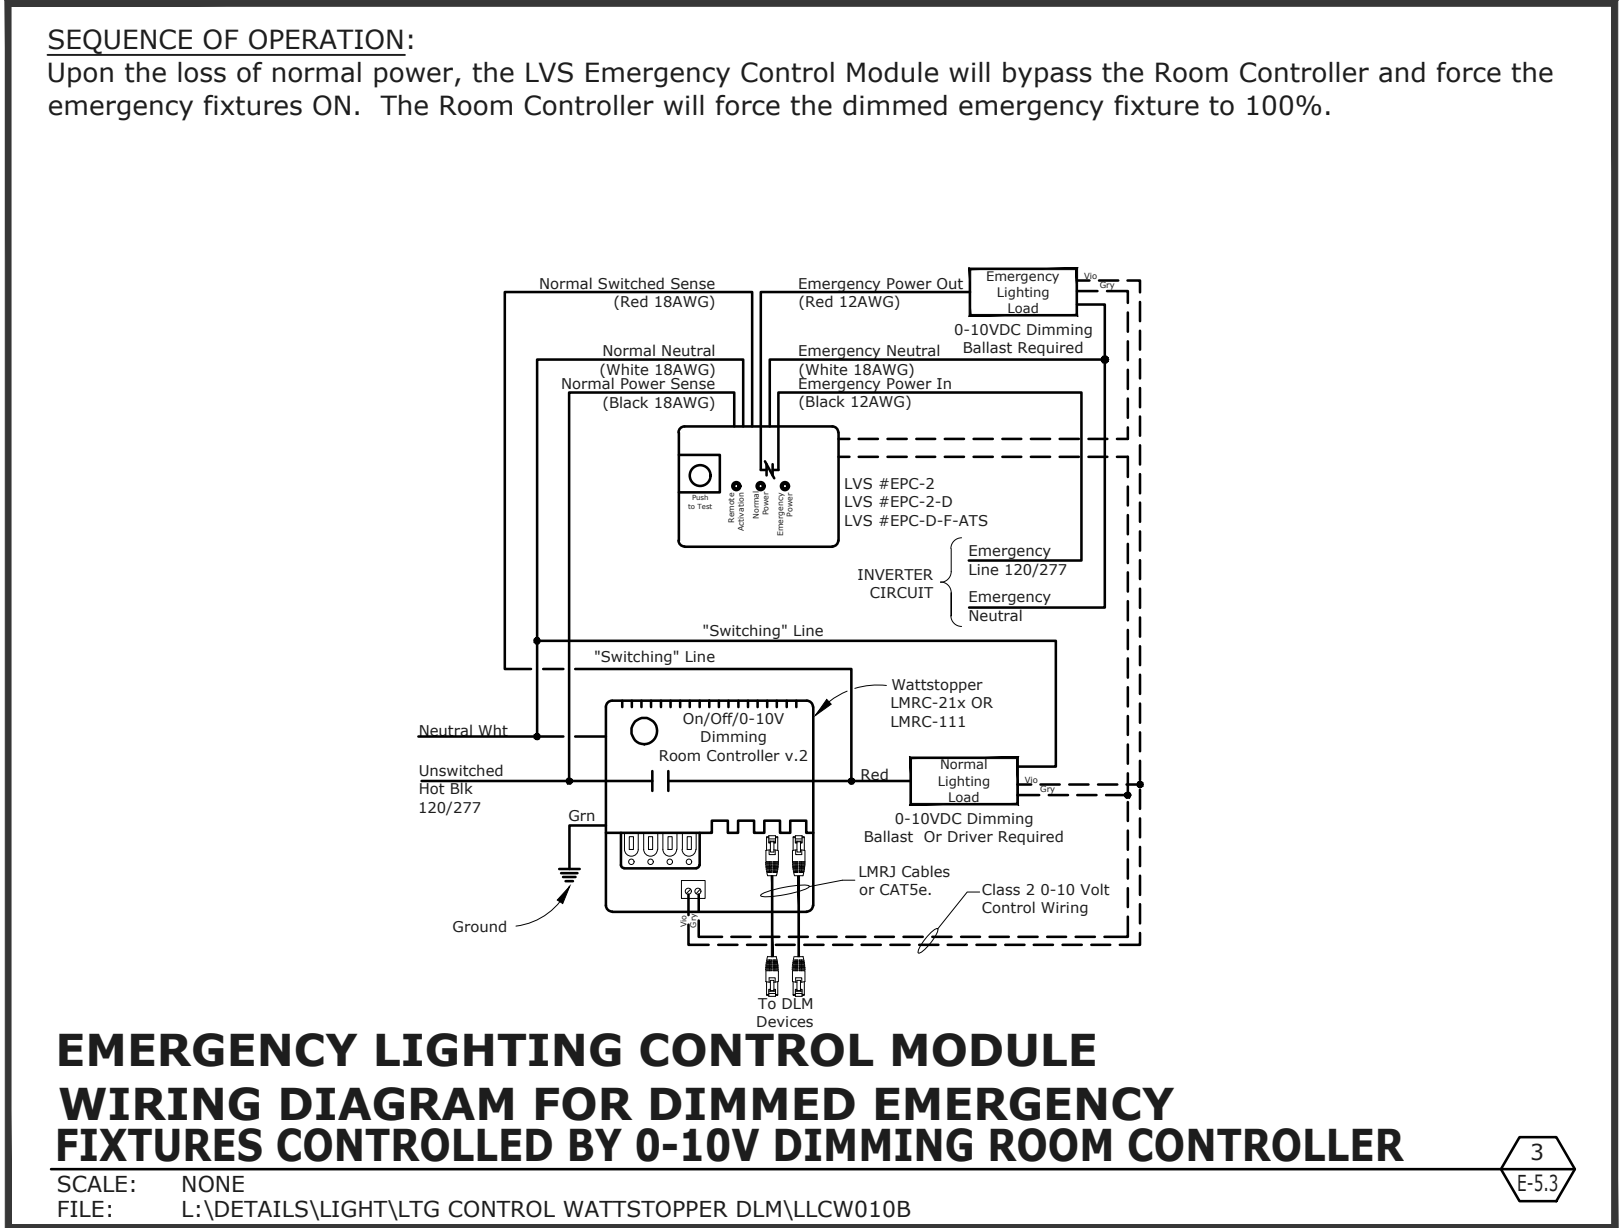
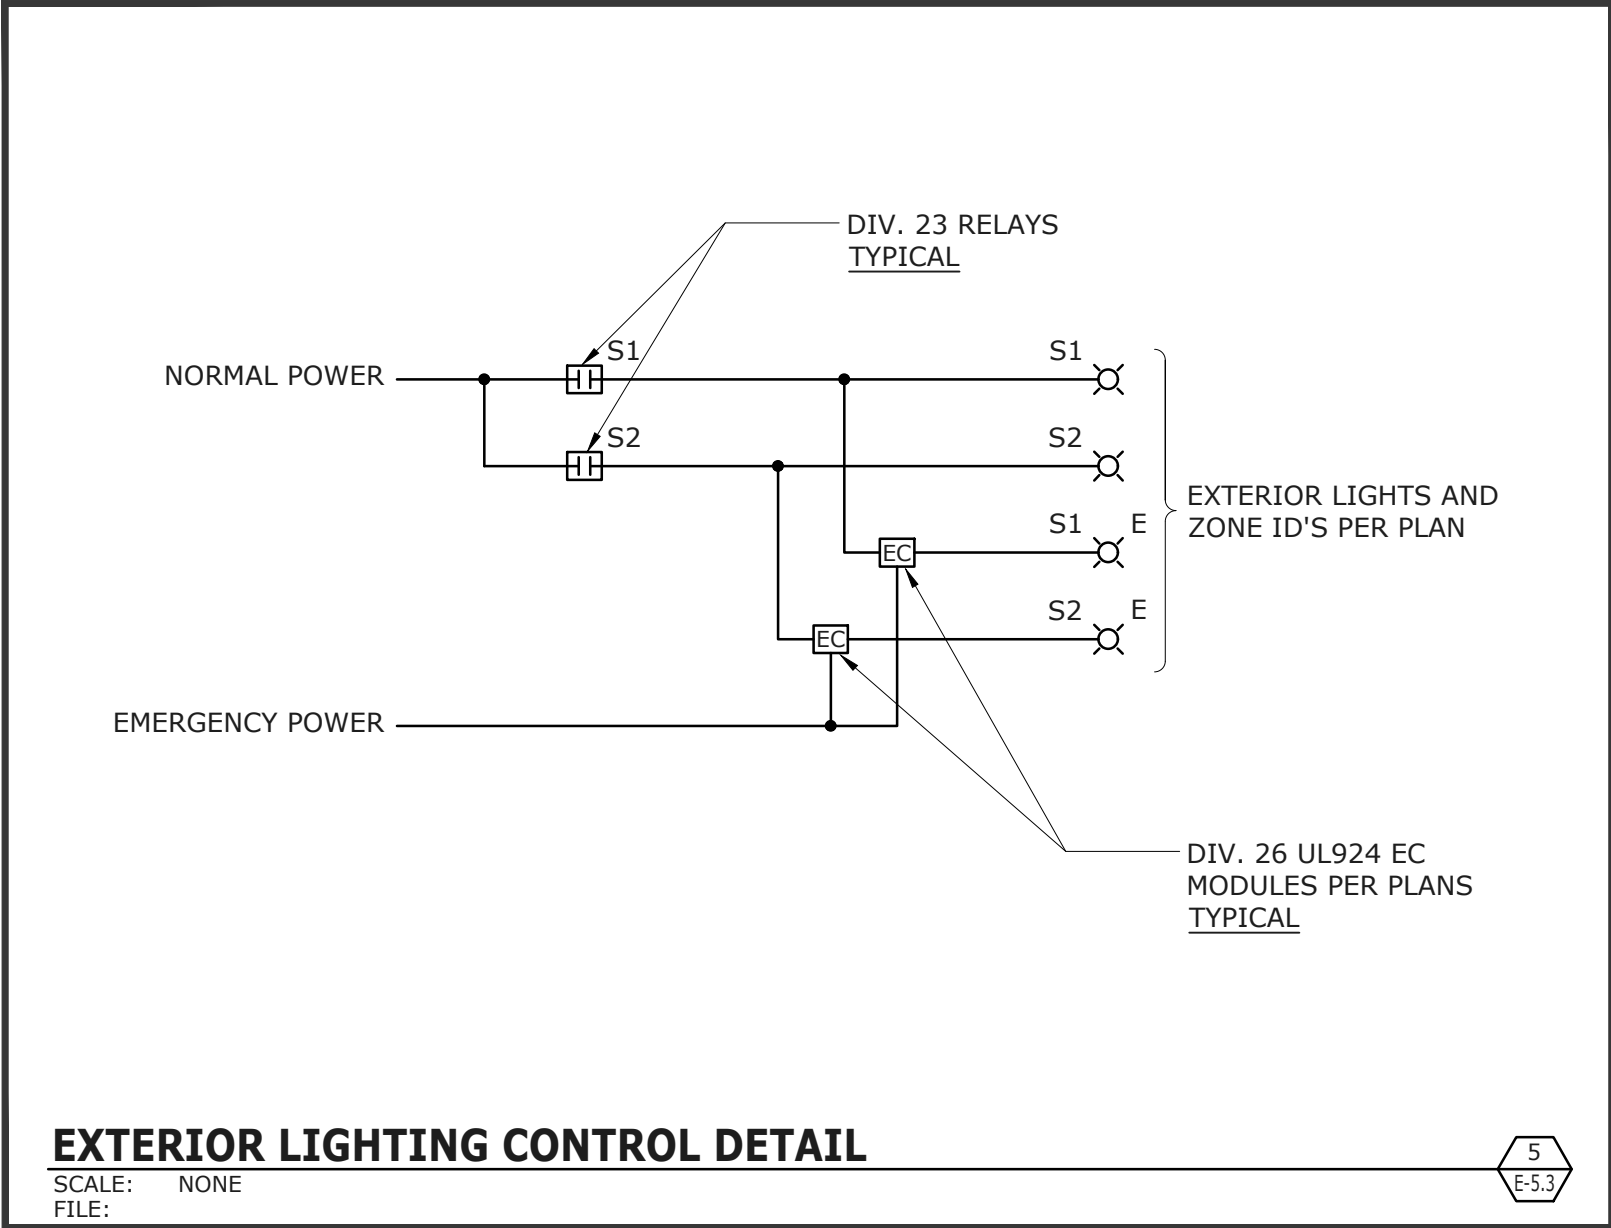
**SINGLE LINE DIAGRAMS - SIGNAL**

SHEET NUMBER



**E-5.2**



LIGHTING CONTROL SEQUENCE OF OPERATIONS										
SPACE TYPE	OCC SENSOR SETPOINT	PHOTOCELL SETPOINT	NORMAL BUSINESS HOURS		AFTER HOURS		TIME SCHEDULE OVERRIDE			AUTOMATIC DEMAND RESPONSE
			LIGHTING	RECEPTACLES	LIGHTING	RECEPTACLES	LIGHTING	RECEPTACLES	DURATION	
OFFICE	MANUAL ON TO PREVIOUS LEVEL/OFF IN 20 MIN	NA	MANUAL ON/OFF BY OCCUPANCY SENSOR	ON/OFF BY OCCUPANCY SENSOR	SAME AS DURING NORMAL BUSINESS HOURS	ON/OFF BY OCCUPANCY SENSOR	NA	NA	NA	NOT REQUIRED
ELECTRIC/ CUSTODIAN	MANUAL ON/OFF	NA	MANUAL ON/OFF	NOT REQUIRED TO BE CONTROLLED	SAME AS DURING NORMAL BUSINESS HOURS	NOT REQUIRED TO BE CONTROLLED	NA	NA	NA	NOT REQUIRED
HALL	AUTO ON/ OFF IN 20 MIN	NA	DIMS TO 50% UPON VACANCY	NOT REQUIRED TO BE CONTROLLED	DIMS TO 0% UPON VACANCY	NOT REQUIRED TO BE CONTROLLED	MANUAL SWITCH	NA	2 HR	NOT REQUIRED
ELECTRICAL EQUIPMENT ROOMS	MANUAL ON/OFF	NA	ON/OFF VIA MANUAL CONTROLS	NOT REQUIRED TO BE CONTROLLED	SAME AS DURING NORMAL BUSINESS HOURS	NOT REQUIRED TO BE CONTROLLED	NA	NA	NA	NOT REQUIRED
STORAGE	MANUAL ON/ OFF IN 20 MIN	NA	ON/OFF PER OCCUPANCY SENSOR, ON/DIM/OFF VIA MANUAL CONTROLS	NOT REQUIRED TO BE CONTROLLED	SAME AS DURING NORMAL BUSINESS HOURS	NOT REQUIRED TO BE CONTROLLED	NA	NA	NA	NOT REQUIRED
CLASSROOM	MANUAL ON/ OFF IN 20 MIN	75 FC AT WORKPLANE	ON/OFF PER OCCUPANCY SENSOR, DIM VIA MANUAL CONTROLS	NOT REQUIRED TO BE CONTROLLED	SAME AS DURING NORMAL BUSINESS HOURS	NOT REQUIRED TO BE CONTROLLED	NA	NA	NA	NOT REQUIRED
GYM	NA	60 FC AT FLOOR	SCHEDULED ON, ON/DIM/OFF VIA MANUAL CONTROLS	NOT REQUIRED TO BE CONTROLLED	SCHEDULED OFF, ON/DIM/OFF VIA MANUAL CONTROLS	NOT REQUIRED TO BE CONTROLLED	MANUAL SWITCH	NA	2 HR	NOT REQUIRED
RESTROOMS	WALL SENSOR MANUAL ON/OFF IN 20 MIN.	NA	MANUAL ON/OFF PER OCCUPANCY SENSOR	NOT REQUIRED TO BE CONTROLLED	SAME AS DURING NORMAL BUSINESS HOURS	NOT REQUIRED TO BE CONTROLLED	NA	NA	NA	NOT REQUIRED
EXTERIOR LIGHTS, ZONES S1	NA	NA		NA	CONTROLLED BY DISTRICT BMS VIA RELAY PROVIDED BY DIV 23, ON DUSK TO LATE EVENING.	NA	ON/OFF VIA MANUAL CONTROL BY DIV 23	NA	2 HR	NOT REQUIRED
EXTERIOR LIGHTS, ZONES S2	NA	NA		NA	CONTROLLED BY DISTRICT BMS VIA RELAY PROVIDED BY DIV 23, ON DUSK TO DAWN.	NA	ON/OFF VIA MANUAL CONTROL BY DIV 23	NA	2 HR	NOT REQUIRED
NOTES:			1. THE INTENT OF THIS SCHEDULE IS TO CLARIFY THE PROGRAMMING AND FUNCTION OF CONTROLS THAT MAY BE LOCATED IN EACH SPACE TYPE. 2. THIS SCHEDULE IS NOT INTENDED TO DEFINE WHICH CONTROLS ARE TO BE INSTALLED IN EACH SPACE TYPE. 3. FOR ACTUAL CONTROL DEVICES TO BE INSTALLED IN EACH SPACE, REFER TO PLANS. 4. ALL SETPOINTS AND TIME SCHEDULES TO BE VERIFIED WITH OWNER PRIOR TO PROGRAMMING. 5. ALL LIGHTING CONTROL DEVICES TO BE CALIBRATED AND COMPLIANCE PERFORMANCE TESTED PER SPECIFICATION SECTION 26 0800 PARAGRAPH 3.2.							



- INVERTER UNIT SPECIFICATIONS**
- ALL EMERGENCY SOURCE CIRCUITS SHALL BE INSTALLED IN SEPARATE RACEWAYS (FROM NORMAL POWER), PER 2017 NEC 700.10(B), OR APPLICABLE CODE AT THE TIME OF PERMITTING.
  - REFER ALSO TO SPECIFICATIONS SECTION 265101. UNITS SHALL BE MYERS POWER PRODUCTS ILLUMINATOR SERIES EM OR APPROVED EQUAL:  
1-EM-3-S-BA2003-M-Z-2YW
  - UNITS SHALL BE 120V 1PH 2W INPUT, 120V OUTPUT WITH 20AMP OUTPUT CIRCUIT BREAKER, RATED AS FOLLOWS:  
2.2KVA
  - INPUT SHALL BE EQUIPPED WITH ANSI 62-41 SURGE PROTECTION AND 1HZ NOMINAL SYNCHRONIZING SLEW RATE.
  - OUTPUT VOLTAGE STATIC REGULATION SHALL BE +/- 5% FOR 100% RESISTIVE LOAD.
  - OUTPUT DISTORTION SHALL BE 5% THD MAXIMUM.
  - OVERLOAD RATING: 150% MOMENTARY; 120% FOR 5 MINUTES.
  - TRANSFER TIME: NO BREAK
  - BATTERY SHALL BE SEALED LEAD CALCIUM, 10 YEAR LIFE, 90 MINUTE RUN TIME, WITH AUTO-DISCONNECT FOR LOW BATTERY VOLTAGE.
  - PROVIDE RS232 PORT FOR EXTERNAL COMMUNICATIONS.
  - INVERTER SHALL BE PWM TYPE.
  - PROVIDE MAINTENANCE BYPASS.
  - PROVIDE IN NEMA 1 ENCLOSURE, FRONT ACCESS ONLY.
  - PROVIDE FACTORY STARTUP AND TEST OF UNIT TO THE SATISFACTION OF BUILDING INSPECTION AUTHORITIES AND WITH MAXIMUM 4 HOURS OF PERSONNEL TRAINING FOLLOWING STARTUP.
  - AUTO SELF TESTING.
  - PROVIDE OUTPUT CIRCUIT BREAKERS RATED 20AMPS EACH WITH DEDICATED CIRCUITS FOR EACH OF THE EMERGENCY LIGHTING LOADS:  
4 OUTPUT BREAKERS
  - SEISMIC QUALIFIED.
  - SUBMIT FOR REVIEW AND APPROVAL.
  - PROVIDE DRY CONTACT CLOSURE OUTPUT WHEN NORMAL POWER IS OFF AND INVERTER IS RUNNING ON BATTERY. CONTACT CLOSURE WILL BE USED TO BYPASS LIGHTING CONTROLS AND BRING EMERGENCY LIGHTS TO FULL BRIGHTNESS.
  - INVERTER SHALL BE UL924 LISTED.

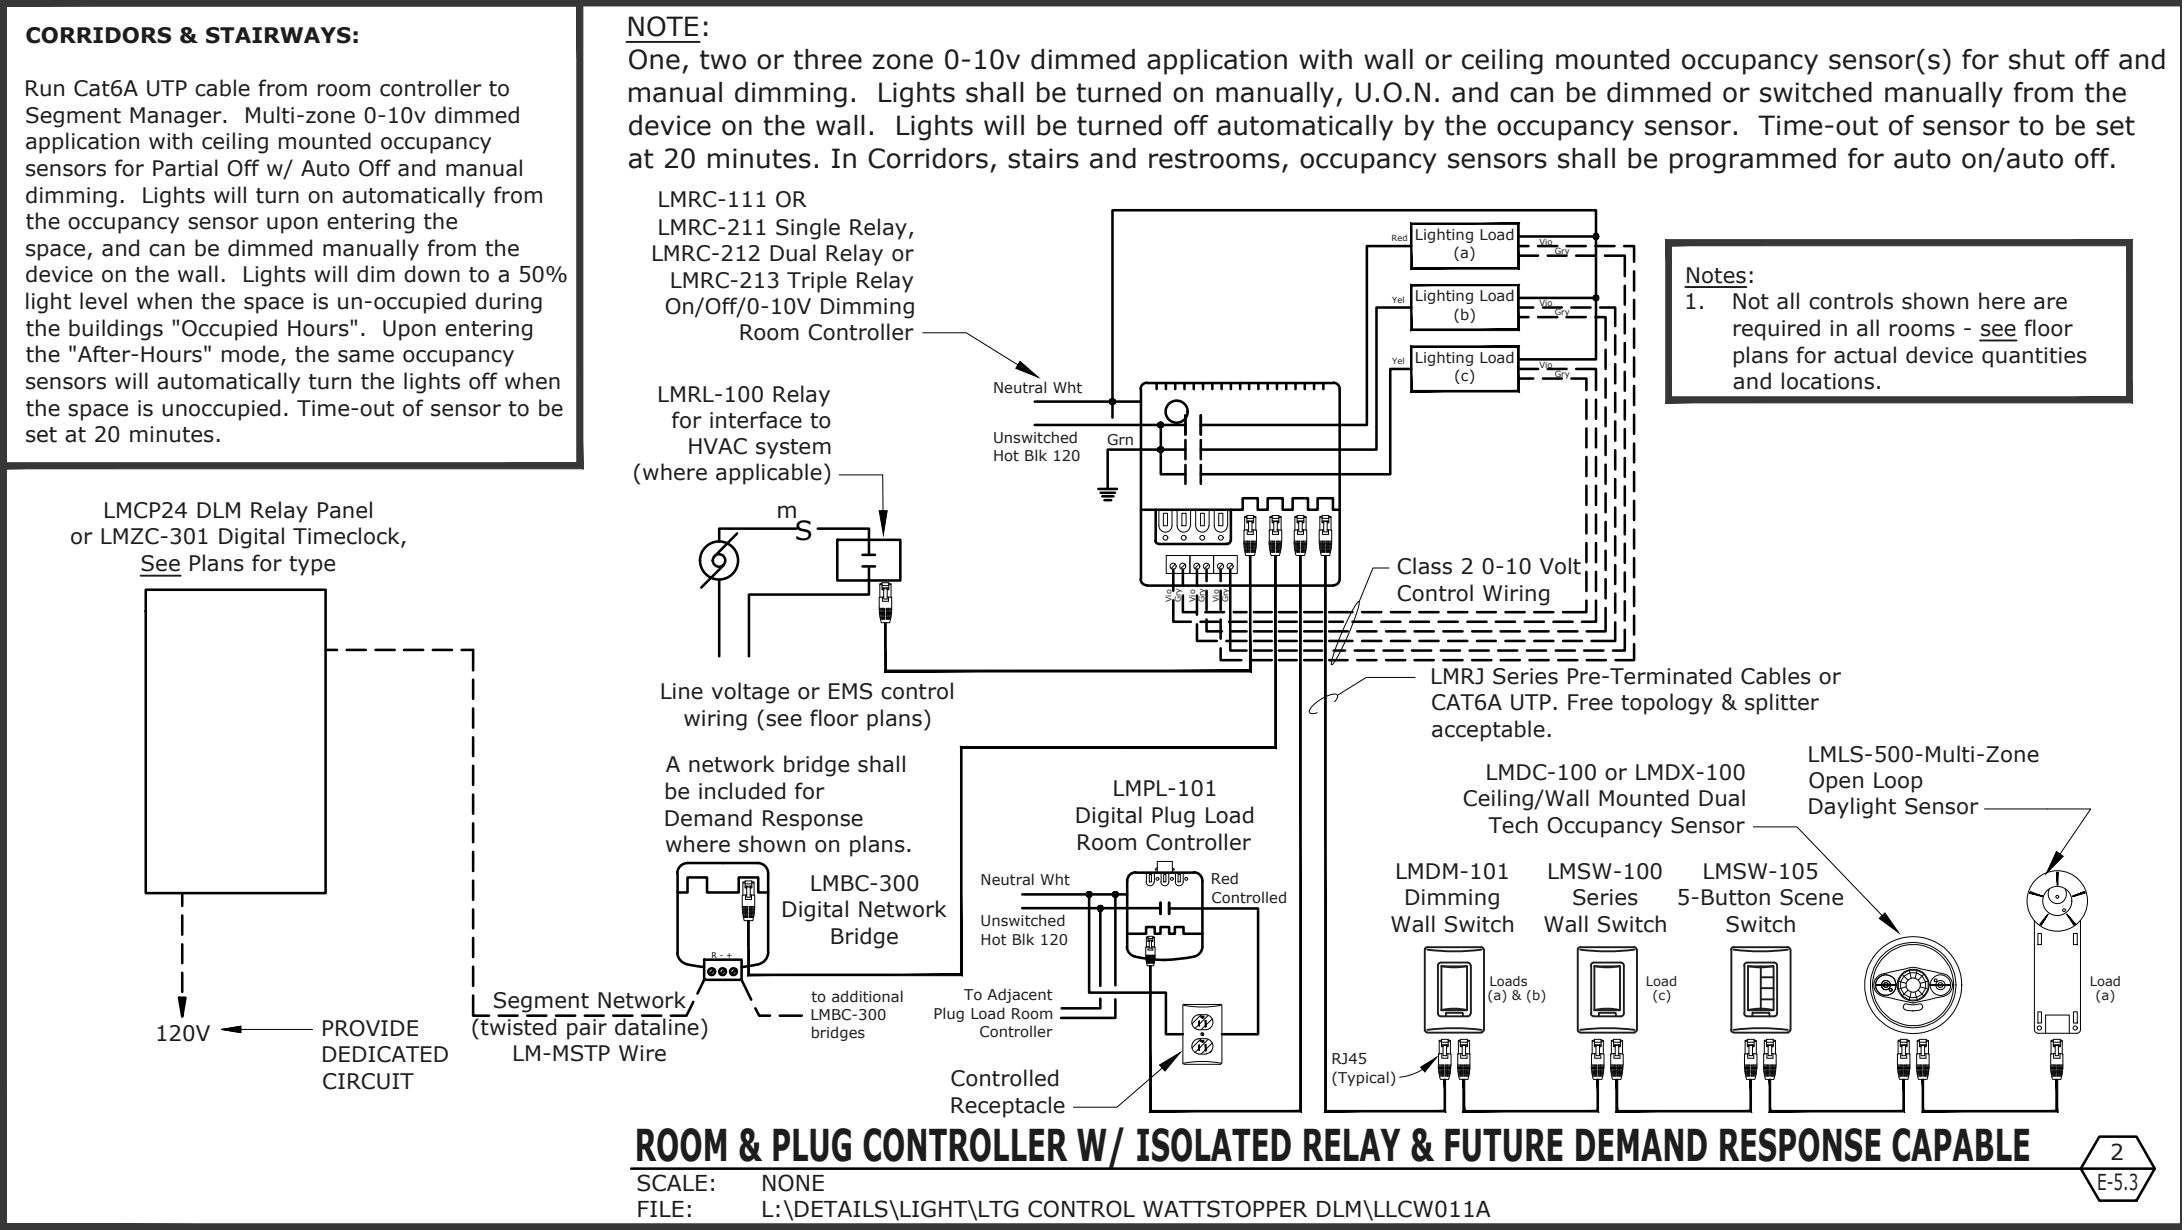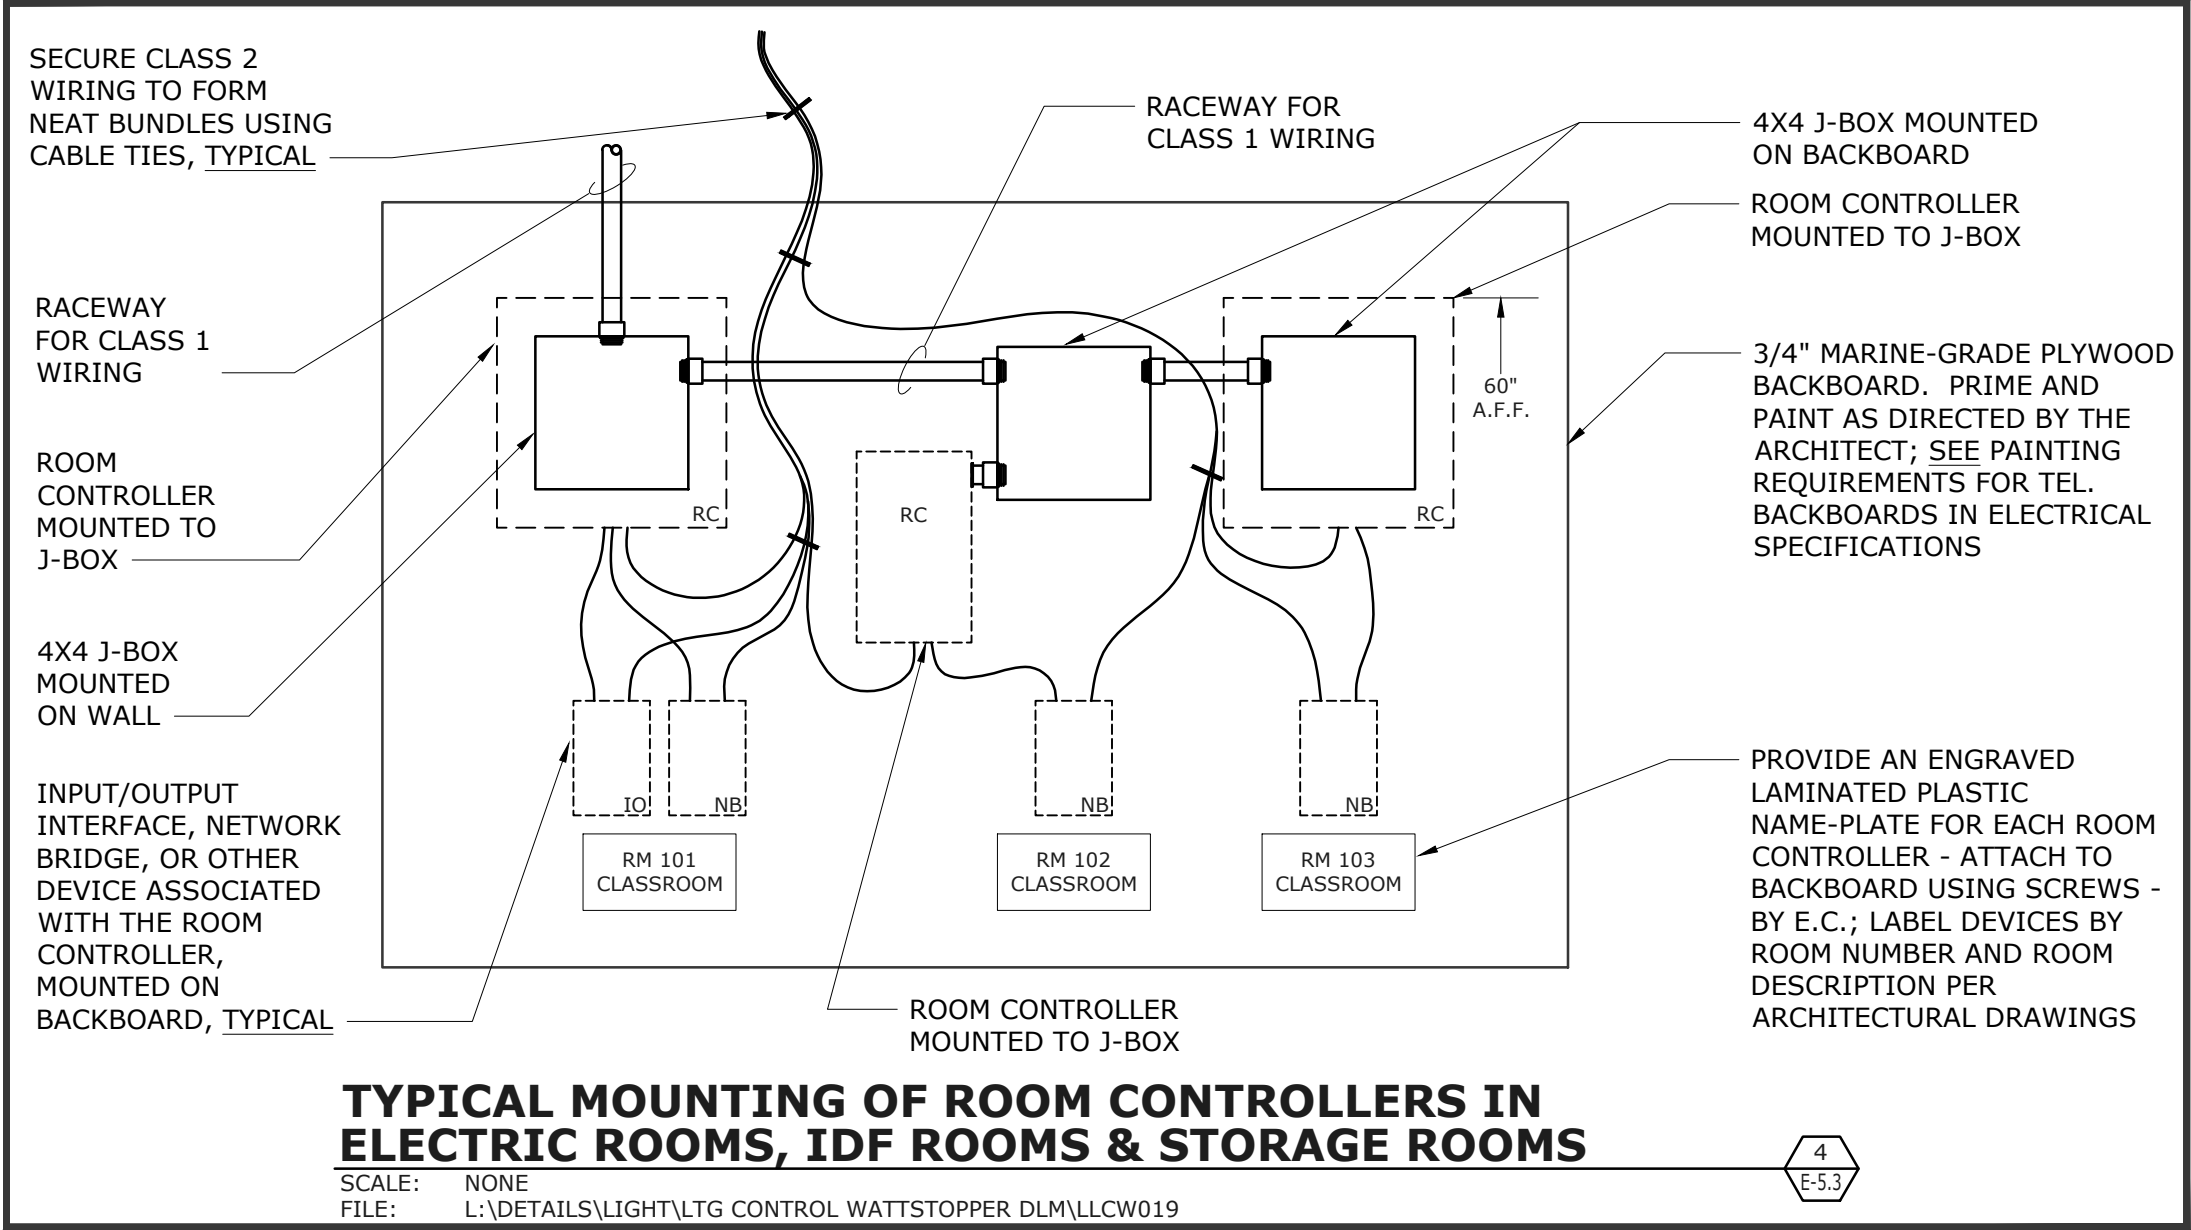

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**P. O'Mahony**  
REGISTERED PROFESSIONAL ELECTRICAL ENGINEER  
No. 14738  
Exp. 6/31  
ELECTRICAL  
STATE OF CALIFORNIA

**FREEDOM HIGH SCHOOL**

**NEW AUXILIARY GYMNASIUM**

1050 NEROLY RD,  
OAKLEY, CA 94561

**LIBERTY UNION HIGH SCHOOL DISTRICT**

REVISIONS


DSA APP NO. 01-119278

ARCH PROJECT NO: 1869.00

DRAWN BY: LN,TV,JW,OOM

DRAWING SCALE: AS NOTED

PTN: 61721-78 FILE NO: 7-H4

BID DOCUMENT

APRIL 27, 2021

SHEET TITLE

**LIGHTING CONTROL DIAGRAMS**

SHEET NUMBER

**E-5.3**



[illegible]

PANEL LM1

VOLTS:120 / 208

PHASE:3 PH

WIRE:4 W

BUSING:225A

POLES:84P

MAINS:225A MCB

FEEDER:SEE SINGLE LINE

CONDUIT:SEE SINGLE LINE

MOUNTED:SURFACE

A/C RATING:10K

LOAD DESCRIPTION	TYPE	A	B	C	BRKR.	CKT.	CKT.	BRKR.	A	B	C	TYPE	LOAD DESCRIPTION	
ELEC 109 - IDF	M	1.00			20/1	1	2	20/1	1.50			L	107, 110, 111	
ELEC 109 - INM	M		1.00		20/1	3	4	20/1		0.51		L	EXTERIOR	
STORAGE 110 - RAMP-M	M			0.48	20/1	5	6	20/1			1.48	L	AUXILIARY GYMNASIUM 101	
STORAGE 110 - LCP	M	0.50			20/1	7	8	20/1	1.48			L	AUXILIARY GYMNASIUM 101	
CLASSROOM 107	R		0.54		20/1	9	10	20/1		1.31		L	101, 102, 103, 104, 105	
CLASSROOM 107	R			0.54	20/1	17	18	20/1			1.00	M	GYM 101 - MOTORIZED BACKBOARDS	
CLASSROOM 107 - PROJECTOR	M	0.70			20/1	13	14	20/1	1.00			M	GYM 101 - MOTORIZED BACKBOARDS	
CLASSROOM 107	M		0.72		20/1	15	16	20/1		1.00		M	GYM 101 - MOTORIZED BACKBOARDS	
104, 105, 106, 110	R			0.72	20/1	17	18	20/1			1.00	M	GYM 101 - MOTORIZED BACKBOARDS	
HALLWAY 102 - WATER FOUNTAIN	M	0.70			20/1	19	20	20/1	1.00			M	GYM 101 - MOTORIZED BACKBOARDS	
OFFICE 103 - STORAGE 111	R		0.72		20/1	21	22	20/1		1.00		M	GYM 101 - MOTORIZED BACKBOARDS	
GYM 101 - SCOREBOARDS, SHOT CLOCK	M			0.36	20/1	23	24	30/1			1.40	M	GYM 101 - MOTORIZED CURTAIN	
GYM 101 - MOTORIZED SOLATUBES	M	0.10			20/1	25	26	30/1	1.40			M	GYM 101 - MOTORIZED CURTAIN	
	M		1.10		20/1	27	28	30/1		0.60		M	STORAGE 110 - AV RACK	
MOTORIZED BLEACHERS	M			1.10	20/1	29	30	20/1			0.60	M	STORAGE 110 - AV RACK	
/	M	1.10			-	31	32	20/1	0.60			M	STORAGE 110 - AV RACK	
GYM 101 - EXTERIOR	R	0.90			20/1	33	34	20/1		0.60		M	STORAGE 110 - AV RACK	
GYM 101	S		0.54		20/1	35	36	20/1			1.20	M	GYM 101 - AV EQUIPMENT	
GYM 101	R	0.54			20/1	37	38	20/1	0.80			M	GYM 101 - AV EQUIPMENT	
GYM 101 - SCORER'S TABLE	R	0.36			20/1	39	40	20/1		0.80		M	GYM 101 - AV EQUIPMENT	
SPARE					20/1	41	42	20/1			0.80	M	GYM 101 - AV EQUIPMENT	
SPARE					20/1	43	44	30/2	2.08			M	GYM 101 - AV EQUIPMENT	
SPARE					20/1	45	46	-			2.08	M	/	
SPARE					20/1	47	48	20/1				/	SPARE	
SPARE					20/1	49	50	-			3.41	M	/	
SPARE					20/1	51	52	100/3		2.85	M	M	PANEL LM2	
SPARE					20/1	53	54	-			2.09	M	/	
			4.64	5.34	3.74					13.25	10.75	9.55		

DEMAND LOAD SUMMARY	CONN KVA	DEMAND FACTOR	DEMAND KVA
TYPE 1*: NON-CONTINUOUS / MISC. LOADS	35.48	100%	35.48
TYPE 2*: LIGHTING / CONTINUOUS LOADS	6.24	100%	7.80
TYPE 3*: RECEPTACLES (FIRST 10KVA)	4.86	100%	4.86
TYPE 4*: RECEPTACLES (OVER 10KVA)	0.00	50%	0.00
TYPE 5*: HVAC / MECHANICAL LOADS	0.00	100%	0.00
TOTALS:	46.58		48.12


PHASE A:17.90 KVA

PHASE B:13.29 KVA


PHASE C:13.29 KVA

149.14 MAX AMPS / PHASE

<

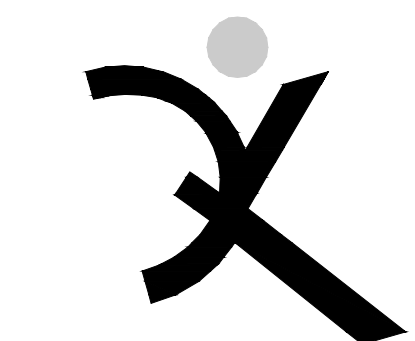

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**FREEDOM  
HIGH SCHOOL**
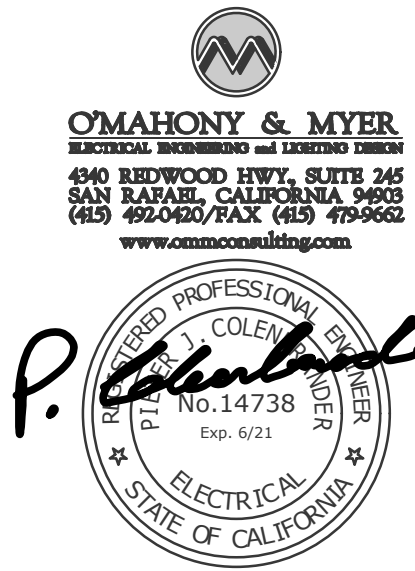
## NEW AUXILIARY GYMNASIUM

1050 NEROLY RD,  
OAKLEY, CA 94561

LIBERTY UNION  
HIGH SCHOOL  
DISTRICT[illegible]

DSA APP NO. 01-119278

ARCH PROJECT NO: 1869.00

DRAWN BY: LN,TV,JWL,NOM

DRAWING SCALE: AS NOTED

PTN: 61721-78 FILE NO: 7-H4

BID DOCUMENT

APRIL 27, 2021










SHEET TITLE

## PANEL SCHEDULES

SHEET NUMBER

## E-6.1



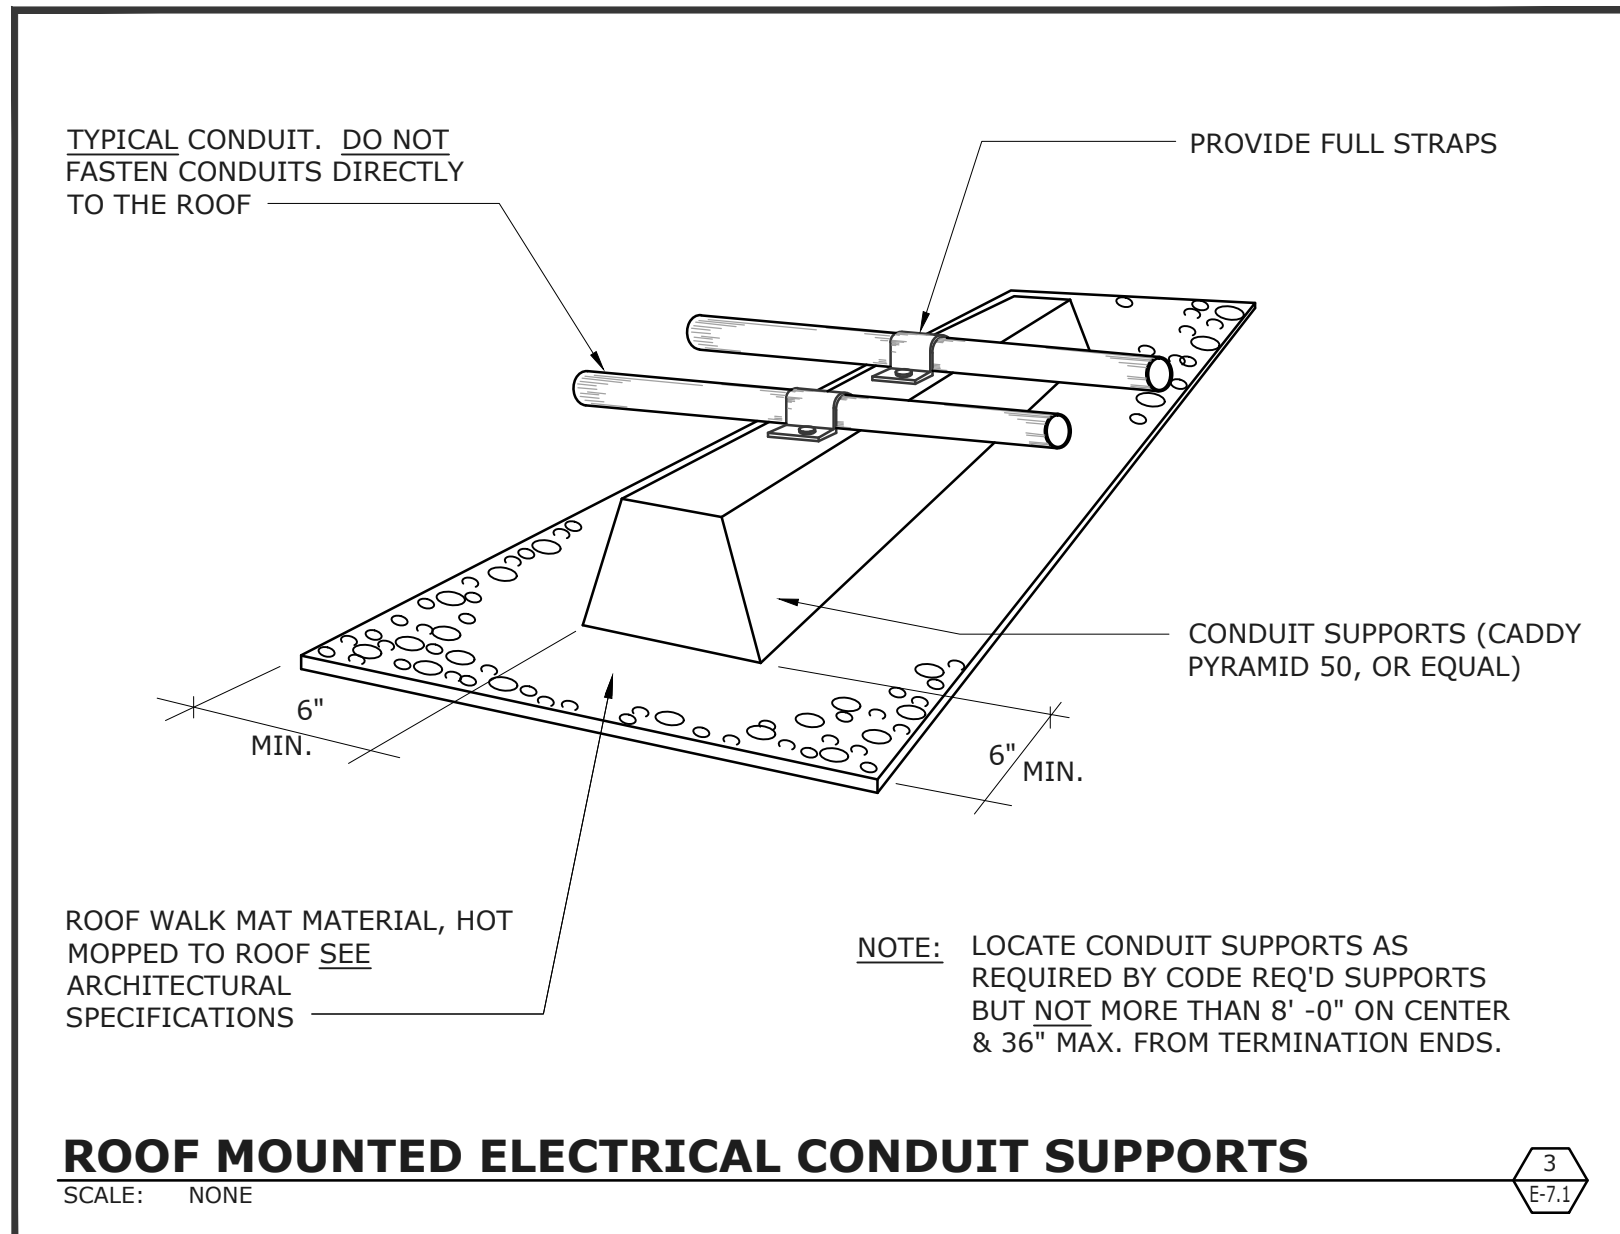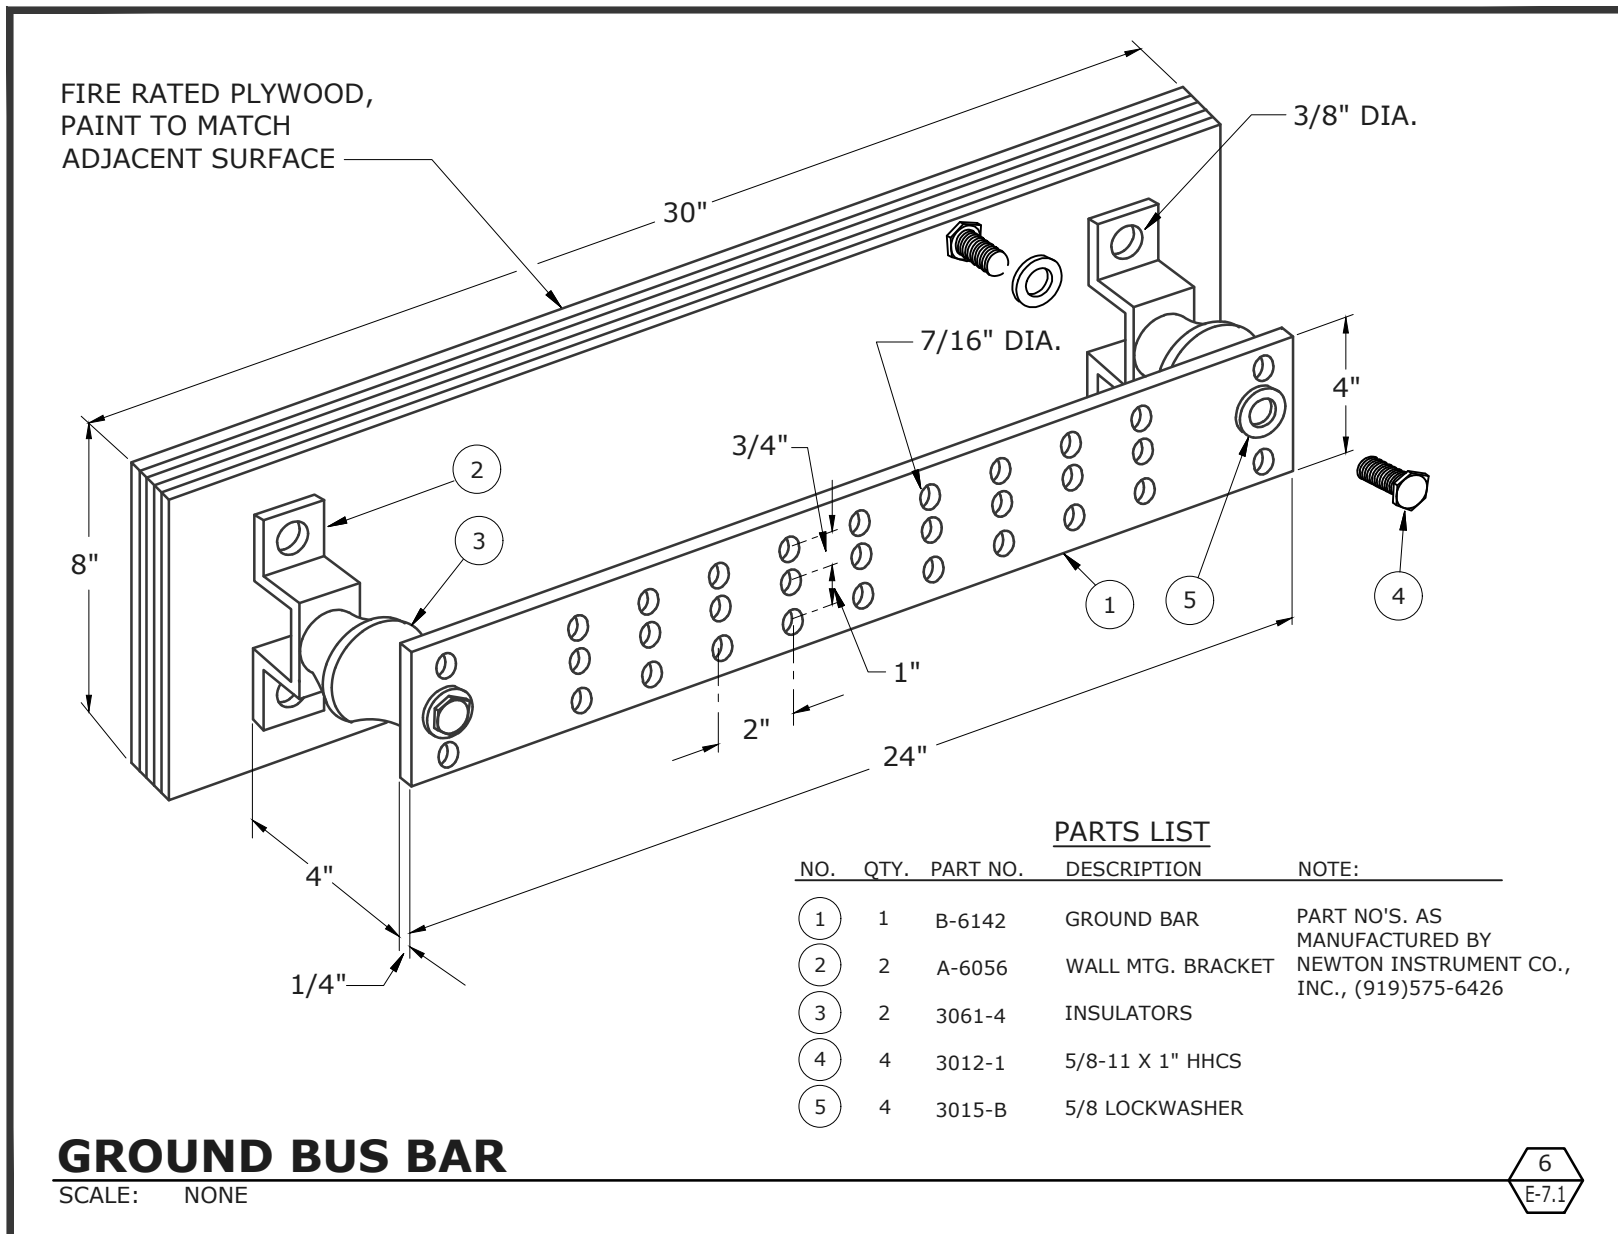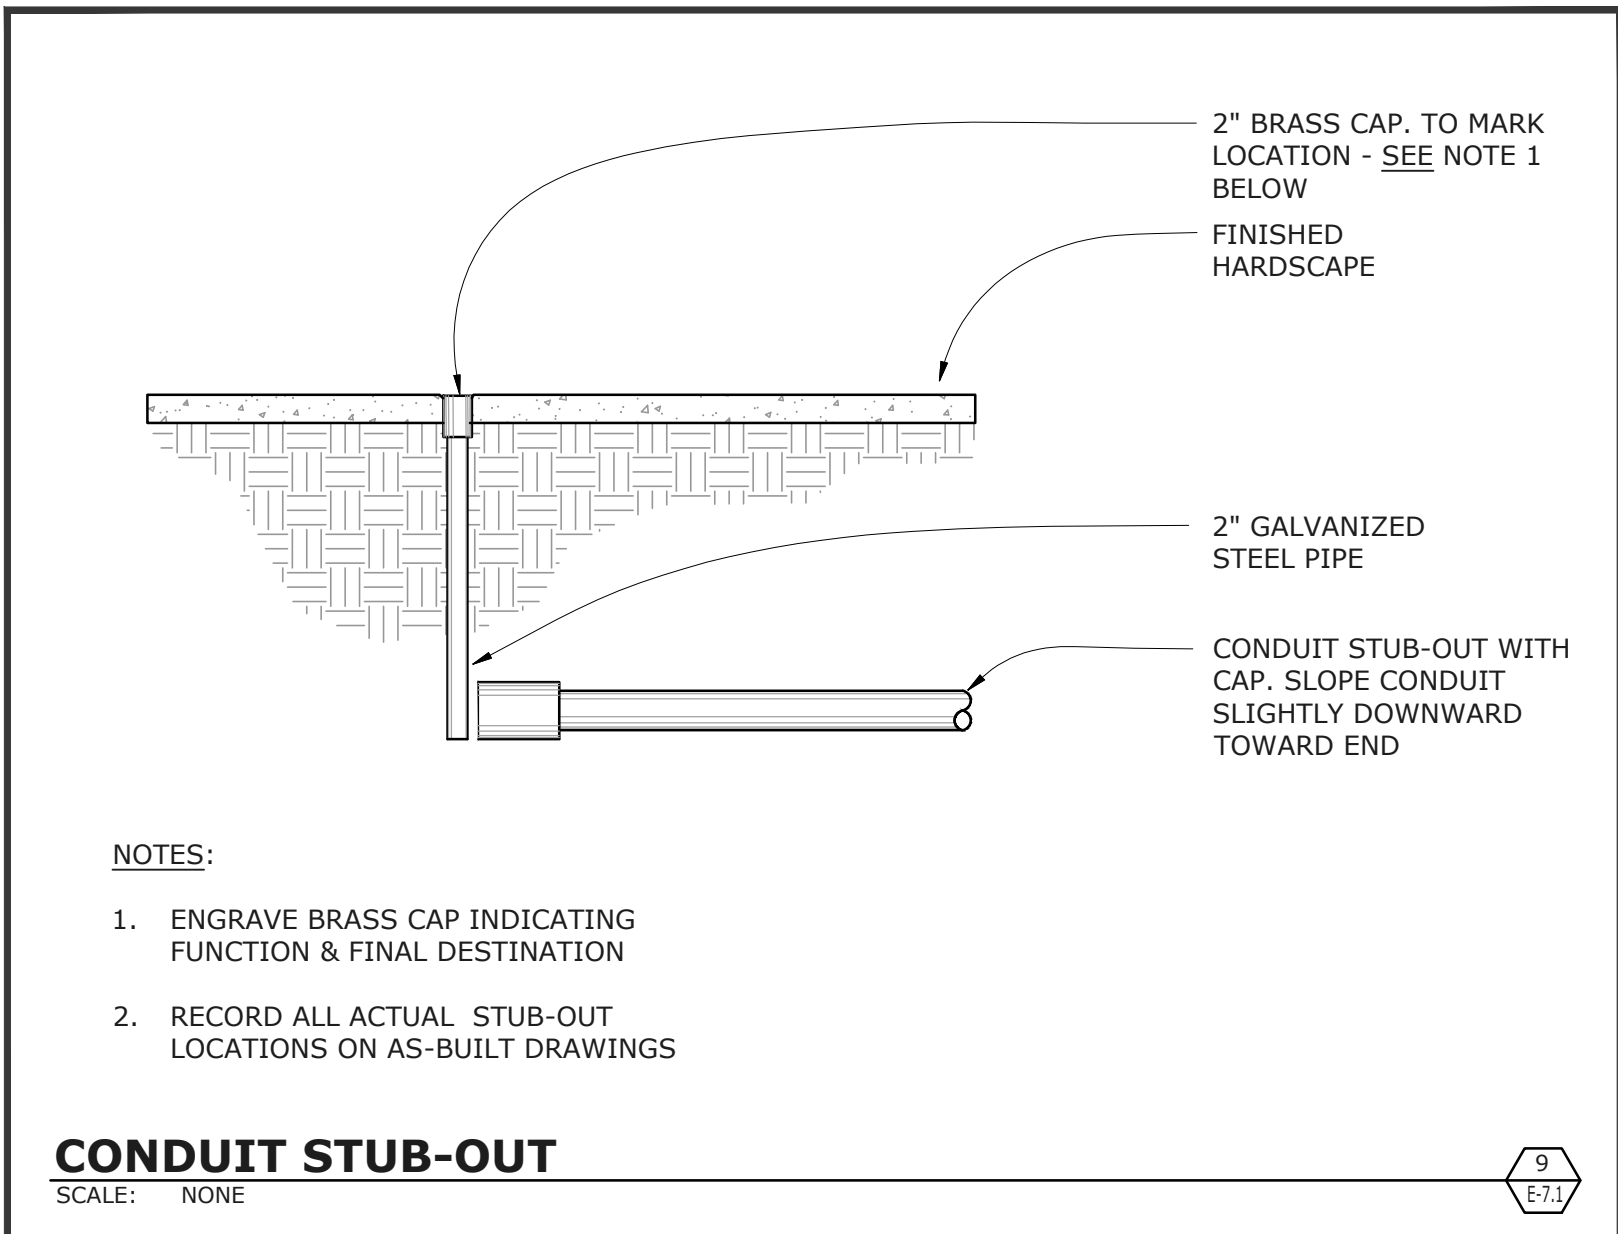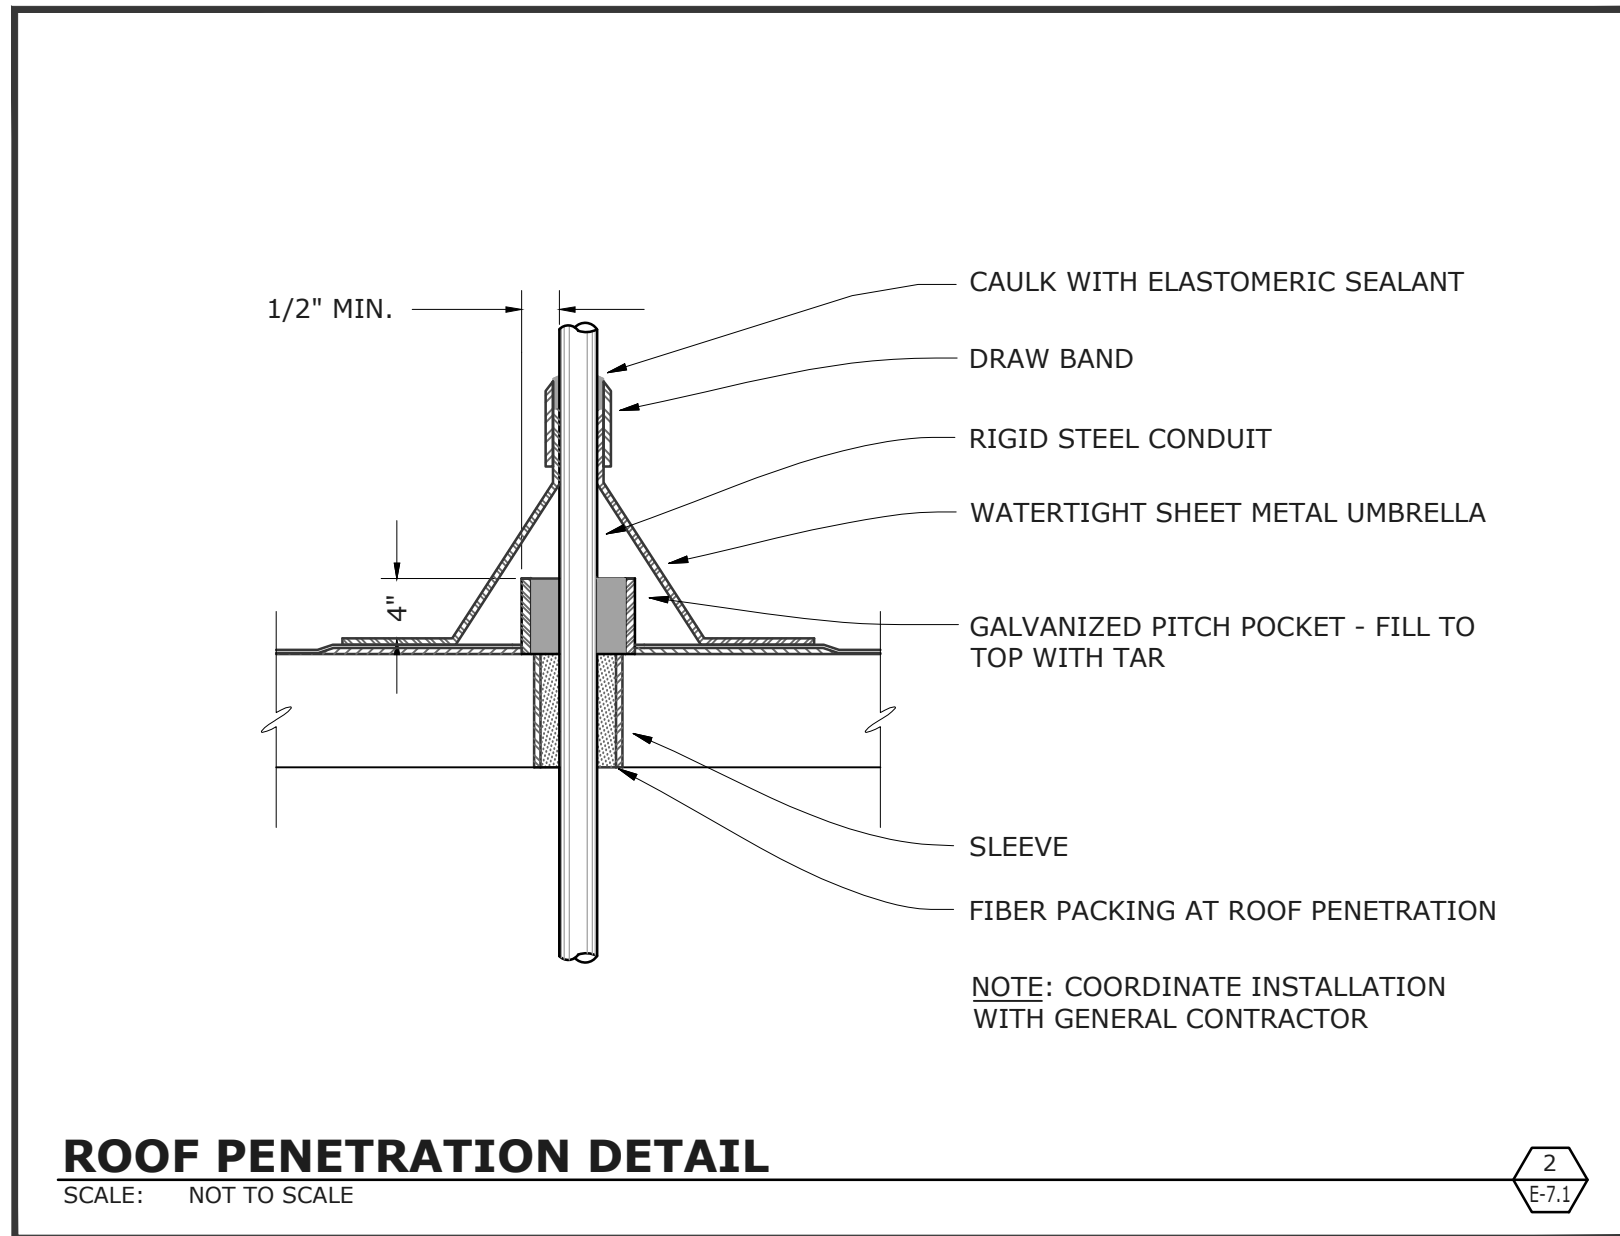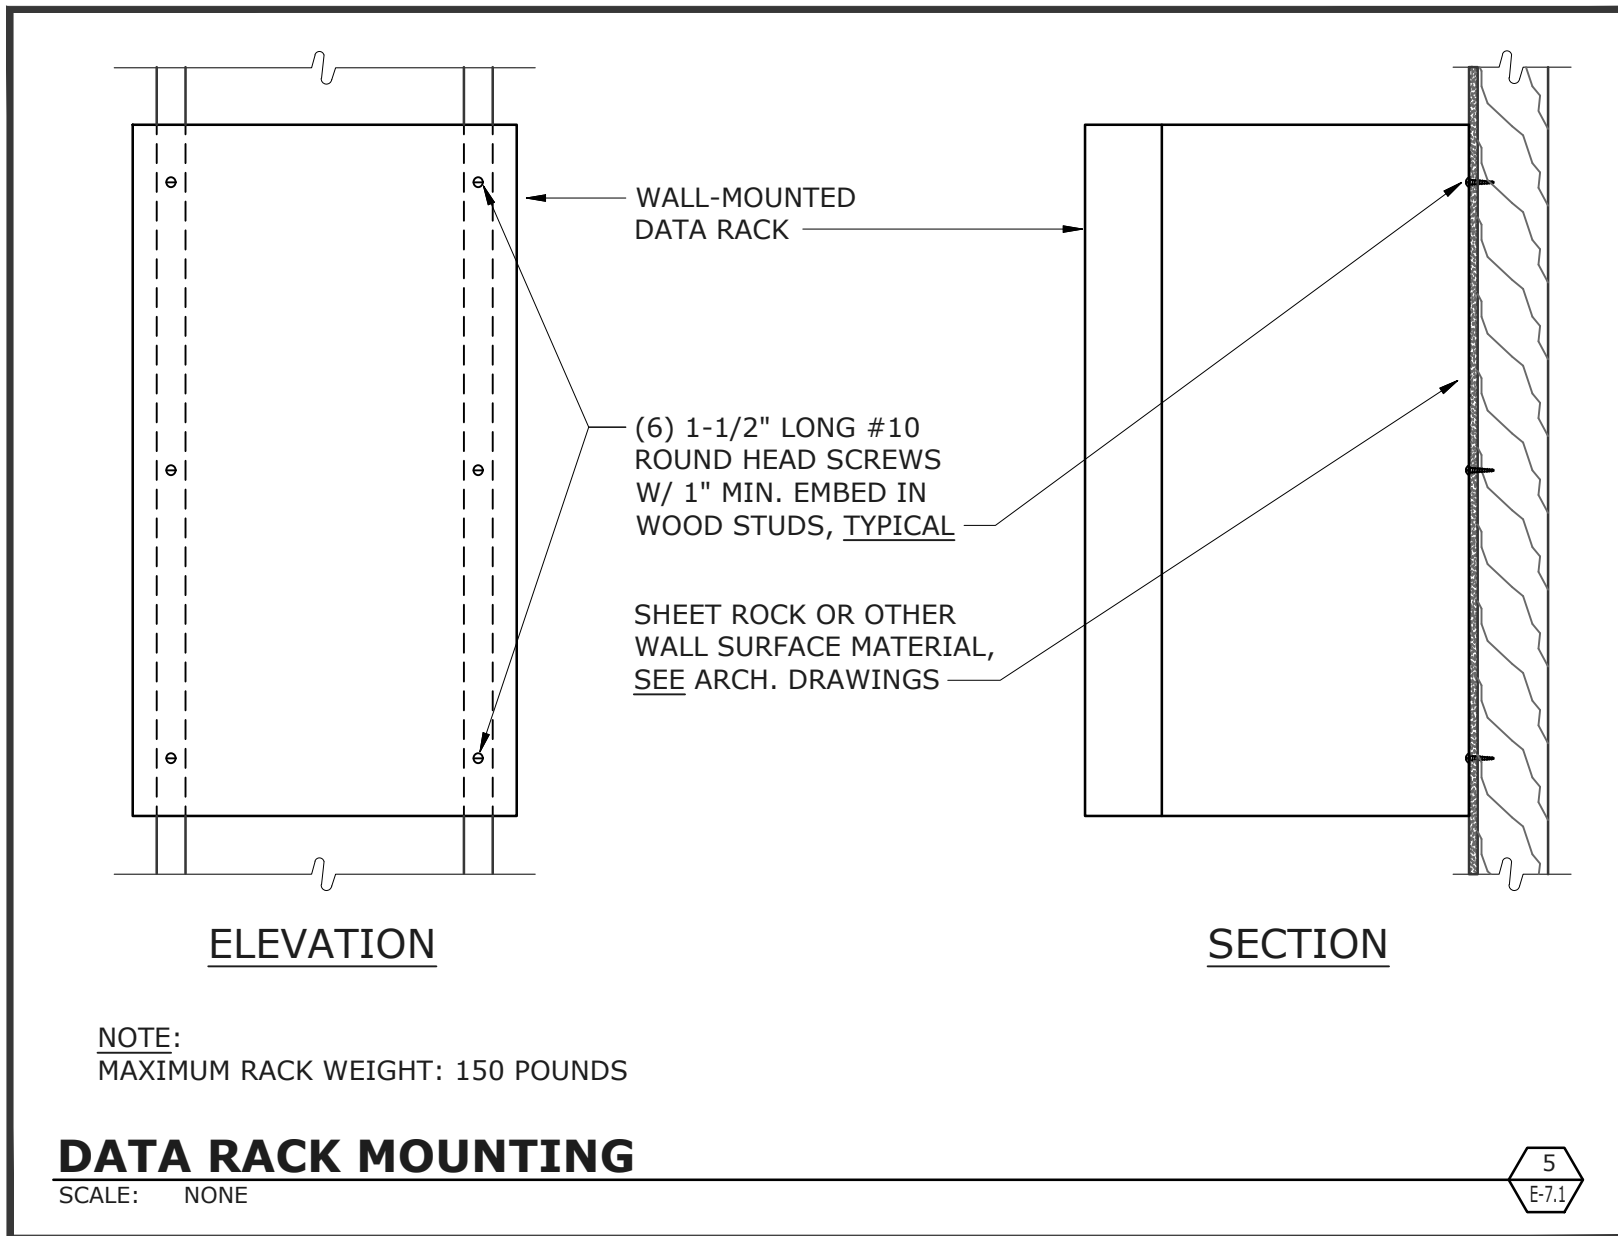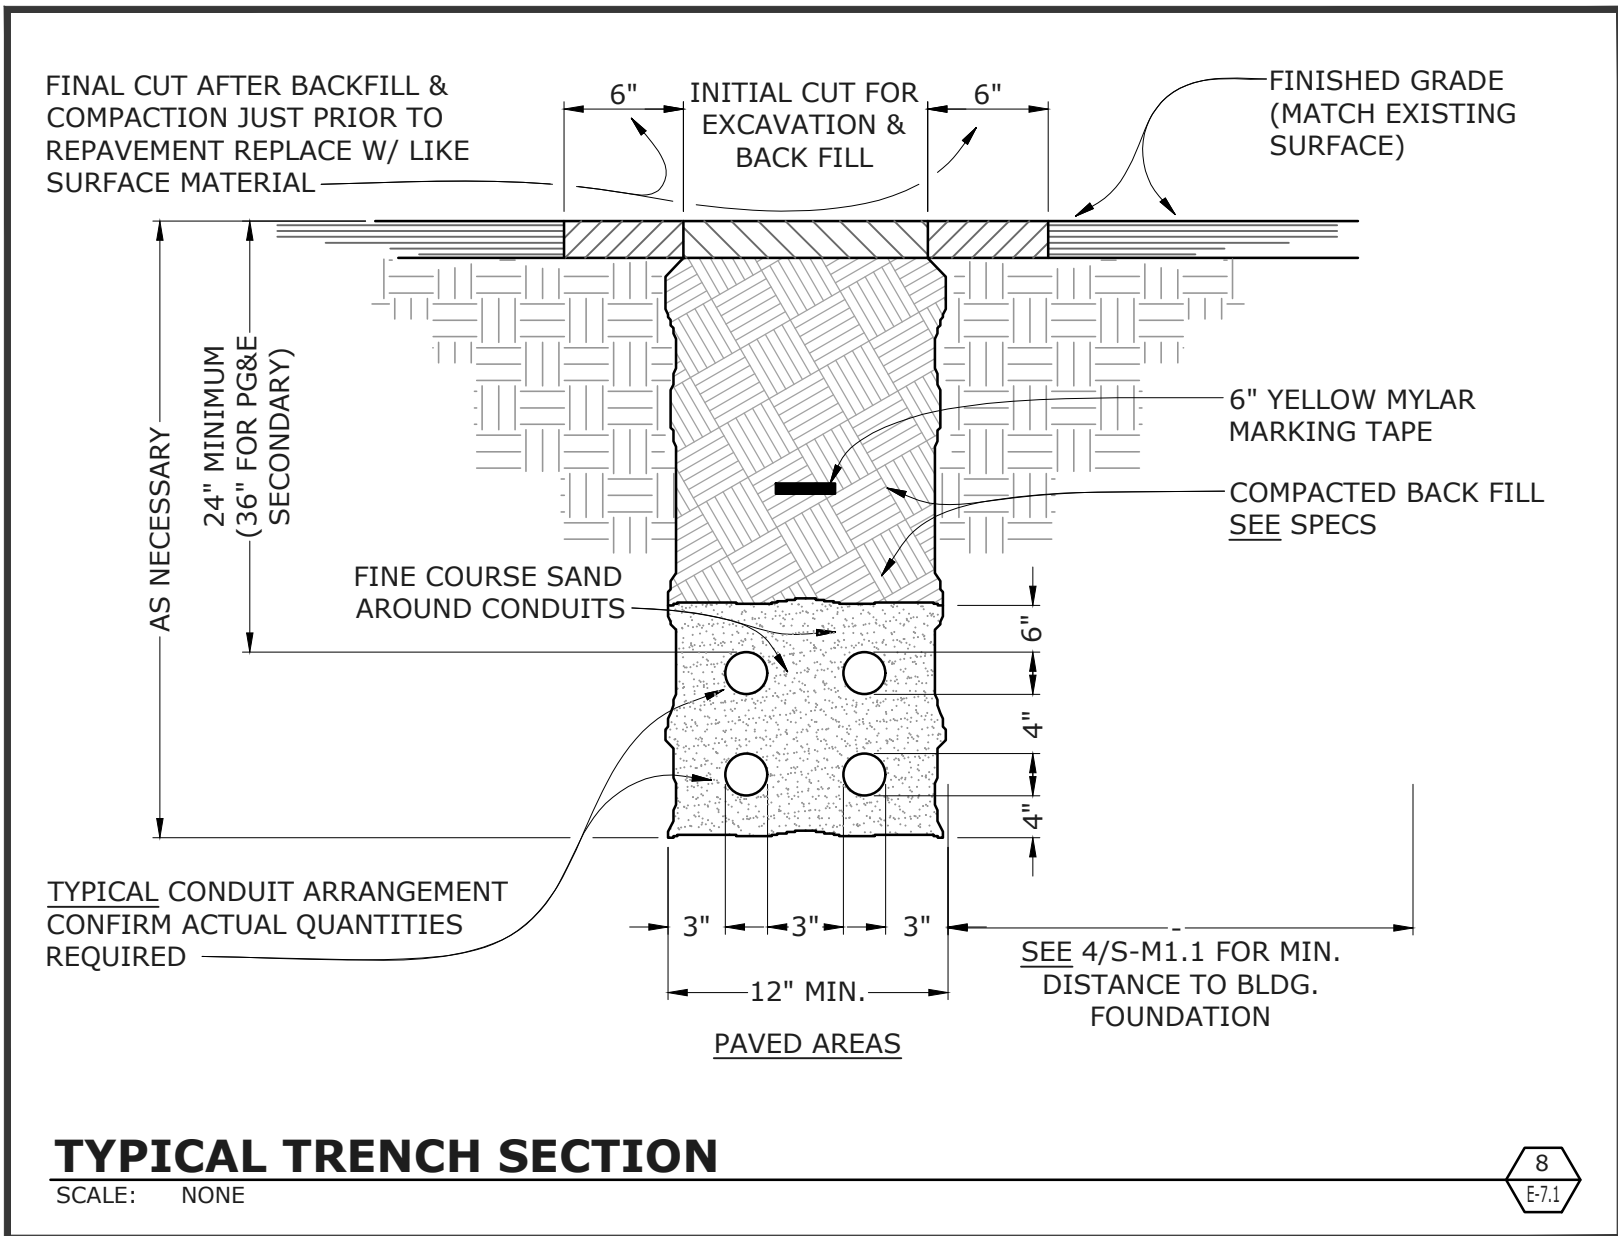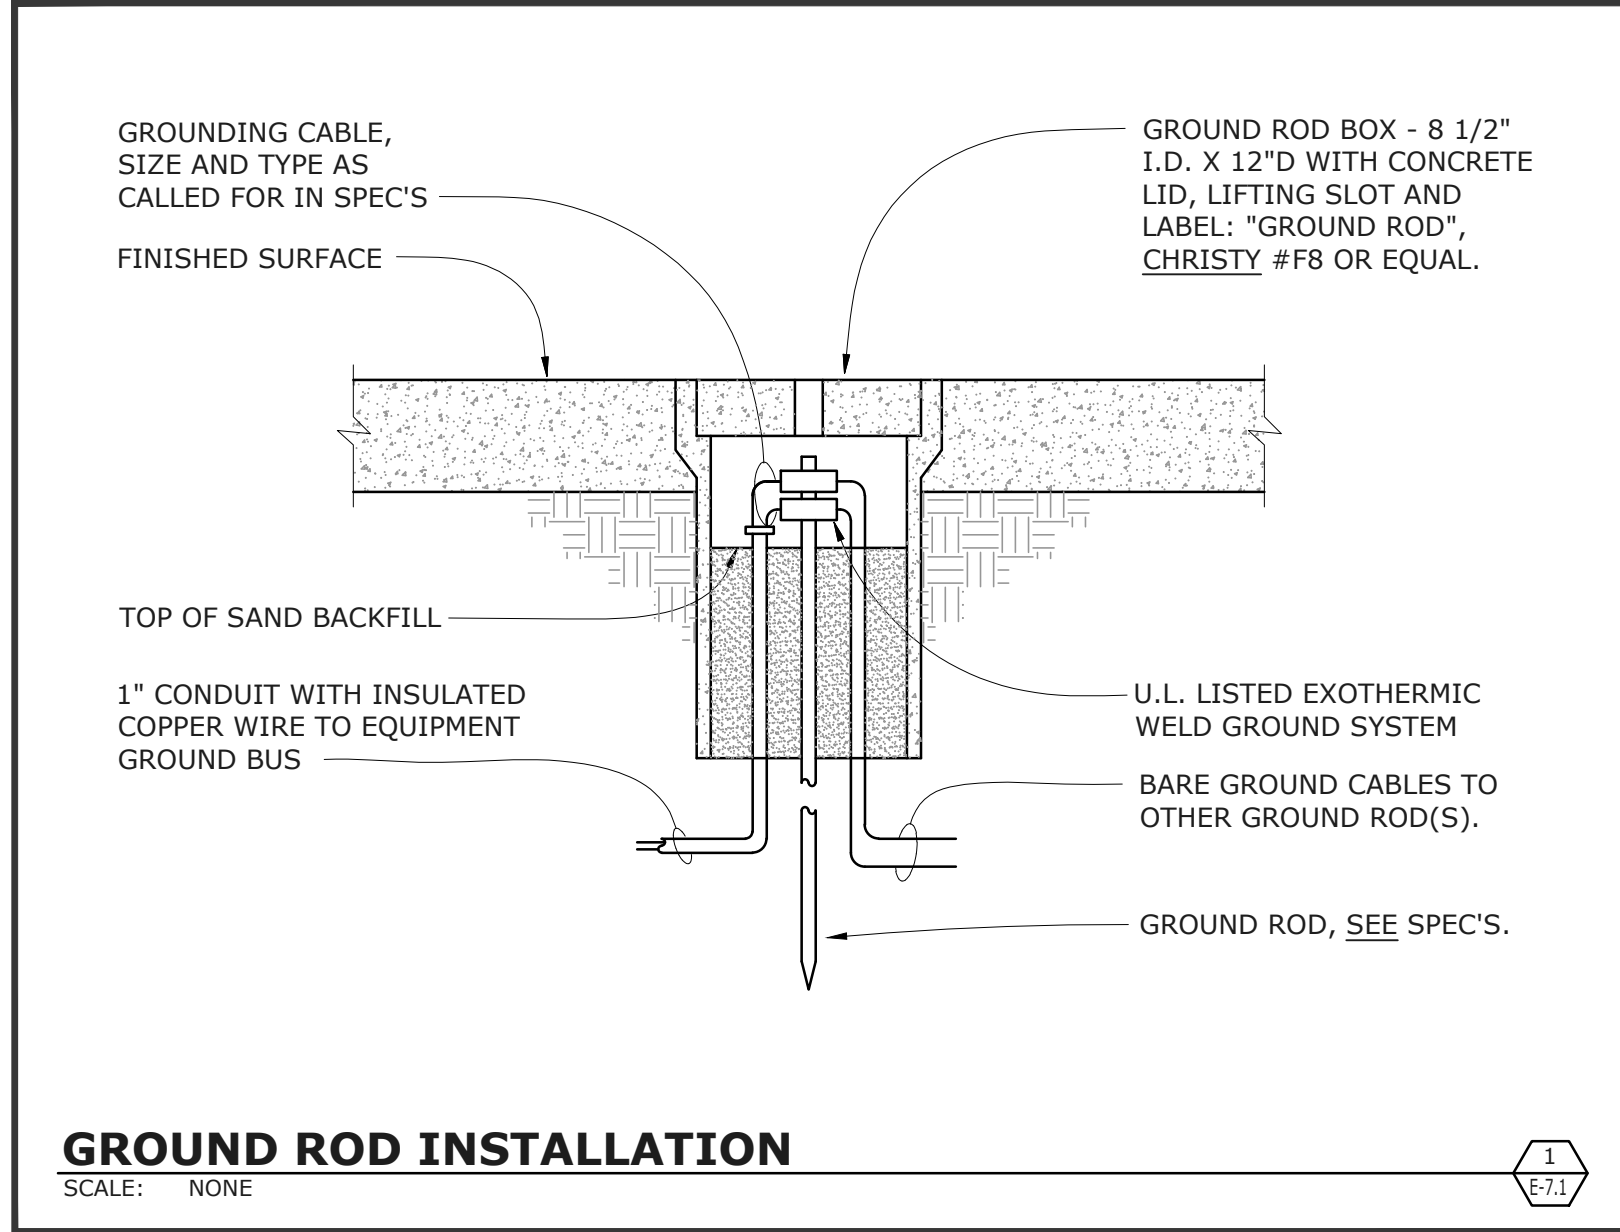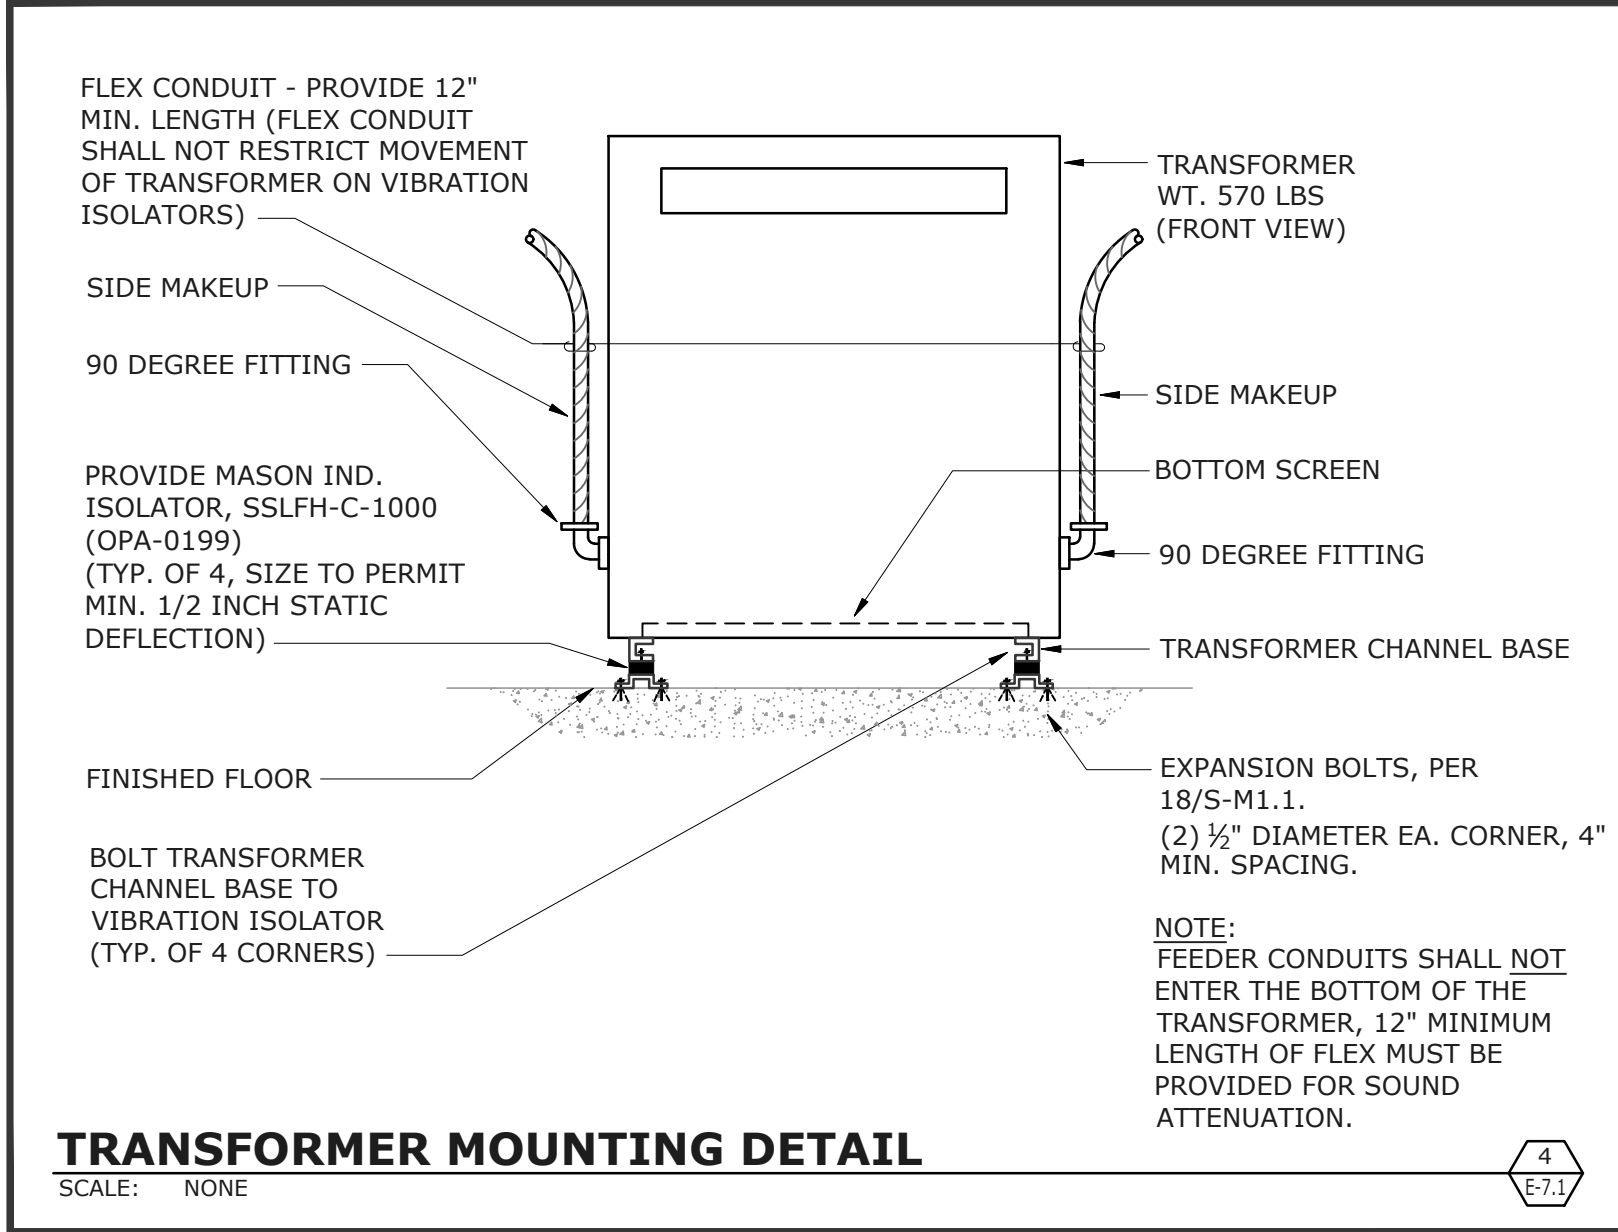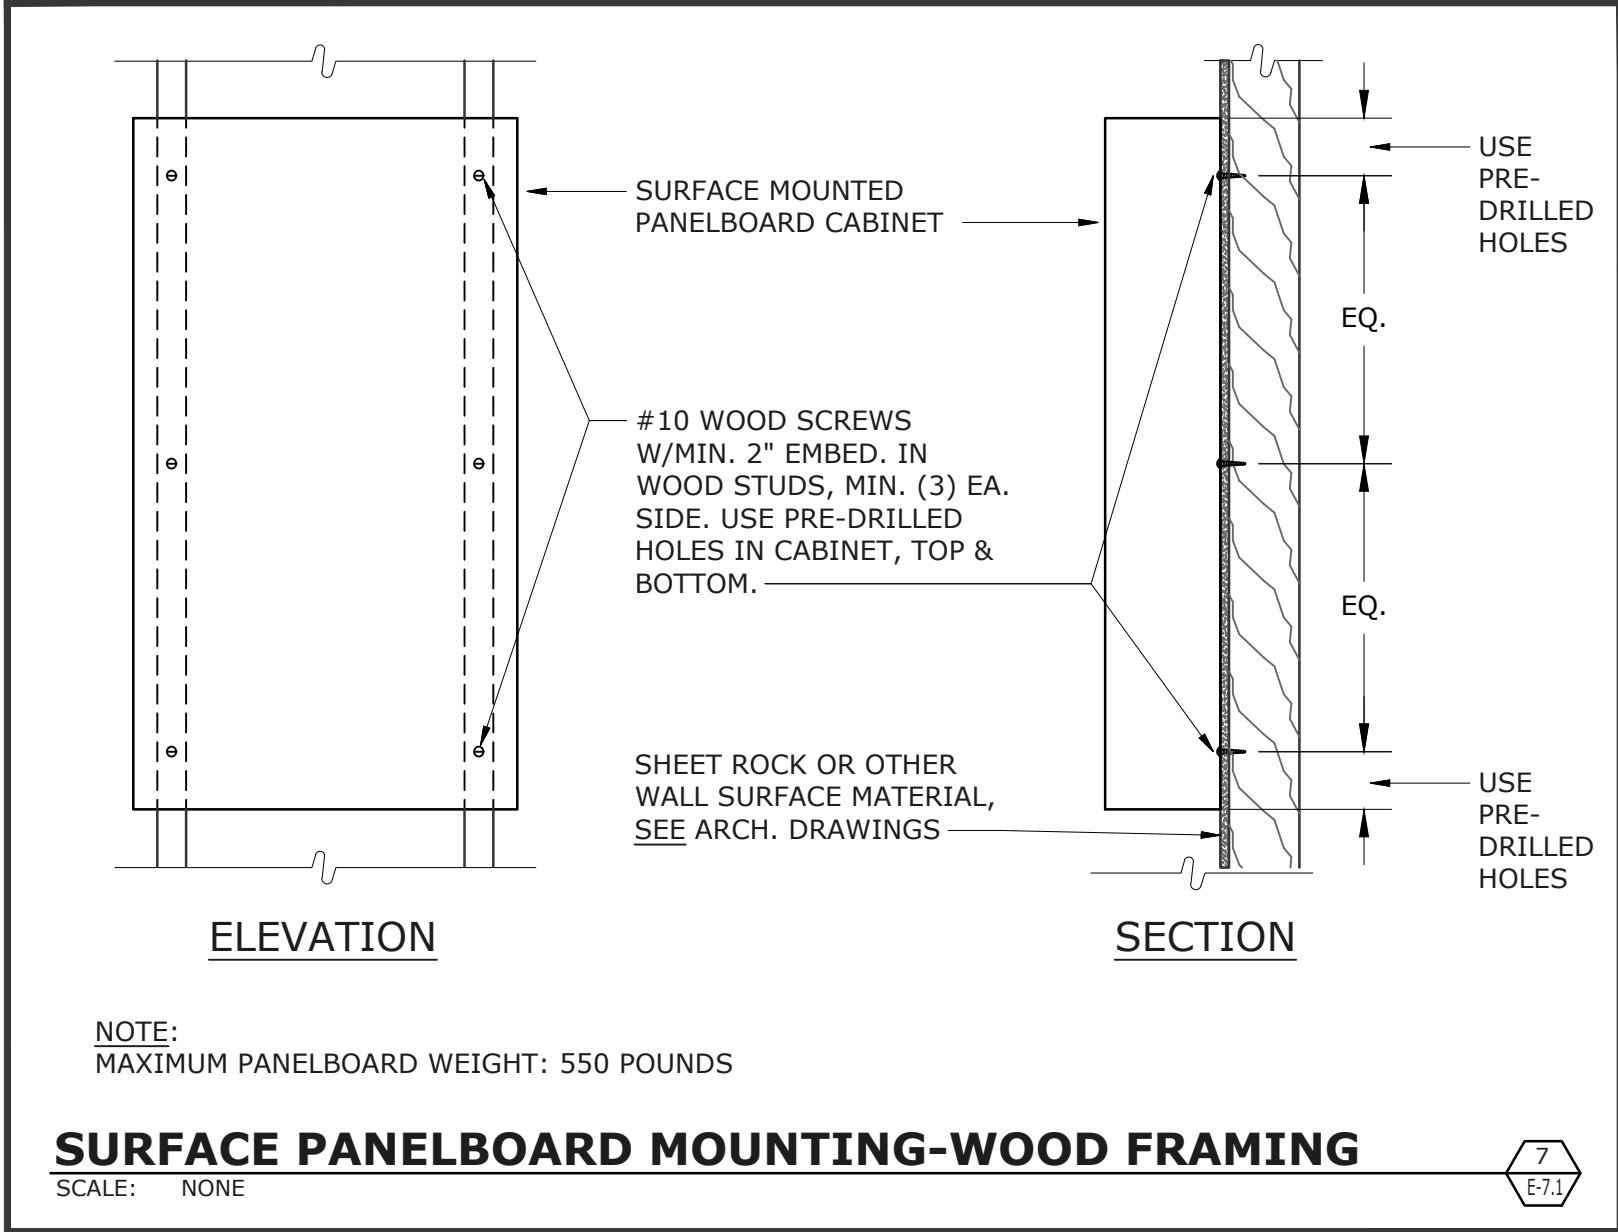

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REVISIONS	

DSA APP NO. 01-119278

ARCH PROJECT NO: 1869.00

DRAWN BY: LN,TV,JVL,DOM

DRAWING SCALE: AS NOTED

PTN: 61721-78 FILE NO: 7-H4

**BID DOCUMENT**

**APRIL 27, 2021**






SHEET TITLE

**DETAILS**

SHEET NUMBER

**E-7.1**




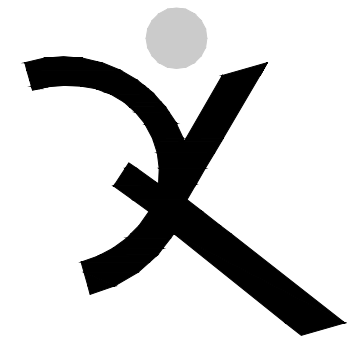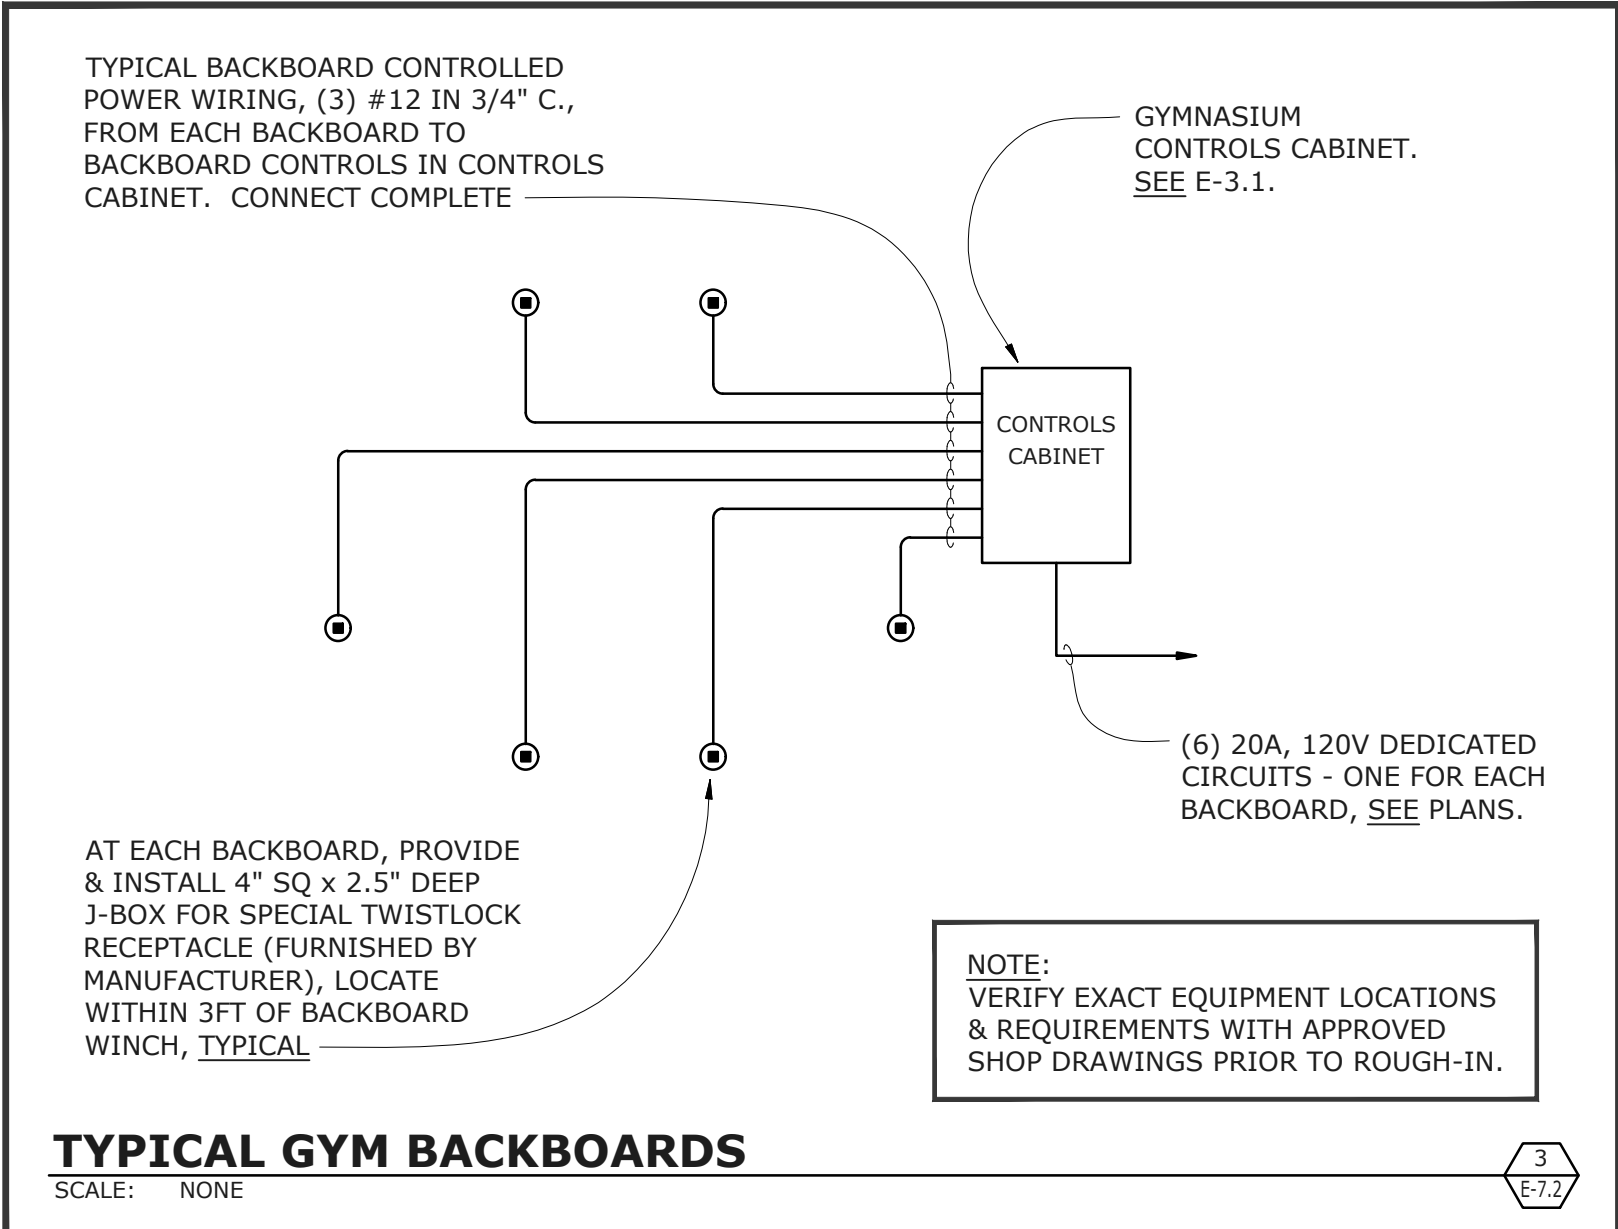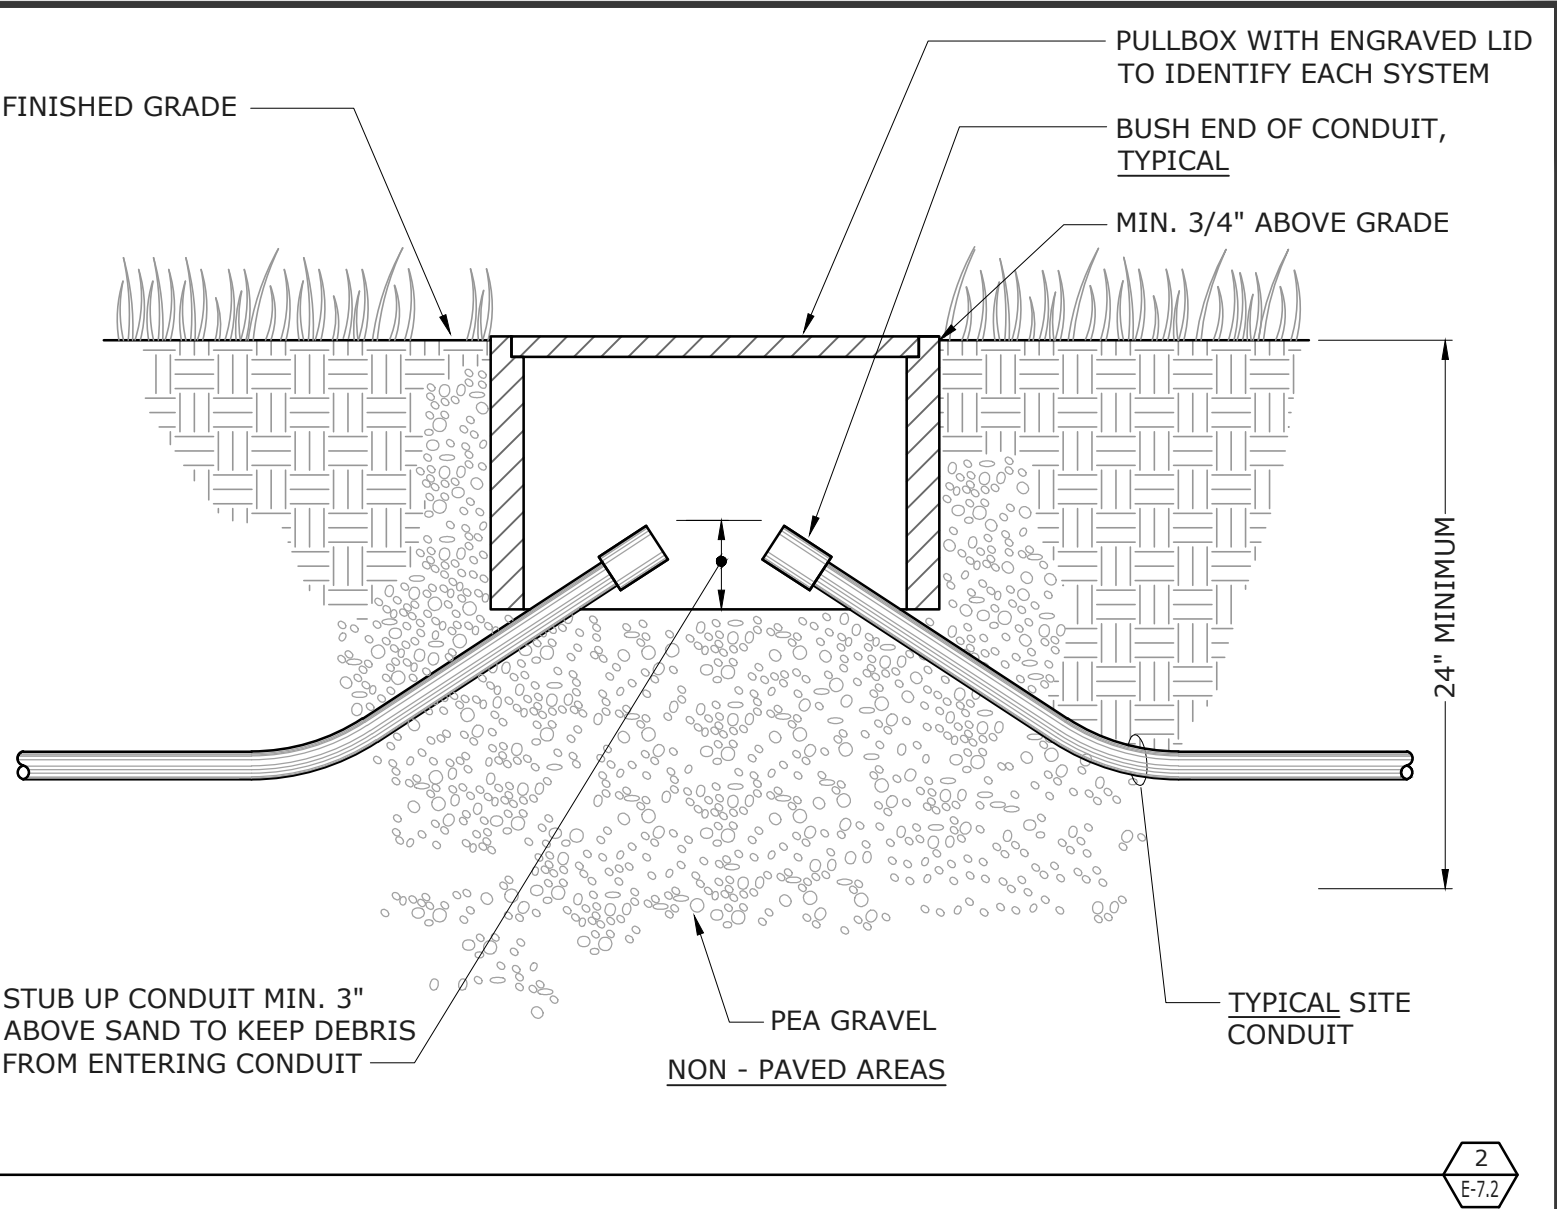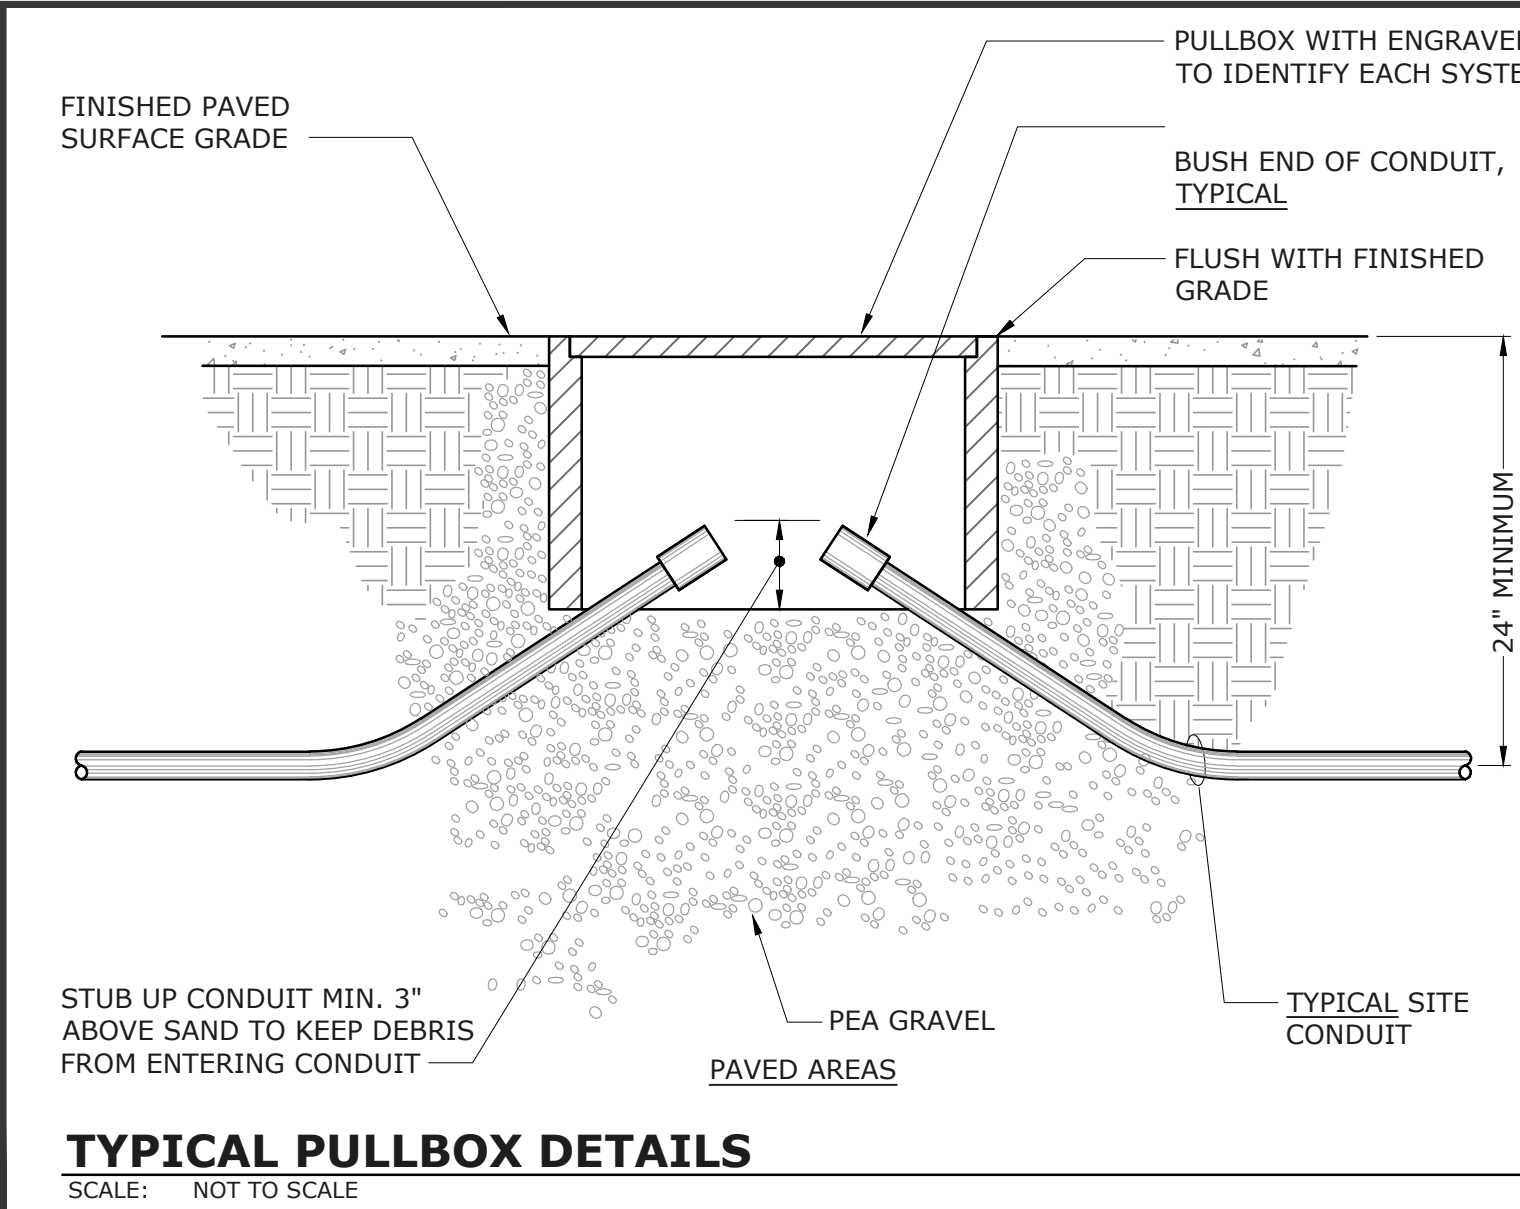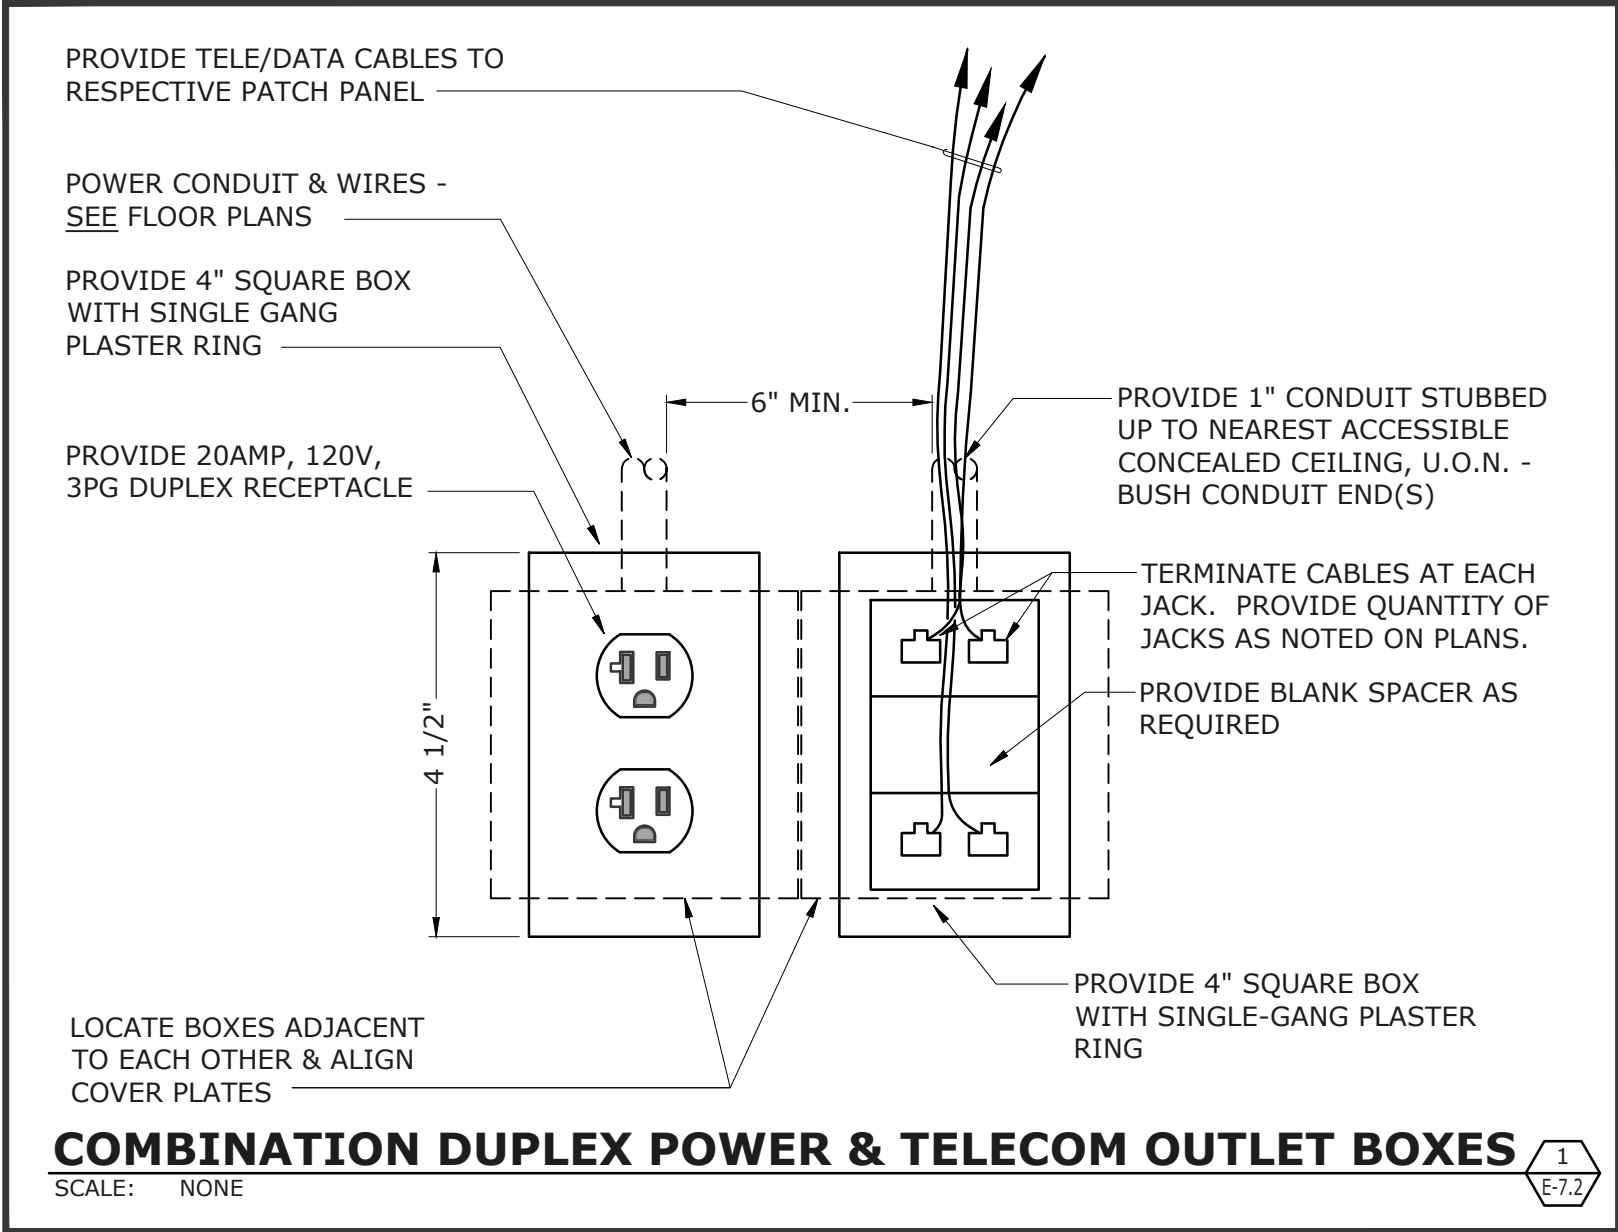

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DISTRICT

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DSA APP NO. 01-119278  
ARCH PROJECT NO. 1869.00  
DRAWN BY: LN,TV,JVL,DOM  
DRAWING SCALE: AS NOTED  
PTN: 61721-78 FILE NO: 7-H4

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APRIL 27, 2021

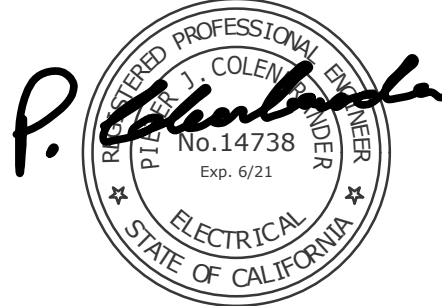SHEET TITLE

DETAILS

SHEET NUMBER

E-7.2



STATE OF CALIFORNIA

Indoor Lighting

CALIFORNIA ENERGY COMMISSION

CERTIFICATE OF COMPLIANCE

NRCC-LTI-E

Project Name:

Freedom HS Auxiliary Gym

Report Page:

(Page 7 of 9)

Project Address:

1050 Neroly Rd

Date Prepared:

12/17/2020

U. DECLARATION OF REQUIRED CERTIFICATES OF ACCEPTANCE

Selections have been made based on information provided in this document. If any selection have been changed by the permit applicant, an explanation should be included in Table E. Additional Remarks. These documents must be provided to the building inspector during construction and any with "A" in the form name must be completed through an Acceptance Test Technician Certification Provider (ATTCP). For more information visit: <http://www.energy.ca.gov/title24/attcp/providers.html>

		Form/Title	Field Inspector	
Yes	No		Pass	Fail
●	○	NRCA-LTI-02-A - Must be submitted for occupancy sensors and automatic time switch controls.	<input type="checkbox"/>	<input type="checkbox"/>
●	○	NRCA-LTI-03-A - Must be submitted for automatic daylight controls.	<input type="checkbox"/>	<input type="checkbox"/>
●	○	NRCA-LTI-04-A - Must be submitted for demand responsive lighting controls.	<input type="checkbox"/>	<input type="checkbox"/>
○	●	NRCA-LTI-05-A - Must be submitted for institutional tuning power adjustment factor (PAF)	<input type="checkbox"/>	<input type="checkbox"/>

Registration Number:

CA Building Energy Efficiency Standards - 2019 Nonresidential Compliance

Registration Date/Time:

Report Version: 2019.1.003  
Schema Version: rev 20200601

Registration Provider:

Energysoft

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STATE OF CALIFORNIA

Indoor Lighting

CALIFORNIA ENERGY COMMISSION

CERTIFICATE OF COMPLIANCE

NRCC-LTI-E

Project Name:

Freedom HS Auxiliary Gym

Report Page:

(Page 8 of 8)

Project Address:

1050 Neroly Rd

Date Prepared:

12/17/2020


DOCUMENTATION AUTHOR'S DECLARATION STATEMENT

I certify that this Certificate of Compliance documentation is accurate and complete.

Documentation Author Name:

Pieter Colenbrander

Documentation Author Signature:



Company:

O'Mahony & Myer

Signature Date:

2020-12-17

Address:

4340 Redwood Hwy Suite 245

CEA/HERS Certification Identification (if applicable):

14738

City/State/Zip:

San Rafael CA 94903

Phone:

415-492-0420

RESPONSIBLE PERSON'S DECLARATION STATEMENT

I certify the following under penalty of perjury, under the laws of the State of California:

1. The information provided on this Certificate of Compliance is true and correct.

2. I am eligible under Division 3 of the Business and Professions Code to accept responsibility for the building design or system design identified on this Certificate of Compliance (responsible designer)

3. The energy features and performance specifications, materials, components, and manufactured devices for the building design or system design identified on this Certificate of Compliance conform to the requirements of Title 24, Part 1 and Part 6 of the California Code of Regulations.


4. The building design features or system design features identified on this Certificate of Compliance are consistent with the information provided on other applicable compliance documents, worksheets, calculations, plans and specifications submitted to the enforcement agency for approval with this building permit application.

5. I will ensure that a completed signed copy of this Certificate of Compliance shall be made available with the building permit(s) issued for the building, and made available to the enforcement agency for all applicable inspections. I understand that a completed signed copy of this Certificate of Compliance is required to be included with the documentation the building provides to the building owner at occupancy.

Responsible Designer Name:

Pieter Colenbrander

Responsible Designer Signature:

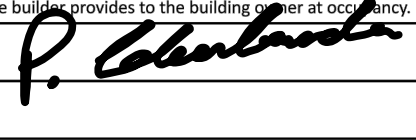

Company:

O'Mahony & Myer

Date Signed:

2020-12-17

Address:

4340 Redwood Hwy, Suite 245

License:

14738

City/State/Zip:

San Rafael CA 94903

Phone:

415-492-0420

Registration Number:

CA Building Energy Efficiency Standards - 2019 Nonresidential Compliance

Registration Date/Time:

Report Version: 2019.1.003  
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Energysoft

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CALIFORNIA ENERGY COMMISSION

CERTIFICATE OF COMPLIANCE

NRCC-LTI-E

Project Name:

Freedom HS Auxiliary Gym

Report Page:

(Page 4 of 9)

Project Address:

1050 Neroly Rd

Date Prepared:

12/17/2020

H. INDOOR LIGHTING CONTROLS (Not including PAFs)									
Area Level Controls									
04	05	06	07	08	09	10	11	12	
Area Description	Complete Building or Area Category Primary Function Area	Area Controls §130.1(a)	Multi-Level Controls §130.1(b)	Shut-Off Controls §130.1(c)	Primary/Sky lit Daylighting §130.1(d)	Secondary Daylighting §140.6(d)	Interlocked Systems §140.6(a)(1)	Field Inspector	
								Pass	Fail
Gym	All Other Space Types	Manual ON/OFF	Dimmer	Occupancy Sensor	N/A	N/A	No	<input type="checkbox"/>	<input type="checkbox"/>
Office	Office 250 square feet or less	Manual ON/OFF	Dimmer	Occupancy Sensor	N/A	N/A	No	<input type="checkbox"/>	<input type="checkbox"/>
Classroom	Classroom, Lecture, or Training Vocational Area	Manual ON/OFF	Dimmer	Occupancy Sensor	Included	Included	No	<input type="checkbox"/>	<input type="checkbox"/>
Restroom	Restrooms	Manual ON/OFF	Exempt*	Occupancy Sensor	N/A	N/A	No	<input type="checkbox"/>	<input type="checkbox"/>
Storage	All Other Space Types	Manual ON/OFF	Exempt*	Occupancy Sensor	N/A	N/A	No	<input type="checkbox"/>	<input type="checkbox"/>
Elec	Electrical Mechanical Telephone Room	Manual ON/OFF	Exempt*	Exempt*	N/A	N/A	No	<input type="checkbox"/>	<input type="checkbox"/>
Corridor	Corridor Area	Manual ON/OFF	Dimmer	Occupancy Sensor	N/A	N/A	No	<input type="checkbox"/>	<input type="checkbox"/>
*NOTES: Controls with a * require a note in the space below explaining how compliance is achieved. EX: Conference 1: Primary/Skylight Daylighting: Exempt because less than 120 watts of general lighting; EXCEPTION 1 to §130.1(d)(2)					13				
					Plan Sheet Showing Daylit Zones:				
Restroom	Exc.2 130.1(b)								
Storage									
Elec									

Registration Number:

CA Building Energy Efficiency Standards - 2019 Nonresidential Compliance

Registration Date/Time:

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CALIFORNIA ENERGY COMMISSION

CERTIFICATE OF COMPLIANCE

NRCC-LTI-E

Project Name:

Freedom HS Auxiliary Gym

Report Page:

(Page 5 of 8)

Project Address:

1050 Neroly Rd

Date Prepared:

12/17/2020

I. LIGHTING POWER ALLOWANCE: COMPLETE BUILDING OR AREA CATEGORY METHODS							
Each area complying using the Complete Building or Area Category Methods per §140.6(b) are included in this table. Column 06 indicates if additional lighting power allowances per §140.6(c) or adjustments per §140.6(a) are being used.							
Conditioned Spaces							
01	02	03	04	05	06		
Area Description	Complete Building or Area Category Primary Function Area	Allowed Density (W/ft²)	Area (ft²)	Allowed Wattage (Watts)	Additional Allowance / Adjustment		
					Area Category	PAF	
Office	Office 250 square feet or less	0.7	116	81.2	No	No	
Gymnasium	All Other Space Types	2.25	7,183	16,161.8	No	No	
Classroom	Classroom, Lecture, or Training Vocational Area	0.7	1,635	1,144.5	No	No	
Restroom	Restrooms	0.65	160	104	No	No	
Elec	Electrical Mechanical Telephone Room	0.4	69	27.6	No	No	
Corridor	Corridor Area	0.6	152	91.2	No	No	
TOTALS:			9,315	17,610.3	See Tables J, or P for detail		

J. ADDITIONAL ALLOWANCE: AREA CATEGORY METHOD QUALIFYING LIGHTING SYSTEM

This section does not apply to this project.

K. TAILORED METHOD GENERAL LIGHTING POWER ALLOWANCE

This section does not apply to this project.

L. ADDITIONAL LIGHTING ALLOWANCE: TAILORED WALL DISPLAY

This section does not apply to this project.

M. ADDITIONAL LIGHTING ALLOWANCE: TAILORED FLOOR AND TASK LIGHTING

This section does not apply to this project.

N. ADDITIONAL LIGHTING ALLOWANCE: TAILORED ORNAMENTAL/SPECIAL EFFECTS

This section does not apply to this project.

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Registration Date/Time:

Report Version: 2019.1.003  
Schema Version: rev 20200601

Registration Provider:

Energysoft

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Indoor Lighting

CALIFORNIA ENERGY COMMISSION

CERTIFICATE OF COMPLIANCE

NRCC-LTI-E

Project Name:

Freedom HS Auxiliary Gym

Report Page:

(Page 6 of 8)

Project Address:

1050 Neroly Rd

Date Prepared:

12/17/2020

O. ADDITIONAL LIGHTING ALLOWANCE: TAILORED VERY VALUABLE MERCHANDISE

This section does not apply to this project.

P. POWER ADJUSTMENT: LIGHTING CONTROL CREDIT (POWER ADJUSTMENT FACTOR (PAF))

This section does not apply to this project.

Q. RATED POWER REDUCTION COMPLIANCE FOR ALTERATIONS

This section does not apply to this project.

R. 80% LIGHTING POWER FOR ALL ALTERATIONS - CONTROLS EXCEPTIONS

This section does not apply to this project.

S. DAYLIGHT DESIGN POWER ADJUSTMENT FACTOR (PAF)

This section does not apply to this project.

T. DECLARATION OF REQUIRED CERTIFICATES OF INSTALLATION

Selections have been made based on information provided in this document. If any selection have been changed by permit applicant, an explanation should be included in Table E. Additional Remarks. These documents must be provided to the building inspector during construction and can be found online at [https://www.energy.ca.gov/title24/2019standards/2019_compliance_documents/Nonresidential_Documents/NRCC/](https://www.energy.ca.gov/title24/2019standards/2019_compliance_documents/Nonresidential_Documents/NRCC/)

		Form/Title	Field Inspector	
Yes	No		Pass	Fail
●	○	NRCI-LTI-01-E - Must be submitted for all buildings	<input type="checkbox"/>	<input type="checkbox"/>
○	●	NRCI-LTI-02-E - Must be submitted for a lighting control system, or for an Energy Management Control System (EMCS), to be recognized for compliance.	<input type="checkbox"/>	<input type="checkbox"/>
○	●	NRCI-LTI-04-E - Must be submitted for two interlocked systems serving an auditorium, a convention center, a conference room, a multipurpose room or a theater to be recognized for compliance.	<input type="checkbox"/>	<input type="checkbox"/>
○	●	NRCI-LTI-05-E - Must be submitted for a Power Adjustment Factor (PAF) to be recognized for compliance.	<input type="checkbox"/>	<input type="checkbox"/>
○	●	NRCI-LTI-06-E - Must be submitted for additional wattage installed in a video conferencing studio to be recognized for compliance.	<input type="checkbox"/>	<input type="checkbox"/>

Registration Number:

CA Building Energy Efficiency Standards - 2019 Nonresidential Compliance

Registration Date/Time:

Report Version: 2019.1.003  
Schema Version: rev 20200601

Registration Provider:

Energysoft

Report Generated: 2020-12-17 10:56:28

STATE OF CALIFORNIA

Indoor Lighting

CALIFORNIA ENERGY COMMISSION

CERTIFICATE OF COMPLIANCE

NRCC-LTI-E

Project Name:

Freedom HS Auxiliary Gym

Report Page:

(Page 1 of 8)

Project Address:

1050 Neroly Rd

Date Prepared:

12/17/2020

A. GENERAL INFORMATION				
01 Project Location (city)	Oakley	04 Total Conditioned Floor Area (ft²)	9,315	
02 Climate Zone	12	05 Total Unconditioned Floor Area (ft²)	0	
03 Occupancy Types Within Project (select all that apply):				
		06 # of Stories (Habitable Above Grade)	1	
<input checked="" type="checkbox"/> Office	<input type="checkbox"/> Retail	<input type="checkbox"/> Hotel/Motel	<input type="checkbox"/> School	<input checked="" type="checkbox"/> Support Areas
<input type="checkbox"/> Parking Garage	<input type="checkbox"/> High-Rise Residential	<input type="checkbox"/> Relocatable	<input type="checkbox"/> Healthcare	<input checked="" type="checkbox"/> Other (Write in) See Table I

B. PROJECT SCOPE					
This table includes any lighting systems that are within the scope of the permit application and are demonstrating compliance using the prescriptive path outlined in §140.6 or §141.0(b)(2) for alterations.					
Scope of Work		Conditioned Spaces		Unconditioned Spaces	
01	02	03	04	05	
My Project Consists of (check all that apply):		Calculation Method	Area (ft²)	Calculation Method	Area (ft²)
<input checked="" type="checkbox"/> New Lighting System		Area Category Method	9315	Area Category Method	0
<input type="checkbox"/> New Lighting System - Parking Garage					
Total Area of Work (ft²)		9315		0	

Registration Number:

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Registration Date/Time:

Report Version: 2019.1.003  
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STATE OF CALIFORNIA

Indoor Lighting

CALIFORNIA ENERGY COMMISSION

CERTIFICATE OF COMPLIANCE

NRCC-LTI-E

Project Name:

Freedom HS Auxiliary Gym

Report Page:

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Project Address:

1050 Neroly Rd

Date Prepared:

12/17/2020

C. COMPLIANCE RESULTS									
If any cell on this table says "DOES NOT COMPLY" or "COMPLIES with Exceptional Conditions" refer to Table D, for guidance.									
Lighting in conditioned and unconditioned spaces must not be combined for compliance per §140.6(b)(1)	Allowed Lighting Power per §140.6(b) (Watts)				=	Total Allowed (Watts)	Adjusted Lighting Power per §140.6(a) (Watts)		Compliance Results
	01	02	03	04			06	07	
	Complete Building §140.6(c)(1)	Area Category §140.6(c)(2)	Area Category Additional §140.6(c)(2)(+) (+)	Tailored §140.6(c)(3) (+)					
Conditioned	(See Table I)	(See Table I)	(See Table J)	(See Table K)	=	17,610.3	≥ 5,220	0	= 5220
Unconditioned		17,610.3	0		=		≥		=
Controls Compliance (See Table H for Details)									COMPLIES
Rated Power Reduction Compliance (See Table Q for Details)									COMPLIES

D. EXCEPTIONAL CONDITIONS

This table is auto-filled with uneditable comments because of selections made or data entered in tables throughout the form.

E. ADDITIONAL REMARKS

This table includes remarks made by the permit applicant to the Authority Having Jurisdiction.

F. INDOOR LIGHTING FIXTURE SCHEDULE										
This table includes all permanent designed lighting and all portable lighting in offices.										
Designed Wattage: Conditioned Spaces										
01	02	03	04	05	06	07	08	09	10	
Name or Item Tag	Complete Luminaire Description	Modular (Track) Fixture	Small Aperture & Color Change¹	Watts per luminaire²	How is Wattage determined	Total Number of Luminaires	Excluded per §140.6(a)(3)	Design Watts	Field Inspector	
									Pass Fail	
AA1	AA1 - High Bay	No	No	113	Mfr. Spec	9	No	1,017	<input type="checkbox"/>	<input type="checkbox"/>
AA2	AA2 - High Bay	No	No	113	Mfr. Spec	21	No	2,373	<input type="checkbox"/>	<input type="checkbox"/>

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NRCC-LTI-E

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Freedom HS Auxiliary Gym

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F. INDOOR LIGHTING FIXTURE SCHEDULE										
AA3	AA3 - High Bay	No	No	71	Mfr. Spec	4	No	284	<input type="checkbox"/>	<input type="checkbox"/>
AB1	AB1 - Linear	No	No	368	Mfr. Spec	1	No	368	<input type="checkbox"/>	<input type="checkbox"/>
AB2	AB2 - Linear	No	No	368	Mfr. Spec	2	No	736	<input type="checkbox"/>	<input type="checkbox"/>
AC1	AC1 - Linear	No	No	92	Mfr. Spec	2	No	184	<input type="checkbox"/>	<input type="checkbox"/>
AD2	AD2 - Striplight	No	No	42	Mfr. Spec	1	No	42	<input type="checkbox"/>	<input type="checkbox"/>
AF1	AF1 - Downlight	No	No	40	Mfr. Spec	3	No	120	<input type="checkbox"/>	<input type="checkbox"/>
AG1	AG1 - Troffer	No	No	24	Mfr. Spec	4	No	96	<input type="checkbox"/>	<input type="checkbox"/>
Total Designed Watts: CONDITIONED SPACES							5,220			


¹FOOTNOTE: Design Watts for small aperture and color changing luminaires which qualify per §140.6(a)(4B) is adjusted to be 75% of their rated wattage. Table F automatically makes this adjustment, the permit applicant should enter full rated wattage in column 05.

²Authority Having Jurisdiction may ask for Luminaire cut sheets to confirm wattage used for compliance per §130.0(c) Wattage used must be the maximum rated for the luminaire, not the lamp.

G. MODULAR LIGHTING SYSTEMS


This section does not apply to this project.

H. INDOOR LIGHTING CONTROLS (Not including PAFs)					
This table includes lighting controls for conditioned and unconditioned spaces. When a control having a * is shown, the notes section of this table provides more detail on how compliance is achieved. The lighting controls section of the Compliance Summary Table on the first page will show "DOES NOT COMPLY" if the notes are left blank.					
Building Level Controls		01	02	03	
		Mandatory Demand Response §110.12(c) Required > 10,000 SF	Shut-off controls §130.1(c) Whole Building Auto Time Switch	Field Inspector	
				Pass Fail	
				<input type="checkbox"/>	<input type="checkbox"/>

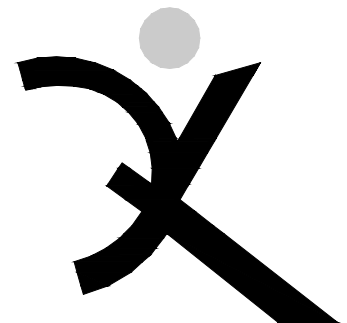


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CERTIFICATE OF COMPLIANCE  
Project Name: Freedom HS Auxiliary Gym  
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Documentation Author's Declaration Statement  
I certify that this Certificate of Compliance documentation is accurate and complete.  
Documentation Author Name: Pieter Colenbrander  
Signature Date: 2020-12-17  
Address: 4340 Redwood Hwy Suite 245  
City/State/Zip: San Rafael CA 94903  
Responsible Person's Declaration Statement  
I certify the following under penalty of perjury, under the laws of the State of California:  
1. The information provided on this Certificate of Compliance is true and correct.  
2. I am eligible under Division 3 of the Business and Professions Code to accept responsibility for the building design or system design identified on this Certificate of Compliance (responsible designer)  
3. The energy features and performance specifications, materials, components, and manufactured devices for the building design or system design conform to the requirements of Title 24, Part 1 and Part 6 of the California Code of Regulations.  
4. The building design features or system design features identified on this Certificate of Compliance are consistent with the information provided on other applicable compliance documents, worksheets, calculations, plans and specifications submitted to the enforcement agency for approval with this building permit application.  
5. I will ensure that a completed signed copy of this Certificate of Compliance shall be made available with the building permit(s) issued for the building, and made available to the enforcement agency for all applicable inspections. I understand that a completed signed copy of this Certificate of Compliance is required to be included with the documentation the builder provides to the building owner at occupancy.  
Responsible Designer Name: Pieter Colenbrander  
Signature Date: 2020-12-17  
Address: 4340 Redwood Hwy, Suite 245  
City/State/Zip: San Rafael CA 94903

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STATE OF CALIFORNIA  
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G. CUTOFF REQUIREMENTS (BUG)  
This table includes fixtures of >=6,200 initial lumens indicated on Table F as needing to comply with Cutoff Requirements. Maximum lumens can be found in Title 24, Part 11, Section 5.106.8.  
true 02 03 04 05 06 07 08 09 10 11 12  
Name or Item Tag Complete Luminaire Description Backlight Rating¹ Uplight Rating² Glare Rating (Lumens)³ Field Inspector  
Mounting Height¹ Max Allowable Backlight Rating¹ Lighting type Max Allowable Uplight Rating³ Mounting Height¹ Max Allowable Glare Rating³ Pass Fail  
BD1 BD1-Pole Mount 2 MH from property line No Limit B3 All other outdoor lighting, including decorative U3 UO 2 MH from property line G3 G2 ☐ ☐

¹ FOOTNOTES: Mounting Height is labeled MH in this table.  
² Authority Having Jurisdiction may ask for Luminaire cut sheets or other documentation to confirm luminaire type, uplight ratings and glare ratings used for compliance per §130.2(b).  
³ BUG ratings with a lower number than the "Max Allowable" are compliant. Ex. If Max Allowable is Bug Rating B4, then B0, B1, B2 and B3 are all compliant.

H. OUTDOOR LIGHTING CONTROLS  
This table demonstrates compliance with controls requirements for all new or altered luminaires installed as part of the permit application. For alteration projects, luminaires which are existing to remain (ie untouched) and luminaires which are removed and reinstalled (wiring only) do not need to be included in this table even if they are within the spaces covered by the permit application.  
When an option having a * is selected, the notes section of this table must be completed. The lighting controls section of the Compliance Summary Table on the first page will show "DOES NOT COMPLY" if the notes are left blank.  
Mandatory Controls  
01 02 03 04 05  
Area Description Shut-Off §130.2(c)1 Auto-Schedule §130.2(c)2 Motion Sensor §130.2(c)3 Field Inspector  
Pedestrian Astronomical Timer Yes Yes ☐ ☐

* NOTES: Controls with a * require a note in the space below explaining how compliance is achieved.  
EX: Not permitted by health & safety to be turned off. EXCEPTION 1 to §130.2(c)
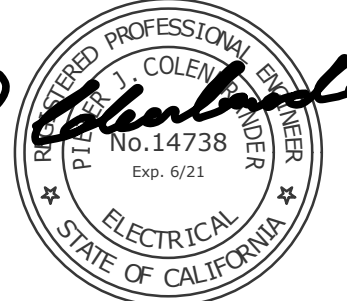
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I. LIGHTING POWER ALLOWANCE (per §140.7)  
This table includes areas using allowance calculations per §140.7. General Hardscape Allowance is per Table 140.7-A while "Use it or lose it" Allowances are per Table 140.7-B. Indicate which allowances are being used to expand sections for user input. Luminaires that qualify for one of the "Use it or lose it" allowances shall not qualify for another "Use it or lose it" allowance.  
General Hardscape Lighting Power Allowance per Table 140.7-A (LZ 0, 1 & 4)  
This section does not apply to this project.  
General Hardscape Lighting Power Allowance per Table 140.7-A (LZ 2 & 3)  
01  
General Hardscape Allowance Table I (below) "Use it or lose it" Allowance (select all that apply) (select all that apply)  
Per Application Table J Sales Frontage Table K Ornamental Table L Per Specific Area Table M  
02 03 04 05 06 07 08 9 10  
Area Description Surface Type Illuminated Area (ft²) Allowed Density (W/ft²) Area Allowance (Watts) Perimeter Length (ft) Allowed Density (W/ft) Linear Allowance (Watts) Total General AWA + LWA (Watts)  
Pedestrian Concrete 23324 0.03 699.72 1544 0.4 617.6 1317.32  
Initial Wattage Allowance for Entire Site (Watts): 350  
Total General Hardscape Allowance (Watts): 1667.32

J. LIGHTING ALLOWANCE: PER APPLICATION  
This section does not apply to this project.  
K. LIGHTING ALLOWANCE: SALES FRONTAGE  
This section does not apply to this project.  
L. LIGHTING ALLOWANCE: ORNAMENTAL  
This section does not apply to this project.  
M. LIGHTING ALLOWANCE: PER SPECIFIC AREA  
This section does not apply to this project.

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N. EXISTING CONDITIONS POWER ALLOWANCE (alterations only)  
This section does not apply to this project.  
O. DECLARATION OF REQUIRED CERTIFICATES OF INSTALLATION  
Selections have been made based on information provided in this document. If any selection have been changed by permit applicant, an explanation should be included in Table E.  
Additional Remarks. These documents must be provided to the building inspector during construction and can be found online at https://www.energy.ca.gov/title24/2019standards/2019_compliance_documents/Nonresidential_Documents/NRCI/  
Yes No Form/Title Field Inspector  
Pass Fail  
NRCI-LTO-01-E - Must be submitted for all buildings ☐ ☐  
NRCI-LTO-02-E - Must be submitted for a lighting control system, or for an Energy Management Control System (EMCS), to be recognized for compliance. ☐ ☐  
P. DECLARATION OF REQUIRED CERTIFICATES OF ACCEPTANCE  
Selections have been made based on information provided in this document. If any selection have been changed by permit applicant, an explanation should be included in Table E.  
Additional Remarks. These documents must be provided to the building inspector during construction and must be completed through an Acceptance Test Technician Certification Provider (ATTCP). For more information visit: http://www.energy.ca.gov/title24/attcp/providers.html  
Yes No Form/Title Field Inspector  
Pass Fail  
NRCA-LTO-02-A - Must be submitted for all outdoor lighting controls except for alterations where controls are added to <= 20 luminaires. ☐ ☐

Registration Number: CA Building Energy Efficiency Standards - 2019 Nonresidential Compliance  
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STATE OF CALIFORNIA  
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CERTIFICATE OF COMPLIANCE  
Project Name: Freedom HS Auxiliary Gym  
Project Address: 1050 Neroly Rd  
Report Page: (Page 1 of 7)  
Date Prepared: 12/17/2020

A. GENERAL INFORMATION  
01 Project Location (city) Oakley  
02 Climate Zone 12  
04 Total Illuminated Hardscape Area (ft²) 23324  
03 Outdoor Lighting Zone per Title 24 Part 1 §10.114 or as designated by Authority Having Jurisdiction (AHJ):  
☐ LZ-0: Very Low - Undeveloped Parkland ☐ LZ-2: Moderate - Rural Areas ☐ LZ-4: High - Must be reviewed by CA Energy Commission for Approval  
☐ LZ-1: Low - Developed Parkland ☒ LZ-3: Moderately High - Urban Areas

B. PROJECT SCOPE  
This table includes outdoor lighting systems that are within the scope of the permit application and are demonstrating compliance using the prescriptive path outlined in §140.7 or §141.0(b)(2), for alterations.  
My Project Consists of:  
01 02  
☒ New Lighting System Must Comply with Allowances from §140.7  
☐ Altered Lighting System Is your alteration increasing the connected lighting load (Watts)? ☒ Yes ☐ No  
03 04 05  
% of Existing Luminaires Being Altered¹ Sum Total of Luminaires Being Added or Altered Calculation Method  
☐ < 10% ☐ >= 10% and < 50% ☐ >= 50%  
Please proceed to Table F, Outdoor Lighting Fixture Schedule to define the project's luminaires.  
¹ FOOTNOTES: % of Existing Luminaires Being Altered = (Sum Total of Luminaires Being Added or Altered / Existing Luminaires within the Scope of the Permit Application) x 100.

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C. COMPLIANCE RESULTS  
Results in this table are automatically calculated from data input and calculations in Tables F through I. Note: If any cell on this table says "COMPLIES with Exceptional Conditions" refer to Table D. Exceptional Conditions for guidance or see applicable Table referenced below.  
Calculations of Total Allowed Lighting Power (Watts) §140.7 or §141.0(b)(2)  
01 02 03 04 05 06 07 08 09  
General Hardscape Allowance §140.7(d)(1) (See Table I) + Per Application §140.7(d)2 (See Table J) + Sales Frontage §140.7(d)2 (See Table K) + Ornamental §140.7(d)2 (See Table L) + Per Specific Area §140.7(d)2 (See Table M) OR Existing Power Allowance §141.0(b)(2) (See Table N) = Total Allowed (Watts) ≥ Total Actual (Watts) 07 must be >= 08  
1,667.32 + --- + --- + --- + --- + --- OR --- = 1,667.32 ≥ 1,195 COMPLIES  
Cutoff Compliance (See Table G for Details) COMPLIES  
Controls Compliance (See Table H for Details) COMPLIES

D. EXCEPTIONAL CONDITIONS  
This table is auto-filled with uneditable comments because of selections made or data entered in tables throughout the form.  
E. ADDITIONAL REMARKS  
This table includes remarks made by the permit applicant to the Authority Having Jurisdiction.

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F. OUTDOOR LIGHTING FIXTURE SCHEDULE  
For new or altered lighting systems demonstrating compliance with §140.7 all new luminaires being installed and any existing luminaires remaining or being moved within the spaces covered by the permit application are included in the Table below. For altered lighting systems using the Existing Power method per §141.0(b)(2), only new luminaires being installed and replacement luminaires being installed as part of the project scope are included (ie, existing luminaires remaining or existing luminaires being moved are not included).  
Designed Wattage:  
01 02 03 04 05 06 07 08 09 10  
Name or Item Tag Complete Luminaire Description Watts per luminaire^{1,2} How is Wattage determined Total number luminaires³ Luminaire Status³ Excluded per §140.7(a) Design Watts Cutoff Req. > 6,200 Initial lumen output §130.2(b) ⁴ Field Inspector  
Pass Fail  
BA1 BA1 - Exterior Sconce ☐ Linear 25 Mfr. Spec 4 New ☐ 100 NA: < 6200 lumens ☐ ☐  
BB1 BB1 - Exterior Sconce ☐ Linear 35 Mfr. Spec 2 New ☐ 70 NA: < 6200 lumens ☐ ☐  
BC1 BC1 - Exterior Sconce ☐ Linear 50 Mfr. Spec 8 New ☐ 400 NA: < 6200 lumens ☐ ☐  
BC2 BC2 - Exterior Sconce ☐ Linear 25 Mfr. Spec 2 New ☐ 50 NA: < 6200 lumens ☐ ☐  
BC3 BC3 - Exterior Sconce ☐ Linear 25 Mfr. Spec 5 New ☐ 125 NA: < 6200 lumens ☐ ☐  
BD1 BD1-Pole Mount ☐ Linear 75 Mfr. Spec 6 New ☐ 450 Yes ☐ ☐  
Total Design Watts: 1195

* NOTES: Selections with a * require a note in the space below explaining how compliance is achieved.  
EX: Luminaire is lighting a statue; EXCEPTION 2 to §130.2(b)  
¹ FOOTNOTES: Authority Having Jurisdiction may ask for Luminaire cut sheets to confirm wattage used for compliance per §130.0(c)  
² For linear luminaires, wattage should be indicated as W/ft instead of Watts/luminaire. Total linear feet should be indicated in column 05 instead of number of luminaires.  
³ Select "New" for new luminaires in a new outdoor lighting project, or for added luminaires in an alteration. Select "Altered" for replacement luminaires in an alteration. Select "Existing to Remain" for existing luminaires within the project scope that are not being altered and are remaining. Select "Existing Reinstalled" for existing luminaires which are being removed and reinstalled as part of the project scope.  
⁴ Compliance with mandatory cutoff requirements is required for luminaires with initial lumen output >= 6,200 unless exempted by §130.2(b)

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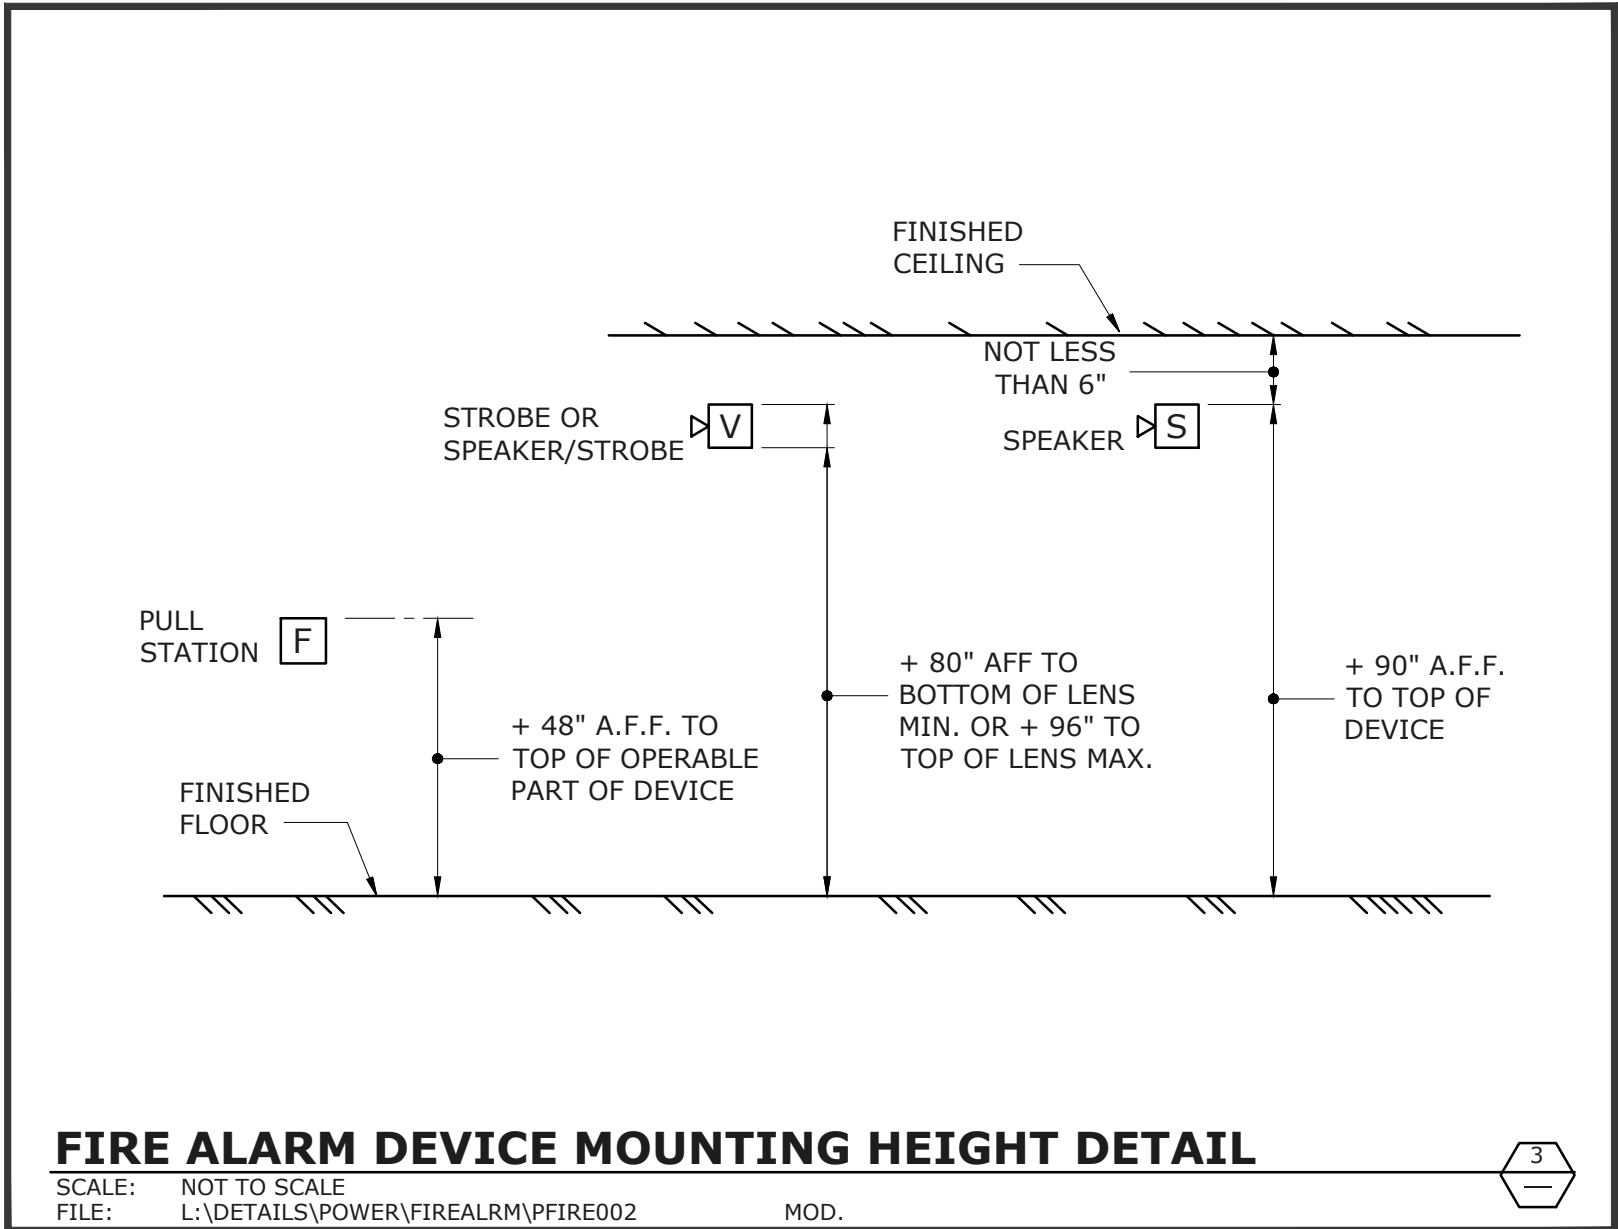
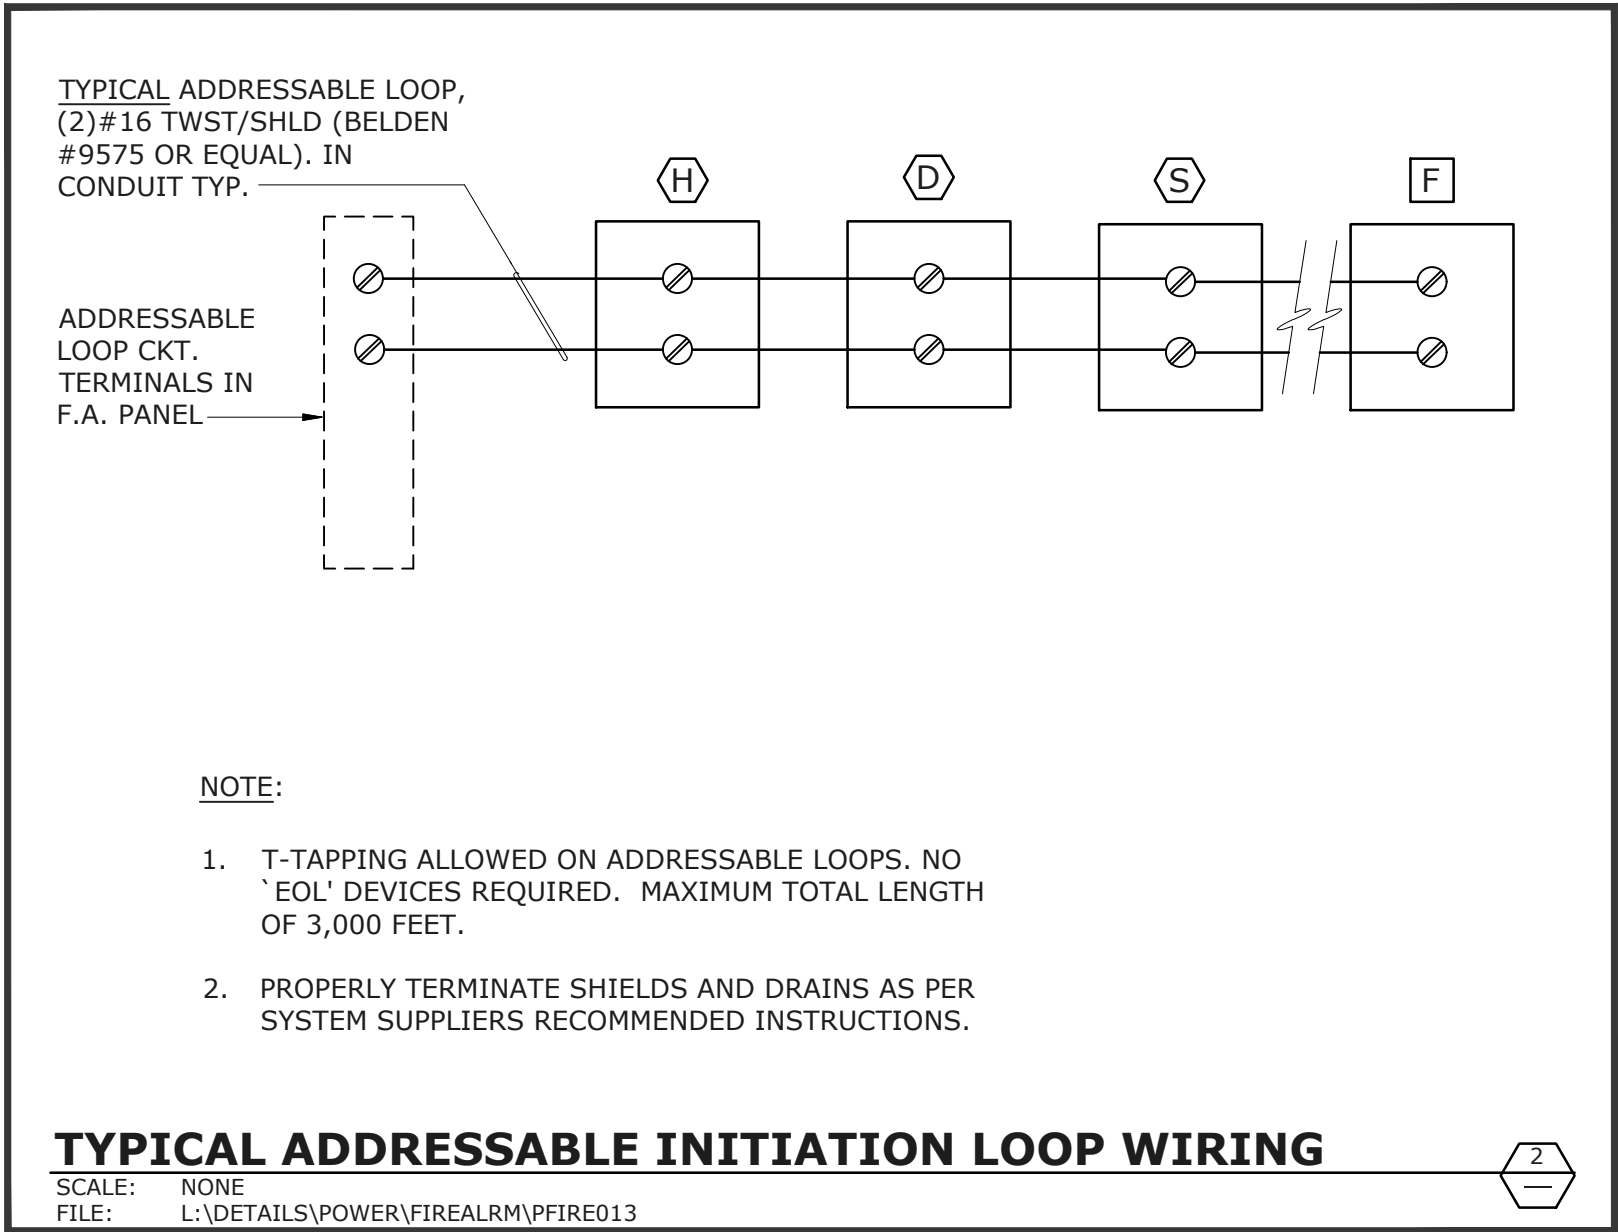
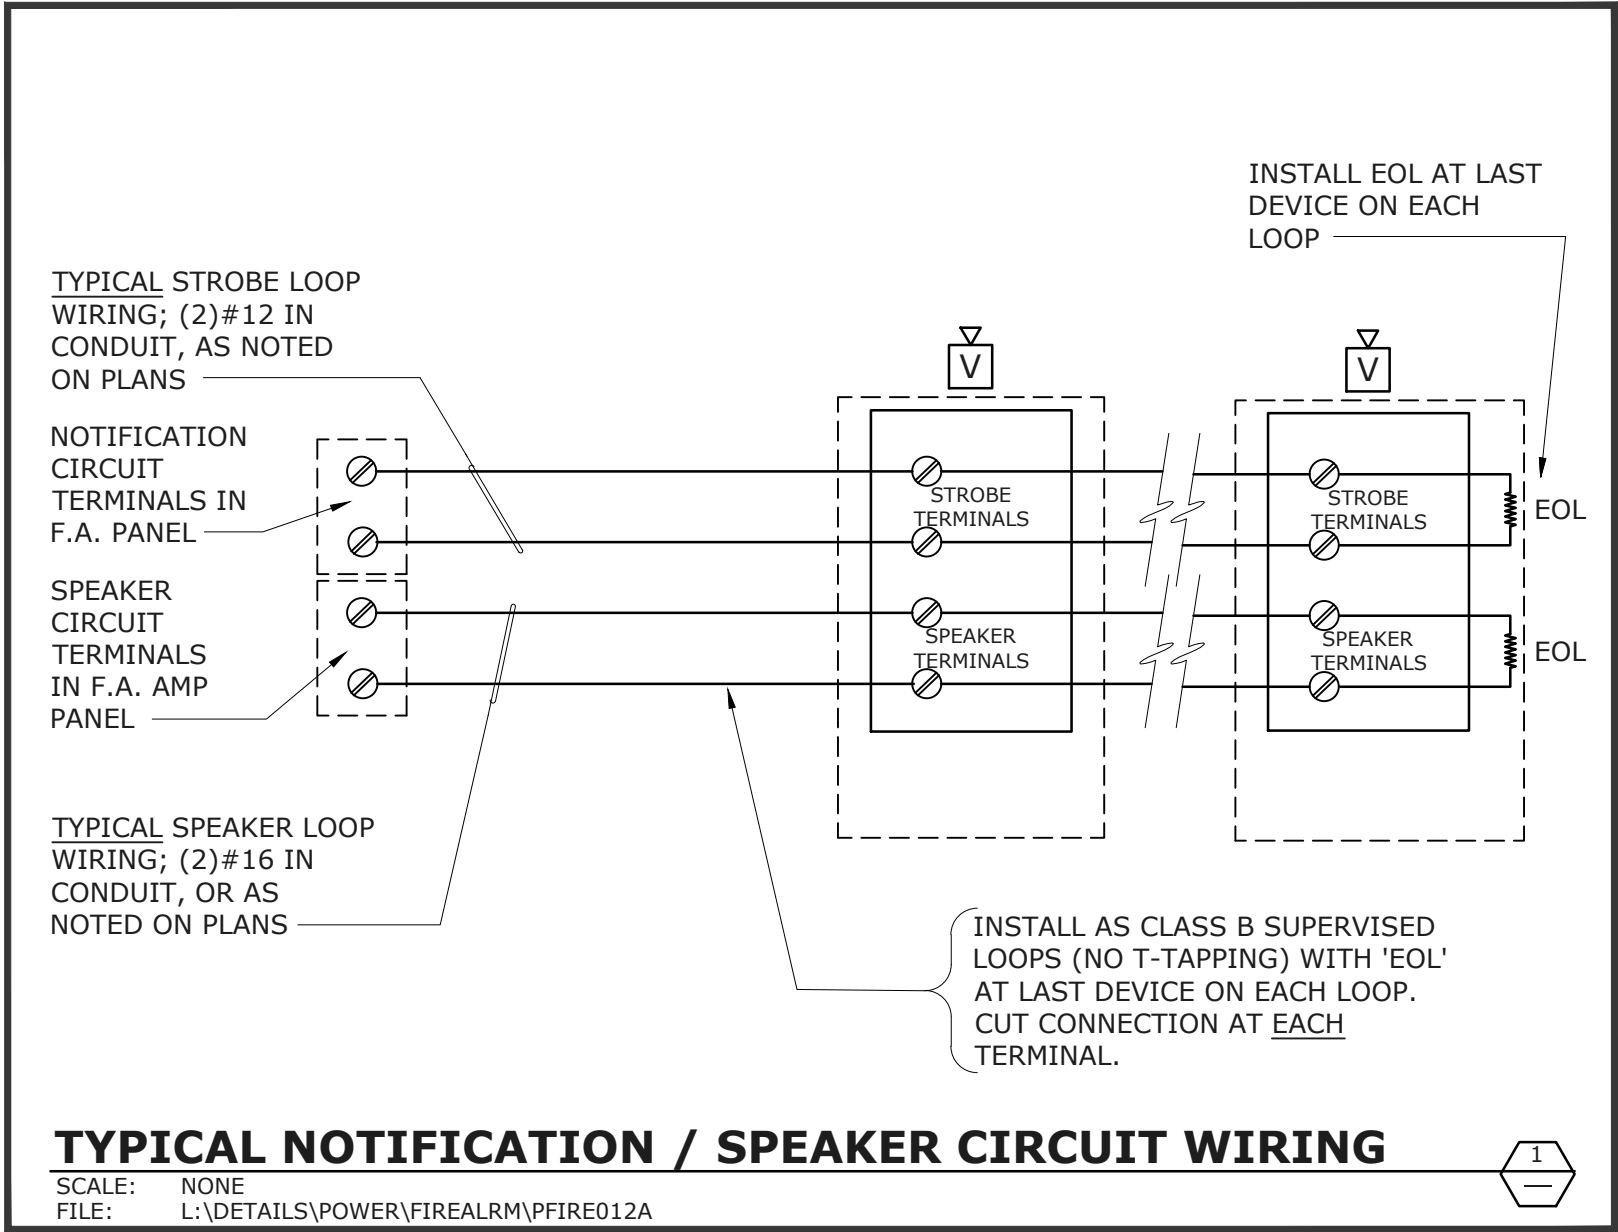
NO.	DESCRIPTION

DSA APP NO. 01-119278  
ARCH PROJECT NO: 1869.00  
DRAWN BY: LN,TV,JW,OOM  
DRAWING SCALE: AS NOTED  
PTN: 61721-78 FILE NO: 7-H4  
BID DOCUMENT  
APRIL 27, 2021  
SHEET TITLE

TITLE 24  
COMPLIANCE  
DOCUMENTS

E-8.2





FIRE ALARM WIRING LEGEND		
TAG	DESCRIPTION	CABLING
A	INITIATION CIRCUIT	(2) #16 TWISTED/UNSHIELDED
B	STROBE NOTIFICATION CIRCUIT(S)	(2) #12 THHN/THWN
C	SPEAKER NOTIFICATION CIRCUIT(S)	(2) #16 TWISTED/SHIELDED
D	SPEAKER NOTIFICATION CIRCUIT - SITE DIST.	(2) #14 TWISTED/SHIELDED
E	TRANSPONDER NETWORKING	(2) #16 TWISTED/SHIELDED + (2) #14 THHN/THWN
F	BEAM DET. CONTROL WIRING	(1) #14 2-CORE SHIELDED CABLE
G	CONSTANT 24V SUPPLY	(2) #14 THHN/THWN

NOTE:  
CONTRACTOR SHALL VERIFY EXACT CABLE/WIRE TYPES WITH SYSTEM MANUFACTURER PRIOR TO ROUGH-IN.

- ### GENERAL FIRE ALARM NOTES
- FINAL FIRE ALARM TEST SHALL BE MADE WITH THE DSA INSPECTOR OF RECORD (IOR). LOCAL FIRE AUTHORITY SHALL BE NOTIFIED OF DATE AND TIME OF FINAL ALARM TESTING AND SHALL ASSIST/WITNESS SUCH TESTING WHEN ABLE. DSA/ARCHITECT/ENGINEER AND OWNER SHALL BE NOTIFIED A MINIMUM OF (48) HOURS PRIOR TO THE FINAL INSPECTION AND/OR TESTING.
  - FIRE ALARM CONTRACTOR SHALL PROVIDE SYSTEM PROGRAMMING FOR SUPERVISORY MONITORING PER CBC SECTION 901.6.2. MONITORING SHALL BE TESTED AND VERIFIED AS SENDING THE CORRECT SIGNALS IN CONJUNCTION WITH FINAL ACCEPTANCE TEST. OWNER SHALL BE RESPONSIBLE FOR ESTABLISHING A FIRE SYSTEM MONITORING CONTRACT AND/OR PROVISIONS.
  - UNDERGROUND AND EXTERIOR CONDUITS SHALL HAVE WATERTIGHT FITTINGS.
  - FIRE ALARM DEVICE MOUNTING HEIGHTS:  
**PULL STATION:** 48" TO TOP OF OPERATOR ABOVE FINISHED FLOOR.  
**HORN INTERIOR:** 90" MIN. TO TOP OF DEVICE ABOVE FINISHED FLOOR, OR 100" MAX TO TOP OF DEVICE, BUT NOT LESS THAN 6" FROM CEILING.  
**WALL MOUNTED STROBE OR HORN/STROBE:** BETWEEN 80" TO BOTTOM OF DEVICE LENS TO +96" TO TOP OF DEVICE LENS ABOVE FINISH FLOOR, BUT NOT LESS THAN 6" FROM CEILING.
  - AUDIBLE FIRE ALARM SYSTEM LEVEL SHALL BE AT LEAST 15dBA ABOVE THE AVERAGE AMBIENT SOUND LEVEL IN ALL OCCUPABLE AREAS, OR 5 dBA ABOVE THE MAXIMUM SOUND LEVEL HAVING A DURATION OF AT LEAST 60 SECONDS, WHICHEVER IS GREATER, MEASURED AT 5 FEET ABOVE THE FLOOR. AUDIBLE SIGNALS SHALL NOT BE LESS THAN 75dBA AT 10 FEET, OR MORE THAN 110dBA AT THE MINIMUM HEARING DISTANCE.
  - AUDIBLE DEVICES SHALL BE SYNCHRONIZED TEMPORAL THREE DISTINCTIVE FIRE ALARM SOUND PER NFPA 72.
  - APPLICABLE CODES:
    - CBC 2019; CEC 2016; CMC 2016; CFC 2016.
    - STATE FIRE MARSHAL TITLE 19, PUBLIC SAFETY.
    - NFPA 72, 2016 EDITION W/CA AMENDMENTS, FIRE ALARM CODE.
  - STROBES SHALL FLASH AT A RATE NOT EXCEEDING TWO FLASHES PER SECOND, AND NOT LESS THAN ONE FLASH EVERY SECOND. THE DEVICE SHALL HAVE A PULSING LIGHT SOURCE NOT LESS THAN 15 CANDELA. VISUAL DEVICES WITHIN 55 FEET OF EACH OTHER SHALL BE SYNCHRONIZED.
  - FIRE ALARM CONTRACTOR SHALL PROVIDE A COPY OF NFPA 72 SYSTEM RECORD OF COMPLETION, SYSTEM RECORD OF INSPECTION AND TESTING, AND THE "EMERGENCY COMMUNICATIONS SUPPLEMENTARY RECORD OF COMPLETION", TO THE INSPECTOR OF RECORD IOR/DSA, SCHOOL DISTRICT, ARCHITECT AND LOCAL FIRE AUTHORITY.
  - POWER SERVICE TO THE FACP, REMOTE POWER SUPPLIES, AND CENTRAL STATION AUTO DIALER SHALL BE ON A DEDICATED BRANCH CIRCUIT WITH A RED MARKING AND IDENTIFIED AS "FIRE ALARM CIRCUIT CONTROL".
  - INSTALL ALL WIRING IN CONDUIT, MIN. 3/4" CONDUIT. ALL FIRE ALARM SYSTEM WIRING SHALL BE FPL (FIRE POWER LIMITED) OR FPLP (FIRE POWER LIMITED PLENUM RATED) AS REQUIRED FOR APPLICATION. WIRING IN CONDUIT ABOVE GROUND MAY BE THHN OR THWN.
  - CONDUIT AND WIRING SHALL BE PER MANUFACTURERS REQUIREMENTS.
  - ALL FIRE ALARM COMPONENTS SHALL BE SECURED TO MOUNTING SURFACES PER MANUFACTURERS SPECIFICATIONS. NO SINGLE DEVICES/EQPT. SHALL EXCEED 20LBS. WITHOUT SPECIAL MOUNTING DETAILS.
  - INSTALLATION OF SYSTEM SHALL NOT BE STARTED UNTIL COMPLETE SET OF CONSTRUCTION DOCUMENTS (WITH DEVICE TYPES AND LISTINGS) HAVE BEEN REVIEWED AND APPROVED BY DSA.
  - A STAMPED SET OF APPROVED PLANS SHALL BE ON THE JOB SITE AT ALL TIMES AND SHALL BE USED FOR INSTALLATION.
  - ANY DISCREPANCIES BETWEEN THE CONTRACT DOCUMENTS AND CODE OR RECOGNIZED STANDARDS SHALL BE BROUGHT TO THE ATTENTION OF DSA AND ARCHITECT/ENGINEER OF RECORD.
  - THE CONTRACTOR SHALL INSTALL AND ADJUST ALL DEVICES TO MAXIMIZE PERFORMANCE AND TO MINIMIZE FALSE ALARMS.
  - SMOKE DETECTORS SHALL NOT BE ANY CLOSER THAN 1 FOOT FROM FIRE SPRINKLER HEADS OR 3 FEET FROM ANY SUPPLY DIFFUSER. IN AREAS OF CONSTRUCTION OR POSSIBLE DAMAGE /CONTAMINATION, INSTALLED DEVICES SHALL BE COVERED UNTIL AREA IS READY TO BE TURNED OVER TO THE OWNER.
  - PER CEC STANDARDS, ALL WIRING IS TO BE PULLED THROUGH EACH JUNCTION BOX AND CONNECTED DIRECTLY TO EACH FIRE ALARM DEVICE. DO NOT SPLICE WIRE. THERE MUST BE AT LEAST 6" OF WIRE LEAD FROM THE BOX TO THE DEVICE. ALL BOXES TO BE SIZED PER CEC FOR PROPER VOLUME WITH INSTALLED WIRING AND DEVICES.
  - SUPERVISING STATION: AUTOMATIC FIRE ALARM SYSTEMS SHALL TRANSMIT THE ALARM, SUPERVISORY AND TROUBLE SIGNALS TO AN APPROVED SUPERVISING STATION AS REQUIRED BY NFPA 72, AS AMENDED BY CFC CHAPTER 80. THE SUPERVISION STATION SHALL BE LISTED AS EITHER UJFX OR UJJS BY UNDERWRITERS LABORATORY OR SHALL MEET THE REQUIREMENTS OF FACTORY MUTUAL RESEARCH APPROVAL STANDARD 3011.
  - A DOCUMENTATION CABINET SHALL BE INSTALLED ADJACENT TO THE FACP IN THE MAIN ELECTRICAL ROOM (NFPA 72, 7.7.2.1). SPACE AGE ELECTRONICS INC, ACERBOX FAD SERIES (#SSU0685 OR EQUAL).
  - ALL RECORD DOCUMENTATION SHALL BE STORED IN THE DOCUMENTATION CABINET (NFPA 72, 7.7.2.3): PROVIDE NAMEPLATE "FIRE ALARM SYSTEM RECORD DOCUMENTS" (NFPA 72, 7.7.2.5).
  - FIRE ALARM MANUAL PULLSTATIONS SHALL MEET THE CALIFORNIA ACCESSIBILITY REQUIREMENTS OUTLINED IN THE CBC ("CONTROLS AND OPERATING MECHANISMS SHALL BE OPERABLE WITH ONE HAND AND NOT REQUIRE TIGHT GRASPING, PINCHING OR TWISTING OF THE WRIST. THE FORCE TO ACTIVATE THE CONTROLS SHALL BE NO GREATER THAN 5 POUNDS OF FORCE". REFER TO DSA ACCESSIBILITY STAFF FOR QUESTIONS OR CLARIFICATION.)

FIRE ALARM EQUIPMENT LIST					
SYMBOL	DESCRIPTION	MANUFACTURER & MODEL NUMBER	CSFM LISTING NUMBER	STANDBY CURRENT	ALARM CURRENT
FAEVP	(E) FIRE ALARM VOICE EVAC CONTROL PANEL WITH DIGITAL AUDIO CONTROLLER, AMPLIFIER & MICROPHONE	SIMPLEX 4100ES	7165-0026:0251	373mA 200mA	470mA 250mA
FAEP	FIRE ALARM MINIPLEX TRANSPONDER	SIMPLEX 4100-9600	7165-0026:0251	87mA	87mA
M	ADDRESSABLE MONITOR MODULE W/ EOLR	SIMPLEX 4090-9001	7300-0026:0223	-	5.10mA
R	ADDRESSABLE RELAY MODULE	SIMPLEX 4090-9002	7300-0026:0223	-	-
S	ADDRESSABLE PHOTOELECTRIC SMOKE DETECTOR	SIMPLEX 4098-9714	7272-0026:0218	0.40mA	1mA
CB	ADDRESSABLE CARBON MONOXIDE DETECTOR BASE	SIMPLEX 4098-9771	7300-0026:0330	1mA	17mA
-	DETECTOR BASE	SIMPLEX 4098-9792	7300-0026:0217	-	-
B	PROJECTED BEAM DETECTOR TRANSMITTER/RECEIVER WITH ADDRESSABLE SYSTEM CONTROLLER	SIEMENS F5000	7260-1508:0104	8.50mA	8.50mA
B	PROJECTED BEAM SMOKE DETECTOR - REFLECTOR	(UNIT INCLUDED WITH TRANSMITTER/RECEIVER)	-	-	-
SP	VISUAL STROBE, WALL MOUNT, SELECTABLE CANDELA UL 1971 PUBLIC MODE NOTIFICATION	SIMPLEX 4906-9103	7125-0026:0316	-	-
			15cd	0mA	53mA
			30cd	0mA	84mA
			75cd	0mA	165mA
			110cd	0mA	224mA
V	COMBINATION VISUAL STROBE AND SPEAKER, WALL MOUNT, SELECTABLE CANDELA UL 1971 PUBLIC MODE NOTIFICATION, VISUAL DEVICE	SIMPLEX 4906-9153 (1/2 WATT TAP)	7320-0026:0247	-	-
			STROBE CKT: 15cd	0mA	53mA
			STROBE CKT: 30cd	0mA	84mA
			STROBE CKT: 75cd	0mA	165mA
			STROBE CKT: 110cd	0mA	224mA
SP	EXTERIOR AUDIBLE SPEAKER WITH WEATHER-PROOF BACKBOX	WHEELLOCK #ET-1010R (1W TAP)	7320-0785:0105	0mA	7mA

NOTE:  
DETECTOR SUBSCRIPTS:  
"c" - DETECTOR IN ACCESSIBLE CEILING SPACE  
"p" - DETECTOR WITHIN 38° OF PEAK

- ### FIRE ALARM SYSTEM DESCRIPTION
- THE FIRE ALARM SYSTEM SHALL BE AN AUTOMATIC ADDRESSABLE SYSTEM WITH STYLE 4, CLASS B WIRING FOR NAC'S AND SLC'S TO MATCH EXISTING.
  - CIRCUIT PATHWAY SURVIVABILITY SHALL BE LEVEL 1.
  - PROVIDE AND INSTALL NEW EQUIPMENT, DEVICES AND REQUIRED MODULES FULLY COMPATIBLE WITH (E) FACP AND PROVIDE CONNECTIONS COMPLETE FOR A FULLY FUNCTIONING NETWORKED FIRE ALARM SYSTEM.
  - THE NEW FIRE ALARM SYSTEM INCLUDES EMERGENCY VOICE / ALARM COMMUNICATION REQUIREMENTS.
  - THE NAME OF THE SPECIFIC PERSON RESPONSIBLE FOR THE SYSTEM DESIGN IS "CHRIS LIPPINCOTT" (OMAHONY & MYER).
  - SYSTEM INSTALLATION SHALL BE BY A LICENSED ELECTRICAL OR FIRE ALARM CONTRACTOR WITH A CALIFORNIA C-10 LICENSE, REGULARLY ENGAGED IN THE INSTALLATION AND COMMISSIONING OF FIRE ALARM SYSTEMS TO NFPA 72 STANDARDS. INSTALLING CONTRACTOR'S NAME AND CONTACT INFORMATION SHALL BE LISTED IN THE NFPA CLOSE OUT DOCUMENTATION AT COMPLETION OF PROJECT.

- ### FIRE ALARM SCOPE OF WORK
- TERMINATE EACH NOTIFICATION LOOP TO THE FAEP OR RAMP AS SHOWN ON PLANS AND RISER DIAGRAM.
  - TERMINATE EACH INITIATION LOOP AT THE FAEP AS SHOWN ON PLANS AND RISER DIAGRAM.
  - IDENTIFY FIRE ALARM CIRCUITS AT TERMINAL AND JUNCTION LOCATIONS TO PREVENT INTERFERENCE WITH THE FIRE ALARM SYSTEM WHEN OTHER ADJACENT SYSTEMS ARE BEING TESTED OR SERVICED.
  - PROVIDE A COMPLETE NETWORK FIRE ALARM SYSTEM, INCLUDING REMOTE POWER SUPPLY TERMINAL CABINETS, EXPANDER PANELS, OUTLETS, DEVICES AND WIRING FOR THE FACILITY AS SHOWN.
  - FINAL SYSTEM PROGRAMMING SHALL BE DONE BASED ON ACTUAL PHYSICAL ROOM NAMES AND NUMBERS USED AT THE SITE (IF DIFFERENT FROM THE ROOM NAMES OR NUMBERS SHOWN ON THE APPROVED PLANS).

- ### SEQUENCE OF OPERATION
- MANUAL PULL STATION - WHEN A PULL STATION IS PULLED, IT SHALL ANNUNCIATE AN ALARM AT THE FACP. ALARM SHALL ACTIVATE ALL AUDIO AND VISUAL DEVICES THROUGHOUT THE CAMPUS.
  - SMOKE AND HEAT DETECTORS - WHEN A SMOKE OR HEAT DETECTOR IS ACTIVATED, IT SHALL ANNUNCIATE AN ALARM AT THE FACP. ALARM SHALL ACTIVATE ALL AUDIO AND VISUAL DEVICES THROUGHOUT THE CAMPUS.
  - ANY BUILDING POWER FAILURE- IF THE BUILDING LOSES POWER, THE FAILURE SHALL SHOW UP AS A TROUBLE SIGNAL ON THE FACP. THE SYSTEM SHALL STAY ACTIVE ON BATTERY BACK-UP POWER IN ACCORDANCE WITH THE STATE FIRE CODE.
  - SYSTEM SHALL INDICATE TROUBLE ALARMS FOR ALL SYSTEM FAULTS (i.e. GROUND FAULTS, SHORTS, OPEN CIRCUITS, BATTERY DISCONNECT, ETC.).
  - FIRE SPRINKLER SYSTEM - WHEN A FLOW SWITCH IS ACTIVATED, IT SHALL ANNUNCIATE AN ALARM AT THE MAIN FACP. ALARM SHALL ACTIVATE ALL AUDIO AND VISUAL DEVICES THROUGHOUT THE CAMPUS. WHEN TAMPER SWITCH IS ACTIVATED, IT SHALL ANNUNCIATE A SUPERVISORY ALARM AT THE MAIN FACP.
  - UPON ALARM CONDITION, AUTO DIALER TO NOTIFY THE SUPERVISING STATION, AND AUTHORIZED SCHOOL PERSONNEL TO NOTIFY THE FIRE DEPARTMENT AND INITIATE EVACUATION OF STUDENTS AND FACULTY AS PER THE SCHOOL'S EVACUATION PLAN.
  - UPON TROUBLE CONDITION, AUTO DIALER TO NOTIFY THE SUPERVISING STATION, AND AUTHORIZED SCHOOL PERSONNEL TO NOTIFY AUTHORIZED TECHNICIAN TO CORRECT THE TROUBLE CONDITION.
  - UPON CO DETECTION, IT SHALL ANNUNCIATE AN ALARM AT THE FACP AND REMOTE ANNUNCIATOR ONLY AND SHALL ACTIVATE THE CO DETECTOR SOUNDER BASE WITH TEMPORAL 4 FORM IN THE CLASSROOM. SCHOOL PERSONNEL TO NOTIFY THE OCCUPANTS, IMMEDIATELY AND INITIATE EVACUATION OF STUDENTS & FACULTY.

**QUATTROCCHI KWOK ARCHITECTS**  
Main Office:  
636 Fifth Street, Santa Rosa, CA 95404  
East Bay:  
55 Harrison Street, Suite 525  
Oakland, CA 94607  
(707) 576-0829

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Electrical, Mechanical and Low Voltage Design  
490 REDWOOD HWY, SUITE 245  
SAN RAFAEL, CALIFORNIA 94903  
(415) 492-0807 / FAX (415) 492-0868  
www.omahonnydesign.com

**P. O'Mahony**  
REGISTERED PROFESSIONAL ELECTRICAL ENGINEER  
No. 14738  
Exp. 6/31  
STATE OF CALIFORNIA

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DSA APP NO. 01-119278

ARCH PROJECT NO: 1869.00

DRAWN BY: LN.TV,JVLLOOM

DRAWING SCALE: AS NOTED

PTN: 61721-78 FILE NO: 7-H4

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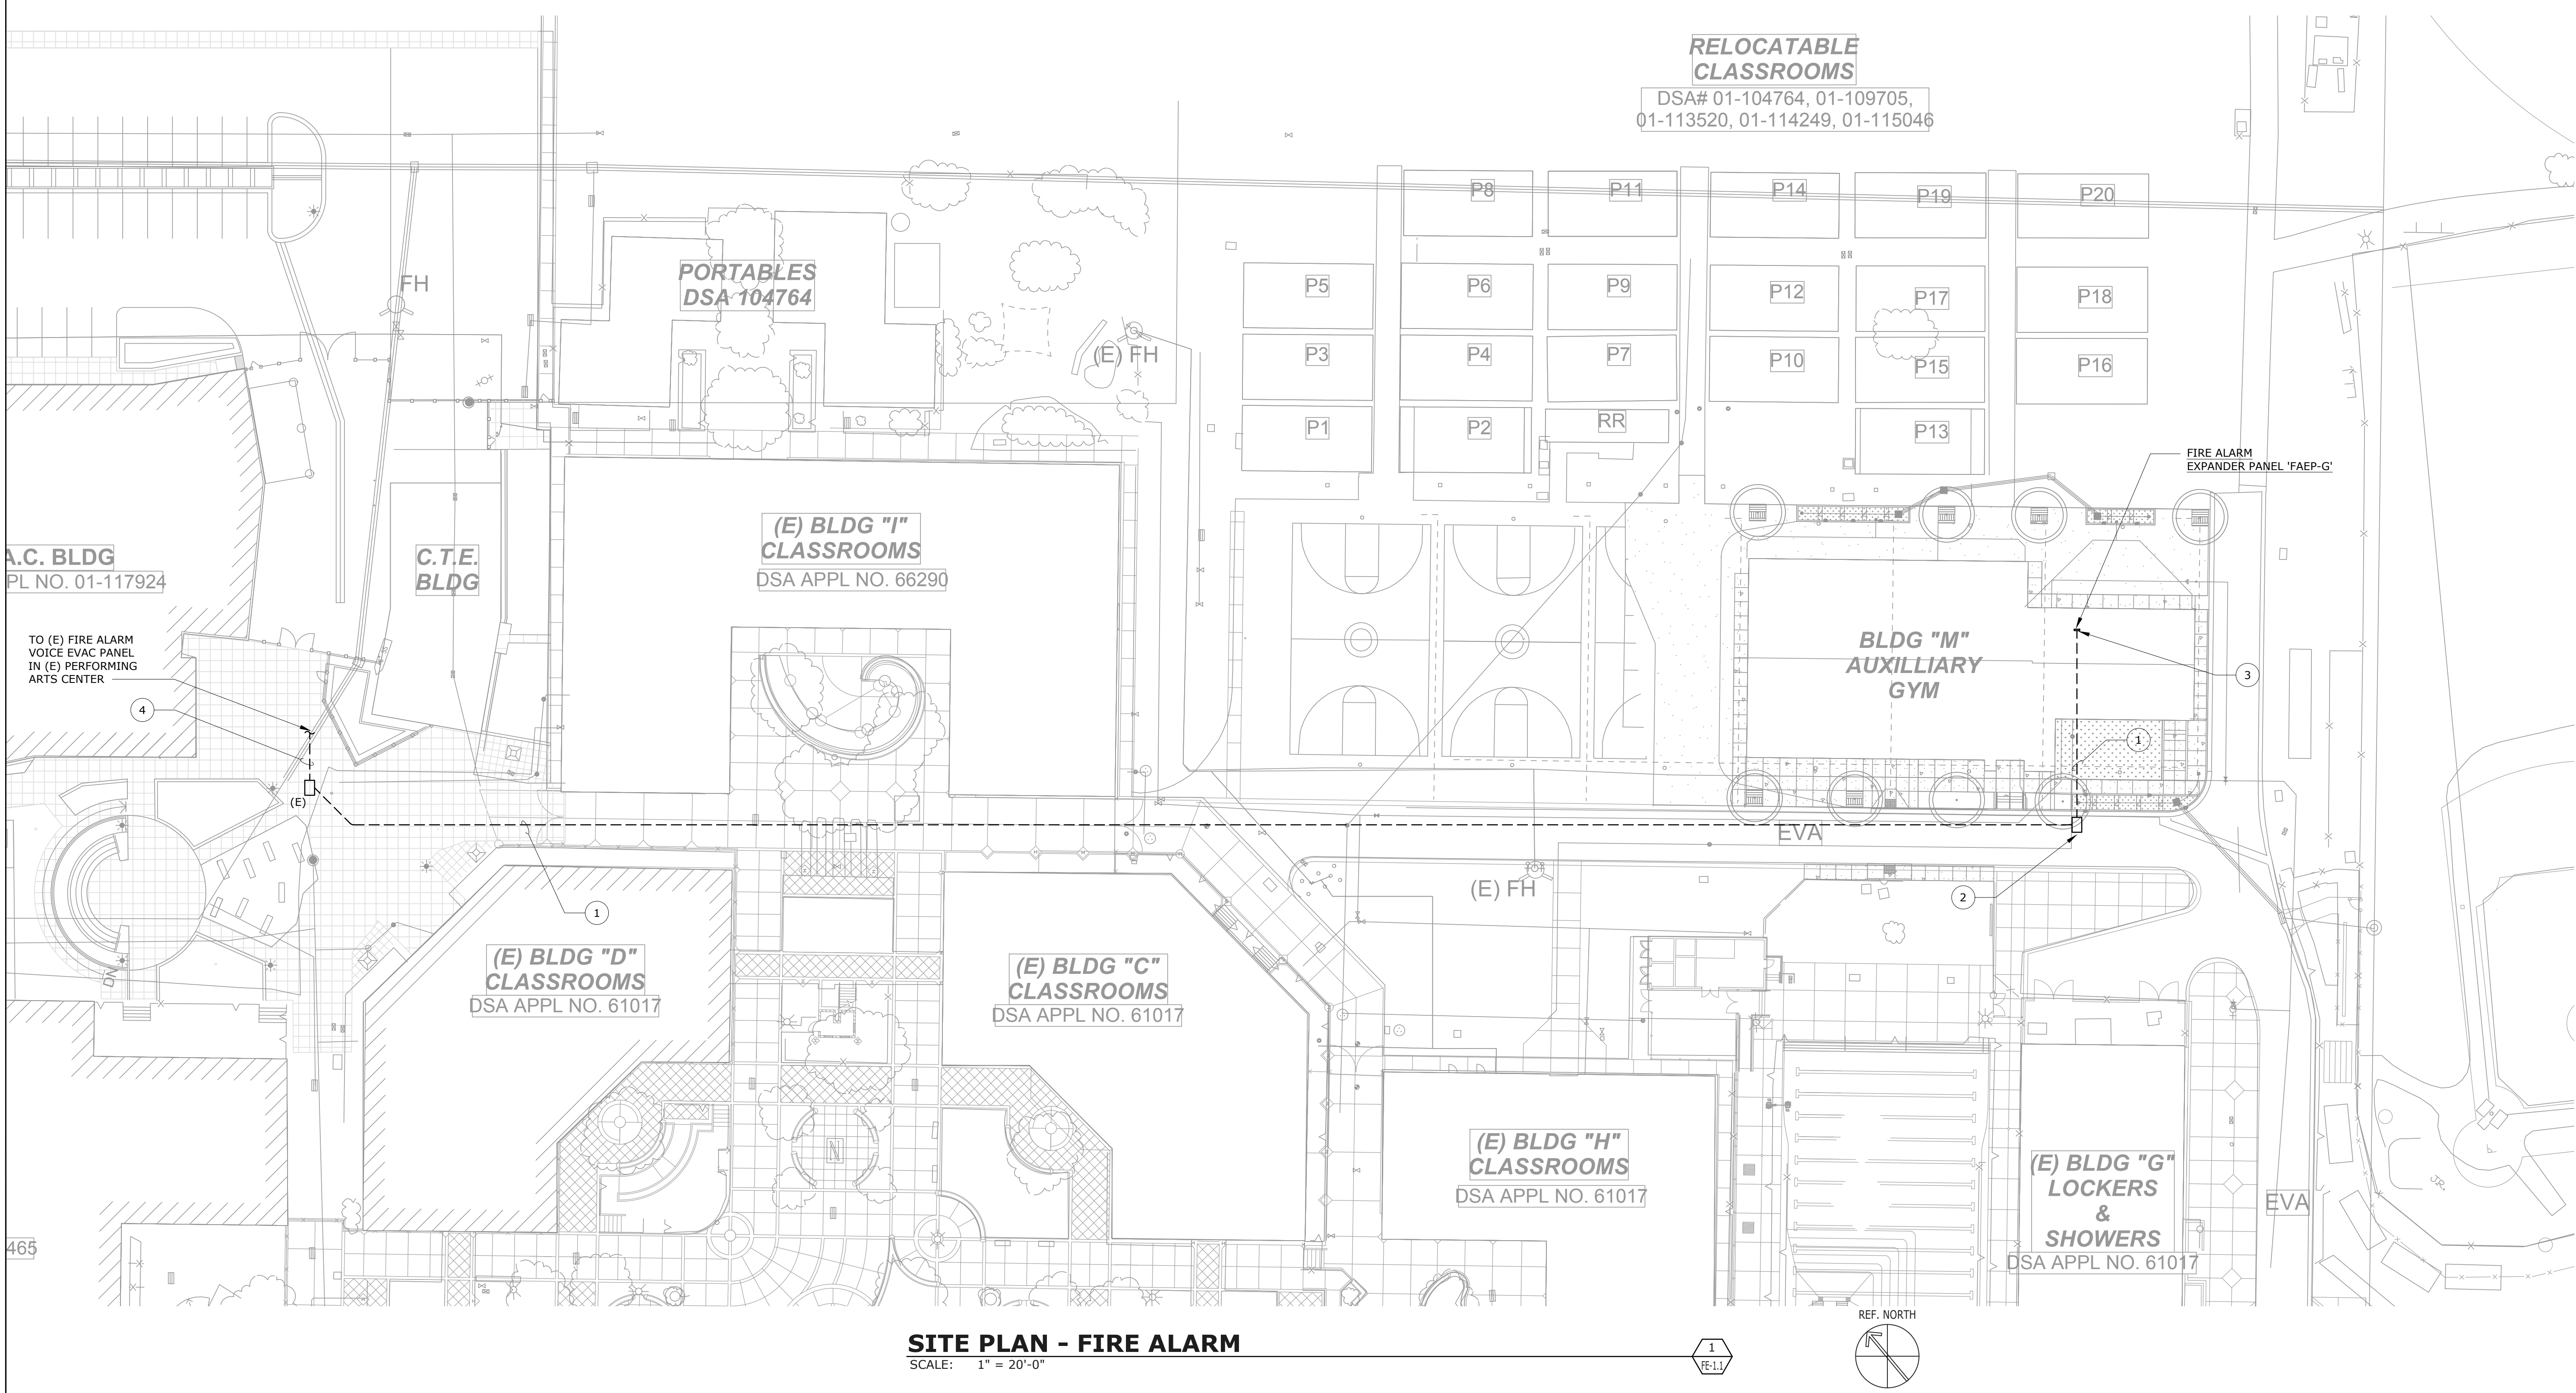
SHEET TITLE

**FIRE ALARM EQUIPMENT LIST, NOTES & DETAILS**

SHEET NUMBER

**FE-0.1**





**SITE PLAN - FIRE ALARM**  
SCALE: 1" = 20'-0"

**NUMBERED SHEET NOTES**

- 1 PROVIDE AND INSTALL 3" UNDERGROUND SCHEDULE 40 PVC RACEWAY. SEE 8/E-7.1.
- 2 PROVIDE AND INSTALL FLUSH, IN-GRADE PULLBOX, CHRISTY (OR EQUAL), WITH COVER LABELED "FIRE ALARM". PULLBOX SHALL BE "TRAFFIC RATED" REINFORCED CONCRETE WITH STEEL FRAME AND STEEL COVER. SIZE PULLBOX PER NEC. SEE 2/E-7.2.
- 3 STUB FIRE ALARM RACEWAY UP IN STORAGE 110 AND CONNECT COMPLETE TO FIRE ALARM PANEL.
- 4 UTILIZE (E) UNDERGROUND FIRE ALARM RACEWAY TO CONNECT (N) AUXILIARY GYM FAEP TO (E) FIRE ALARM VOICE EVAC PANEL IN (E) PERFORMING ARTS CENTER BUILDING.

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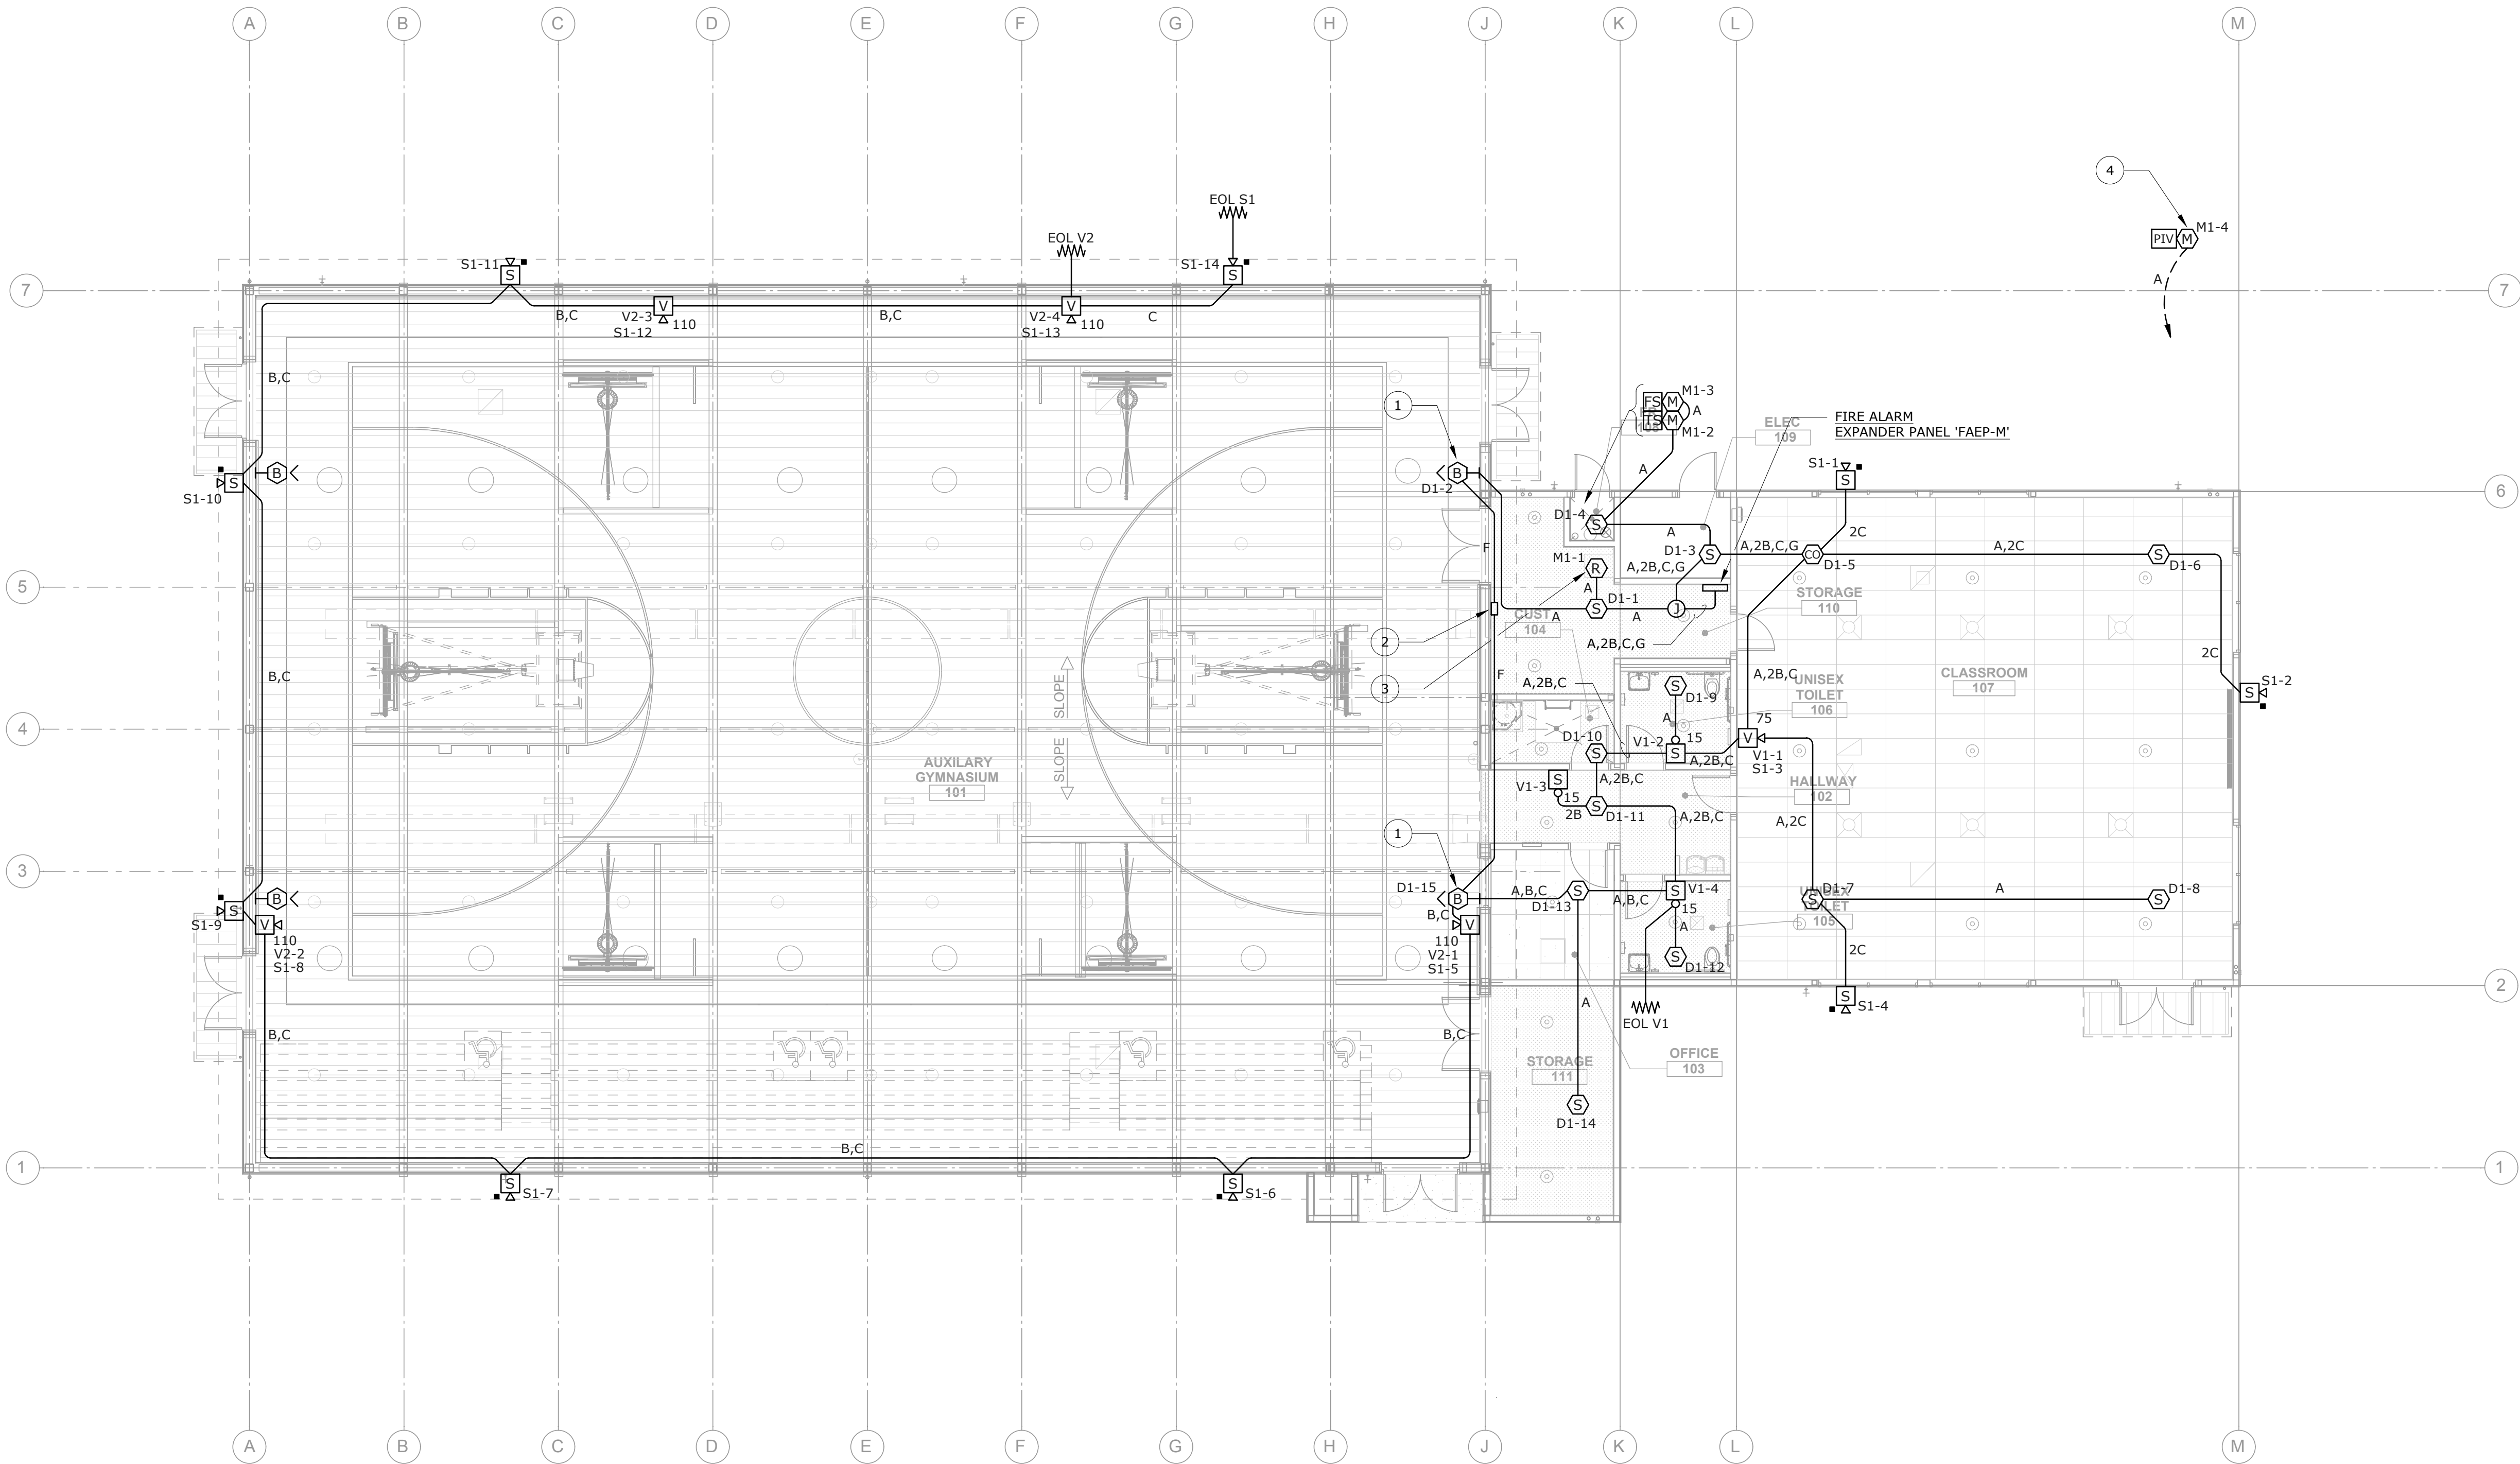
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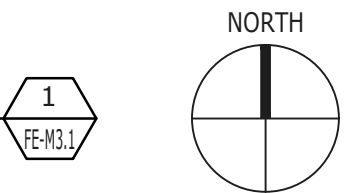
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**SITE PLAN - FIRE ALARM**  
SHEET NUMBER  
**FE-1.1**






**FLOOR PLAN - FIRE ALARM**  
SCALE: 1/8" = 1'-0"



NUMBERED SHEET NOTES

- 1 MOUNT BEAM DETECTOR TRANSMITTER AND ASSOCIATED RECEIVER BETWEEN 12" AND 18" BELOW ROOF. VERIFY CLEAR PATH FOR PROJECTED BEAM PRIOR TO ROUGH-IN.
- 2 PROVIDE AND INSTALL REMOTE CONTROLLER FOR PROJECTED BEAM DETECTORS. CONNECT COMPLETE TO DETECTORS WITH CONTROL WIRE AS SHOWN.
- 3 PROVIDE AND INSTALL RELAY MODULE TO FACILITATE BUILDING FIRE ALARM SYSTEM CONNECTION TO AV RACK. COORDINATE EXACT LOCATION WITH AV SYSTEM INSTALLER. CONNECTION TO AV RACK BY AV SYSTEM INSTALLER.
- 4 PROVIDE AND INSTALL MONITOR MODULE FOR PIV. CONNECT COMPLETE TO BUILDING SLC CIRCUIT VIA NEAREST ADJACENT INITIATION DEVICE. RUN WIRING IN 1" CONDUIT.

KEYPLAN

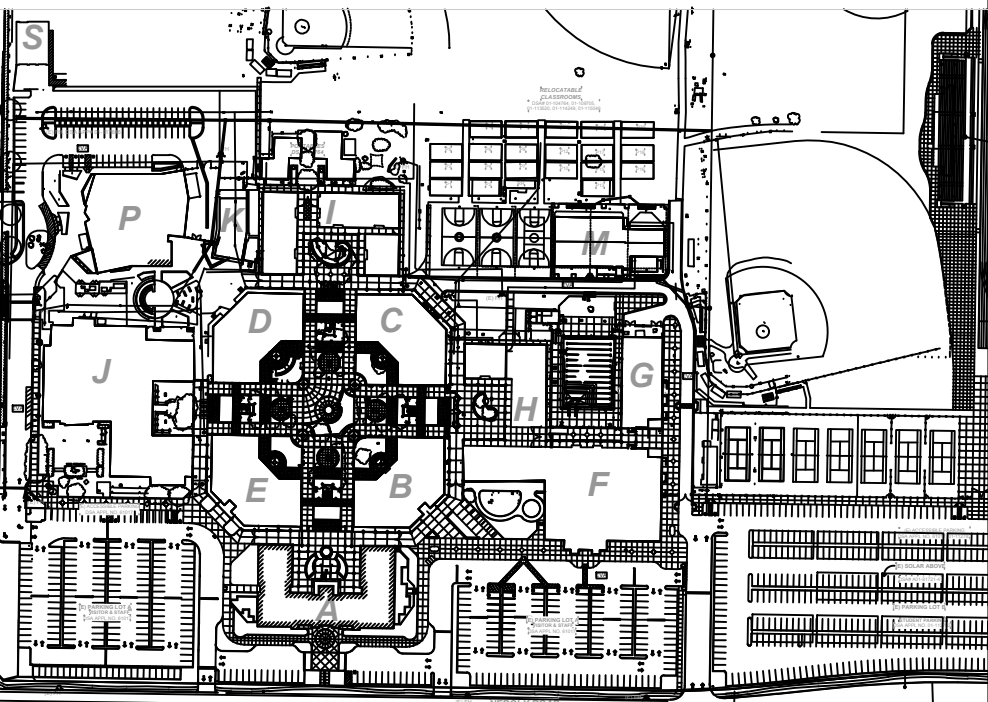

**QUATTROCCHI KWOK ARCHITECTS**  
Main Office:  
636 Fifth Street, Santa Rosa, CA 95404  
East Bay:  
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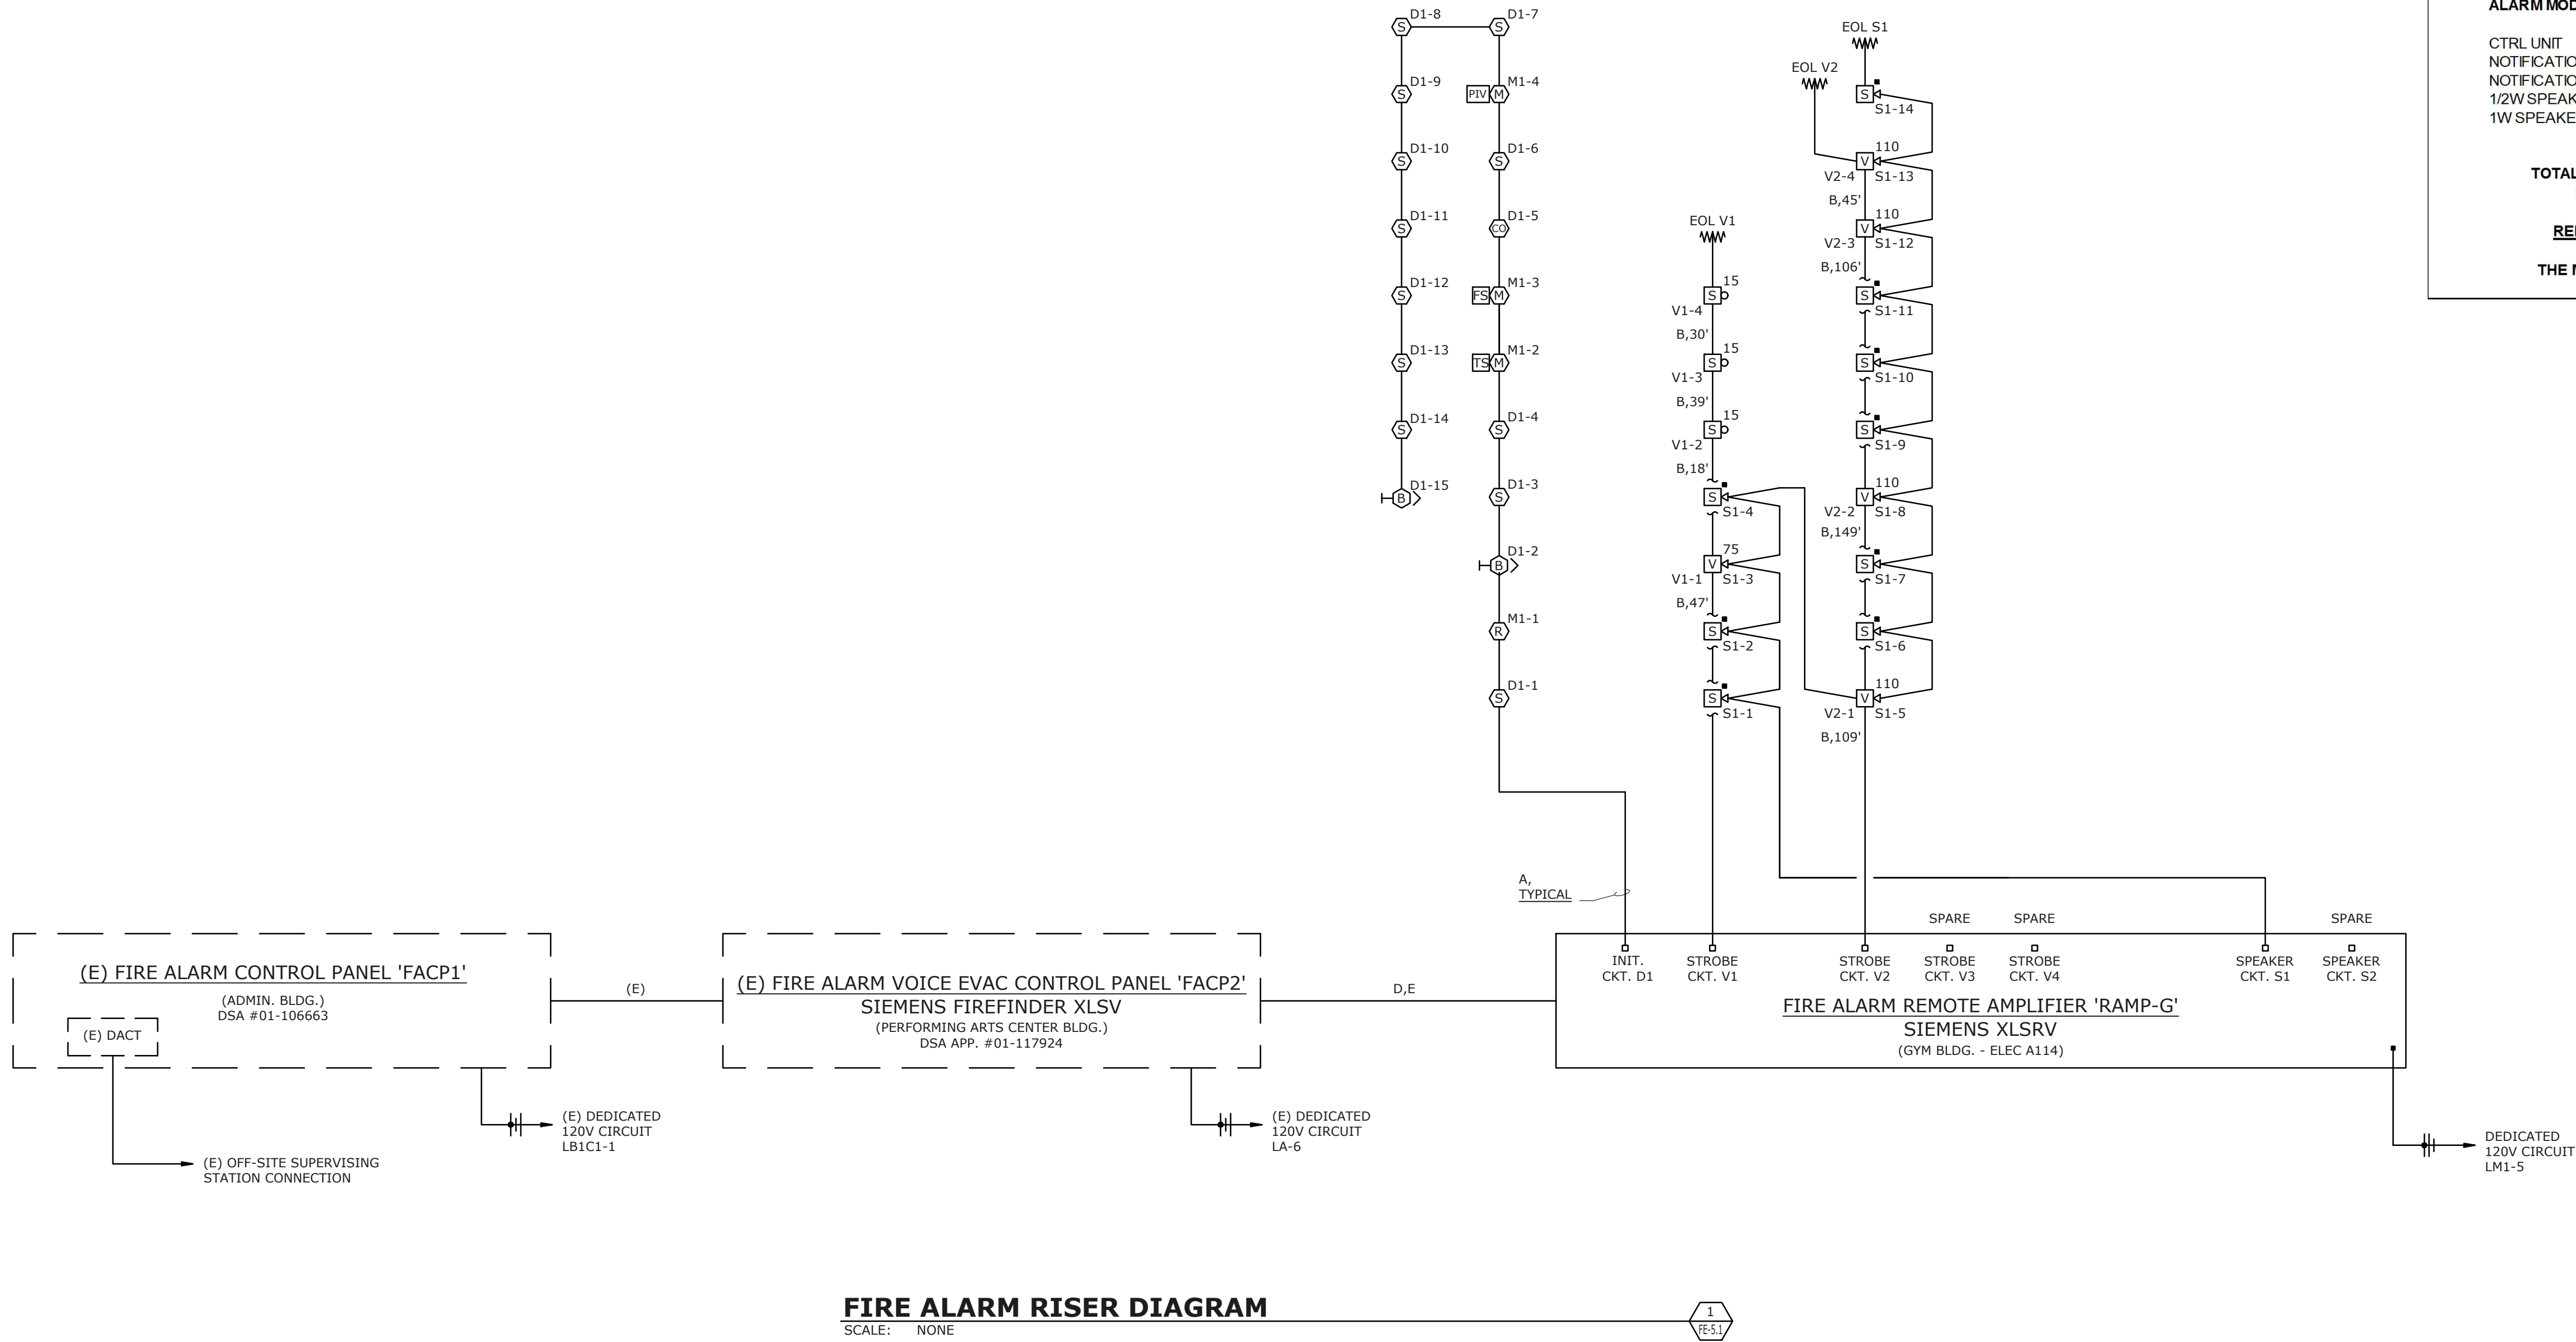
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**FLOOR PLAN - FIRE ALARM**

SHEET NUMBER

**FE-M3.1**





FIRE ALARM RISER DIAGRAM  
SCALE: NONE

VOLTAGE DROP CALCULATIONS

FIRE ALARM EXPANDER PANEL 'RAMP-G'

SIGNAL CIRCUIT:	V1				
TOTAL CKT CURRENT =	0.329 A				
MAX VOLT-DROP =	0.46%				
SYSTEM VOLTAGE =	20.4 V				
Device Address-->	V1-1	V1-2	V1-3	V1-4	
Type of Device -->	75spstr	15str	15str	15str	eol
Current of Device (Amp)-->	0.165	0.053	0.053	0.053	0.005
Size of Wire (AWG)-->	#12	#12	#12	#12	#12
Distance to each Device (Ft)-->	47	18	39	30	5
Current Total (Amp)-->	0.329	0.164	0.111	0.058	0.005
Device Volt-drop -->	0.29%	0.35%	0.43%	0.46%	0.46%
Device Volt -->	20.3	20.3	20.3	20.3	20.3

SIGNAL CIRCUIT:	V2				
TOTAL CKT CURRENT =	0.901 A				
MAX VOLT-DROP =	4.87%				
SYSTEM VOLTAGE =	20.4 V				
Device Address-->	V2-1	V2-2	V2-3	V2-4	
Type of Device -->	110spstr	110spstr	110spstr	110spstr	eol
Current of Device (Amp)-->	0.224	0.224	0.224	0.224	0.005
Size of Wire (AWG)-->	#12	#12	#12	#12	#12
Distance to each Device (Ft)-->	109	149	106	45	5
Current Total (Amp)-->	0.901	0.677	0.453	0.229	0.005
Device Volt-drop -->	1.86%	3.77%	4.68%	4.87%	4.87%
Device Volt -->	20.0	19.6	19.4	19.4	19.4

BATTERY CALCULATIONS: FIRE ALARM VOICE EVAC PANEL 'FACP2'

STANDBY MODE	EA (A)	QTY.	CURRENT
(E) CONTROL UNIT/LOADS	0.573	2	1.146
(E) ANNUNCIATOR	0.087	1	0.087
(E) DETECTORS, MODULES & REMOTE MIC	0.080	1	0.080
DETECTOR	0.0004	13	0.005
CO DETECTOR	0.0010	1	0.001
TOTAL STANDBY CURRENT =	1.319 A		
REQUIRED (24 HOURS) =	31.655 AH		

ALARM MODE	EA (A)	QTY.	CURRENT
(E) CONTROL UNIT/LOADS	0.720	2	1.440
(E) ANNUNCIATOR	0.087	1	0.087
(E) DETECTORS, MODULES & REMOTE MIC	0.006	1	0.006
DETECTOR	0.001	0	0.000
CO DETECTOR	0.017	0	0.000
MODULES	0.032	8	0.256
(E) 1/2W SPEAKERS	0.064	1	0.064
DETECTORS	0.006	13	0.078
CO DETECTOR	0.017	1	0.017
MODULES	0.005	4	0.020
TOTAL ALARM CURRENT =	1.968 A		
REQUIRED (15 MIN) =	0.492 AH		

TOTAL POWER REQUIRED WITH 120%  
BATTERY DERATING FACTOR = 38.576 AH


PROVIDE TWO 12V, 55AH BATTERIES  
MOUNTED IN SEPARATE ENCLOSURE  
BATTERIES SHALL BE MARKED WITH  
THE MONTH AND YEAR OF THEIR MANUFACTURE

BATTERY CALCULATIONS: FIRE ALARM EXTENDER PANEL 'RAMP-G'

STANDBY MODE	EA (A)	QTY.	CURRENT
CTRL UNIT	0.087	1	0.087
TOTAL STANDBY CURRENT =	0.087 A		
REQUIRED (24 HOURS) =	2.088 AH		

ALARM MODE	EA (A)	QTY.	CURRENT
CTRL UNIT	0.087	1	0.087
NOTIFICATION CKT V1	0.329	1	0.329
NOTIFICATION CKT V2	0.901	1	0.901
1/2W SPEAKERS	0.032	5	0.160
1W SPEAKERS	0.064	9	0.576
TOTAL POWER REQUIRED WITH 120% BATTERY DERATING FACTOR =	2.506 AH		


REPLACE (E) WITH TWO 12V, 9AH BATTERIES  
BATTERIES SHALL BE MARKED WITH  
THE MONTH AND YEAR OF THEIR MANUFACTURE

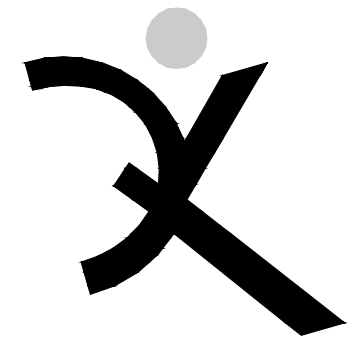

QUATTROCCHI KWOK  
ARCHITECTS  
Main Office:  
636 Fifth Street, Santa Rosa, CA 95404  
East Bay:  
55 Harrison Street, Suite 525  
Oakland, CA 94607  
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APRIL 27, 2021

SHEET TITLE

FIRE ALARM  
RISER  
DIAGRAM

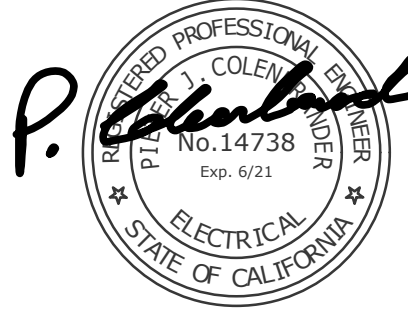
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FE-5.1







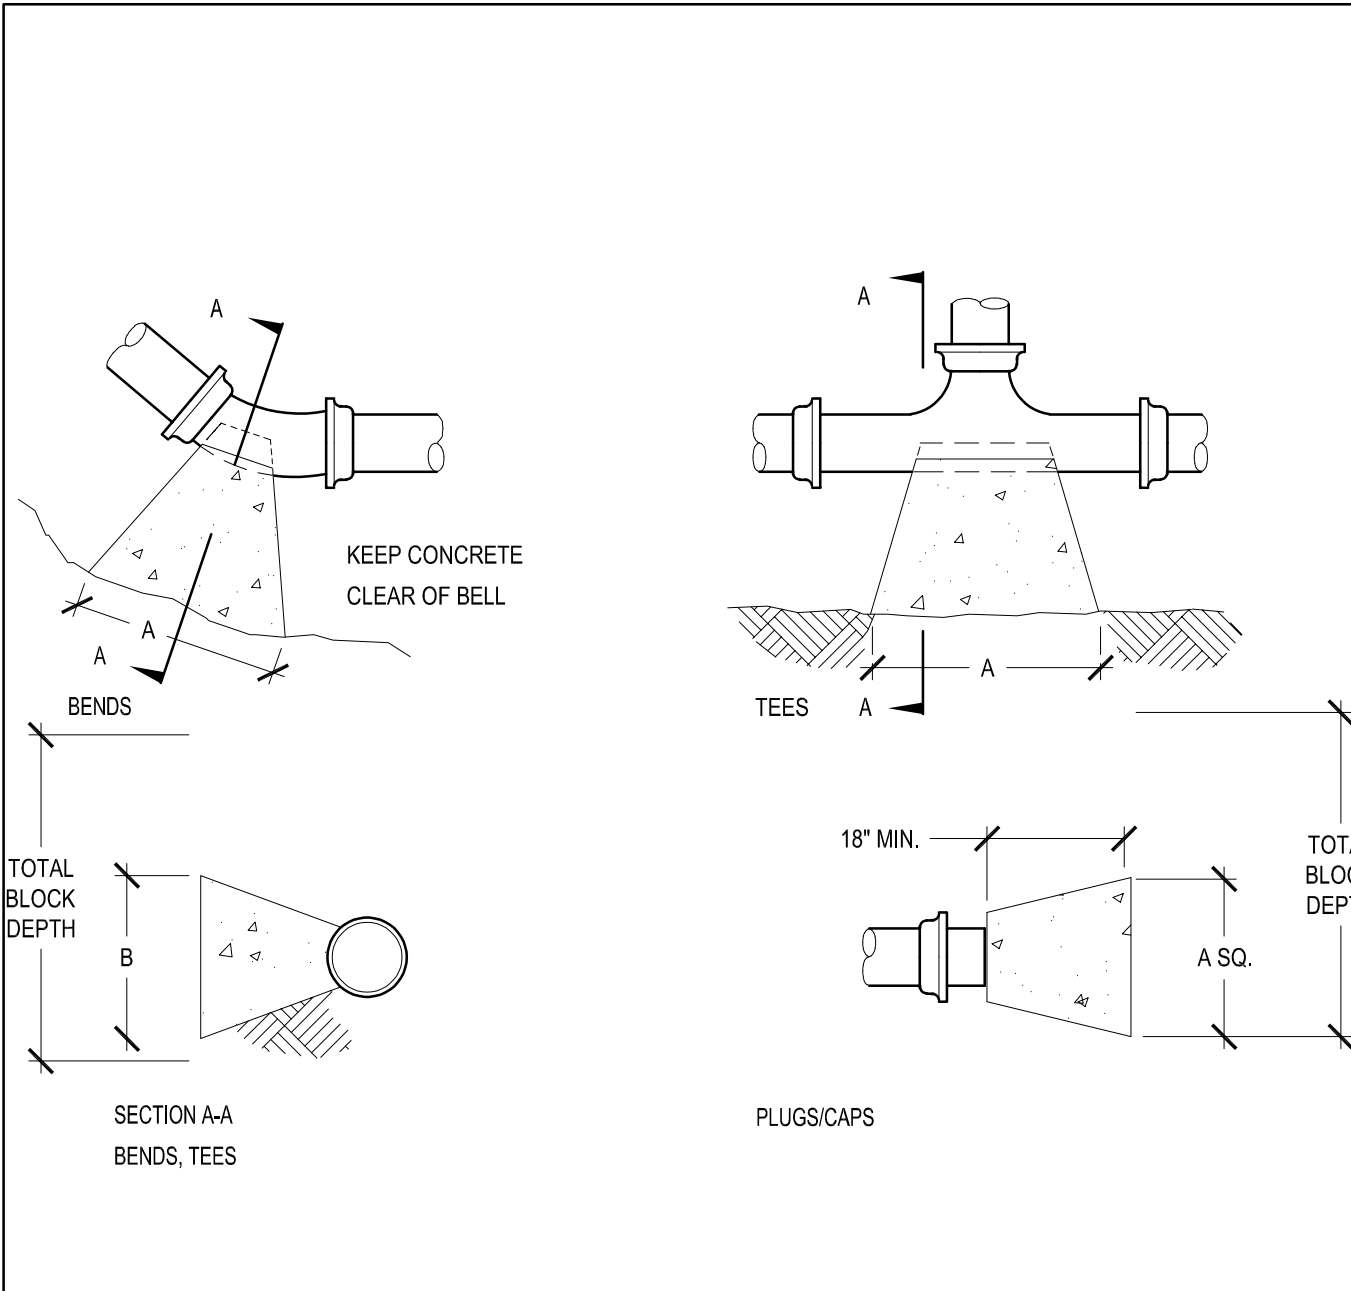

SOIL BEARING CAPACITY 2000 PSF FOR CLAYEY SAND SOILS TYPE ACCORDANCE WITH NFPA 13: TABLE A10.6(c); SEE GEOTECHICAL REPORT FOR DESCRIPTION OF SOIL CONDITIONS.

TRUST BLOCK CALCULATIONS PER NFPA 13: A10.6.1(b)  
6"-90 BEND AREA = (7.9 S.F.)/(225 PSI/100PSI)/(1000 PSF/2000PSF) = 8.9 S.F.  
6"-45 BEND AREA = 8.9 S.F. x 0.541 = 4.8 S.F.  
6"-22.5 BEND AREA = 8.9 S.F. x 0.275 = 2.5 S.F.  
6"-DEAD END AREA = (5.6 S.F.)/(225 PSI/100 PSI)/(1000 PSF/2000PSF) = 6.3 S.F.


PIPE SIZE	90° BENDS			45° BENDS			22.5° BENDS			TEES AND PLUGS		
	SQ. FT.	"A"	"B"	SQ. FT.	"A"	"B"	SQ. FT.	"A"	"B"	SQ. FT.	"A"	"B"
6	8.9	53"	24"	4.8	39"	18"	2.5	30"	12"	6.3	43"	21"

BASED ON A WATER PRESSURE OF 225 POUNDS PER SQUIRE INCH AND A SOIL RESISTANCE OF 2000 POUNDS PER SQUARE FOOT, AND SAFETY FACTOR OF 1.5 IN ACCORDANCE WITH NFPA 13(2016) TABLE A.10.6.1(b).

TOTAL BLOCK DEPTH SHALL BE AT LEAST TWICE THE BLOCK DEPTH "B" IN ACCORDANCE WITH NFPA 24.

JOINT RESTRAINT SHALL UTILIZE BOTH THRUST BLOCKS AND MEGALUG MECHANICAL JOINT RESTRAINT FITTINGS PER LOCAL FIRE MARSHAL

3 THRUST BLOCK N.T.S.

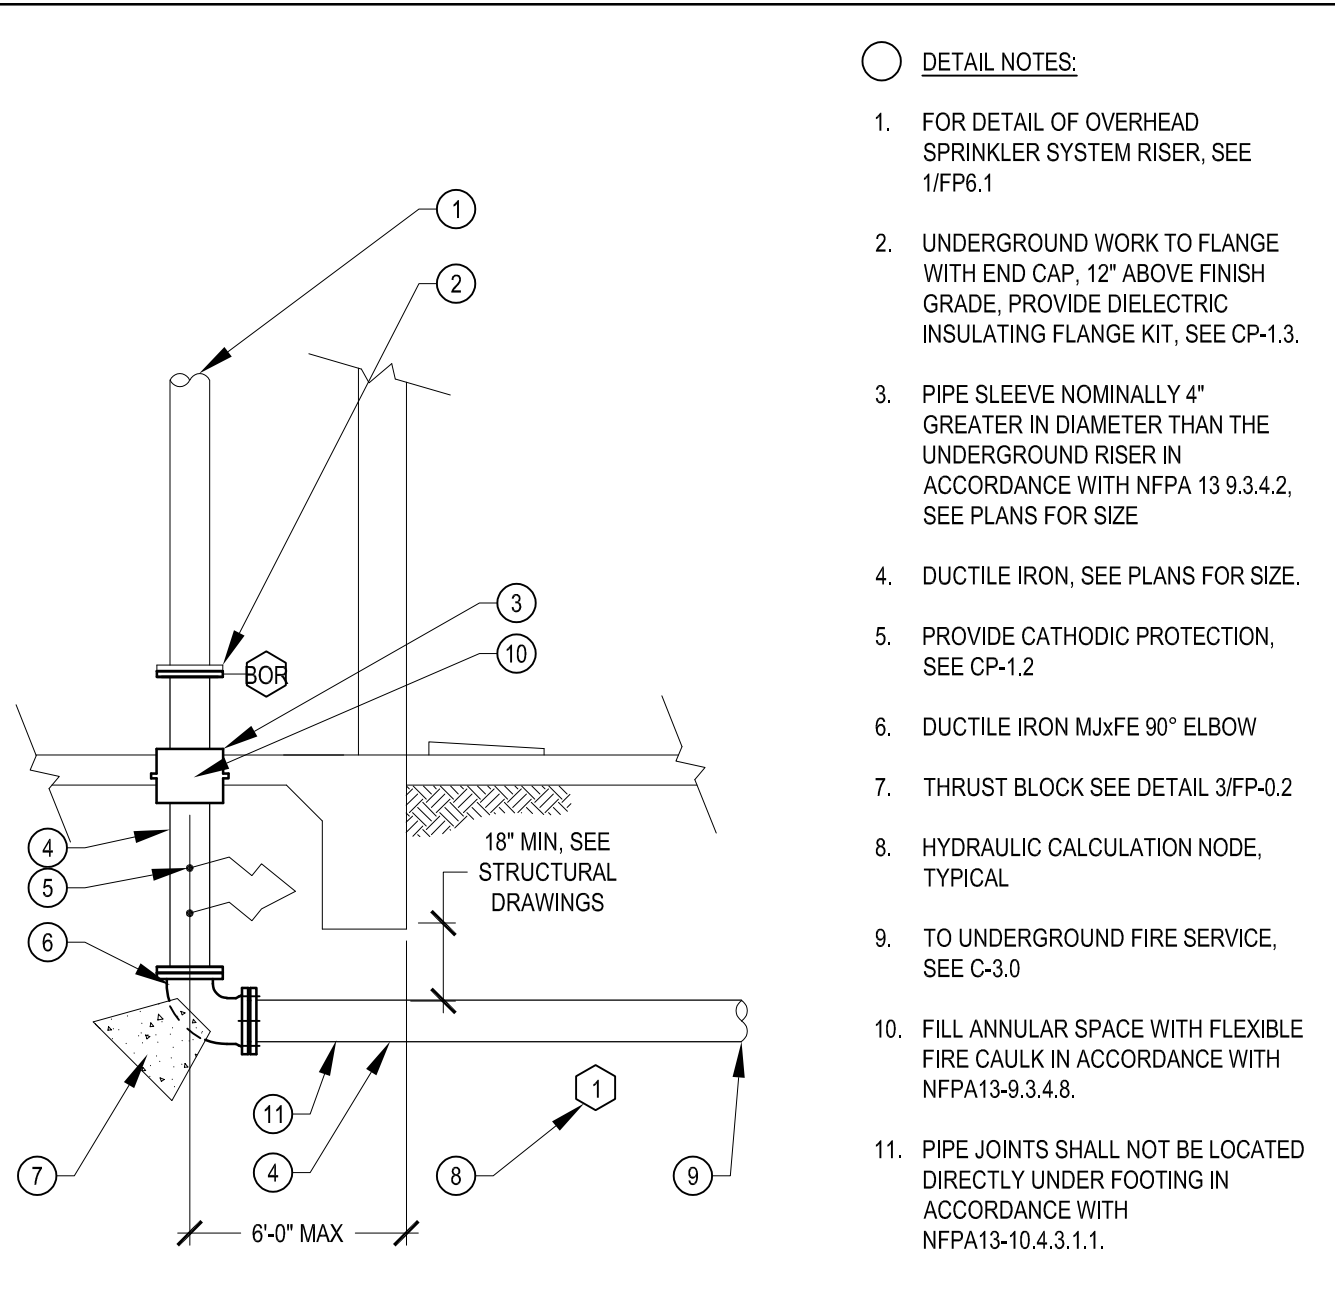


DETAIL NOTES:

- FOR DETAIL OF OVERHEAD SPRINKLER SYSTEM RISER, SEE 1/FP6.1
- UNDERGROUND WORK TO FLANGE WITH END CAP, 12" ABOVE FINISH GRADE, PROVIDE DIELECTRIC INSULATING FLANGE KIT, SEE CP-1.3.
- PIPE SLEEVE NOMINALLY 4" GREATER IN DIAMETER THAN THE UNDERGROUND RISER IN ACCORDANCE WITH NFPA 13 9.3.4.2, SEE PLANS FOR SIZE
- DUCTILE IRON, SEE PLANS FOR SIZE.
- PROVIDE CATHODIC PROTECTION, SEE CP-1.2
- DUCTILE IRON MxFe 90° ELBOW
- THRUST BLOCK SEE DETAIL 3/FP-0.2
- HYDRAULIC CALCULATION NODE, TYPICAL
- TO UNDERGROUND FIRE SERVICE, SEE C-3.0
- FILL ANNULAR SPACE WITH FLEXIBLE FIRE CAULK IN ACCORDANCE WITH NFPA13-9.3.4.8.
- PIPE JOINTS SHALL NOT BE LOCATED DIRECTLY UNDER FOOTING IN ACCORDANCE WITH NFPA13-10.4.3.1.1.

1 UNDERGROUND RISER N.T.S.

DETAIL NOTES:

- SELECT NATIVE SOILS, 90% COMPACTION FOR AREAS TO BE LEFT IN NATIVE STATE ONLY. CAP AREAS IN UNPAVED ROADWAYS WITH 12" CLASS 2 AGGRERAGATE BASE, 95% COMPACTION
- SAWCUT PAVEMENT EACH SIDE OF TRENCH 6" FROM TRENCH EDGE, REMOVE PAVEMENT AND BASEROCK, REPLACE AND RECOMPOST BASEROCK TACKCOAT EDGE AND REPAVE
- SELECT SAND BACKFILL AT 95% COMPACTION
- CLASS 2 AGGREGATE BASEROCK
- PLASTIC WARNING TAPE MARKED "FIRE WATER"
- 6 10 GA. COPPER TRACE WIRE COATED AND STRANDED TAPED ON TOP OF ALL NON-METALLIC PIPE
- SAND BEDDING MATERIAL(95% COMPACTION)
- FIRE SERVICE PIPING

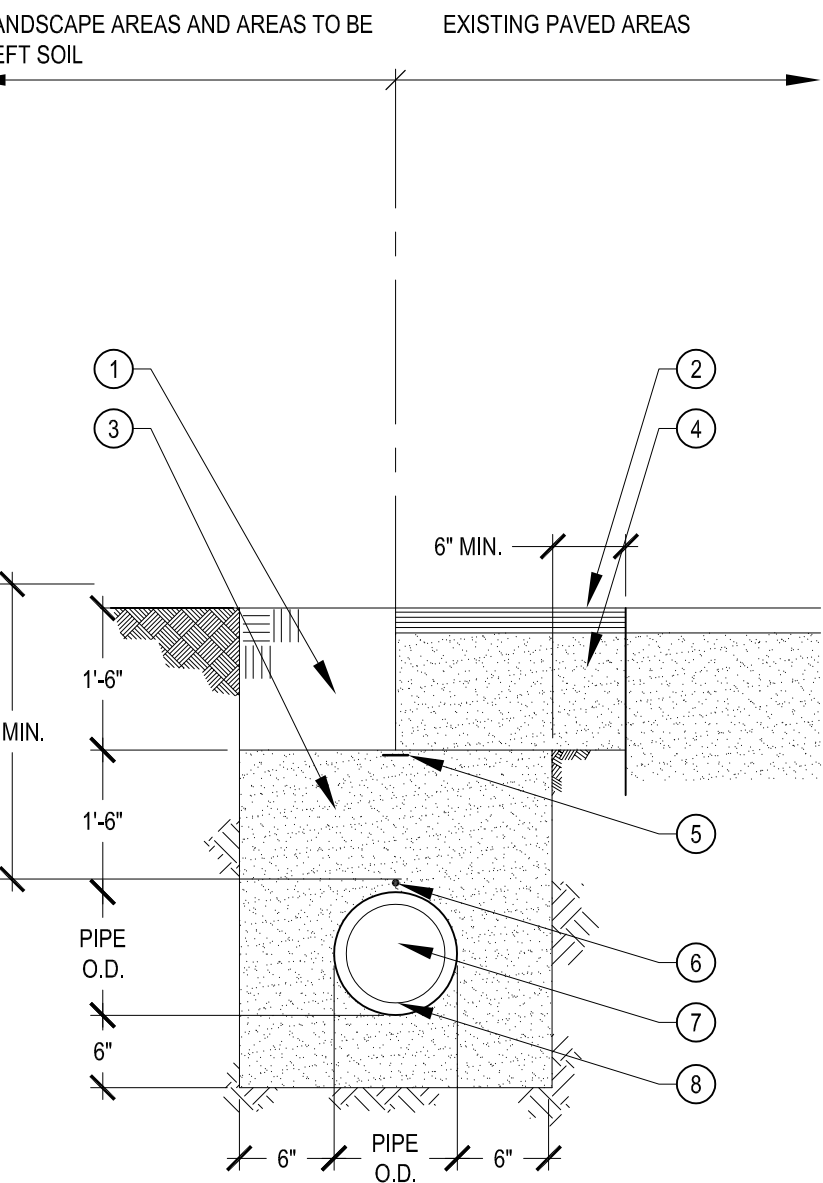

2 UTILITY TRENCH N.T.S.



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FREEDOM  
HIGH SCHOOL

NEW AUXILIARY  
GYMNASIUM

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SHEET TITLE

DETAILS - FIRE  
PROTECTION

SHEET NUMBER

FP-0.2





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SHEET TITLE


## SITE PLAN - FIRE PROTECTION

SHEET NUMBER

## FP-1.1



FREEDOM HIGH SCHOOL AUXILIARY GYM REMOTE AREA  
LIGHT HAZARD  
DESIGN AREA: 1500 SQ FT  
DENSITY: 0.1 GPM/SQ FT  
FLOW AT BASE OF RISER: 168 GPM  
RESIDUAL PRESSURE AT BASE OF RISER: 34.6 PSI  
FLOW AT SOURCE: 268 GPM  
RESIDUAL PRESSURE AT SOURCE: 36.6 PSI  
OUTSIDE HOUSE FLOW: 100 GPM  
REMOTE NODE: 107  
FLOW: 18.2 GPM @ 10.6 PSI  
*INCLUDES OUTSIDE HOSE FLOW  
SEE 1/FP-6.2 FOR HYDRAULIC DATA PLATE TEMPLATE

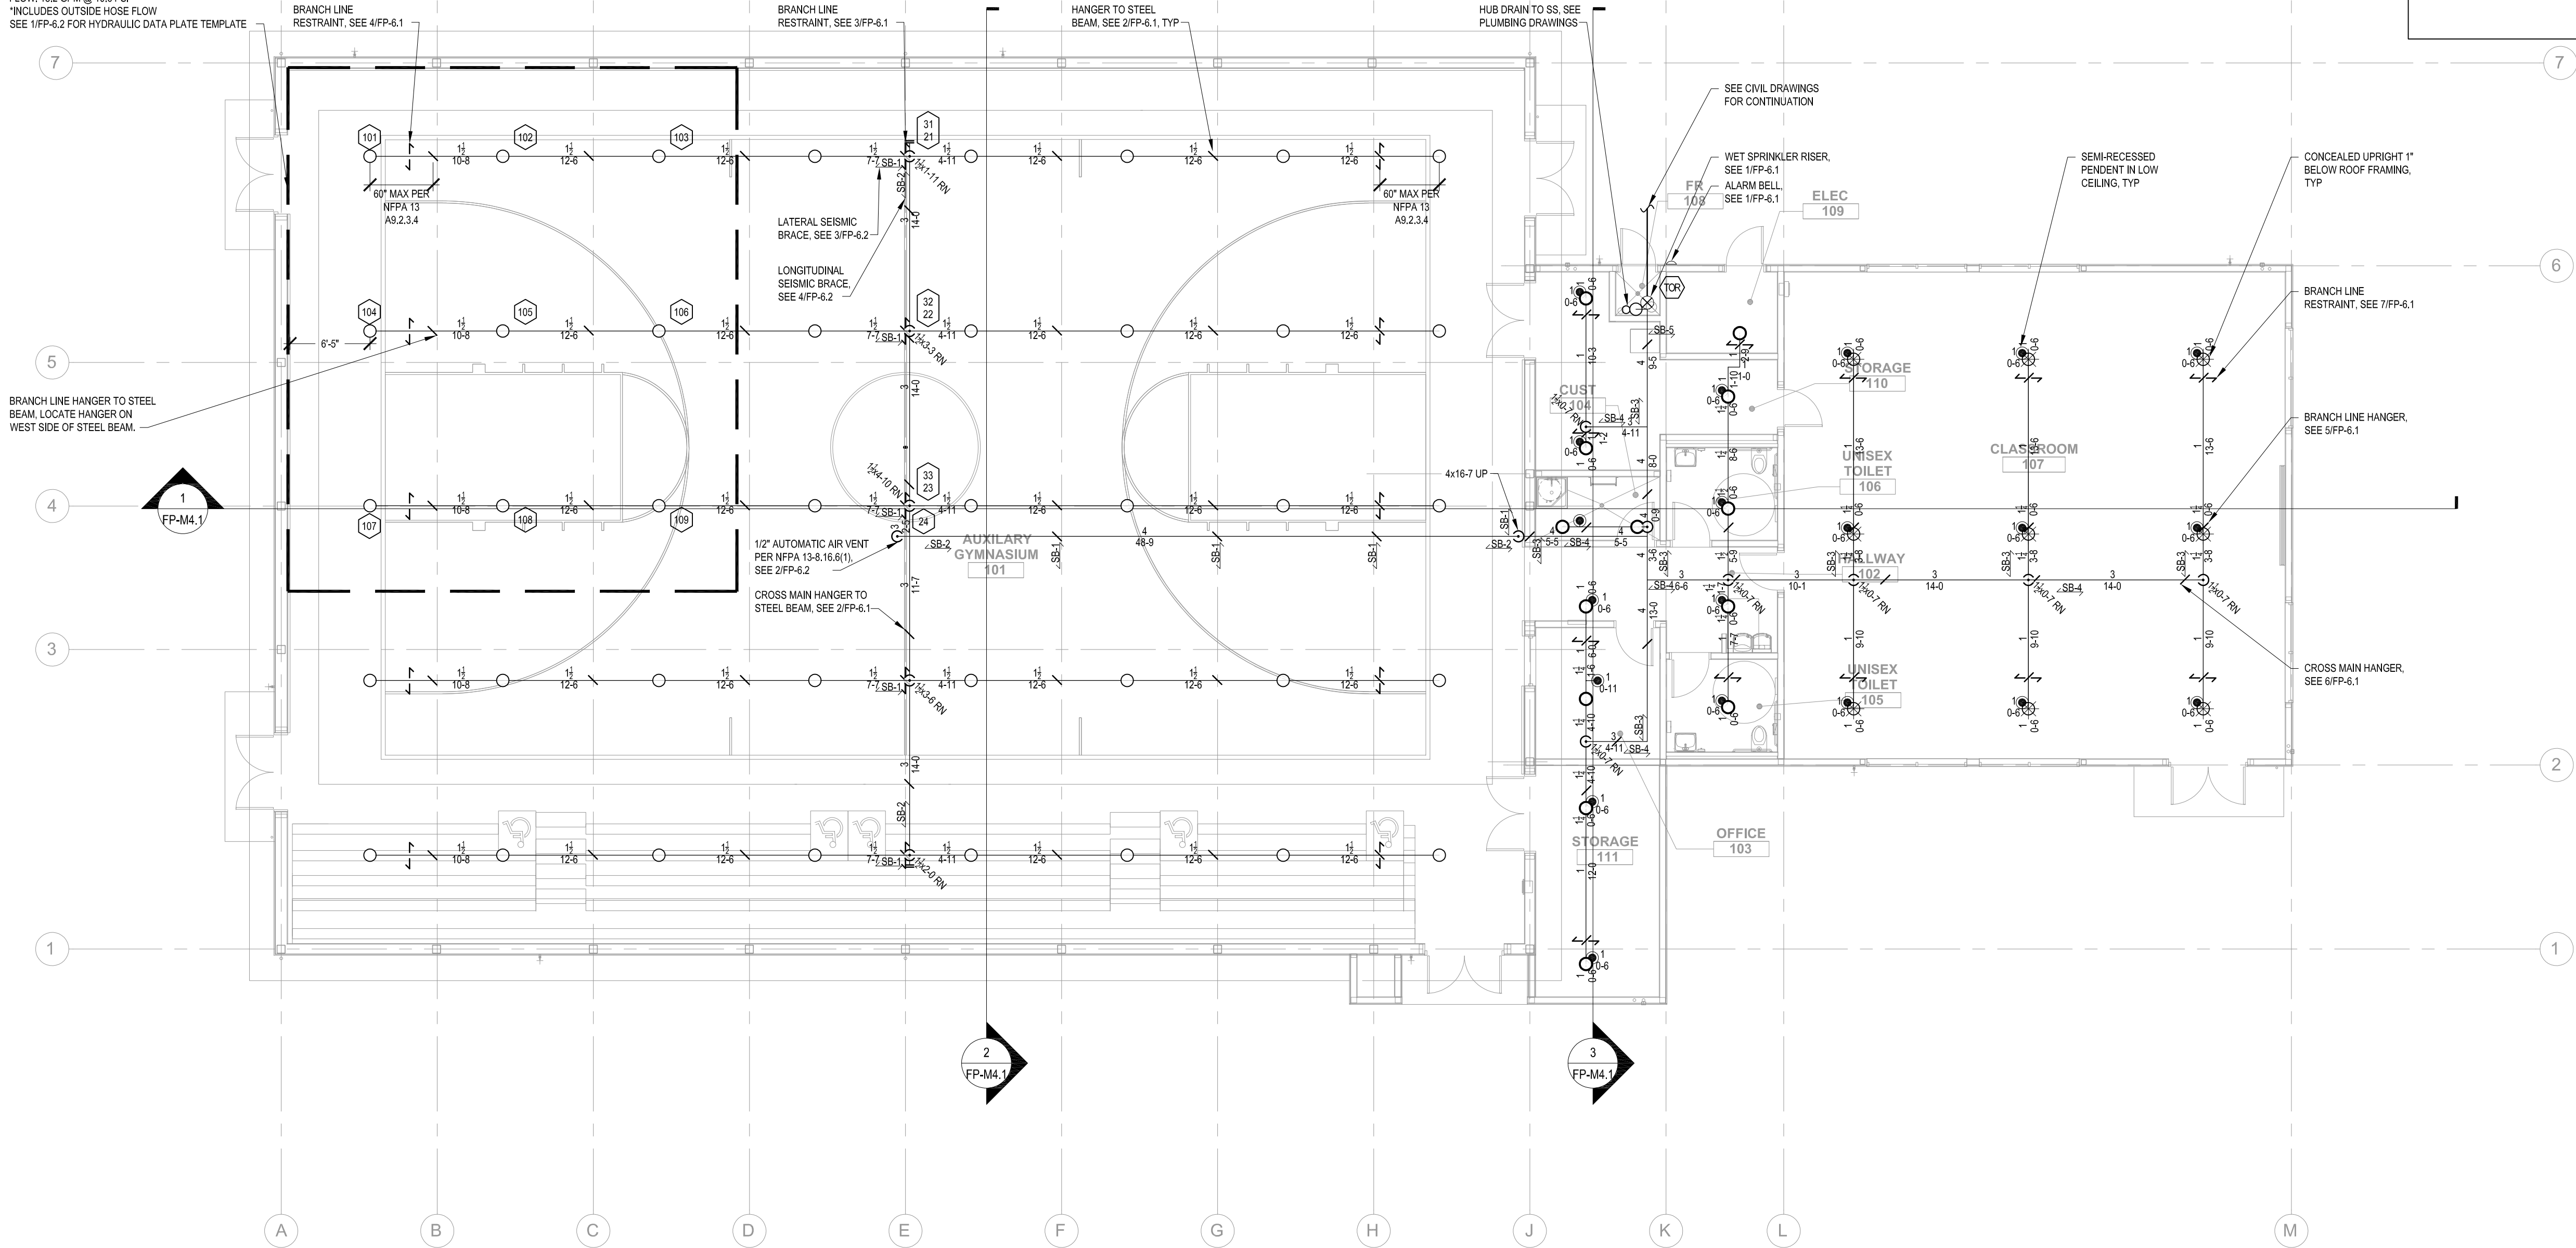

GENERAL NOTES

NOTES:

- ALL DIMENSIONS ARE CENTERLINE TO CENTERLINE UNLESS OTHERWISE NOTED.
- ALL PIPE 1-1/2" AND SMALLER SHALL BE SCHEDULE 40 BLACK STEEL WITH CAST IRON THREADED FITTINGS IN ACCORDANCE WITH ANSI B16.4.
- ALL PIPE 2" AND GREATER SHALL BE SCHEDULE 10 BLACK WITH GROOVED COUPLINGS AND WELDED OUTLETS.
- ALL PIPE 1-1/2" AND SMALLER SHALL HAVE SUPPORT SPACING LESS THAN 12 FEET.
- ALL PIPE 2" AND GREATER SHALL HAVE SUPPORT SPACING LESS THAN 15 FEET.
- BRANCH LINES SHALL BE RESTRAINED WITH NO. 12 440 LB WIRE AT THE END OF BRANCH LINE, AND AT INTERVALS NOT EXCEEDING 30 FT.
- PROVIDE 1" ANNULAR CLEARANCE AT ALL SPRINKLER PENETRATIONS OF LAY IN PANEL SUSPENDED CEILINGS.



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PIPING PLAN -  
FIRE  
PROTECTION


SHEET NUMBER

FP-M2.1

SPRINKLER									
SYMBOL	DESCRIPTION	MANF.	MODEL	SIN	TYPE	K FACTOR	TEMP RATING	QTY	NOTES
●	RECESSED PENDENT	TYCO	TY-FRB	3231	SSP	5.6	155 °F	20	1, 2, 3, 4,
○	UPRIGHT ON BRANCH LINE	TYCO	TY-FRB	3131	SSU	5.6	155 °F	41	
○	UPRIGHT IN CONCEALED SPACE	TYCO	TY-FRB	3131	SSU	5.6	200 °F	13	
⊗	FLAT SPRAY UPRIGHT	TYCO	CC3	3199	FSU	5.6	155 °F	9	
TOTAL SPRINKLER (THIS SHEET)								83	
TOTAL SPRINKLERS JOB								83	

- FINISH TO MATCH ADJACENT MATERIAL VERIFY WITH ARCHITECT
- PROVIDE ON 401 EXTENSION
- PROVIDE STYLE 10 RECESSED ESCUTCHEON. FINISH TO MATCH ADJACENT MATERIAL VERIFY WITH ARCHITECT
- FOR LAY IN PANEL SUSPENDED CEILINGS PROVIDE 1" ANNULAR CLEARANCE AROUND RECESSED ESCUTCHEON. CONCEAL OVERSIZED HOLE WITH VIKING 1260 EXPANSION PLATE. FINISH TO MATCH ADJACENT MATERIAL VERIFY WITH ARCHITECT.

1 PIPING PLAN - FIRE PROTECTION  
FP-M2.1 SCALE: 1/8" = 1'-0"

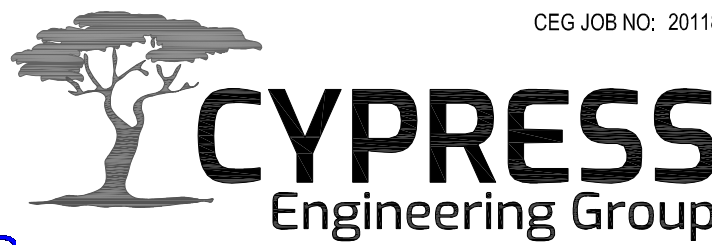


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1  
FP-M3.1

**CEILING PLAN - FIRE PROTECTION**

SCALE: 1/8" = 1'-0"

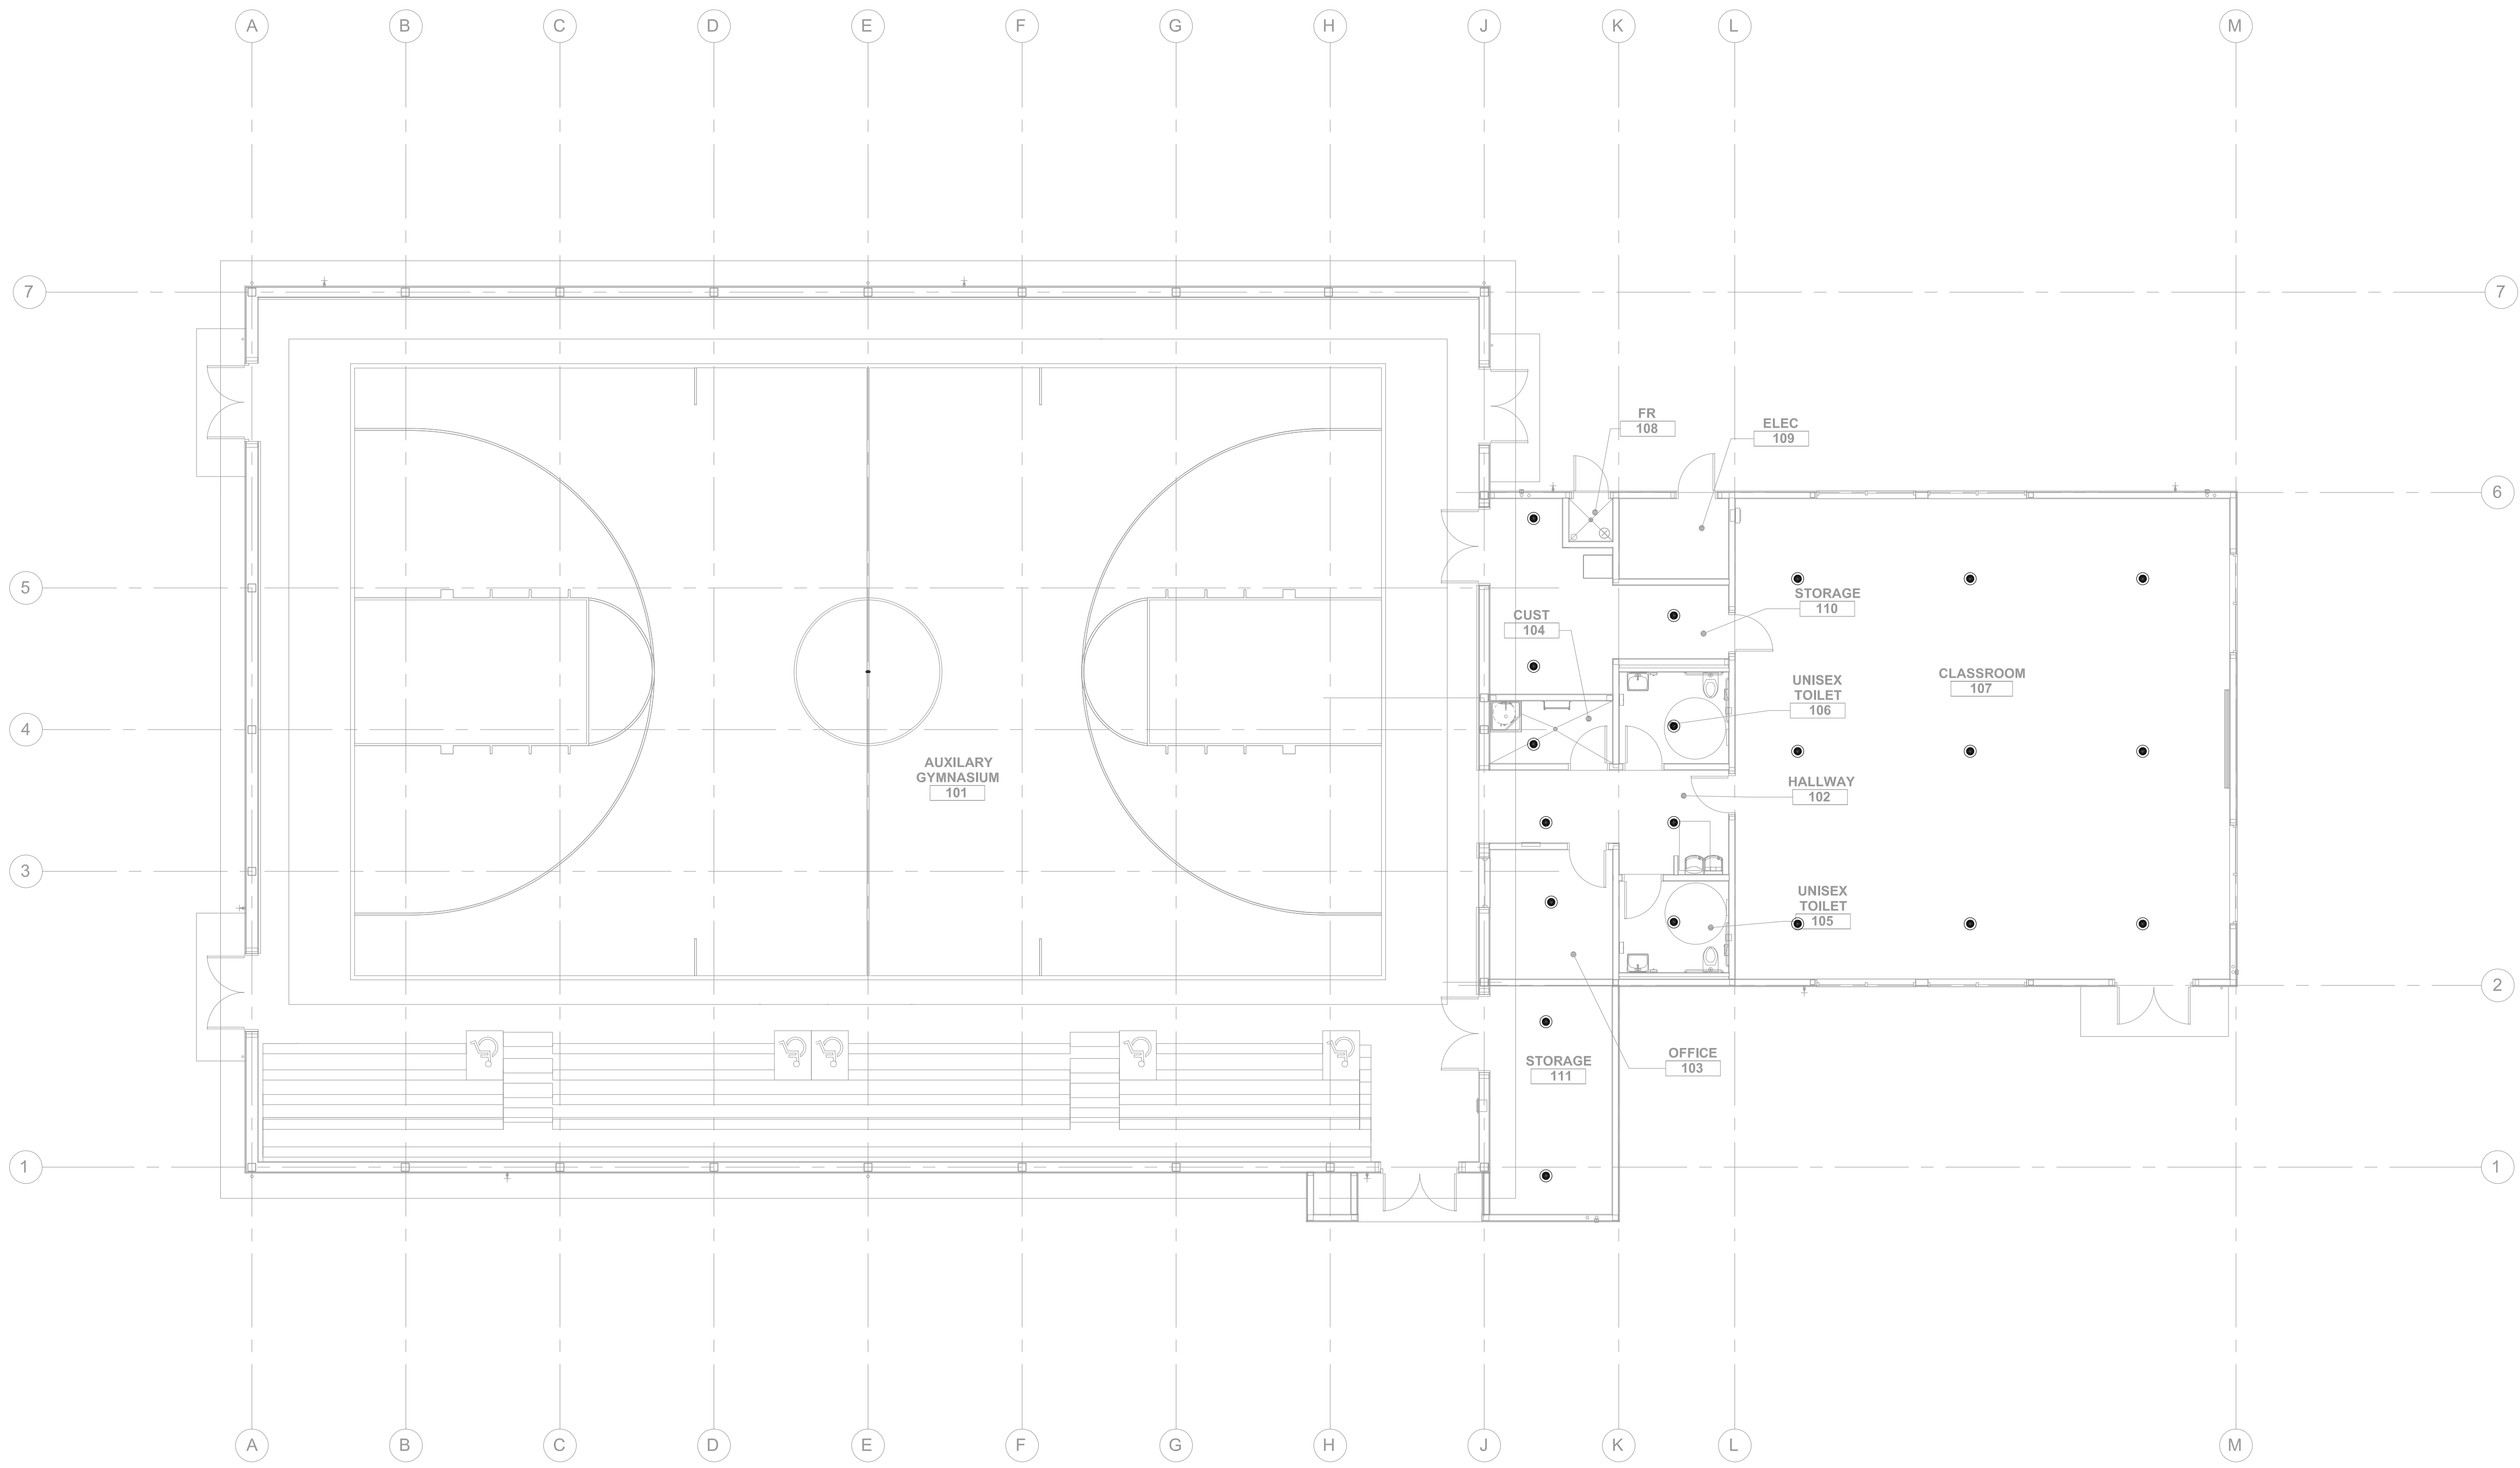

  
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DRAWING SCALE:	1/8" = 1' - 0"	
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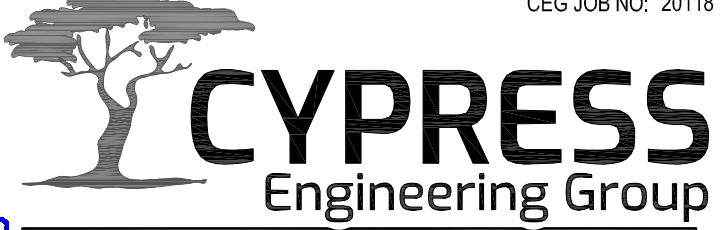

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**CEILING PLAN -  
FIRE  
PROTECTION**

SHEET NUMBER

**FP-M3.1**




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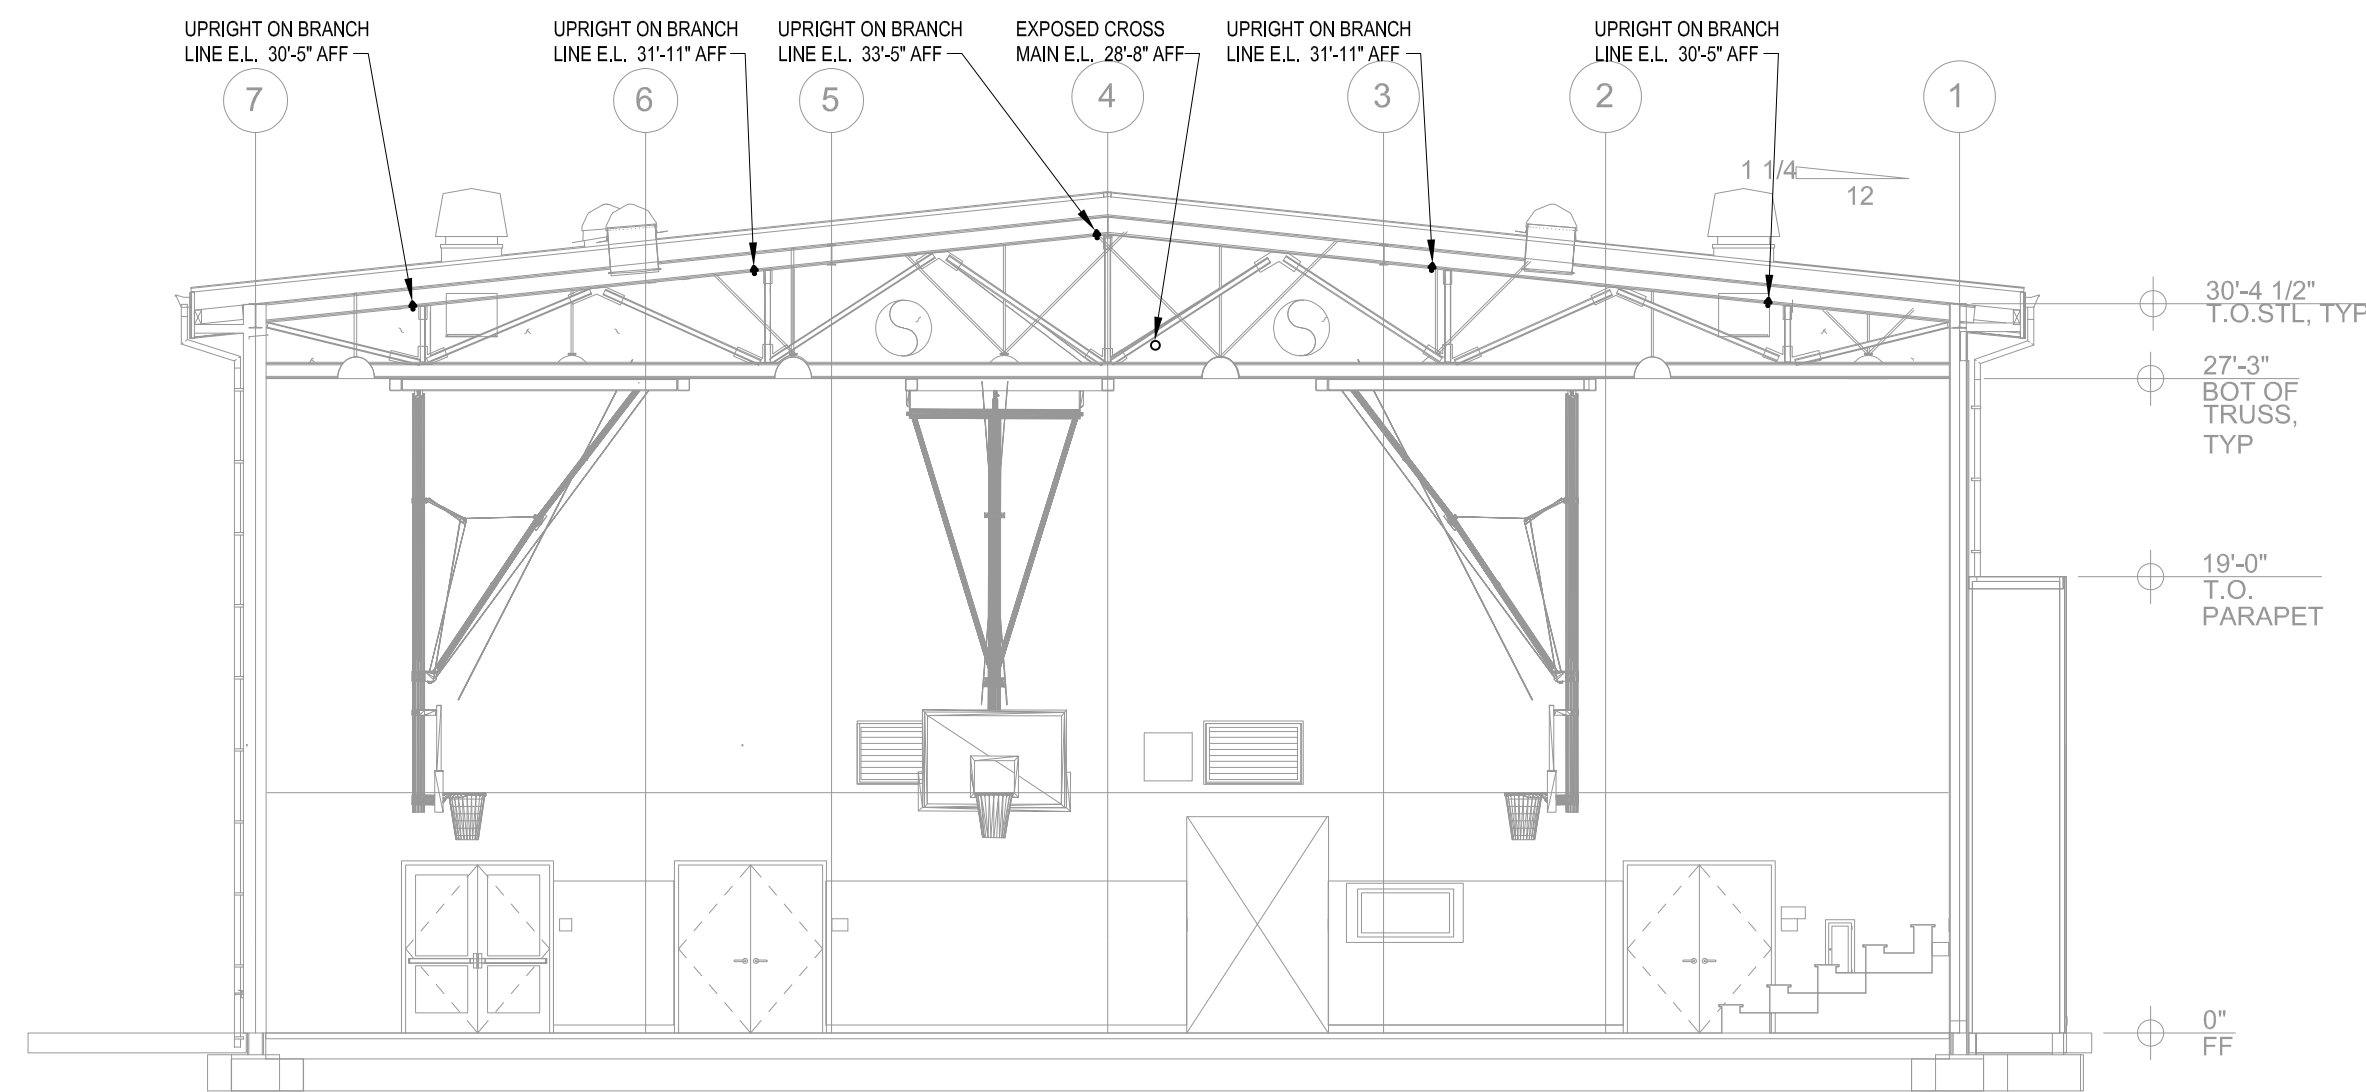
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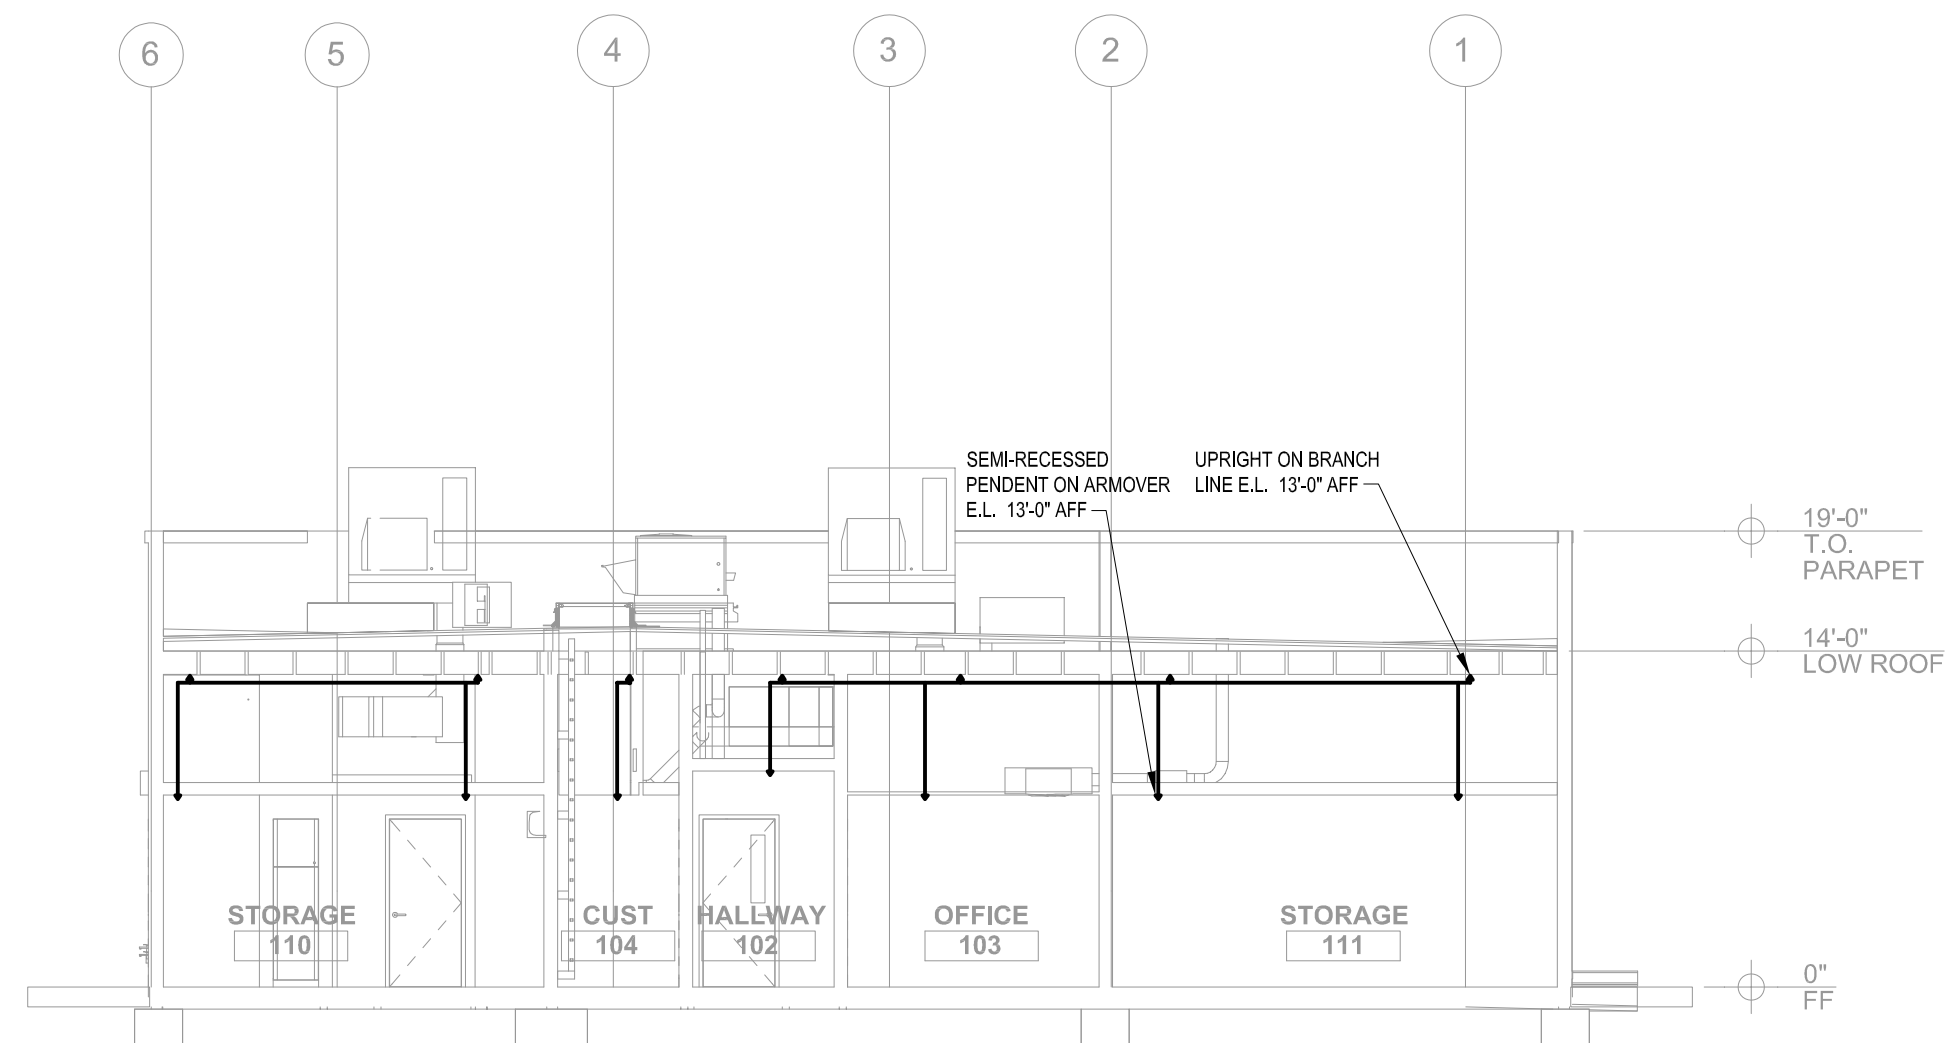





**1 SECTIONS - FIRE PROTECTION**  
 FP-M4.1 SCALE: 1/8" = 1'-0"

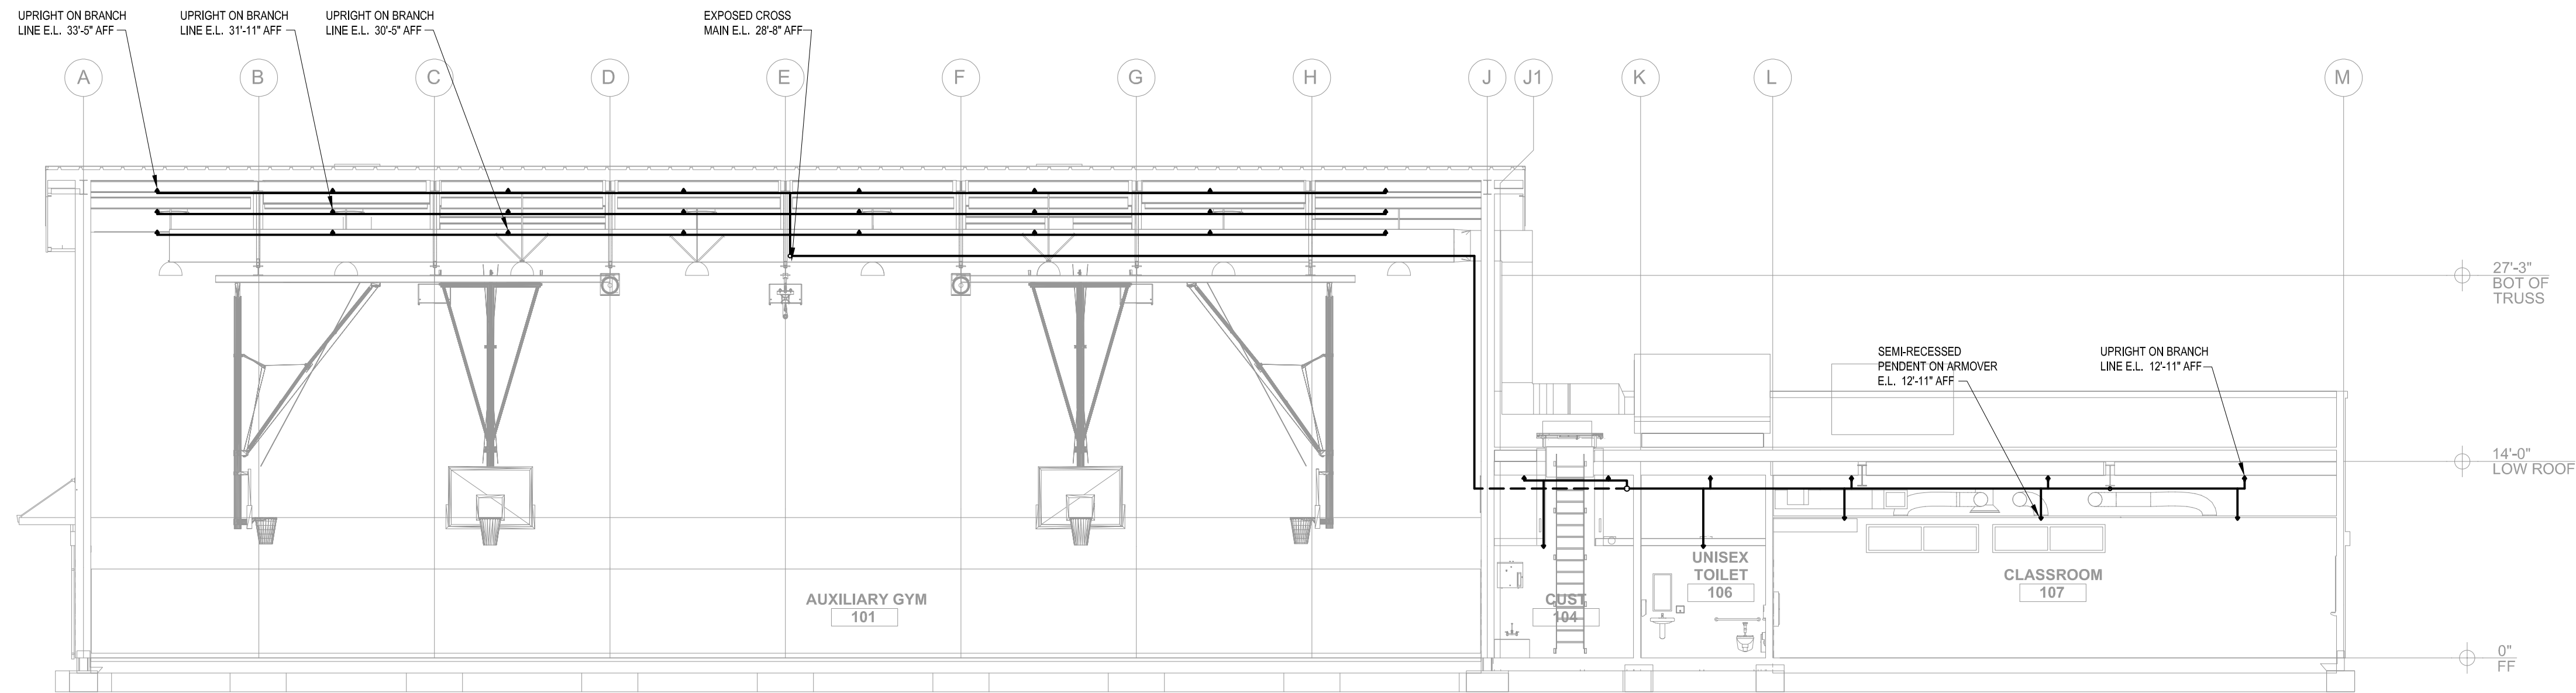

**2 SECTIONS - FIRE PROTECTION**  
 FP-M4.1 SCALE: 1/8" = 1'-0"



**3 SECTIONS - FIRE PROTECTION**  
 FP-M4.1 SCALE: 1/8" = 1'-0"

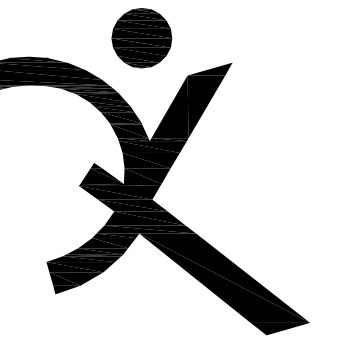

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## FREEDOM HIGH SCHOOL

### NEW AUXILIARY GYMNASIUM

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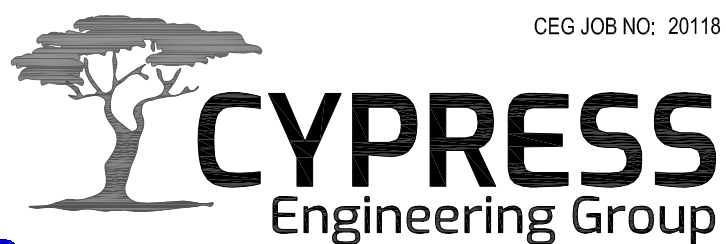
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## SECTIONS - FIRE PROTECTION

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# FP-M4.1



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DETAILS - FIRE  
PROTECTION

SHEET NUMBER

FP-6.1

9	WOOD FRAMING BLOCKING	N.T.S.	<p>○ <u>DETAIL NOTES:</u></p> <ol style="list-style-type: none"><li>WOOD FRAMING</li><li>2x MIN BLOCKING TO MATCH DEPTH OF JOIST FOR PIPE SIZE UP TO 2"</li><li>3x MIN. BLOCKING TO MATCH DEPTH OF JOIST FOR PIPE SIZE UP TO AND INCLUDING 6"</li><li>SIMPSON A35 HANGER, EACH END</li><li>SEE REQUIRED HANGER OR BRACING DETAIL FOR CONNECTION</li></ol>
6	RING HANGER	N.T.S.	<p>○ <u>DETAIL NOTES:</u></p> <ol style="list-style-type: none"><li>MIN. 3x WOOD STRUCTURE. PROVIDE BLOCKING WHEN 3x OR GREATER STRUCTURE IS NOT AVAILABLE. SEE DETAIL 9/FP-6.1</li><li>1/2" THROUGH-BOLT</li><li>TOLCO FIG. 51 SIDE BEAM BRACKET</li><li>3/8" TOLCO FIG. 100 ALL THREAD ROD</li><li>TOLCO FIG 200 ADJUSTABLE RING HANGER</li></ol>
3	BRANCH LINE RESTRAINT	N.T.S.	<p>○ <u>DETAIL NOTES:</u></p> <ol style="list-style-type: none"><li>STEEL BEAM , SEE STRUCTURAL DRAWINGS</li><li>TOLCO FIG 65 BEAM CLAMP</li><li>3/8" TOLCO FIG. 100 HANGER ROD WITHIN 6" OF RESTRAINT ROD IN ACCORDANCE WITH NFPA13-9.3.6.1</li><li>TOLCO FIG 200 BAND HANGER</li><li>STEEL BEAM , SEE STRUCTURAL DRAWINGS</li><li>METAL DECKING</li><li>TOLCO FIG 75 SWIVEL ATTACHMENT</li><li>3/8" TOLCO FIG 100 RESTRAINT ROD</li><li>EXTEND ROD TO PIPE TYPICAL.</li></ol>
1	WET RISER	N.T.S.	<p>○ <u>DETAIL NOTES:</u></p> <ol style="list-style-type: none"><li>TO SYSTEM, SEE SPRINKLER PIPING PLAN</li><li>HYDRAULIC CALCULATION NODE, TYP</li><li>FLEXIBLE COUPLING, TYP</li><li>4-WAY BRACE, SEE 8/FP-6.1</li><li>2" TESTANDRAIN MODEL 1011A WITH MODEL 7000 PRESSURE RELIEVE VALVE SET AT 175 PSI</li><li>FLOW SWITCH</li><li>PRESSURE GAGE, TYP</li><li>PROVIDE TERMINATION WITH 45° EL TO SMOOTH BORE CORROSION-RESISTANT OUTLET GIVING FLOW EQUIVALENT TO ONE SPRINKLER FOR ALARM TEST IN ACCORDANCE WITH NFPA 13-8.17.4.2.4. DAYLIGHT OVER HUB DRAIN, SEE PLUMBING DRAWINGS.</li><li>SEE 1/FP0.1 FOR UNDERGROUND RISER</li><li>10" 120V ALARM BELL</li><li>SPARE HEAD CABINET</li><li>HYDRAULIC DATA PLATE</li><li>TYCO CV-1FR UL LISTED CHECK VALVE</li><li>BUTTERFLY INDICATING VALVE WITH TAMPER SWITCH</li><li>FILL ANNUAL CLEARANCE WITH FLEXIBLE FIRE CAULK, SEE 1/FP0.1</li></ol>
10	TYPICAL DROP TO CEILING	N.T.S.	<p>○ <u>DETAIL NOTES:</u></p> <ol style="list-style-type: none"><li>HANGER FOR ARMORER GREATER THAN 2FT</li><li>1" SCH 40 HARD PIPE TYPICAL</li><li>PROVIDE 1" ANNUAL CLEARANCE AT ALL SPRINKLER PENETRATIONS OF LAY IN PANEL SUSPENDED CEILINGS. PROVIDE OVERSIZED EXPANSION PLATE AT RECESSED SPRINKLER ESCUTCHEON</li><li>PENDENT HEAD AT LOW CEILINGS</li><li>CENTER OR QUARTER POINT LENGTH WISE ALONG PANEL</li><li>BRANCH LINE</li><li>TEE DOWN FOR SWING ARMOVER TO FACILITATE ALIGNMENT AT LOW CEILING</li></ol>
7	BRANCH LINE RESTRAINT	N.T.S.	<p>○ <u>DETAIL NOTES:</u></p> <ol style="list-style-type: none"><li>MIN. 3x WOOD STRUCTURE. PROVIDE BLOCKING WHEN 3x OR GREATER STRUCTURE IS NOT AVAILABLE. SEE DETAIL 9/FP-6.1</li><li>TOLCO FIG. 51 SIDE BEAM BRACKET</li><li>1/2" THROUGH-BOLT</li><li>TOLCO FIG 75 SWIVEL ATTACHMENT</li><li>SEE 5/FP-6.2 FOR HANGER ATTACHMENT</li><li>TOLCO FIG 25 SURGE ARRESTOR AT RESTRAINT LOCATION PER NFPA 13-9.3.6.2</li><li>TOLCO FIG 200 ADJUSTABLE RING HANGER</li><li>PROVIDE FULL DEPTH 2X BLOCKING BOTH SIDES.</li></ol>
4	RESTRAINT WIRE	N.T.S.	<p>○ <u>DETAIL NOTES:</u></p> <ol style="list-style-type: none"><li>METAL DECKING, SEE STRUCTURAL DRAWINGS</li><li>TWO #8 X 1/2" SELF TAPPING SCREWS</li><li>10GA. GALVANIZED STEEL STRAPS 3" WIDE X4" LONG</li><li>FOUR TIGHT TURNS</li><li>NO. 12, 440 LBS RESTRAINT WIRE INSTALLED AT LEAST 45° FROM VERTICAL AND ANCHORED ON BOTH SIDES OF PIPE.</li><li>TWO TIGHT TURNS PER NFPA-13-A9.3.6.1.</li></ol>
2	RING HANGER	N.T.S.	<p>○ <u>DETAIL NOTES:</u></p> <ol style="list-style-type: none"><li>MIN. 3x WOOD STRUCTURE. PROVIDE BLOCKING WHEN 3x OR GREATER STRUCTURE IS NOT AVAILABLE. SEE DETAIL 9/FP-6.1.</li><li>3/8" THROUGH BOLT</li><li>TOLCO FIG. 58 THREADED SIDE BEAM BRACKET</li><li>3/8" TOLCO FIG. 100 ALL THREAD ROD</li><li>TOLCO FIG. 200 RING HANGER</li></ol>
11	DROP HARD CEILING	N.T.S.	<p>○ <u>DETAIL NOTES:</u></p> <ol style="list-style-type: none"><li>HANGER FOR ARMORER GREATER THAN 2FT</li><li>CONTRACTOR MAY PROVIDE OPTIONAL FLEX HEAD 2072F FLEXIBLE (1.25 IN I.D.) SPRINKLER HOSE WITH STUD MOUNTING BRACKET FOR HARD CEILING APPLICATION</li><li>FLEXHEAD STUD MOUNTING BRACKET FOR OPTIONAL HOSE APPLICATION</li><li>PENDENT HEAD AT LOW CEILINGS</li><li>BRANCH LINE</li><li>TEE DOWN FOR SWING ARMOVER TO FACILITATE ALIGNMENT AT LOW CEILING</li></ol>
8	RISER BRACE	N.T.S.	<p>○ <u>DETAIL NOTES:</u></p> <ol style="list-style-type: none"><li>PROVIDE 4X BLOCKING W/3/4 TOP AND BOTTOM AT EACH END</li><li>1/2" Ø GALV. THROUGH BOLT</li><li>WALL FRAMING</li><li>TOLCO FIG 909 SWIVEL</li><li>TOLCO 1001 FAST CLAMP SWAY BRACE ATTACHMENT</li></ol>
5	RING HANGER	N.T.S.	<p>○ <u>DETAIL NOTES:</u></p> <ol style="list-style-type: none"><li>MIN. 3x WOOD STRUCTURE. PROVIDE BLOCKING WHEN 3x OR GREATER STRUCTURE IS NOT AVAILABLE. SEE DETAIL 9/FP-6.1.</li><li>3/8" THROUGH BOLT</li><li>TOLCO FIG. 58 THREADED SIDE BEAM BRACKET</li><li>3/8" TOLCO FIG. 100 ALL THREAD ROD</li><li>TOLCO FIG. 200 RING HANGER</li></ol>

NOTE: FOR PIPE SIZES UP TO AND INCLUDING 2"

REGISTERED PROFESSIONAL ENGINEER  
STEPHEN E. RAWSON  
MECHANICAL  
STATE OF CALIFORNIA  
EXP. JUNE 30, 2022

CEG JOB NO: 20118

**CYPRESS**  
Engineering Group


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## FREEDOM HIGH SCHOOL

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SHEET TITLE

## SEISMIC BRACING CALCULATIONS - FIRE PROTECTION

SHEET NUMBER

# FP-6.3

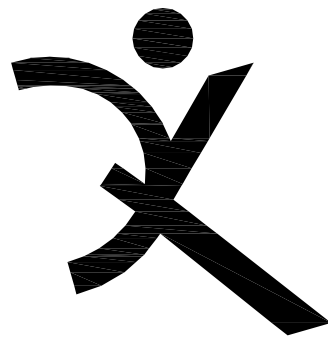
Seismic Bracing Calculations		Sheet _X_ of _X_
Project: FREEDOM HIGH SCHOOL NEW AUXILIARY GYMNASIUM Address: 1050 NEROLY RD OAKLEY, CA 94561		Cypress Engineering Group 8 Harris Ct., Suite A8 Monterey, CA 93940 (831) 218-1802
Brace Information	Seismic Brace Attachments	
Maximum Spacing: 20'-0"	Structure attachment or tension-only bracing system:	
Maximum Brace Length: 7'-0"	Make: TOLCO Model: EIG 909 NO THREAD SWIVEL	
Bracing Material: 1" Sch. 40	Listed load rating: 2015 Adjusted load rating: 1745	
Angle from Vertical: 60° MINIMUM	Sway brace (pipe attachment) fitting:	
Least radius of gyration: 0.421"	Make: TOLCO Model: EIG 1001 IN-LINE SWAY BRACE	
LR value: 200	Listed load rating: 2015 Adjusted load rating: 1745	
Maximum Horizontal Load: 1604 lbs	NFFPA 13: Table 9.3.5.11.8(b)	
Fastener Information		Seismic Brace Assembly Detail (Provide detail on plans)
Orientation of connecting surface: NFFPA Type F		SEE DETAIL 7FP-6.2 SEE DETERMINATION OF SEISMIC COEFFICIENT Cp ON FP-0.1
Type: THROUGH BOLT		
Diameter: 1/2 in		
Length: 3 1/2 in		
Maximum load: 600 lbs		
NFFPA 13: Figure 9.3.5.12.1		
Brace identification no. (to be used on plans) SB-5		
<input checked="" type="checkbox"/> Lateral brace <input type="checkbox"/> Longitudinal brace		
Seismic Coefficient Cp= 0.65 (See Attached NFFPA13: Table 9.3.5.9.3)		
Diameter	Type	Length
4 in	Sch. 10 Steel	20
		11.78
		lb/ft
		235.6
		lb
		lb/ft
		lb
		lb/ft
		lb
		lb/ft
		lb
		lb/ft
		lb
Total Weight of Water Filled Piping		235.6
Wp (Total Weight of Water Filled Piping x 1.15 to account for valves and fittings)		270.9
Horizontal Force (NFFPA13.9.3.5.9.3) Fpw = Cp x Wp =		176.1
*Excludes tension-only bracing systems		

Seismic Bracing Calculations		Sheet _X_ of _X_
Project: FREEDOM HIGH SCHOOL NEW AUXILIARY GYMNASIUM Address: 1050 NEROLY RD OAKLEY, CA 94561		Cypress Engineering Group 8 Harris Ct., Suite A8 Monterey, CA 93940 (831) 218-1802
Brace Information	Seismic Brace Attachments	
Maximum Spacing: 15'-0"	Structure attachment or tension-only bracing system:	
Maximum Brace Length: 7'-0"	Make: TOLCO Model: EIG 909 NO THREAD SWIVEL	
Bracing Material: 1" Sch. 40	Listed load rating: 2015 Adjusted load rating: 1745	
Angle from Vertical: 60° MINIMUM	Sway brace (pipe attachment) fitting:	
Least radius of gyration: 0.421"	Make: TOLCO Model: EIG 1001 IN-LINE SWAY BRACE	
LR value: 200	Listed load rating: 2015 Adjusted load rating: 1745	
Maximum Horizontal Load: 1604 lbs	NFFPA 13: Table 9.3.5.11.8(b)	
Fastener Information		Seismic Brace Assembly Detail (Provide detail on plans)
Orientation of connecting surface: NFFPA Type I		SEE DETAIL 5FP-6.2 SEE DETERMINATION OF SEISMIC COEFFICIENT Cp ON FP-0.1
Type: THROUGH BOLT		
Diameter: 1/2 in		
Length: 3 1/2 in		
Maximum load: 485 lbs		
NFFPA 13: Figure 9.3.5.12.1		
Brace identification no. (to be used on plans) SB-3		
<input checked="" type="checkbox"/> Lateral brace <input type="checkbox"/> Longitudinal brace		
Seismic Coefficient Cp= 0.65 (See Attached NFFPA13: Table 9.3.5.9.3)		
Diameter	Type	Length
3 in	Sch. 10 Steel	15
		7.94
		lb/ft
		119.1
		lb
1.5 in	Sch. 40 Steel	7
		3.61
		lb/ft
		25.3
		lb
1.25 in	Sch. 40 Steel	15
		2.93
		lb/ft
		43.9
		lb
1 in	Sch. 40 Steel	37.5
		2.05
		lb/ft
		76.9
		lb
		lb/ft
		lb
Total Weight of Water Filled Piping		265.2
Wp (Total Weight of Water Filled Piping x 1.15 to account for valves and fittings)		304.9
Horizontal Force (NFFPA13.9.3.5.9.3) Fpw = Cp x Wp =		198.2
*Excludes tension-only bracing systems		

Seismic Bracing Calculations		Sheet _X_ of _X_
Project: FREEDOM HIGH SCHOOL NEW AUXILIARY GYMNASIUM Address: 1050 NEROLY RD OAKLEY, CA 94561		Cypress Engineering Group 8 Harris Ct., Suite A8 Monterey, CA 93940 (831) 218-1802
Brace Information	Seismic Brace Attachments	
Maximum Spacing: 15'-0"	Structure attachment or tension-only bracing system:	
Maximum Brace Length: 7'-0"	Make: TOLCO Model: EIG 909 NO THREAD SWIVEL	
Bracing Material: 1" Sch. 40	Listed load rating: 2015 Adjusted load rating: 1745	
Angle from Vertical: 60° MINIMUM	Sway brace (pipe attachment) fitting:	
Least radius of gyration: 0.421"	Make: TOLCO Model: EIG 1001 IN-LINE SWAY BRACE	
LR value: 200	Listed load rating: 2015 Adjusted load rating: 1745	
Maximum Horizontal Load: 1604 lbs	NFFPA 13: Table 9.3.5.11.8(b)	
Fastener Information		Seismic Brace Assembly Detail (Provide detail on plans)
Orientation of connecting surface: NFFPA Type C		SEE DETAIL 3FP-6.2 SEE DETERMINATION OF SEISMIC COEFFICIENT Cp ON FP-0.1
Type: THROUGH BOLT		NOTE: LOAD LIMITED BY FIG 600 SWAY BRACE ATTACHMENT. LOAD ALONG BEAM 1265 LBS
Diameter: 1/2 in		
Length: 1/2 in		
Maximum load: 2650 lbs		
NFFPA 13: Figure 9.3.5.12.1		
Brace identification no. (to be used on plans) SB-1		
<input checked="" type="checkbox"/> Lateral brace <input type="checkbox"/> Longitudinal brace		
Seismic Coefficient Cp= 0.65 (See Attached NFFPA13: Table 9.3.5.9.3)		
Diameter	Type	Length
3 in	Sch. 10 Steel	15
		7.94
		lb/ft
		119.1
		lb
1.5 in	Sch. 40 Steel	87.5
		3.61
		lb/ft
		315.9
		lb
		lb/ft
		lb
		lb/ft
		lb
		lb/ft
		lb
Total Weight of Water Filled Piping		435.0
Wp (Total Weight of Water Filled Piping x 1.15 to account for valves and fittings)		500.2
Horizontal Force (NFFPA13.9.3.5.9.3) Fpw = Cp x Wp =		325.1
*Excludes tension-only bracing systems		

Seismic Bracing Calculations		Sheet _X_ of _X_
Project: FREEDOM HIGH SCHOOL NEW AUXILIARY GYMNASIUM Address: 1050 NEROLY RD OAKLEY, CA 94561		Cypress Engineering Group 8 Harris Ct., Suite A8 Monterey, CA 93940 (831) 218-1802
Brace Information	Seismic Brace Attachments	
Maximum Spacing: 30'-0"	Structure attachment or tension-only bracing system:	
Maximum Brace Length: 7'-0"	Make: TOLCO Model: EIG 909 NO THREAD SWIVEL	
Bracing Material: 1" Sch. 40	Listed load rating: 2015 Adjusted load rating: 1745	
Angle from Vertical: 60° MINIMUM	Sway brace (pipe attachment) fitting:	
Least radius of gyration: 0.421"	Make: TOLCO Model: EIG 4L IN-LINE SWAY BRACE	
LR value: 200	Listed load rating: 2015 Adjusted load rating: 1745	
Maximum Horizontal Load: 1604 lbs	NFFPA 13: Table 9.3.5.11.8(b)	
Fastener Information		Seismic Brace Assembly Detail (Provide detail on plans)
Orientation of connecting surface: NFFPA Type F		SEE DETAIL 6FP-6.2 SEE DETERMINATION OF SEISMIC COEFFICIENT Cp ON FP-0.1
Type: THROUGH BOLT		
Diameter: 1/2 in		
Length: 3 1/2 in		
Maximum load: 600 lbs		
NFFPA 13: Figure 9.3.5.12.1		
Brace identification no. (to be used on plans) SB-4		
<input type="checkbox"/> Lateral brace <input checked="" type="checkbox"/> Longitudinal brace		
Seismic Coefficient Cp= 0.65 (See Attached NFFPA13: Table 9.3.5.9.3)		
Diameter	Type	Length
4 in	Sch. 10 Steel	30
		11.78
		lb/ft
		353.4
		lb
		lb/ft
		lb
		lb/ft
		lb
		lb/ft
		lb
		lb/ft
		lb
Total Weight of Water Filled Piping		353.4
Wp (Total Weight of Water Filled Piping x 1.15 to account for valves and fittings)		406.4
Horizontal Force (NFFPA13.9.3.5.9.3) Fpw = Cp x Wp =		264.2
*Excludes tension-only bracing systems		

Seismic Bracing Calculations		Sheet _X_ of _X_
Project: FREEDOM HIGH SCHOOL NEW AUXILIARY GYMNASIUM Address: 1050 NEROLY RD OAKLEY, CA 94561		Cypress Engineering Group 8 Harris Ct., Suite A8 Monterey, CA 93940 (831) 218-1802
Brace Information	Seismic Brace Attachments	
Maximum Spacing: 60'-0"	Structure attachment or tension-only bracing system:	
Maximum Brace Length: 7'-0"	Make: TOLCO Model: EIG 909 NO THREAD SWIVEL	
Bracing Material: 1" Sch. 40	Listed load rating: 2015 Adjusted load rating: 1745	
Angle from Vertical: 60° MINIMUM	Sway brace (pipe attachment) fitting:	
Least radius of gyration: 0.421"	Make: TOLCO Model: EIG 4L IN-LINE SWAY BRACE	
LR value: 200	Listed load rating: 2015 Adjusted load rating: 1745	
Maximum Horizontal Load: 1604 lbs	NFFPA 13: Table 9.3.5.11.8(b)	
Fastener Information		Seismic Brace Assembly Detail (Provide detail on plans)
Orientation of connecting surface: NFFPA Type C		SEE DETAIL 4FP-6.2 SEE DETERMINATION OF SEISMIC COEFFICIENT Cp ON FP-0.1
Type: THROUGH BOLT		NOTE: LOAD LIMITED BY FIG 600 SWAY BRACE ATTACHMENT. LOAD ALONG BEAM 1265 LBS
Diameter: 1/2 in		
Length: 1/2 in		
Maximum load: 2650 lbs		
NFFPA 13: Figure 9.3.5.12.1		
Brace identification no. (to be used on plans) SB-2		
<input type="checkbox"/> Lateral brace <input checked="" type="checkbox"/> Longitudinal brace		
Seismic Coefficient Cp= 0.65 (See Attached NFFPA13: Table 9.3.5.9.3)		
Diameter	Type	Length
4 in	Sch. 10 Steel	60
		11.78
		lb/ft
		706.80
		lb
		lb/ft
		lb
		lb/ft
		lb
		lb/ft
		lb
		lb/ft
		lb
Total Weight of Water Filled Piping		706.80
Wp (Total Weight of Water Filled Piping x 1.15 to account for valves and fittings)		814.74
Horizontal Force (NFFPA13.9.3.5.9.3) Fpw = Cp x Wp =		607.58
*Excludes tension-only bracing systems		

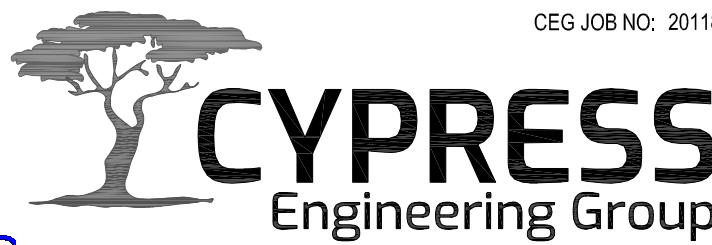

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831.218.1802  
8 Harris Court, Suite A8  
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AV PANEL SCHEDULE								
DEVICE TYPE	LOCATION	DESCRIPTION	PANEL SIZE- FLUSH MOUNT	PANEL SIZE- SURFACE MOUNT	BOX TYPE- FLUSH MOUNT	BOX TYPE- SURFACE MOUNT	WIRING CONNECTION	
<div><div>AV-G1</div><div>--</div></div> <div><div>AV-G3</div><div>--</div></div> <div><div>AV-G4</div><div>--</div></div> <div><div>AV-G6</div><div>--</div></div> <div><div>AV-G7</div><div>--</div></div>	GYM / CLASSROOM	MULTI-PANEL	3-GANG	3-GANG	3-GANG DOUBLE-DEPTH BOX	DOUBLE-DEPTH 3-GANG BELL WEATHERPROOF BOX	HOME RUN TO AV RACK	
<div><div>AV-G8</div><div>--</div></div>								
<div><div>AV-G2</div><div>--</div></div> <div><div>AV-G5</div><div>--</div></div>	GYM	MULTI-PANEL	5-GANG	5-GANG	5-GANG DOUBLE-DEPTH BOX	DOUBLE-DEPTH 5-GANG BELL WEATHERPROOF BOX	HOME RUN TO AV RACK	
<div><div>JB-1</div><div>--</div></div>	GYM	J-BOX	6X6 BLANK	6X6 BLANK	NEMA TYPE 1 6X6X6	NEMA TYPE 1 6X6X6	HOME RUN TO AV RACK	
<div><div>RK-1</div><div>--</div></div>	STORAGE	J-BOX AT EQUIPMENT RACK	N/A	N/A	NEMA TYPE 1 12X12X6	NEMA TYPE 1 12X12X6	HOME RUN TO AV RACK	
<div><div>WX</div><div>--</div></div>	GYM / CLASSROOM	WIRELESS MIC ANTENNA	1-GANG	1-GANG	2-GANG DOUBLE-DEPTH BOX W/ 1-GANG REDUCER	DOUBLE-DEPTH 1-GANG BELL WEATHERPROOF BOX	HOME RUN TO AV RACK	
<div><div>FM</div><div>--</div></div>	GYM / CLASSROOM	FM TRANSMITTER	1-GANG	1-GANG	2-GANG DOUBLE-DEPTH BOX W/ 1-GANG REDUCER	DOUBLE-DEPTH 1-GANG BELL WEATHERPROOF BOX	HOME RUN TO AV RACK	
<div><div>LS-1</div><div>--</div></div>	GYM	LOUDSPEAKER CONNECTION	1-GANG	1-GANG	2-GANG DOUBLE-DEPTH BOX W/ 1-GANG REDUCER	DOUBLE-DEPTH 1-GANG BELL WEATHERPROOF BOX	HOME RUN TO AV RACK	
<div><div>LS-2</div><div>--</div></div>	GYM	LOUDSPEAKER CONNECTION	1-GANG	1-GANG	2-GANG DOUBLE-DEPTH BOX W/ 1-GANG REDUCER	DOUBLE-DEPTH 1-GANG BELL WEATHERPROOF BOX	HOME RUN TO AV RACK	
<div><div>CSP-1</div><div>--</div></div>	GYM	REMOTE CONTROL PANEL	PRE-MADE DEVICE	PRE-MADE DEVICE	MFR: FSR INC MODEL OWB-X3-FM-PLT	MFR: FSR INC MODEL OWB-X3-SM-PLT	HOME RUN TO AV RACK	
<div><div>CSP-2</div><div>--</div></div>	CLASSROOM	REMOTE CONTROL PANEL	1-GANG	1-GANG	2-GANG DOUBLE-DEPTH BOX W/ 1-GANG REDUCER	DOUBLE-DEPTH 1-GANG BELL WEATHERPROOF BOX	HOME RUN TO AV RACK	
<div><div>VPJ</div><div>--</div></div>	GYM	(FUTURE) VIDEO PROJECTOR	BLANK	BLANK	NEMA TYPE 1 6X6X6	NEMA TYPE 1 6X6X6	HOME RUN TO AV RACK	
<div><div>SCRC</div><div>--</div></div>	GYM	(FUTURE) MOTORIZED SCREEN CONTROL	BLANK	BLANK	2-GANG DOUBLE-DEPTH BOX	DOUBLE-DEPTH 2-GANG BELL WEATHERPROOF BOX	HOME RUN TO AV RACK	
<div><div>SC</div><div>--</div></div>	CLASSROOM	CEILING MOUNT 70V LOUDSPEAKER	N/A DIRECT CONNECT	N/A DIRECT CONNECT	1-GANG W/ FLEX CONDUIT TO LOUDSPEAKER	1-GANG W/ FLEX CONDUIT TO LOUDSPEAKER	FROM AV RACK - CONTINUES TO OTHER SIMILAR DEVICES IN AREA	

PRODUCTION SYSTEMS SCOPE MATRIX		
SCOPE	RESPONSIBILITY	
	EC	AV
POWER SYSTEMS (COMPLETE)	X	
COMPANY SWITCHES	X	
CONDUIT FOR AV SYSTEM	X	
WIRE & PULL FOR AV SYSTEMS (LOW-VOLT ONLY)		X
WIRE TERMINATION FOR AV SYSTEMS		X
EQUIPMENT RACKS FOR AV		X
AV EQUIPMENT & INSTALLATION		X
AV TESTING, TUNING, CONFIGURATION		X

ASSISTIVE LISTENING			
	# SEATS	# RECEIVERS / #HEARING AID	TYPE
GYM	868	35/9	FM
CLASSROOM	79	4/2	FM

219.3 Receivers for Assistive Listening Systems <small>-Department of Justice's ADA Standards for Accessible Design (2010)-</small>		
Capacity of Seating in Assembly Area	Minimum Number of Required Receivers	Minimum Number of Required Receivers Required to be Hearing-aid Compatible
50 or less	2	2
51 to 200	2, plus 1 per 25 seats over 50 seats ¹	2
201 to 500	2, plus 1 per 25 seats over 50 seats ¹	1 per 4 receivers ¹
501 to 1000	20, plus 1 per 33 seats over 500 seats ¹	1 per 4 receivers ¹
1001 to 2000	35, plus 1 per 50 seats over 1000 seats ¹	1 per 4 receivers ¹
2001 and over	55 plus 1 per 100 seats over 2000 seats ¹	1 per 4 receivers ¹
1. Or fraction thereof.		

- ASSISTIVE LISTENING CODE REFERENCES
- 219.2 Required Systems. In each assembly area where audible communication is integral to the use of the space, an assistive listening system shall be provided. EXCEPTION: Other than in courtrooms, assistive listening systems shall not be required where audio amplification is not provided.
  - 219.3 Receivers. Receivers complying with 706.2 shall be provided for assistive listening systems in each assembly area in accordance with Table 219.3. Twenty-five percent minimum of receivers provided, but no fewer than two, shall be hearing-aid compatible in accordance with 706.3. EXCEPTIONS: 1. Where a building contains more than one assembly area and the assembly areas required to provide assistive listening systems are under one management, the total number of required receivers shall be permitted to be calculated according to the total number of seats in the assembly areas in the building provided that all receivers are usable with all systems. 2. Where all seats in an assembly area are served by an induction loop assistive listening system, the minimum number of receivers required by Table 219.3 to be hearing-aid compatible shall not be required to be provided.
  - Advisory 706.1 General. Assistive listening systems are generally categorized by their mode of transmission. There are hard-wired systems and three types of wireless systems: induction loop, infrared, and FM radio transmission. Each has different advantages and disadvantages that can help determine which system is best for a given application. For example, an FM system may be better than an infrared system in some open-air assemblies since infrared signals are less effective in sunlight. On the other hand, an infrared system is typically a better choice than an FM system where confidential transmission is important because it will be contained within a given space.
  - 703.7.2.4 Assistive Listening Systems. Assistive listening systems shall be identified by the International Symbol of Access for Hearing Loss complying with Figure 703.7.2.4. (signage by architect).



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ARCHITECTS

Main:  
636 Fifth Street, Santa Rosa, CA 95404  
East Bay:  
55 Harrison Street, Suite 525,  
Oakland, CA 94607  
(707) 576-0829

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DSA APP NO. 01-119278		
ARCH PROJECT NO.		1869.00
DRAWN BY:		
DRAWING SCALE:		
PTN: 61721-78		FILE NO: 7-H4
BID DOCUMENT		
APRIL 27, 2021		
SHEET TITLE		

AV PANEL  
SCHEDULE &  
ALS  
INFORMATION

SHEET NUMBER



WIRETYPE SCHEDULE

NOTES:  
1- WIRETYPES SHOWN BELOW ARE CURRENT TO OUR BEST KNOWLEDGE.  
2- MANUFACTURER SUBSTITUTIONS ARE ALLOWED, WITH APPROVAL FROM CONSULTANT.  
3- ALL CONDUIT, BACKBOXES AND JUNCTION BOXES BY ELECTRICAL CONTRACTOR.

TYPE	DESCRIPTION	DRY LOCATIONS EX: IN-WALL, CEILING, & CMD					WET LOCATIONS EX: IN-SLAB, IN-GRADE, OUTDOOR					NOTES
		MFR	MODEL	O.D.	AREA	RATING	MFR	MODEL	O.D.	AREA	RATING	

GROUP A - MIC LEVEL												
A1	Microphone Level Audio 22 AWG, 7X30 Stranding, Foil shield	Belden	9451	0.135	0.0143	CMR	Belden	2451RW	0.158	0.0196	CMR	

GROUP B - LINE LEVEL												
B1	Line Level Audio 22 AWG, 7x30 Stranding, Foil Shield	Belden	9451	0.135	0.0143	CMR	Belden	2451RW	0.158	0.0196	CMR	
B2	Digital Audio - AES/EBU, 110-ohm 22 AWG, 7x30 Stranding, Foil Shield	Gepco	DS401	0.180	0.0254	CMR	Sommer Cable	200-0241AQ	0.276	0.0598	CMR	
B3	Line Audio + DC Power 1-PR 22 AWG, 7x30 Stranding, Foil Shield 1-PR 18 AWG, 16x30 Stranding, Foil Shield	Belden	1502R	0.250	0.0491	CMR	Liberty	LLINX-U-DB	0.275	0.0549	DB	Runs Under 300'
B3B	Line Audio + DC Power 1-PR 22 AWG, 7x30 Stranding, Foil Shield 1-PR 14 AWG, 16x30 Stranding, Foil Shield	Sommer Cable	500-0101-1	0.291	0.0665	CMR	Belden	(1) 2451RW & (1) 5000U1	0.158 & 0.320	0.0196 & 0.0804	N/A	Runs Over 300'

GROUP C - VIDEO, NETWORK, & RF LEVEL												
C1	Party-Line Intercom, 1 CH 20 AWG, 7x28 Stranding, Foil Shield	Belden	8762	0.204	0.0327	CM	West Penn	AQC292	0.220	0.0380	CL3	Runs Under 500'
C1B	Party-Line Intercom, 1 CH 18 AWG, 16x30 Stranding, Foil Shield	Belden	8760	0.222	0.0387	CM	West Penn	AQ293	0.310	0.0754	CL3	Runs Over 500'
C1C	Digital Intercom, 1 CH 20 AWG, 7x28 Stranding, Foil Shield	Belden	9207	0.330	0.0855	CMG	West Penn	AQC292	0.220	0.0380	CL3	Helix-Net 1 Channel
C2	Party-Line Intercom, 2 CH 22 AWG, 7x30 Stranding, Foil Shield, 2 Pair	Belden	1814R	0.330	0.0855	CMR	West Penn	AQC430	0.250	0.0491	CL3	
C3	Party-Line Intercom, 4 CH 22 AWG, 7x30 Stranding, Foil Shield, 4 Pair	Belden	1815R	0.384	0.1158	CMR	West Penn	AQC439	0.427	0.1431	CL3	
C3B	Digital Intercom, Multi-CH 24 AWG, Solid, Foil Shield, 4 Pair, Cat5e, F/UTP	Belden	1533R	0.260	0.0531	CMR	Belden	7937A	0.276	0.0598	DB	Helix-Net Multi Channel
C5	Ethernet Data, Cat 6A, Single Foil Shield, F/UTP 23 AWG, Solid, Bonded Pairs	Belden	10GX62F	0.300	0.0707	CMR	Belden	2141A	.370	0.1075	CM-LS	
C6	Crestron / AMX Control 22 AWG, 7x30 Stranded, Foil Shield, (DATA) 18 AWG, 16x30 Stranded, (Power)	Liberty	LLINX-U	0.246	0.0475	CMG	Liberty	LLINX-U-DB	0.275	0.0549	DB	
C7	DC Control, 2 Conductor 18 AWG, 16x30 Stranded, Twisted Pair	Belden	9740	0.210	0.0346	CMG	West Penn	AQ224	0.270	0.0572	CL3	
C8	DC Control, 4 Conductor 18 AWG, 16x30 Stranded, Twisted Pair	Belden	9156	0.333	0.0870	CMG	West Penn	AQ244	0.327	0.0839	CL3	
C9	CATV Video 18 AWG, Solid Conductor, Braided Shield, RG-6 Type	Belden	9116	0.270	0.0572	CM, CATV	West Penn	AQC841	0.275	0.0594	CL3	
C10	Production Video 20 AWG, Solid Conductor, Braided Shield, RG-59 Type	Belden	1505A	0.233	0.0426	CMR	Belden	88281	0.271	0.0577	CMP	Runs Under 500'
C10B	Production Video 18 AWG, Solid Conductor, Braided Shield	Belden	1694A	0.274	0.0589	CMR	Belden	1694WB	0.274	0.0589	CMR	Runs Over 500'
C10C	Production Video 16 AWG, Solid Conductor, Braided Shield	Belden	4794R	0.320	0.0804	CMR	NO KNOWN OPTION					
C12	Wireless Antenna 10 AWG, Solid Conductor, Braided Shield, RG-8/U, 50Ω	Time Microwave systems	LMR-400-FR	0.405	0.1288	CMR	Time Microwave Systems	LMR-400-DB	0.405	0.1288	DB	
C14	Infrared Emitter 19 AWG, Solid Conductor, Braided Shield	Time Microwave systems	LMR-200-FR	0.195	0.0298	CMR	Time Microwave Systems	LMR-200-DB	0.195	0.0298	DB	Runs Under 100'
C15	Extron XTP/DTP shielded 4-Twisted Pair	Extron	XTP DTP 24	0.276	0.0598	CM	NO KNOWN OPTION					
C19	Digital Media Cable, 8G Shielded 4 Twisted	Crestron	DM-CBL-8G-NP	0.244	0.0467	CMR	NO KNOWN OPTION					Use DM-8G-CONN Connector

GROUP D - LOUDSPEAKER LEVEL												
D1	Loudspeaker, 2 Conductor 12 AWG, 65X30 Stranded	Belden	5000UP	.312	0.0764	CL3	Belden	5000U1	0.320	0.0804	WB	
D2	Loudspeaker, 4 Conductor 12 AWG, 65X30 Stranded	Belden	5002UP	0.365	0.1046	CL3	Belden	5002U1	0.377	0.1116	WB	
D3	Loudspeaker, 70 Volt, 2 Conductor 18 AWG, 7x26 Stranded	West Penn	224	0.156	0.0191	CMR	West Penn	AQ224	0.270	0.0572	CL3	
D4	Loudspeaker, 70 Volt, 4 Conductor 18 AWG, 7x26 Stranded	West Penn	244	0.183	0.0263	CMR	West Penn	AQ244	0.327	0.0839	CL3	

GROUP E - EMPTY CONDUIT												
E	NO WIRETYPE, FOR FUTURE EXPANSION											

GROUP F - FIBER OPTIC LEVEL												
F3	Single-Mode Fiber, 2-strand 1310 μm, OS2, OFNR	Belden	FISD002R9	0.184	0.0266	OFNR	Belden	FSSL002NF	0.184	0.0266	OFNR	
F5	Multi-Mode Fiber, 2-strand, OM3 50/125 MM, DUPLEX, OFNR	Belden	FL4D002R9	0.184	0.0266	OFNR	Belden	FS2H002NF	0.184	0.0266	OFNR	

1 AV WIRETYPE SCHEDULE

CONDUIT SEPARATION TABLE -AV CONDUITS-					
	A	B	C	D	E
A	--	12"	12"	12"	12"
B	12"	--	6"	6"	6"
C	12"	6"	--	6"	6"
D	12"	6"	6"	--	6"
E	12"	6"	6"	6"	--

CONDUIT SEPARATION NOTES

- THE AV SPECIFIC CONDUIT SEPARATION TABLE ABOVE REFLECTS BEST-CASE SCENARIOS, AND SHOULD BE ADHERED TO WHEN POSSIBLE.
- ABSOLUTE MINIMUM SEPARATION FOR AV CONDUIT IS 4", IF ABOVE DISTANCES ARE NOT ACHIEVABLE.
- ABSOLUTE MINIMUM SEPARATION BETWEEN AV AND ELECTRICAL POWER CONDUITS IS 36"


2 CONDUIT SEPARATION TABLES

CONDUIT RUN LENGTH LIMITS -ELECTRICAL-	
AV CONDUIT TYPE	MAX RUN LENGTH
A	500'
B	500'
C	250'
D	500'
E	250'
F	5000'

CONDUIT RUN LENGTH LIMIT NOTES

- C-TYPE CONDUIT CONTAINS IP BASED NETWORK CONNECTIONS THAT CAN NOT EXCEED 250'
- IF CONDUIT RUN LENGTHS CAN NOT BE MAINTAINED, CONTRACTOR MUST SUBMIT RUN LENGTH FOR APPROVAL.

3 CONDUIT RUN LENGTH LIMITS

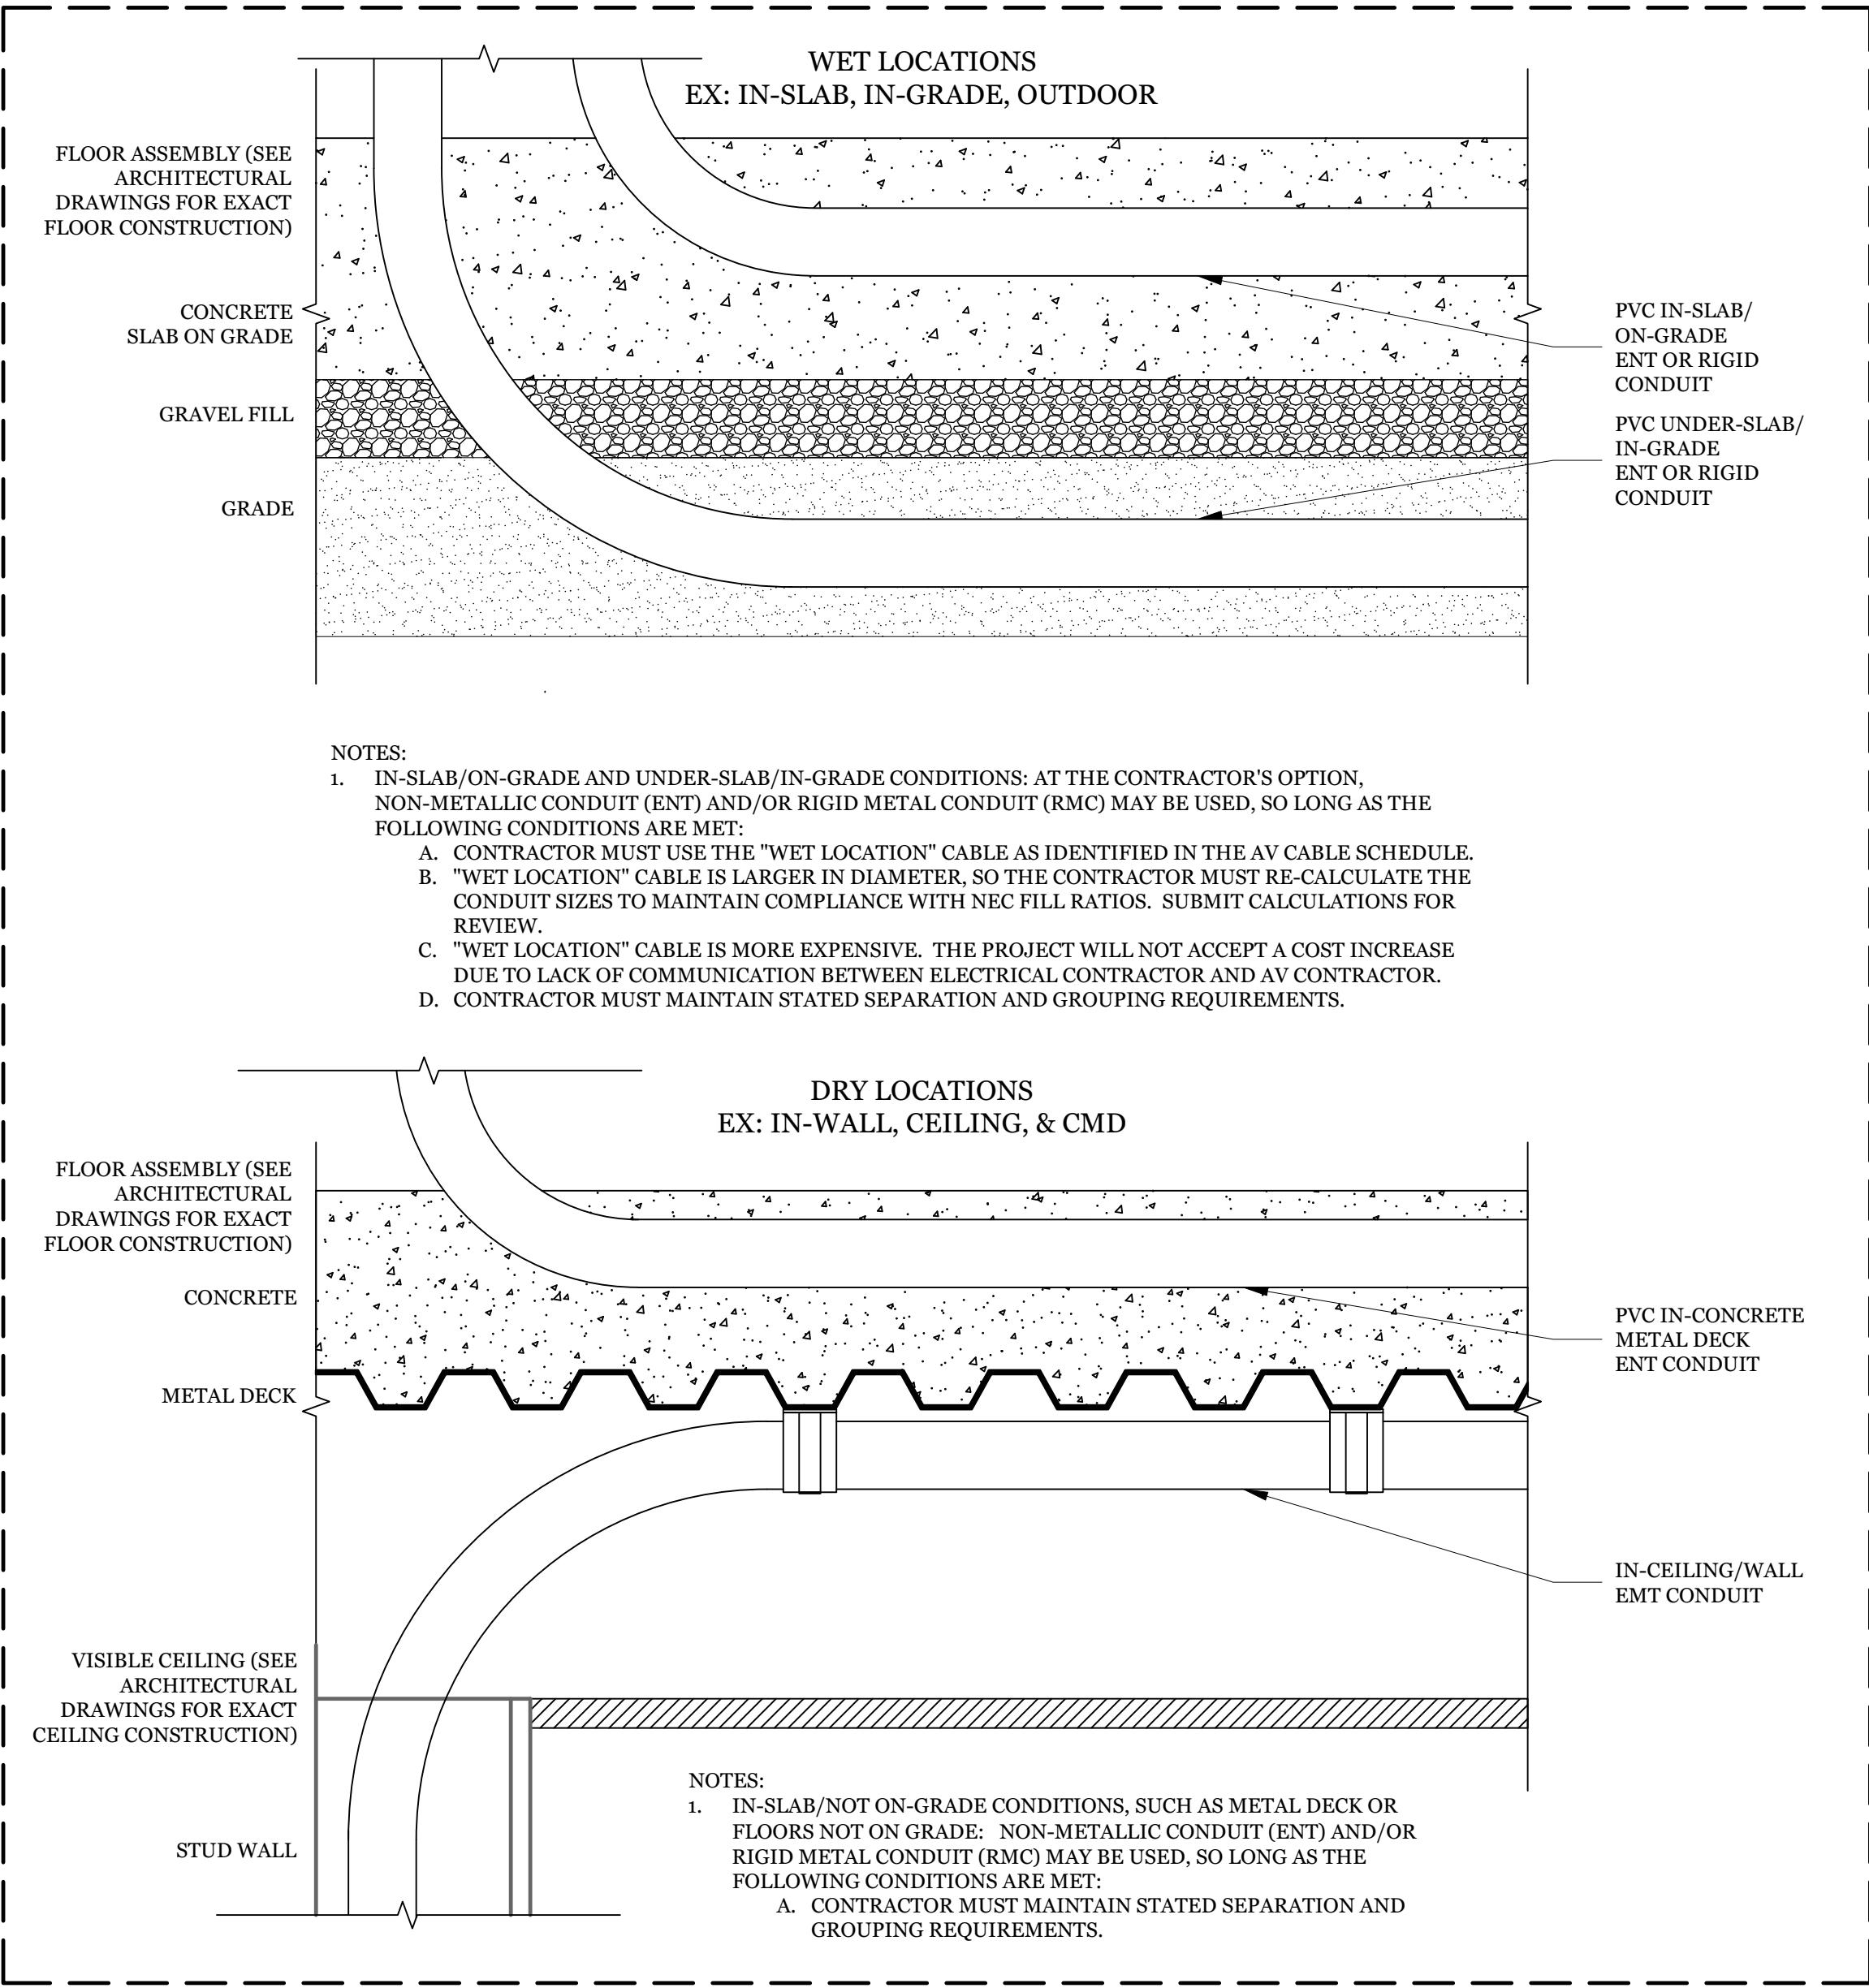

4 WET/DRY CABLE SELECTION GUIDELINES



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Main:  
636 Fifth Street, Santa Rosa, CA 95404  
East Bay:  
55 Harrison Street, Suite 525,  
Oakland, CA 94607  
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Tel: 415-995-4300  
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ARCH PROJECT NO: 1869.00

DRAWN BY:  

DRAWING SCALE:  

PTN: 61721-78      FILE NO: 7-H4

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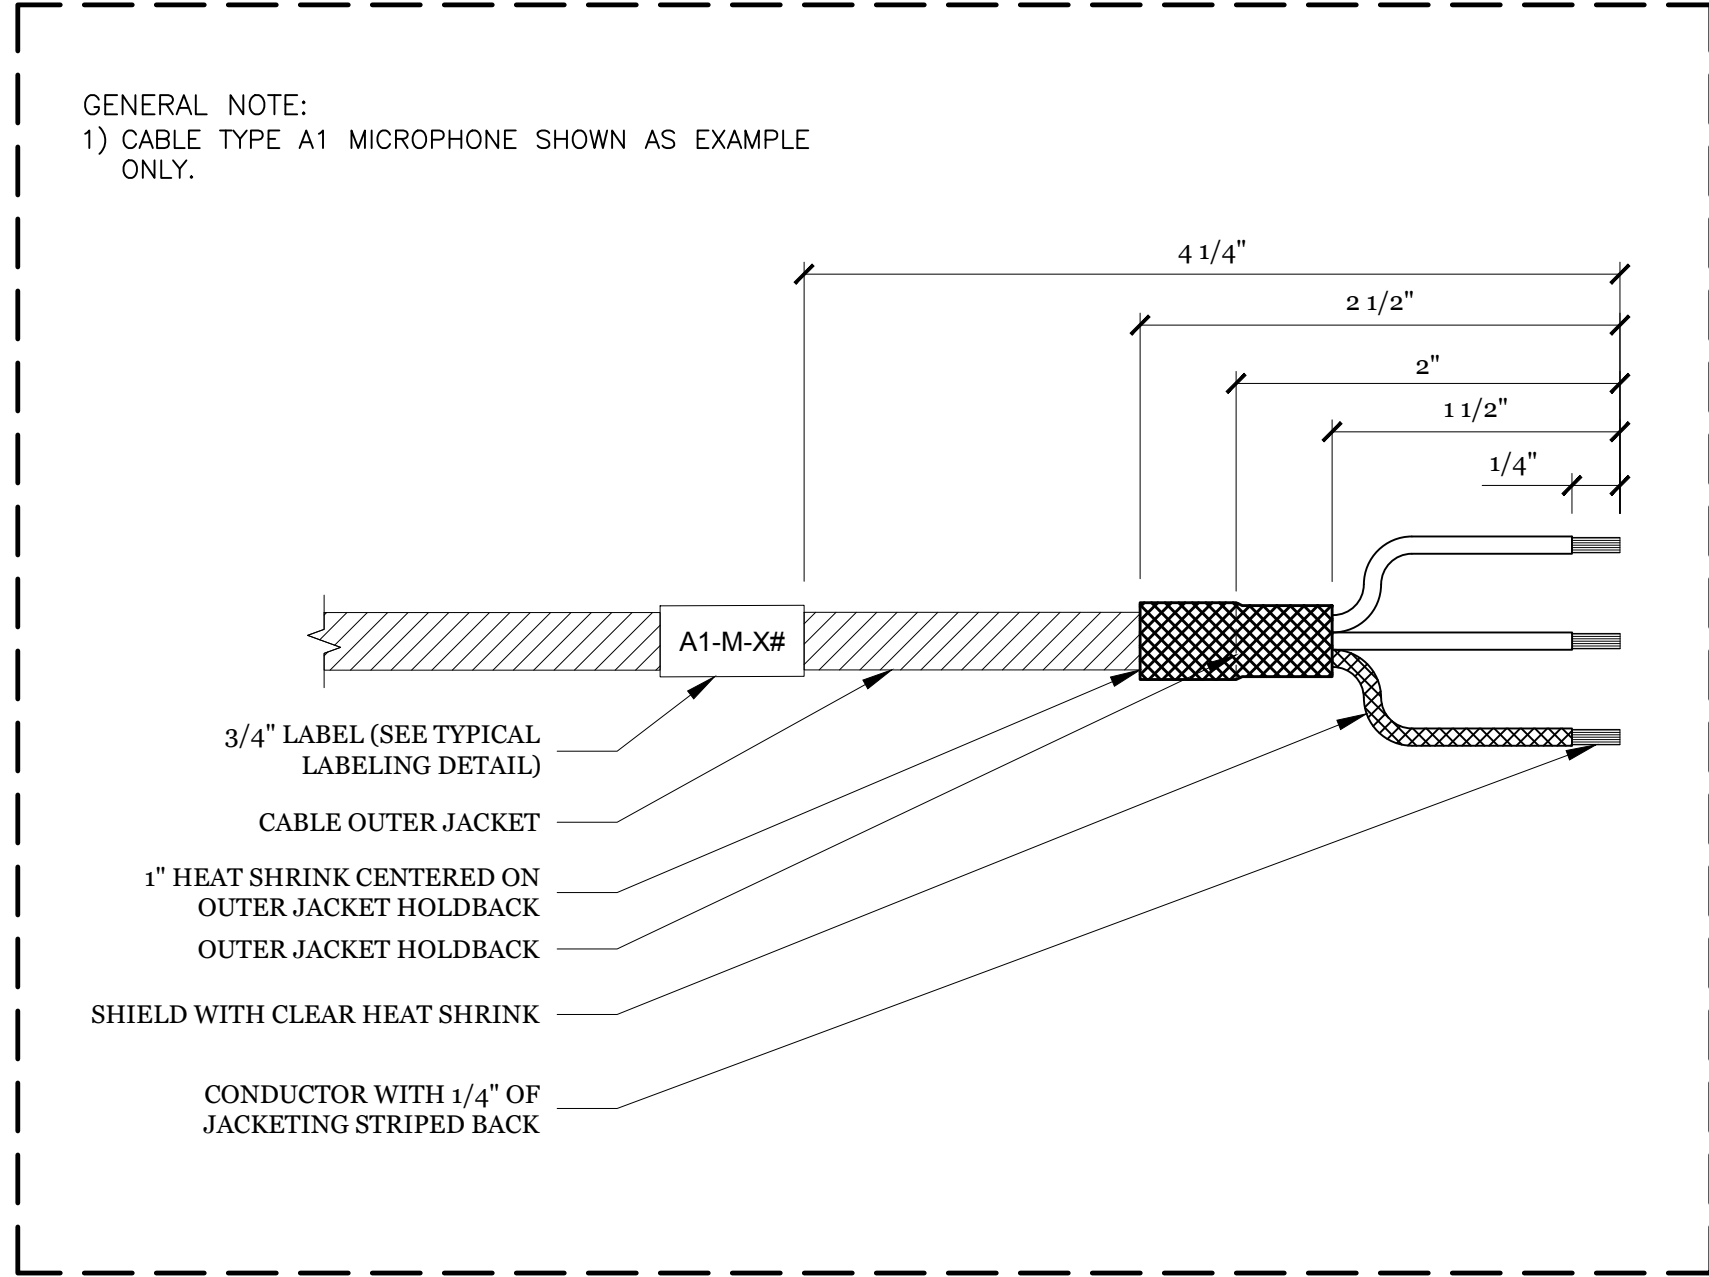
APRIL 27, 2021

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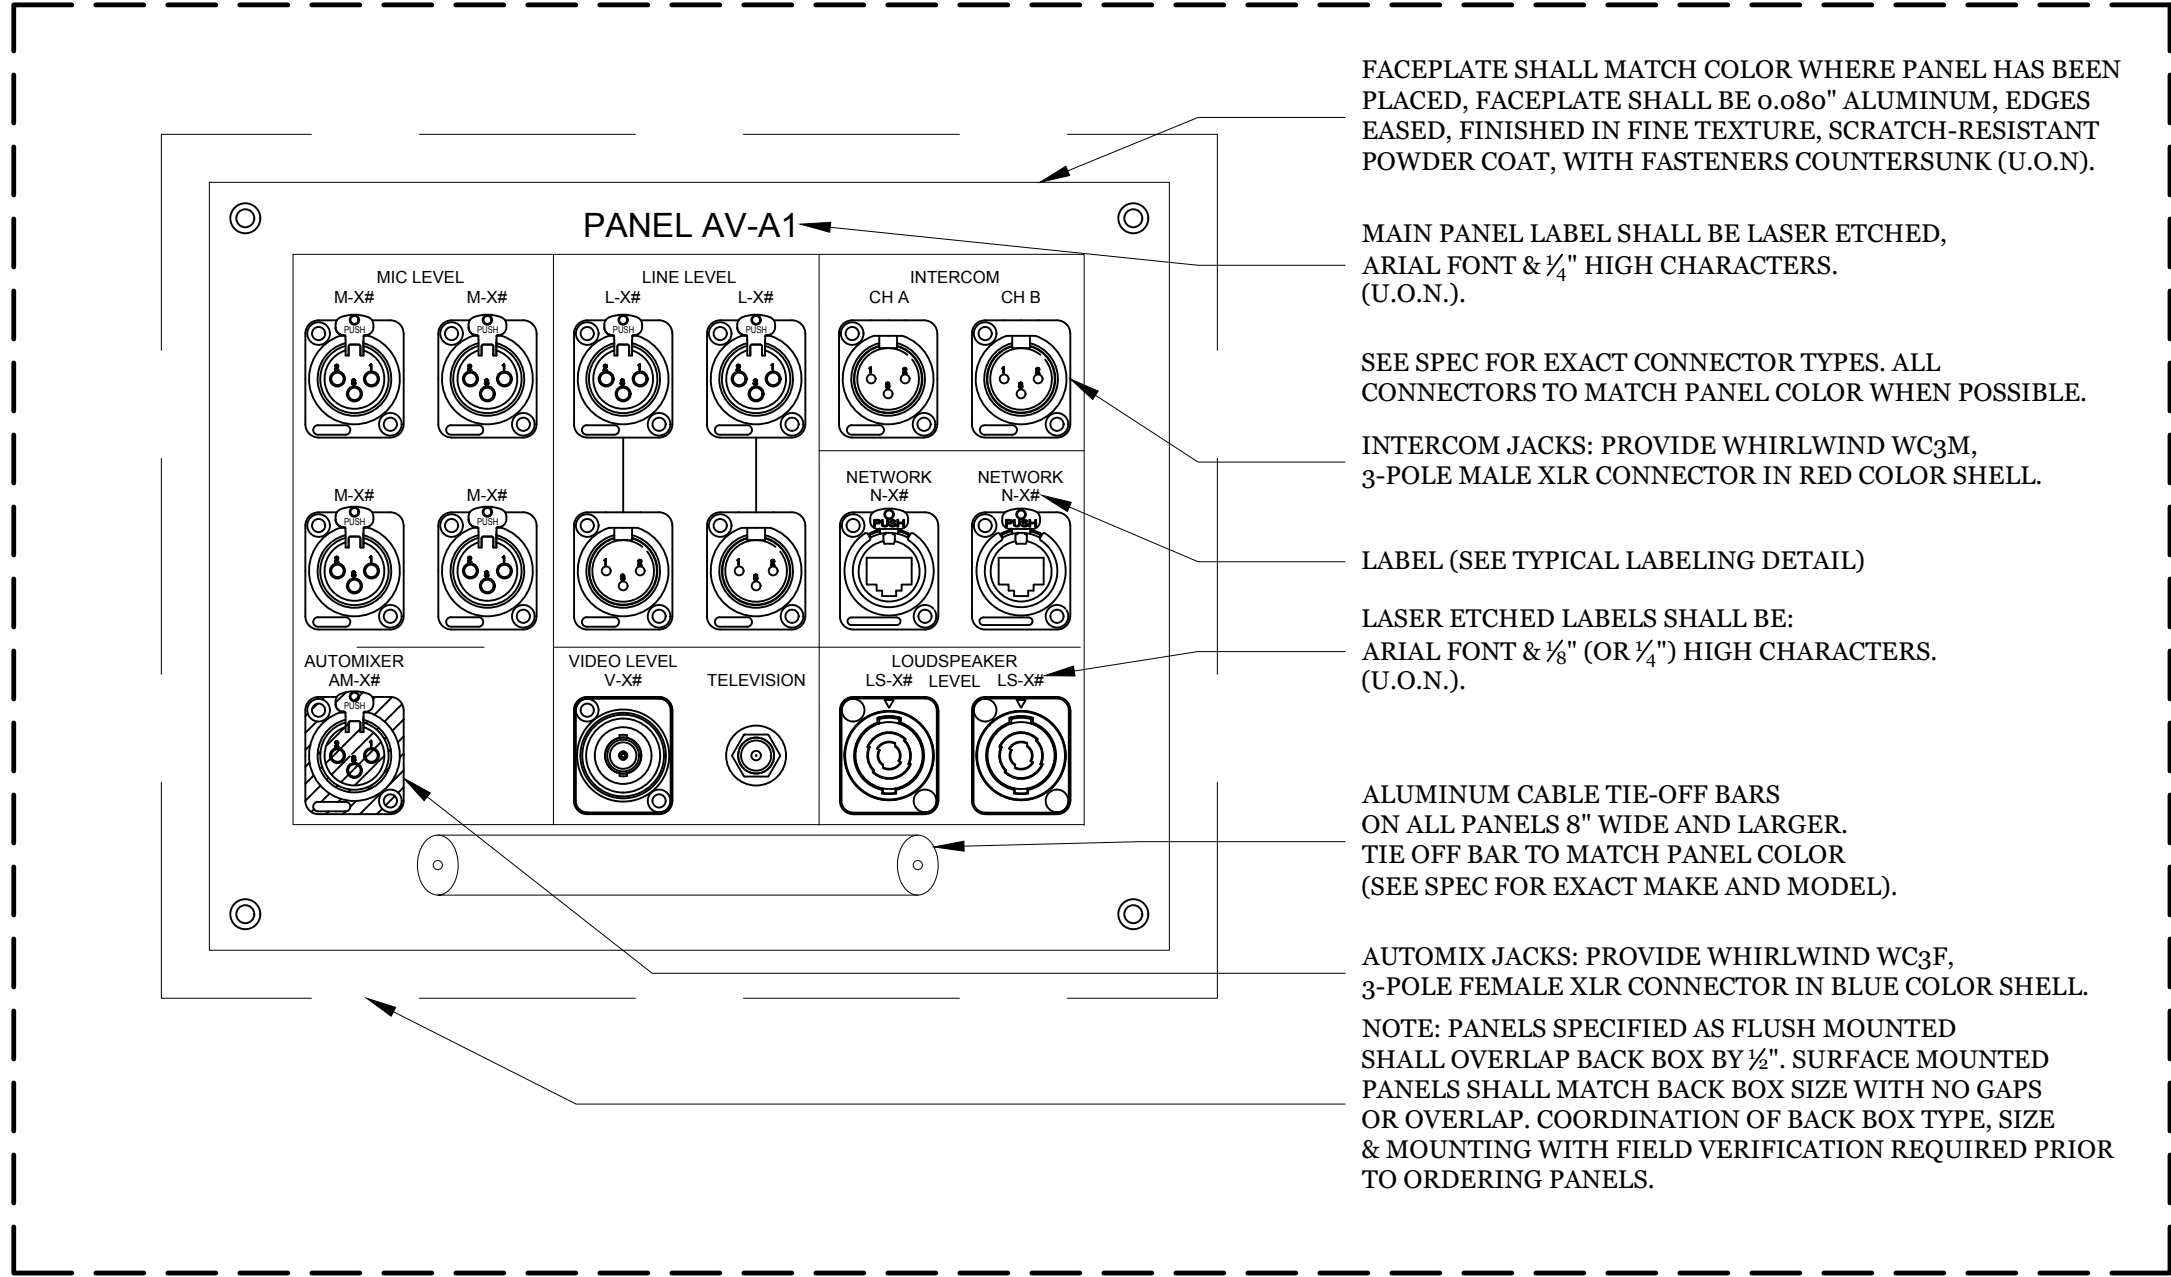
AV WIRETYPE  
SCHEDULE

SHEET NUMBER






1 TYPICAL WIRE TERMINATION PREP  
NTS



2 TYPICAL MULTI I/O PANEL  
NTS

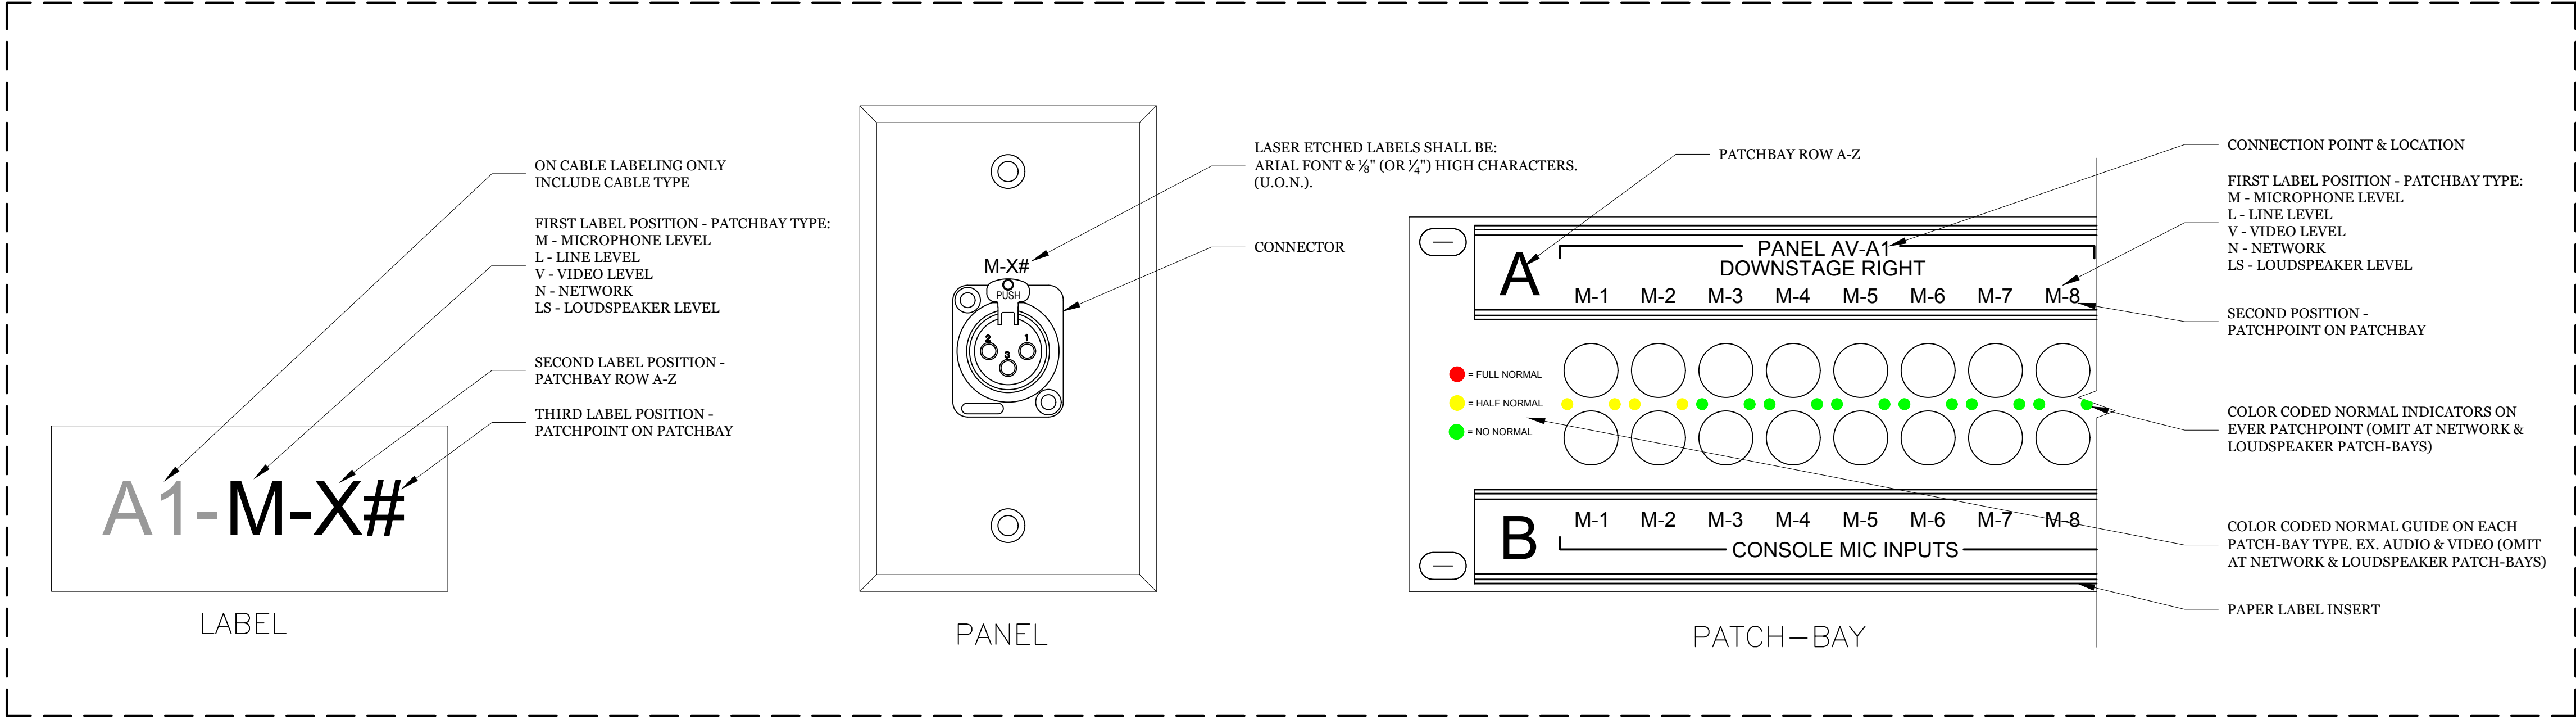


3 TYPICAL LABELING DETAIL  
NTS

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SHEET TITLE





1 RACK ELEVATION GUIDELINES  
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Main:  
636 Fifth Street, Santa Rosa, CA 95404  
East Bay:  
55 Harrison Street, Suite 525,  
Oakland, CA 94607  
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## FREEDOM HIGH SCHOOL
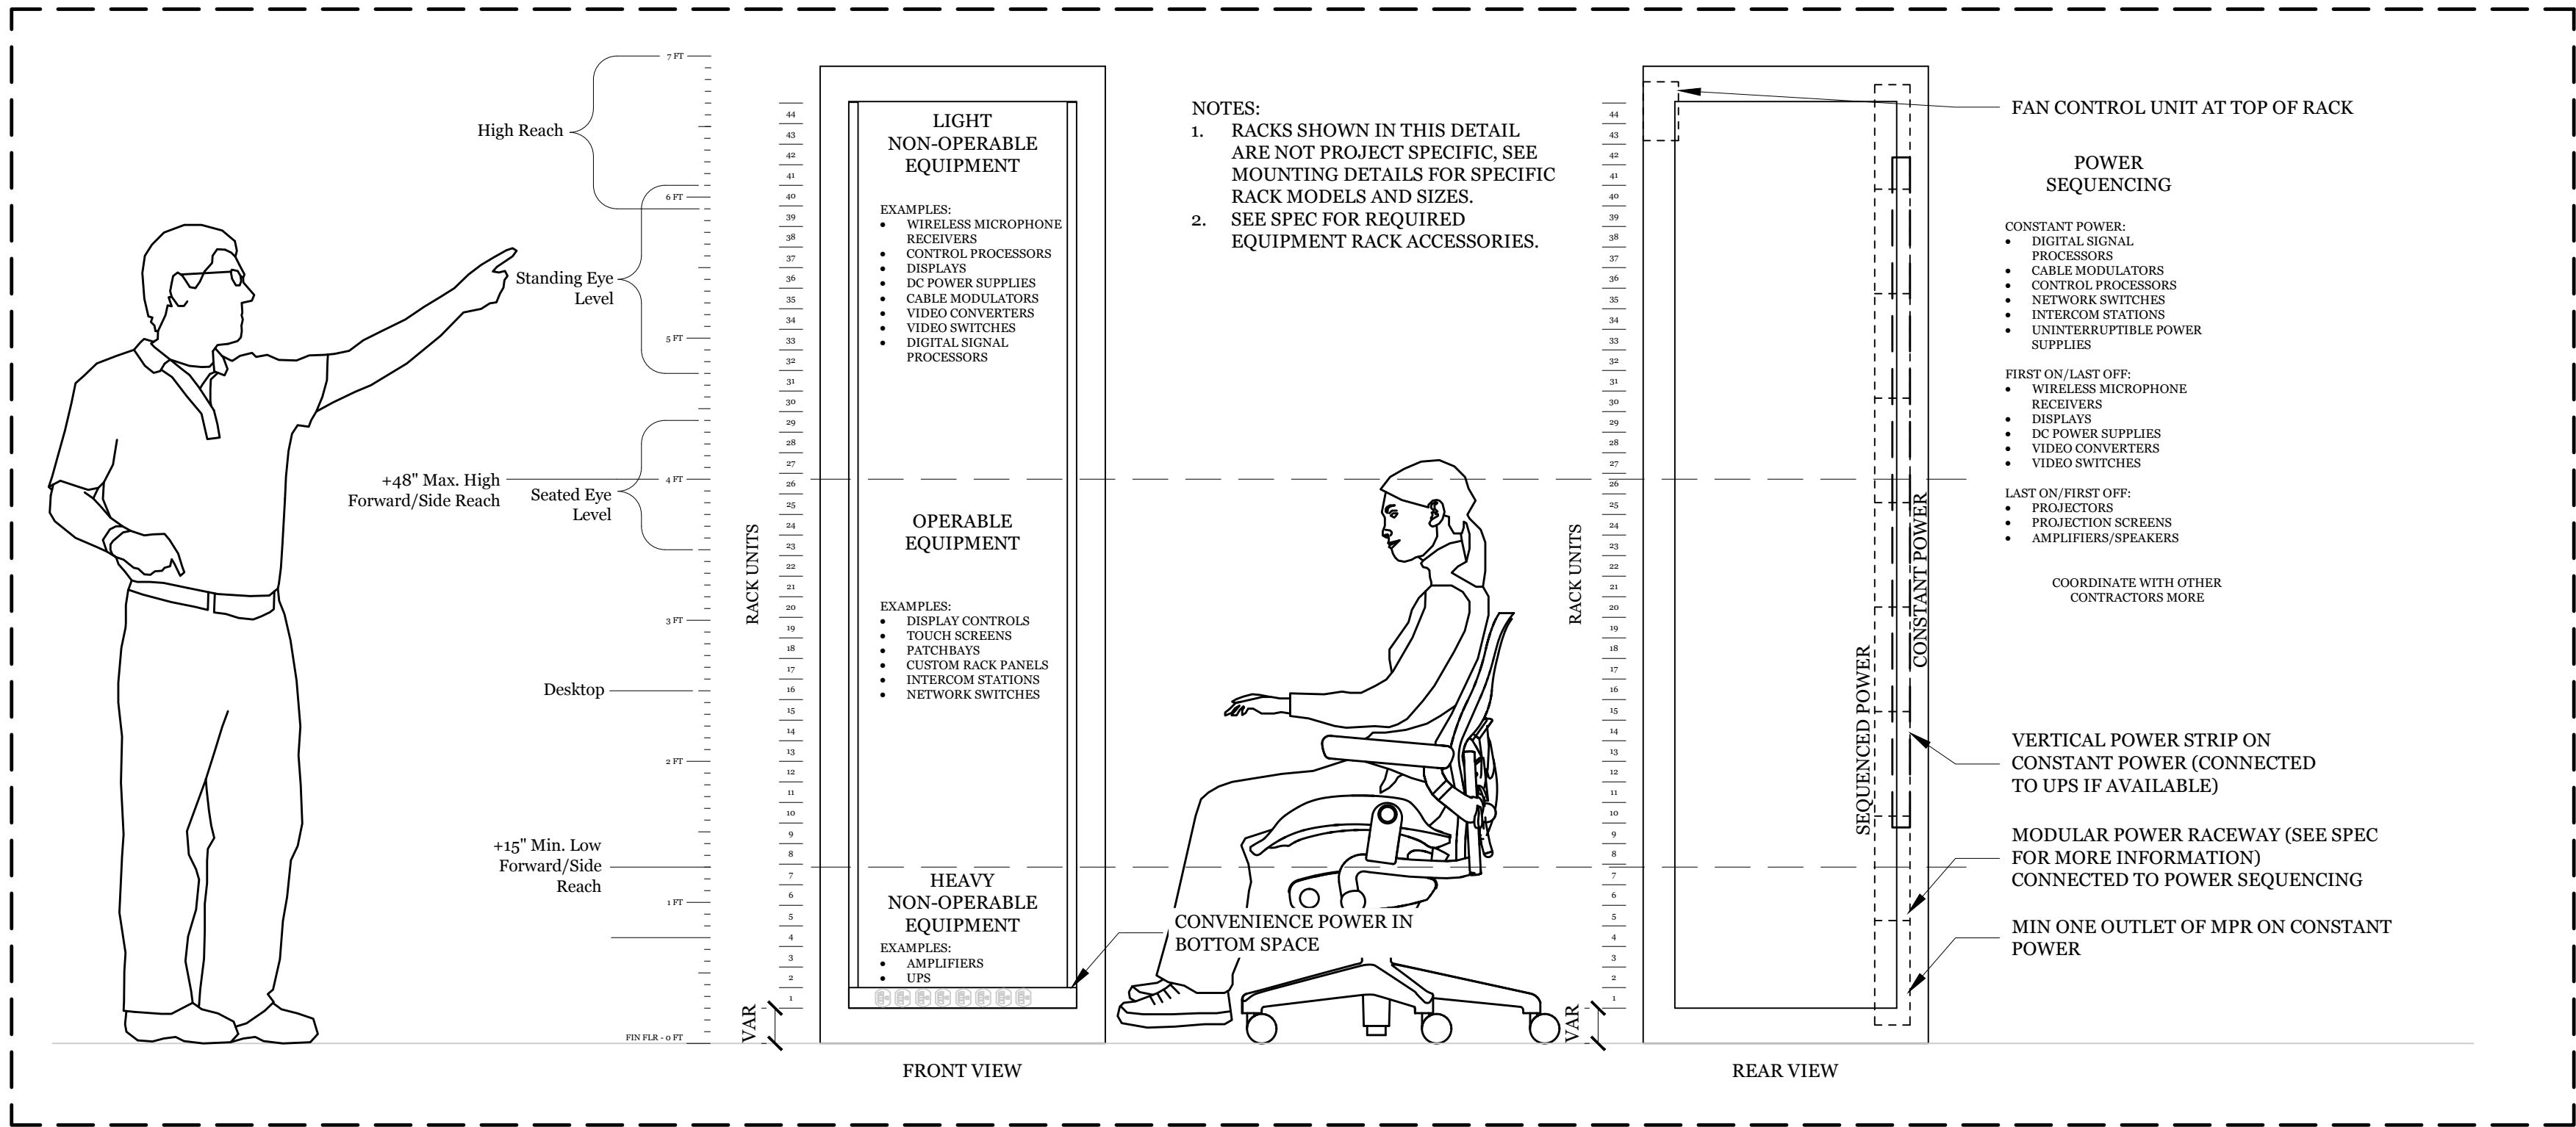
## NEW AUXILIARY GYMNASIUM

1050 NEROLY RD,  
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## LIBERTY UNION HIGH SCHOOL DISTRICT

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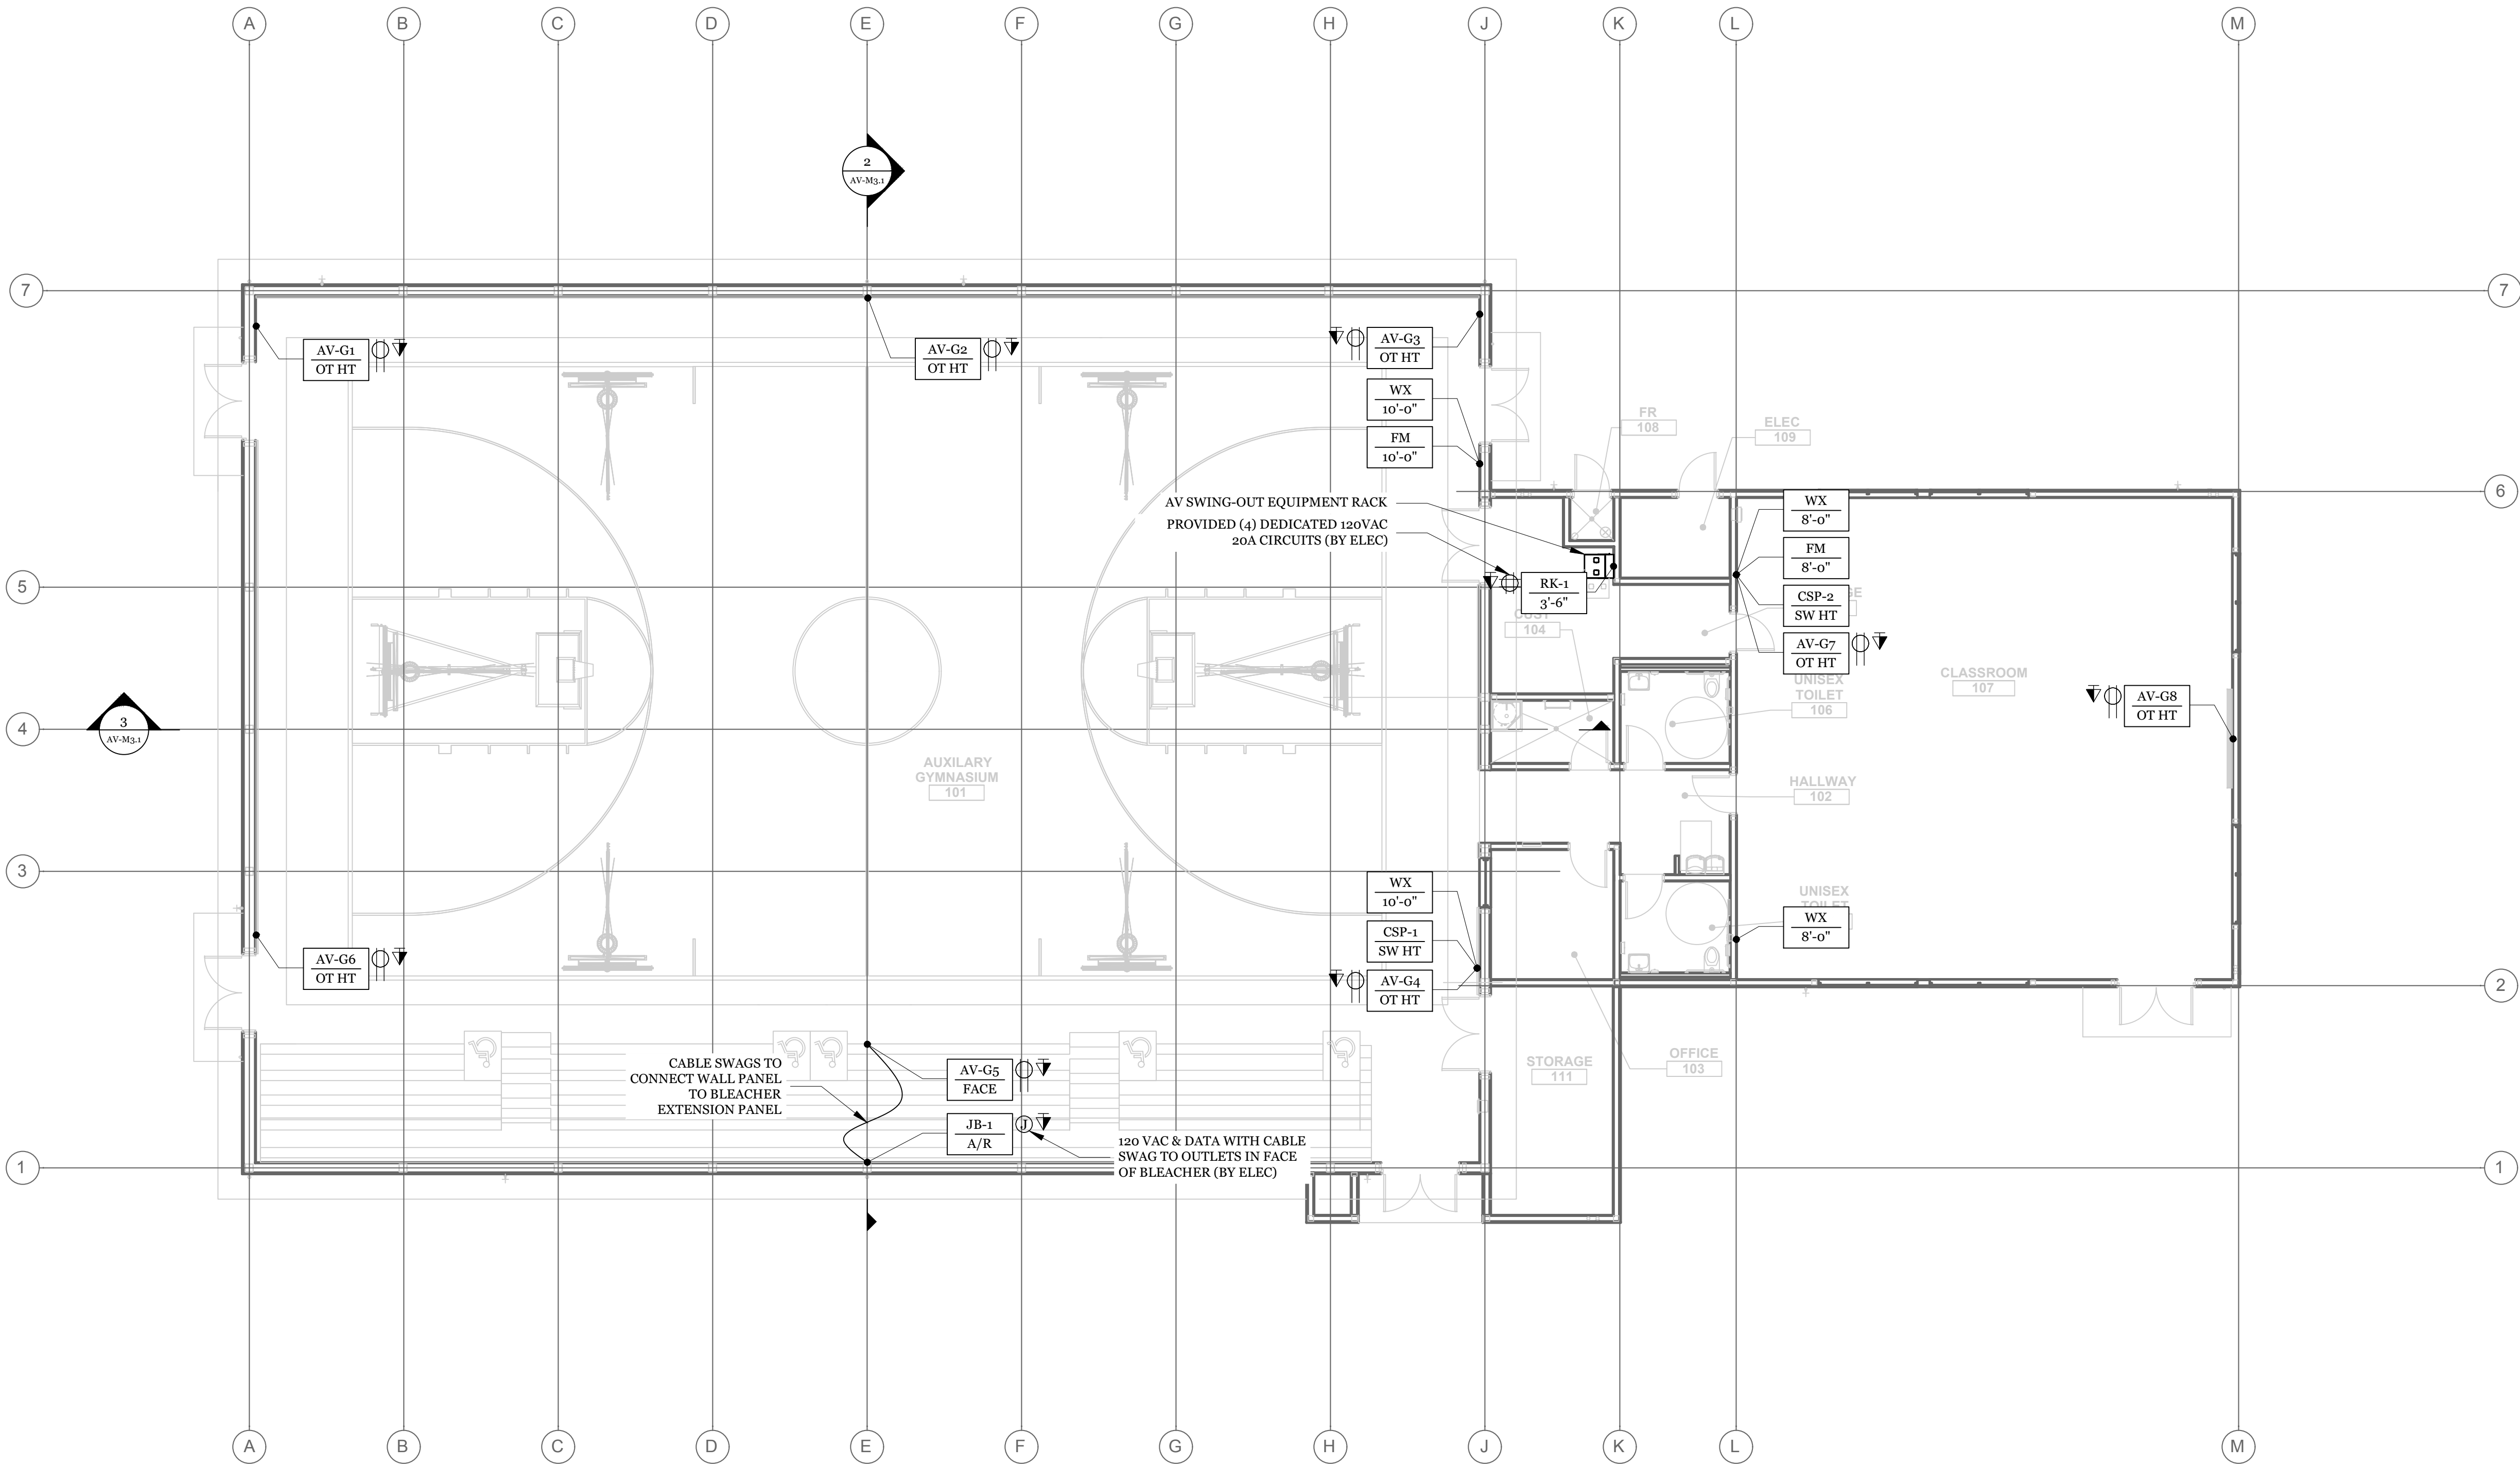
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## AV STANDARD DETAILS

SHEET NUMBER


# AV-M.04





1 AV DEVICE PLAN AT LEVEL 1  
1/8"=1'-0"

AV SYMBOL KEY

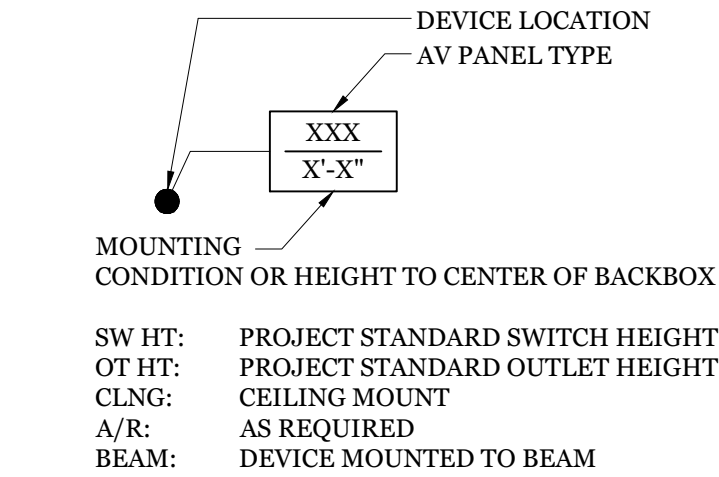

SW HT: PROJECT STANDARD SWITCH HEIGHT  
OT HT: PROJECT STANDARD OUTLET HEIGHT  
CLNG: CEILING MOUNT  
A/R: AS REQUIRED  
BEAM: DEVICE MOUNTED TO BEAM


AUDIO  
• AV-XX: CUSTOM AV PANEL & LOCATION  
• FM: FM ASSISTIVE LISTENING ANTENNA  
• WX: WIRELESS MICROPHONE ANTENNA

VIDEO  
• VPJ: VIDEO PROJECTOR

LOUDSPEAKER  
• LS-#: LOUDSPEAKER & JACK QUANTITY / TYPE  
• SC: CEILING MOUNT 70V LOUDSPEAKER

CONTROL  
• SCRC: MOTORIZED ROLL-DOWN SCREEN CONTROL  
• CSP-#: REMOTE CONTROL PANEL & LOCATION

OTHER  
• JB-#: JUNCTION BOX  
• RK-#: EQUIPMENT RACK JUNCTION BOX

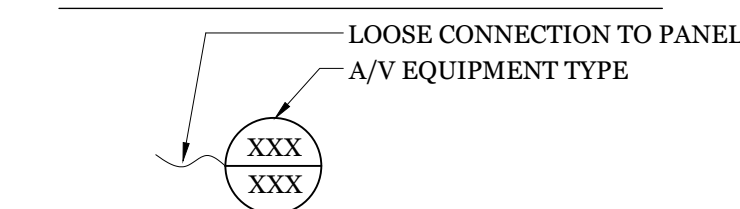

MOUNTING  
CONDITION  
AUDIO  
• MIC: MICROPHONE

VIDEO  
• VCAM: VIDEO CAMERA  
• VPJ: VIDEO PROJECTOR

LOUDSPEAKER  
• LS: LOUDSPEAKER  
• SUB: SUBWOOFER  
• PS: PAGING SPEAKER

ELECTRICAL

- ⌚ DUPLEX OUTLET, 120V / 20A (BY ELEC)
- ⌚ QUAD OUTLET, 120V / DUAL 20A (BY ELEC)
- ⌚ SPECIALTY OUTLET (SEE DESCRIPTION) (BY ELEC)
- ⌚ JUNCTION BOX (SEE DESCRIPTION) (BY ELEC)
- ⌚ TEL/DATA OUTLET (BY ELEC)

GENERAL NOTES

- ALL AC OUTLETS, CONDUIT & BACKBOXES BY ELECTRICAL.
- REQUIRED STRUCTURAL BACKING BY STRUCTURAL ENGINEER.
- A/V CONTRACTOR TO COORDINATE WITH ELECTRICAL TO DETERMINE EXACT LOCATION OF A/V BACKBOXES.
- ALL VISIBLE LOUDSPEAKERS & PANELS SHALL BE PROVIDED IN A COLOR AS DETERMINED BY THE ARCHITECT DURING THE SHOP DRAWING PHASE. COORDINATE EXACT MOUNTING CONDITIONS WITH ARCHITECT, STRUCTURAL ENGINEER & GENERAL CONTRACTOR.



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ARCHITECTS  
Main:  
636 Fifth Street, Santa Rosa, CA 95404  
East Bay:  
55 Harrison Street, Suite 525,  
Oakland, CA 94607  
(707) 576-0829

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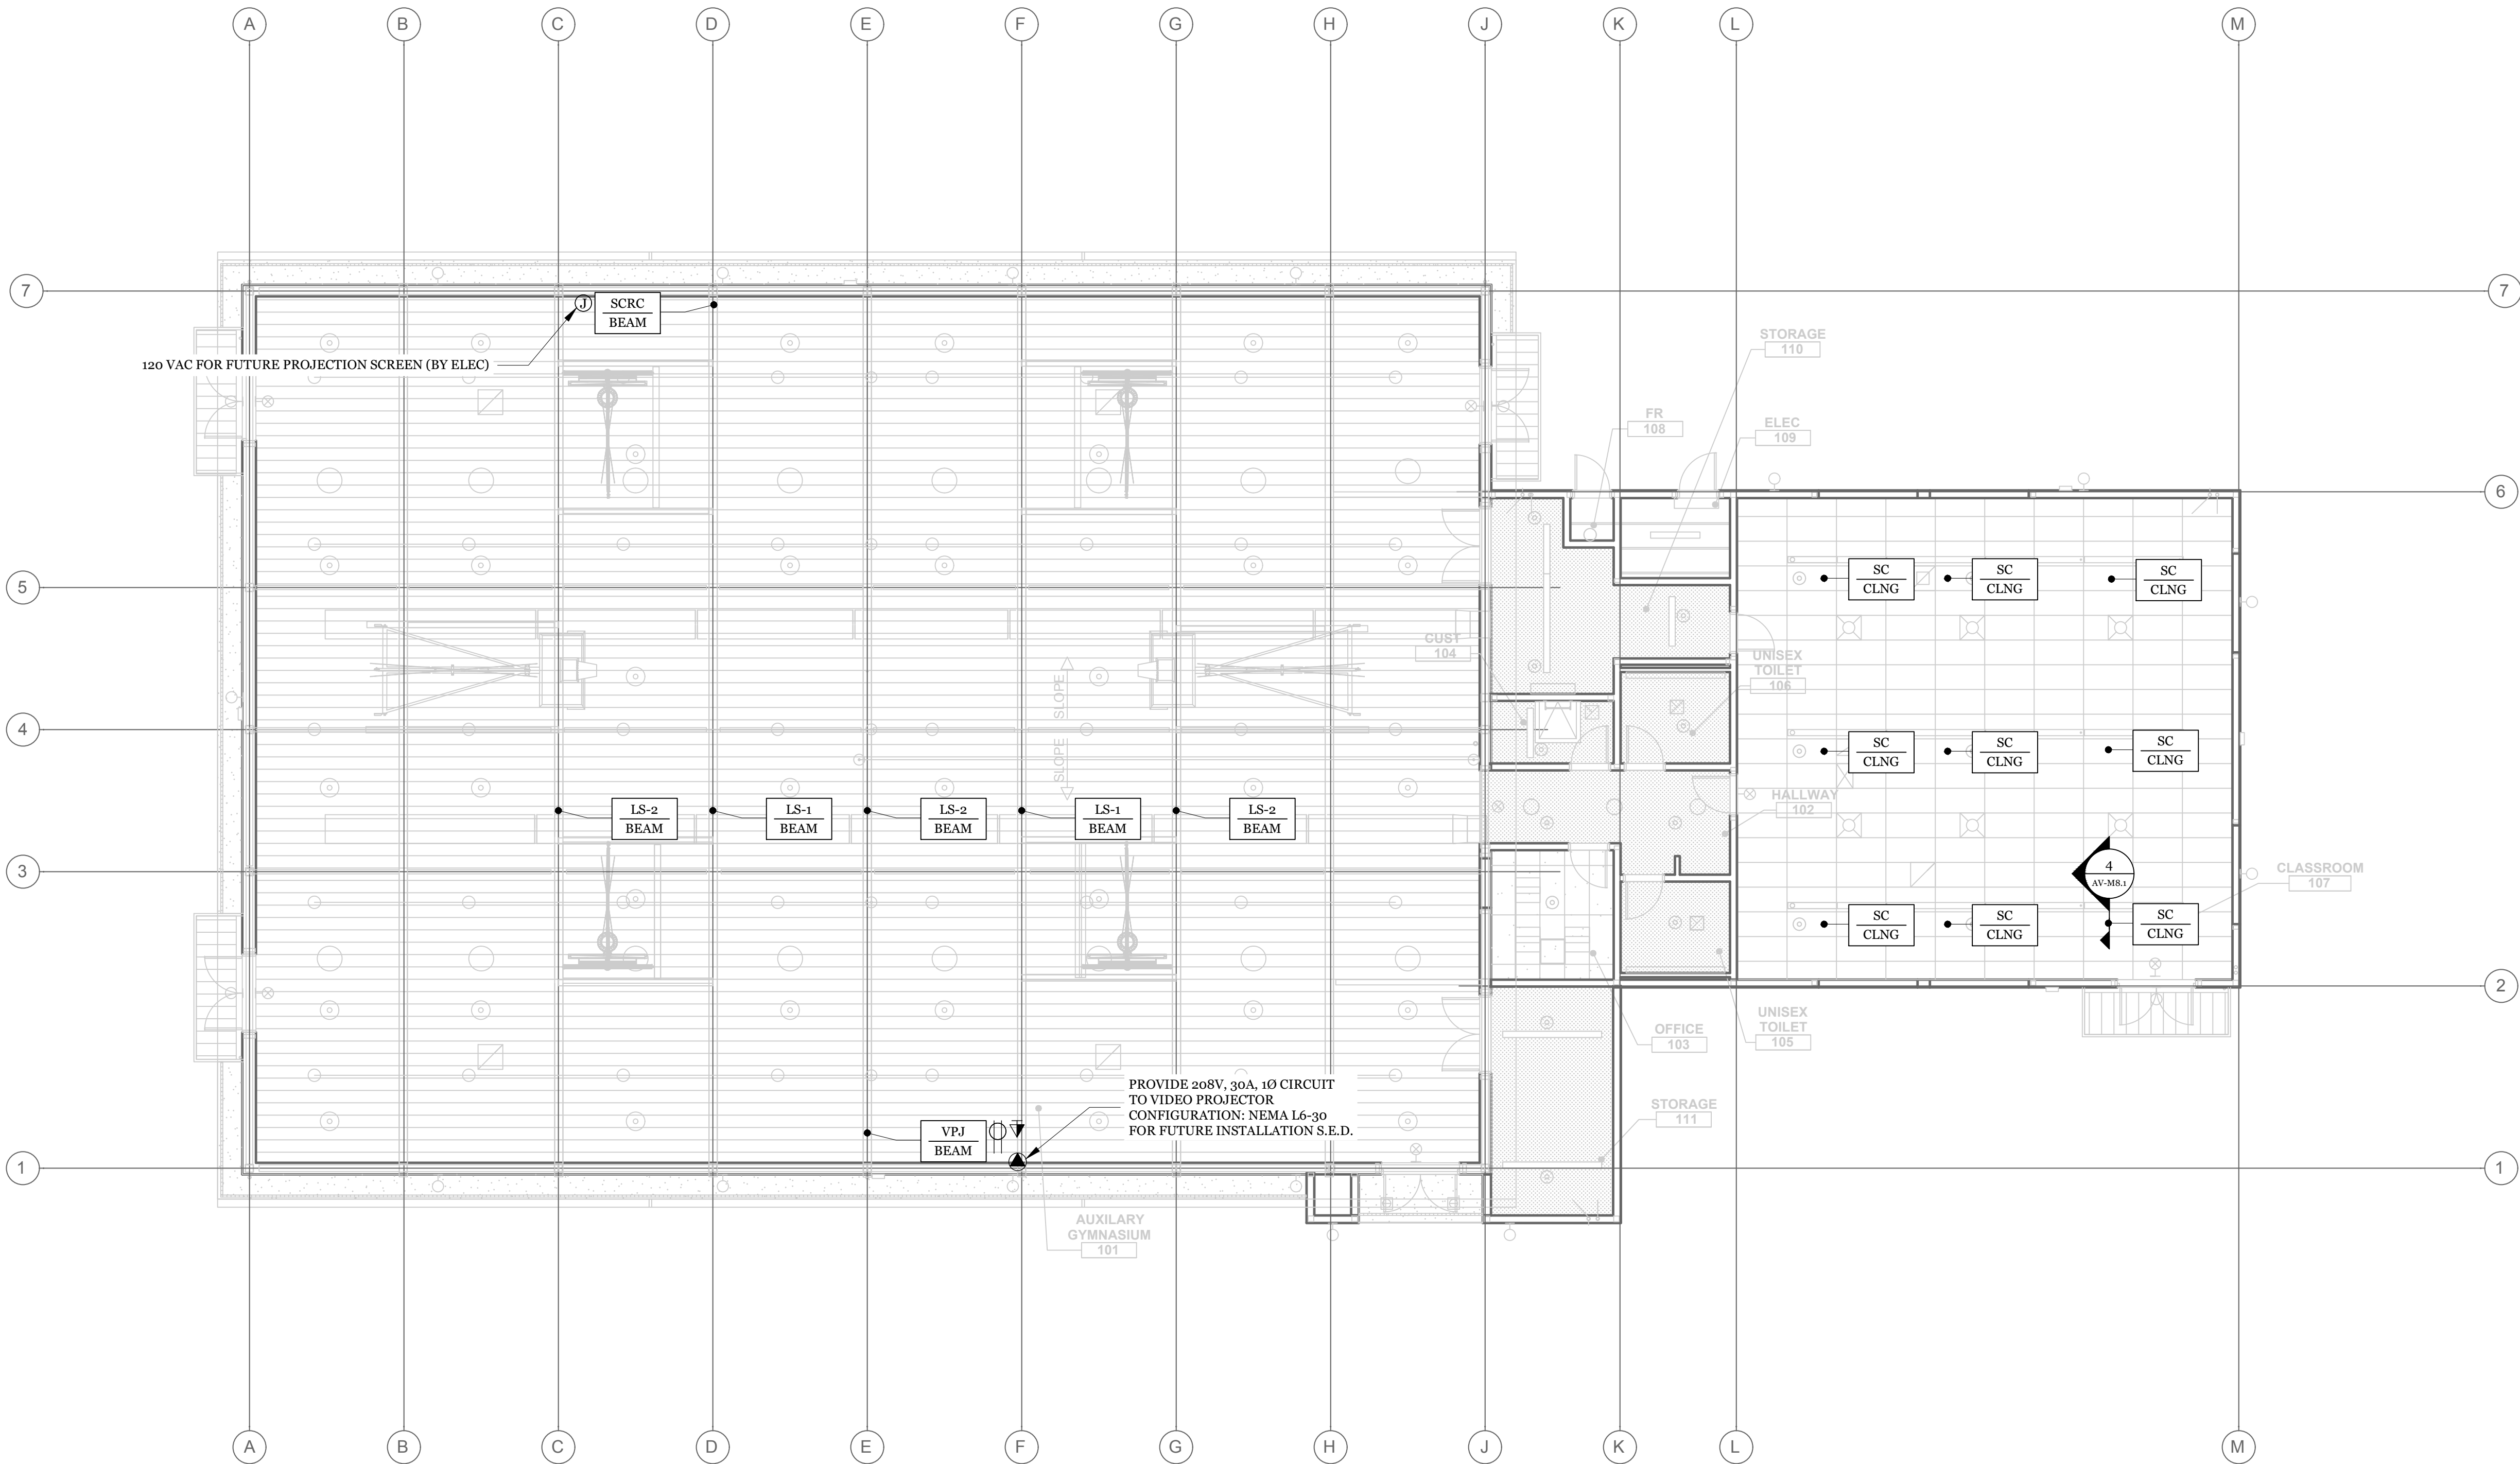
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AV DEVICE PLAN  
AT LEVEL 1

SHEET NUMBER


AV-M1.1





1 AV DEVICE RCP AT LEVEL 1  
1/8"=1'-0"

AV SYMBOL KEY

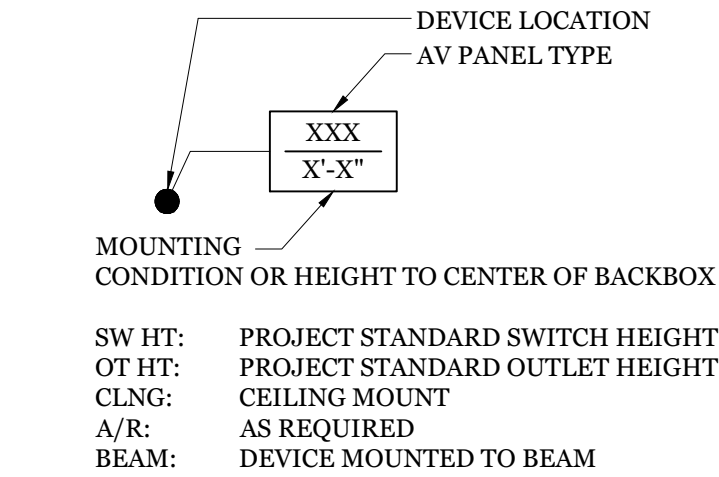

SW HT: PROJECT STANDARD SWITCH HEIGHT  
OT HT: PROJECT STANDARD OUTLET HEIGHT  
CLNG: CEILING MOUNT  
A/R: AS REQUIRED  
BEAM: DEVICE MOUNTED TO BEAM


AV-XX: CUSTOM AV PANEL & LOCATION  
FM: FM ASSISTIVE LISTENING ANTENNA  
WX: WIRELESS MICROPHONE ANTENNA

VPJ: VIDEO PROJECTOR

LS-#: LOUDSPEAKER & JACK QUANTITY / TYPE  
SC: CEILING MOUNT 70V LOUDSPEAKER

SCRC: MOTORIZED ROLL-DOWN SCREEN CONTROL  
CSP-#: REMOTE CONTROL PANEL & LOCATION

JB-#: JUNCTION BOX  
RK-#: EQUIPMENT RACK JUNCTION BOX

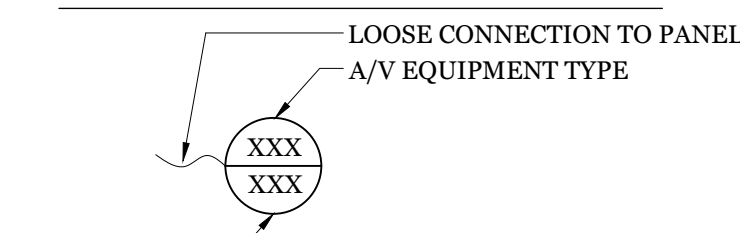

MIC: MICROPHONE

VCAM: VIDEO CAMERA  
VPJ: VIDEO PROJECTOR

LS: LOUDSPEAKER  
SUB: SUBWOOFER  
PS: PAGING SPEAKER

ELECTRICAL

- ⏏ DUPLEX OUTLET, 120V / 20A (BY ELEC)
- ⏏ QUAD OUTLET, 120V / DUAL 20A (BY ELEC)
- ⏏ SPECIALTY OUTLET (SEE DESCRIPTION) (BY ELEC)
- ⏏ JUNCTION BOX (SEE DESCRIPTION) (BY ELEC)
- ⏏ TEL/DATA OUTLET (BY ELEC)

GENERAL NOTES

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QUATTROCCHI KWOK  
ARCHITECTS  
Main:  
636 Fifth Street, Santa Rosa, CA 95404  
East Bay:  
55 Harrison Street, Suite 525,  
Oakland, CA 94607  
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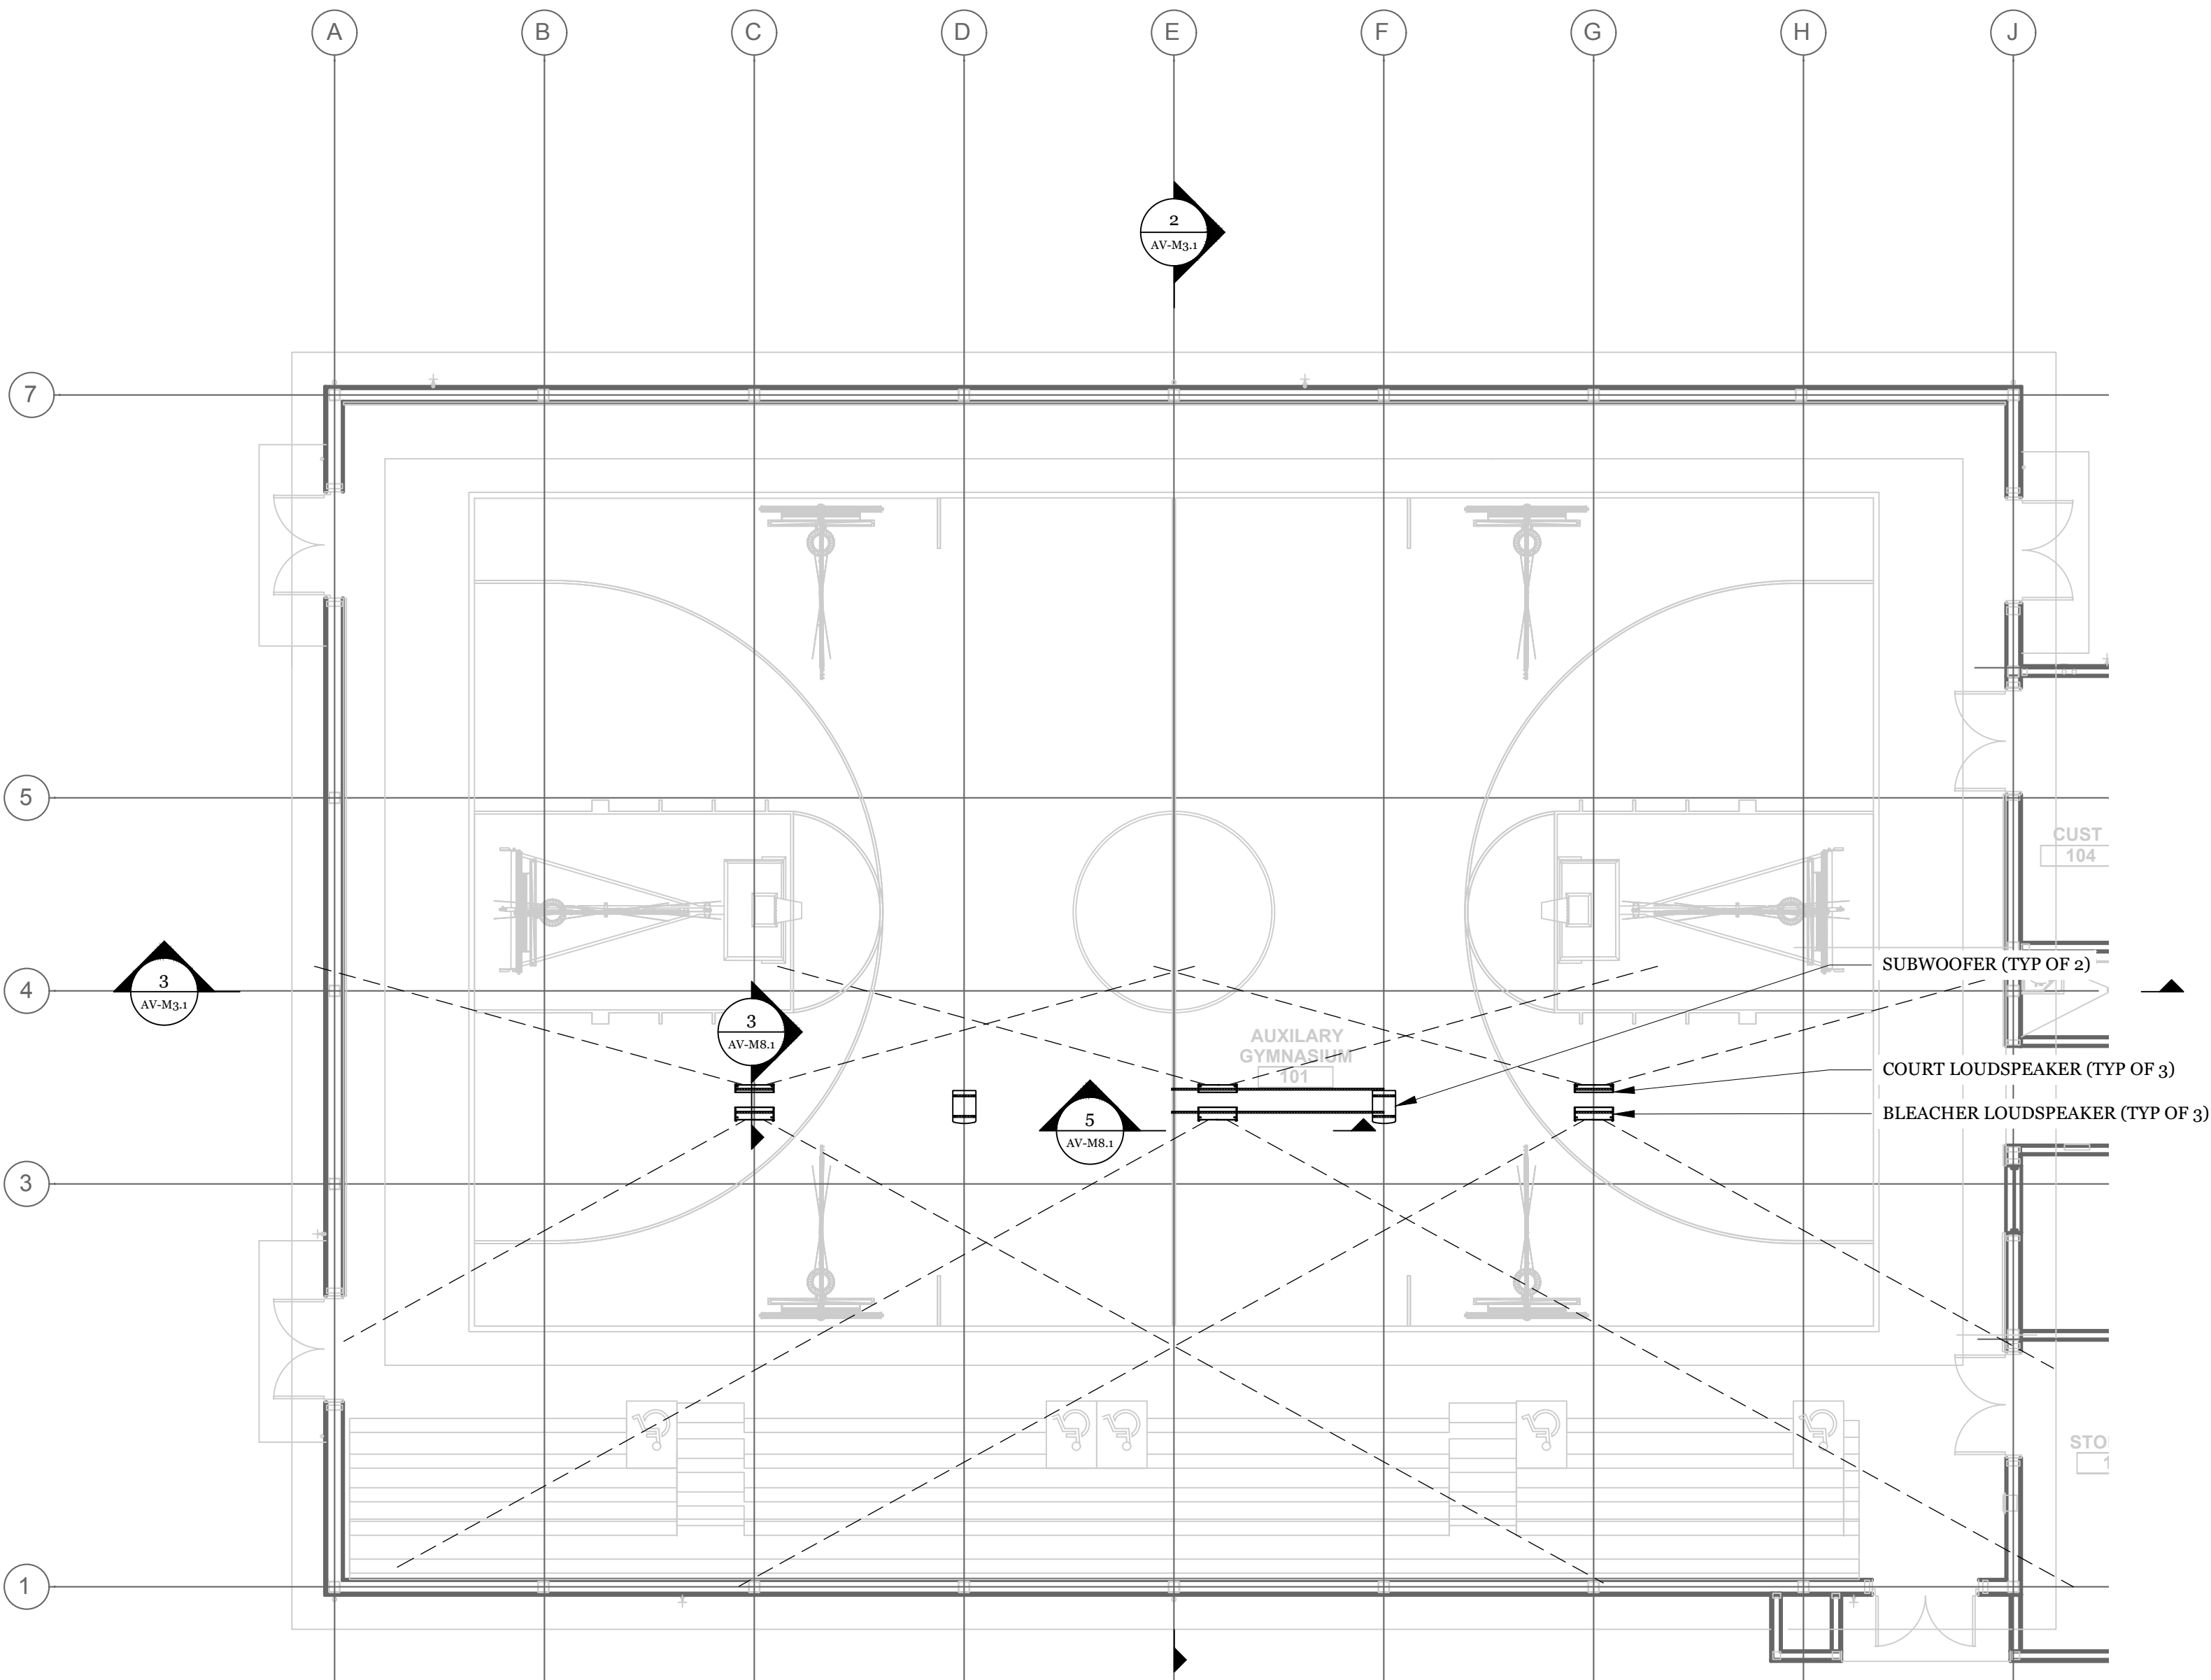
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AV DEVICE RCP  
AT LEVEL 1


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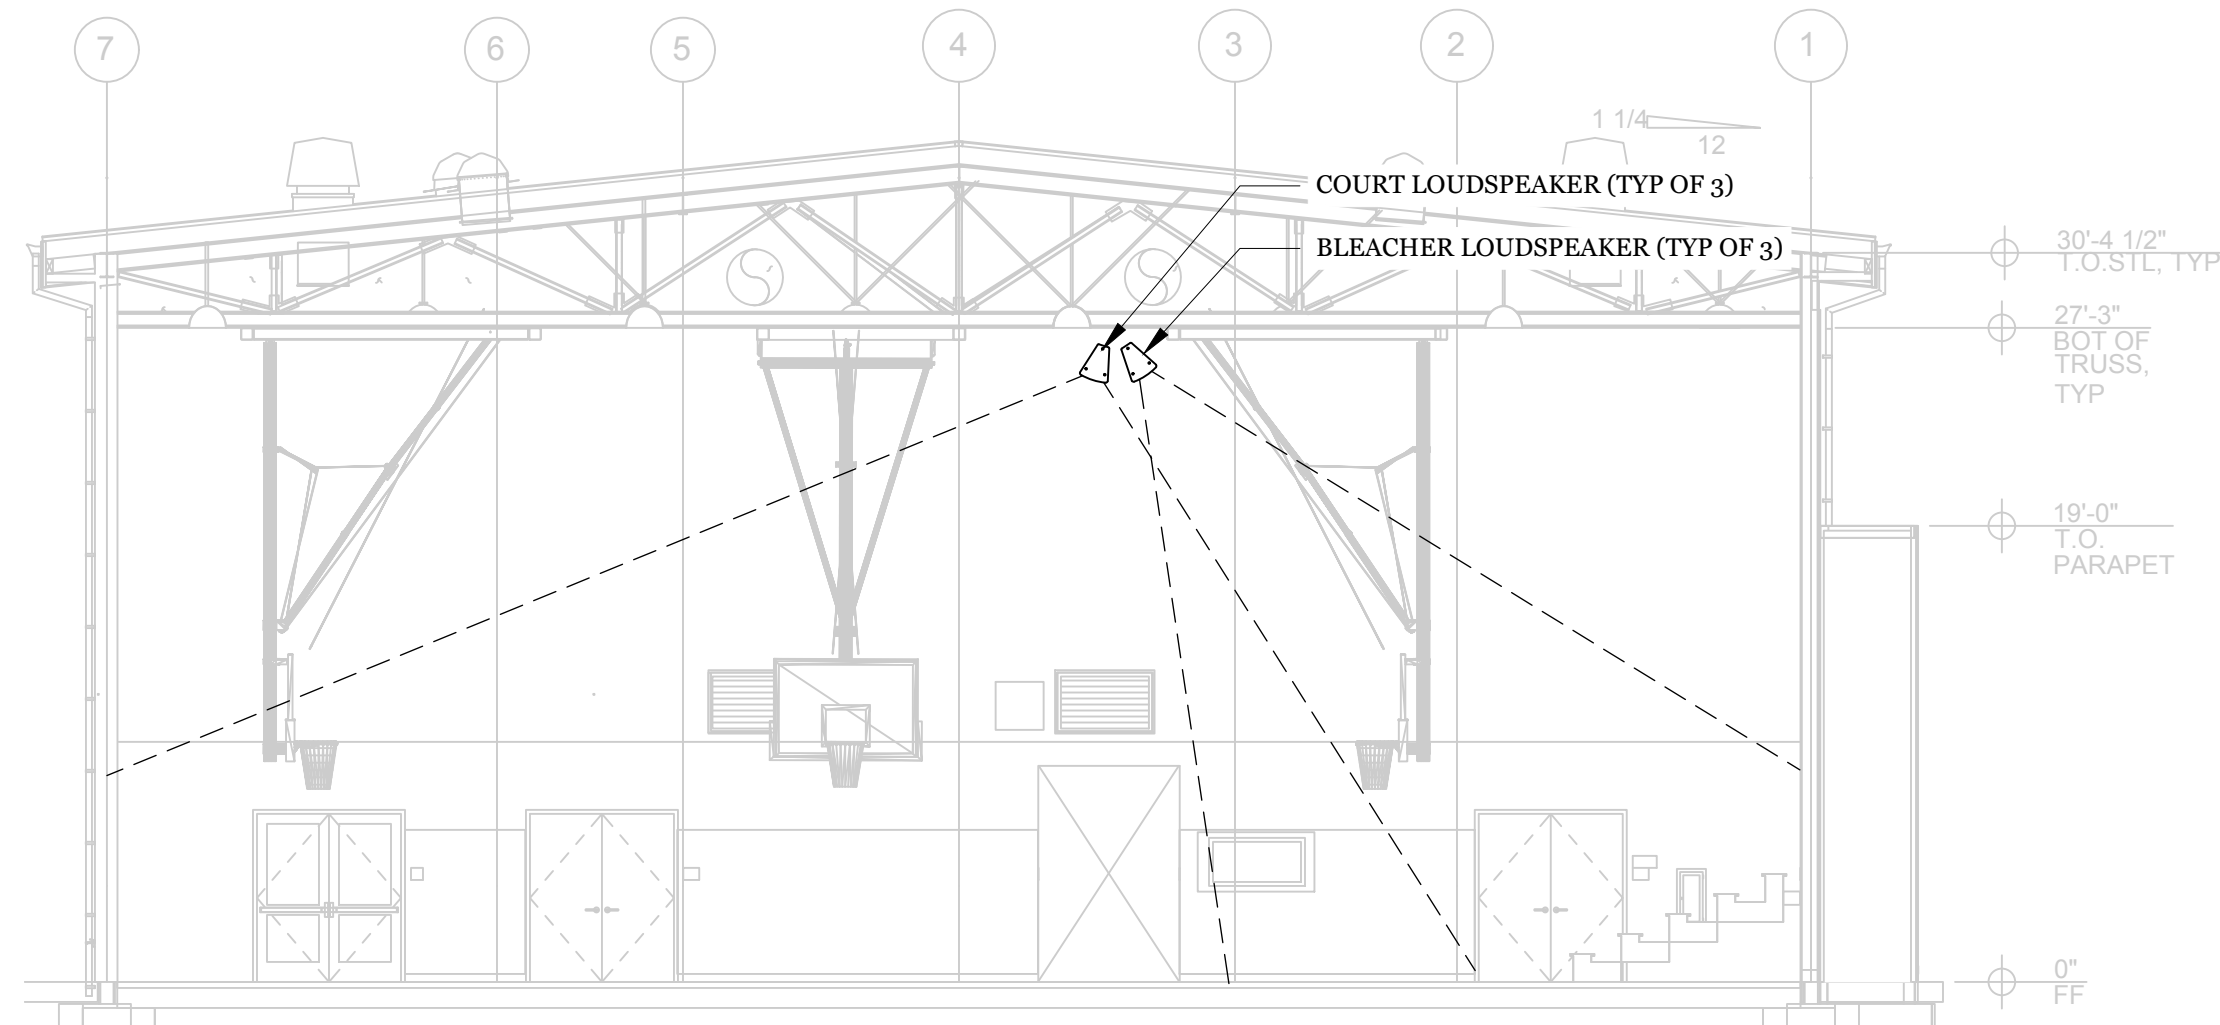




1 AUDIO PLAN AT GYM  
1/8"=1'-0"




3 AUDIO SECTION NORTH AT GYM  
1/8"=1'-0"

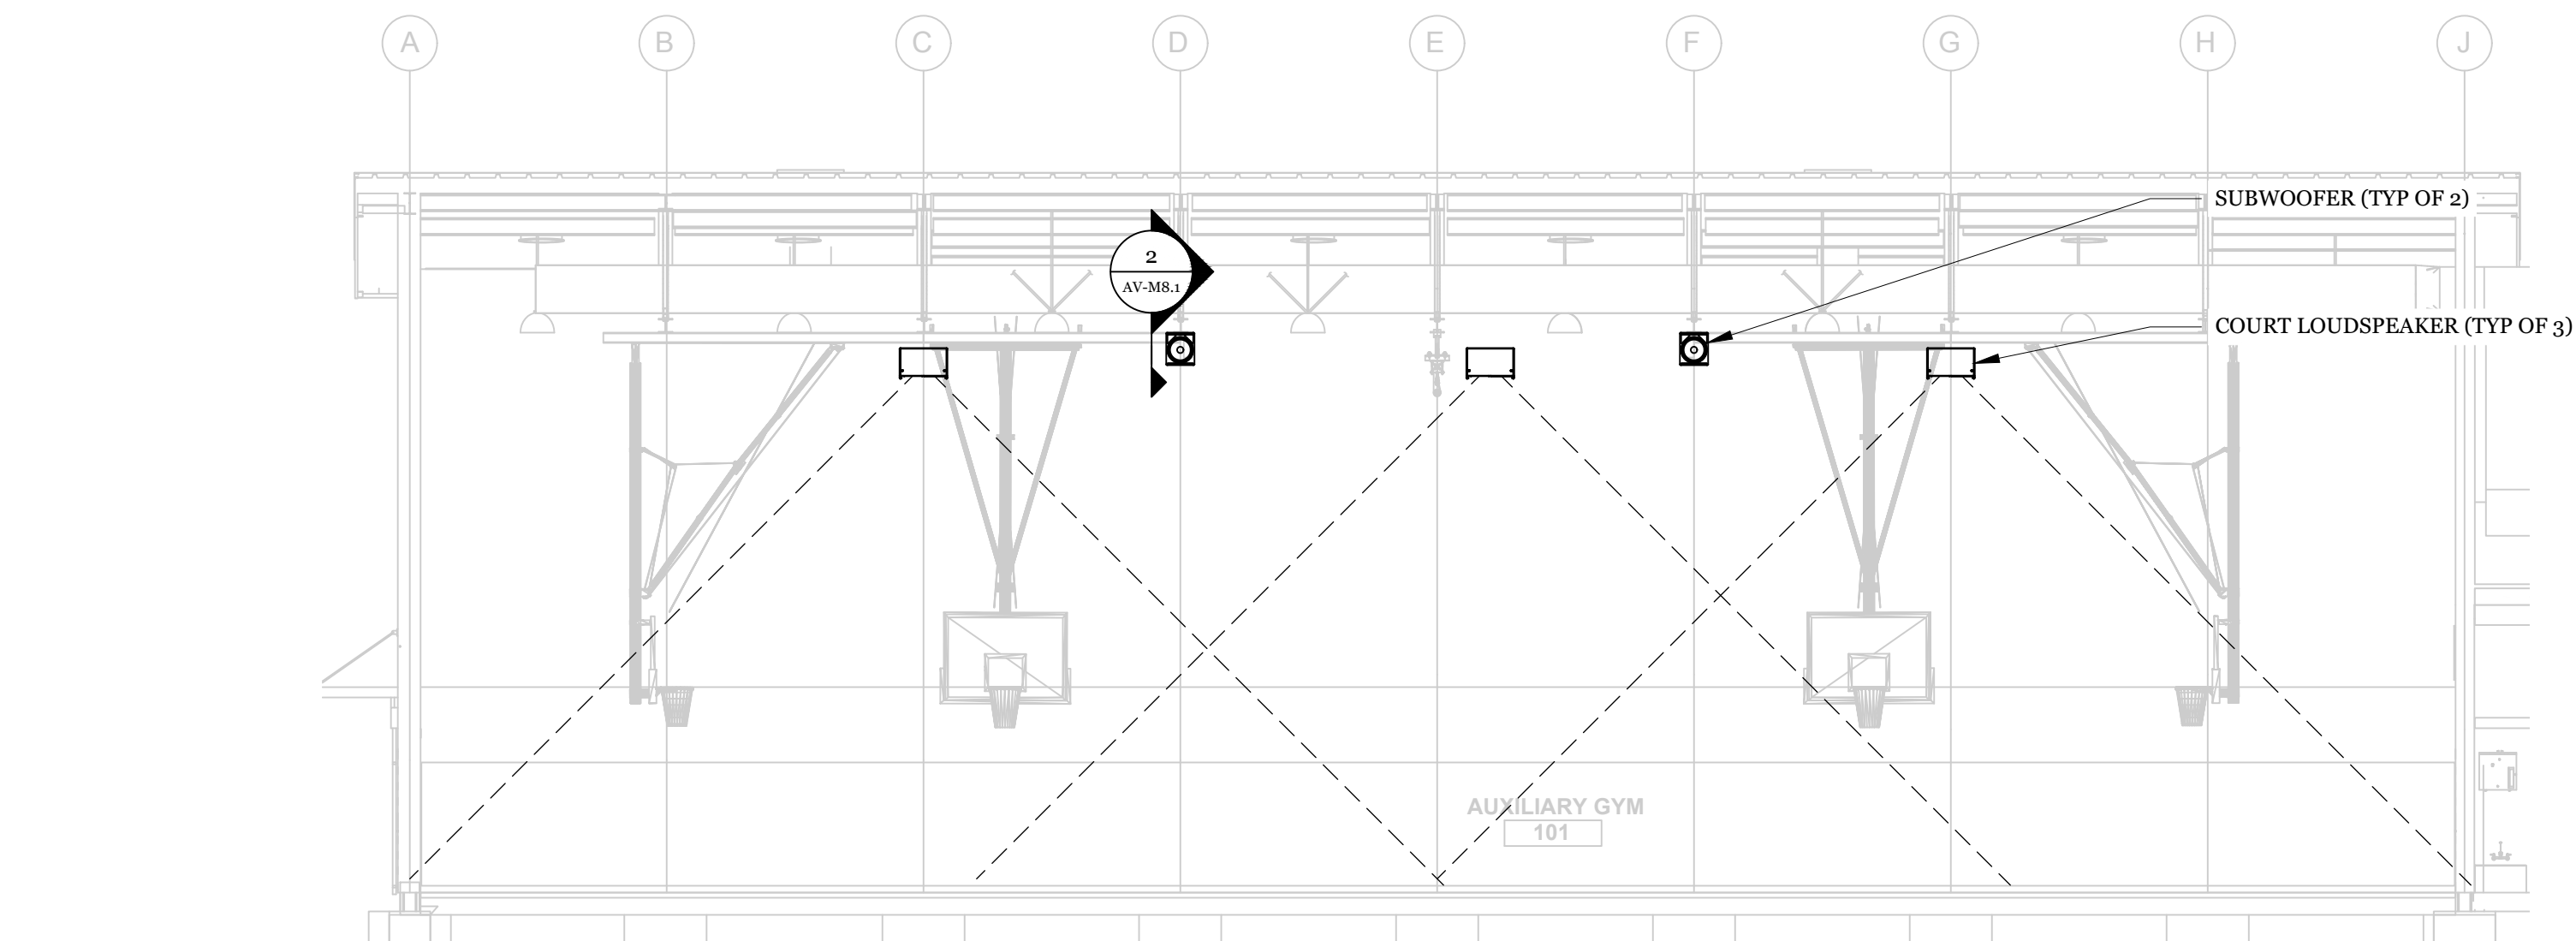

2 AUDIO SECTION EAST AT GYM  
1/8"=1'-0"

#### GENERAL NOTES

1. ALL AC OUTLETS, CONDUIT & BACKBOXES BY ELECTRICAL.
2. REQUIRED STRUCTURAL BACKING BY STRUCTURAL ENGINEER.
3. A/V CONTRACTOR TO COORDINATE WITH ELECTRICAL TO DETERMINE EXACT LOCATION OF A/V BACKBOXES.
4. ALL VISIBLE LOUDSPEAKERS & PANELS SHALL BE PROVIDED IN A COLOR AS DETERMINED BY THE ARCHITECT DURING THE SHOP DRAWING PHASE. COORDINATE EXACT MOUNTING CONDITIONS WITH ARCHITECT, STRUCTURAL ENGINEER & GENERAL CONTRACTOR.

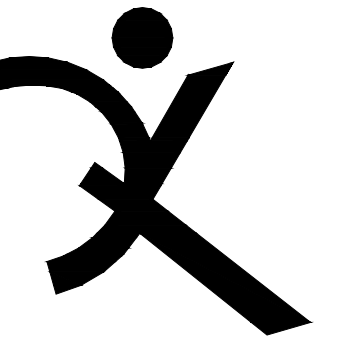

QUATTROCCHI KWOK  
ARCHITECTS

Main:  
636 Fifth Street, Santa Rosa, CA 95404  
East Bay:  
55 Harrison Street, Suite 525,  
Oakland, CA 94607  
(707) 576-0829

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1000 Marina Village Way, Suite 200, San Francisco, CA 94133  
Tel: 415-398-4000  
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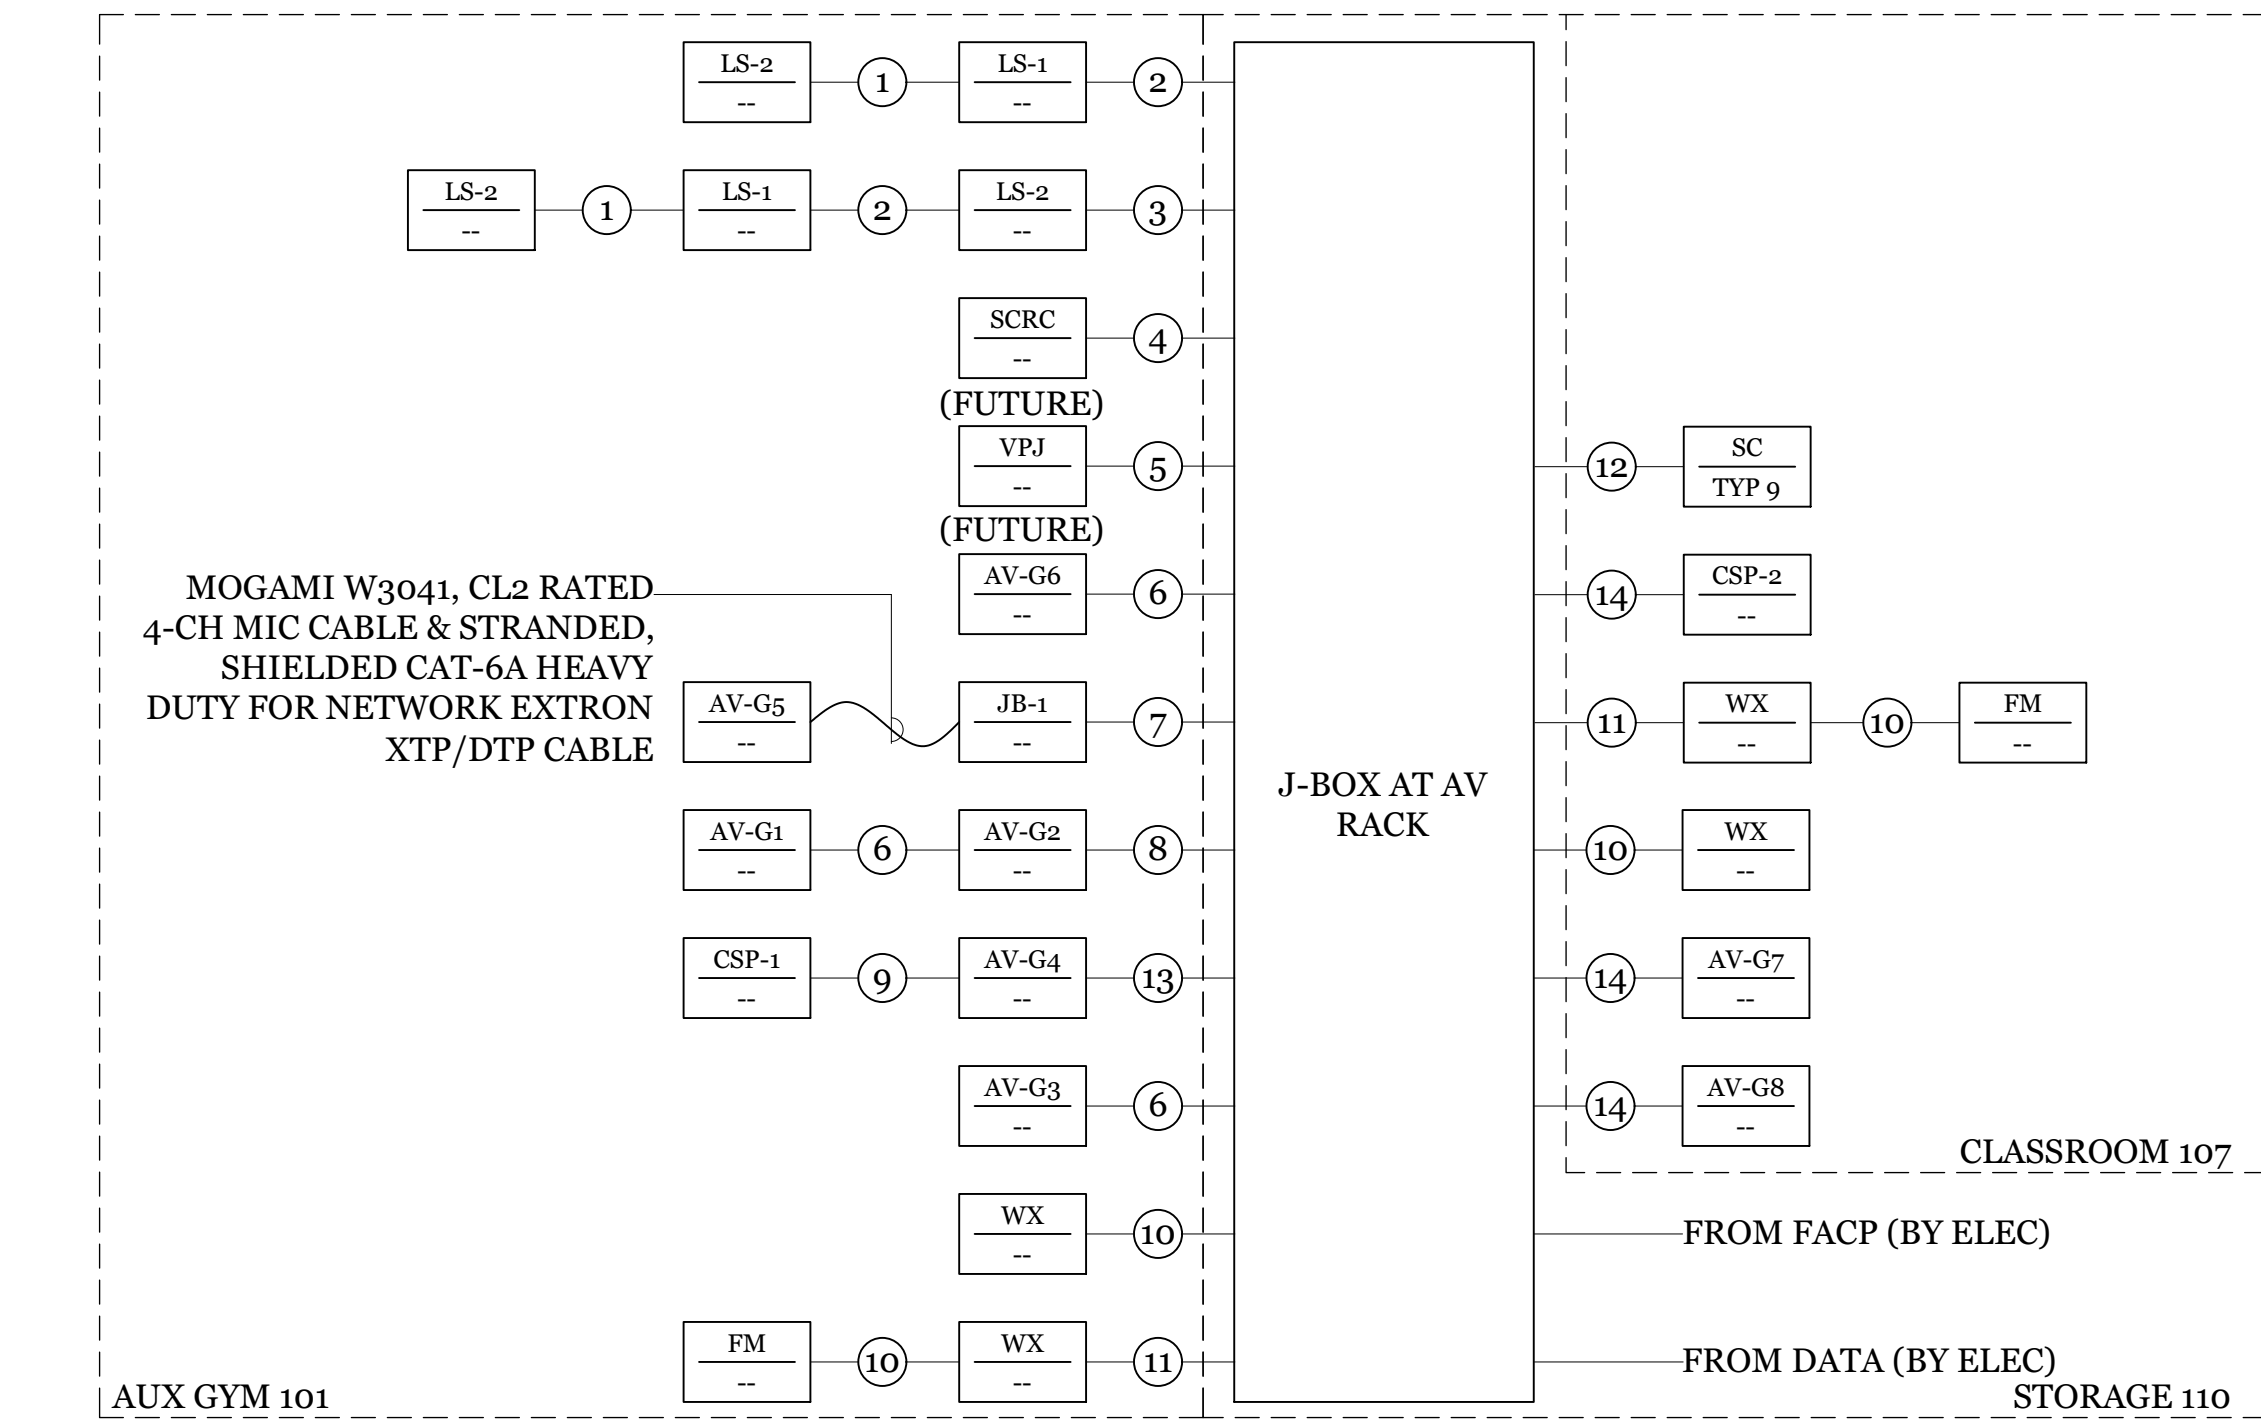
SHEET TITLE

## AUDIO PLANS & SECTIONS AT THEATRE

SHEET NUMBER

# AV-M3.1





WIRE & CONDUIT TABLE					
RUN NUMBER	WIRE QTY	WIRE TYPE	CONDUIT QTY	CONDUIT SIZE	NOTES
1	2	D2	1	1-0"	
2	3	D2	1	1-1/4"	
3	5	D2	1	1-1/2"	
4	--	C-TYPE	1	1-0"	FUTURE
5	--	C-TYPE	1	1-1/2"	FUTURE
6	1 3 1	A1 B1 C5	1 1 1	3/4" 3/4" 3/4"	
7	1 3 1	A1 B1 C5	1 1 1	3/4" 3/4" 1-0"	
8	2 6 2	A1 B1 C5	1 1 1	3/4" 3/4" 1-1/4"	
9	2	C5	1	3/4"	
10	1	C12	1	1-0"	
11	2	C12	1	1-1/4"	
12	1	D3	1	3/4"	
13	1 3 3	A1 B1 C5	1 1 1	3/4" 3/4" 1-1/4"	
14	1	C5	1	1-0"	

1 AV WIRE AND CONDUIT RISER DIAGRAM  
NTS

AV WIRE RISER NOTES & KEY



- WIRES OF SIMILAR WIRETYPE CLASSIFICATION (A, B, C, D or E) MAY BE COMBINED INTO A SINGLE CONDUIT.
- MINIMUM CONDUIT SIZE IS 3/4".
- CONDUIT SIZE TO BE VERIFIED IN WRITING BY AV CONTRACTOR WITHIN 30 DAYS OF CONTRACT AWARD.
- ALL CONDUIT & BACKBOXES BY ELECTRICAL.
- FOLLOW CONDUIT SEPARATION TABLES & CONDUIT RUN LENGTH TABLES AS INDICATED ON KEY SHEET & IN SPECIFICATIONS.
- INCREASE CONDUIT TO NEXT SIZE UP FOR RUNS GREATER THAN 50'-0" WITHOUT A JUNCTION BOX.

**QUATTROCCHI KWOK ARCHITECTS**

Main:  
636 Fifth Street, Santa Rosa, CA 95404  
East Bay:  
55 Harrison Street, Suite 525,  
Oakland, CA 94607  
(707) 576-0829

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Planning and Design of Theatres | Production Systems | AV  
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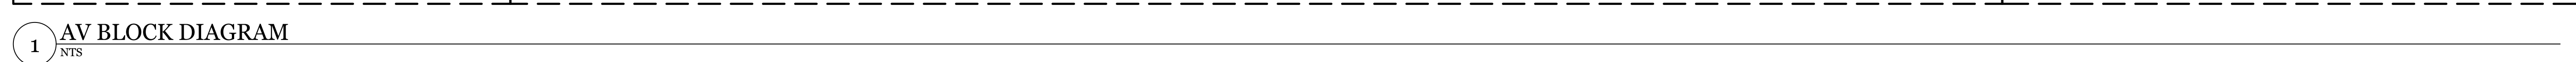
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**WIRE & CONDUIT RISER DIAGRAMS**


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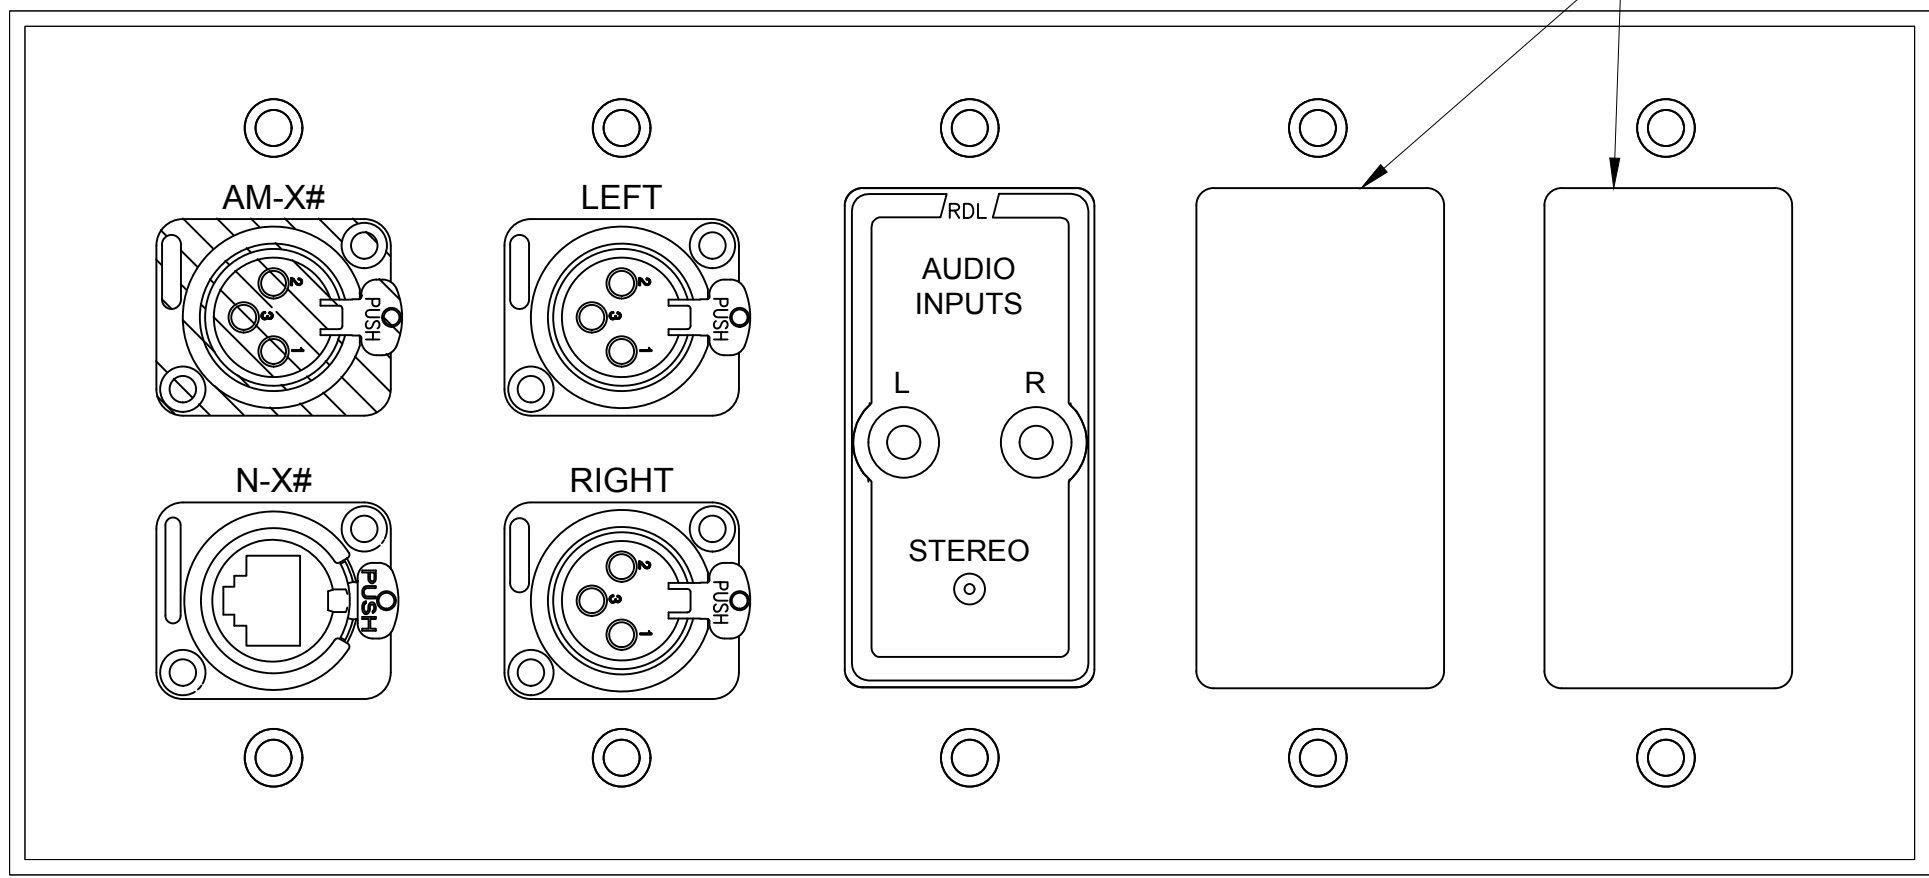










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2 AV PANEL AV-G2,5  
12"=1'-0" THIS DEVICE WEIGHS LESS THAN 20 LBS.

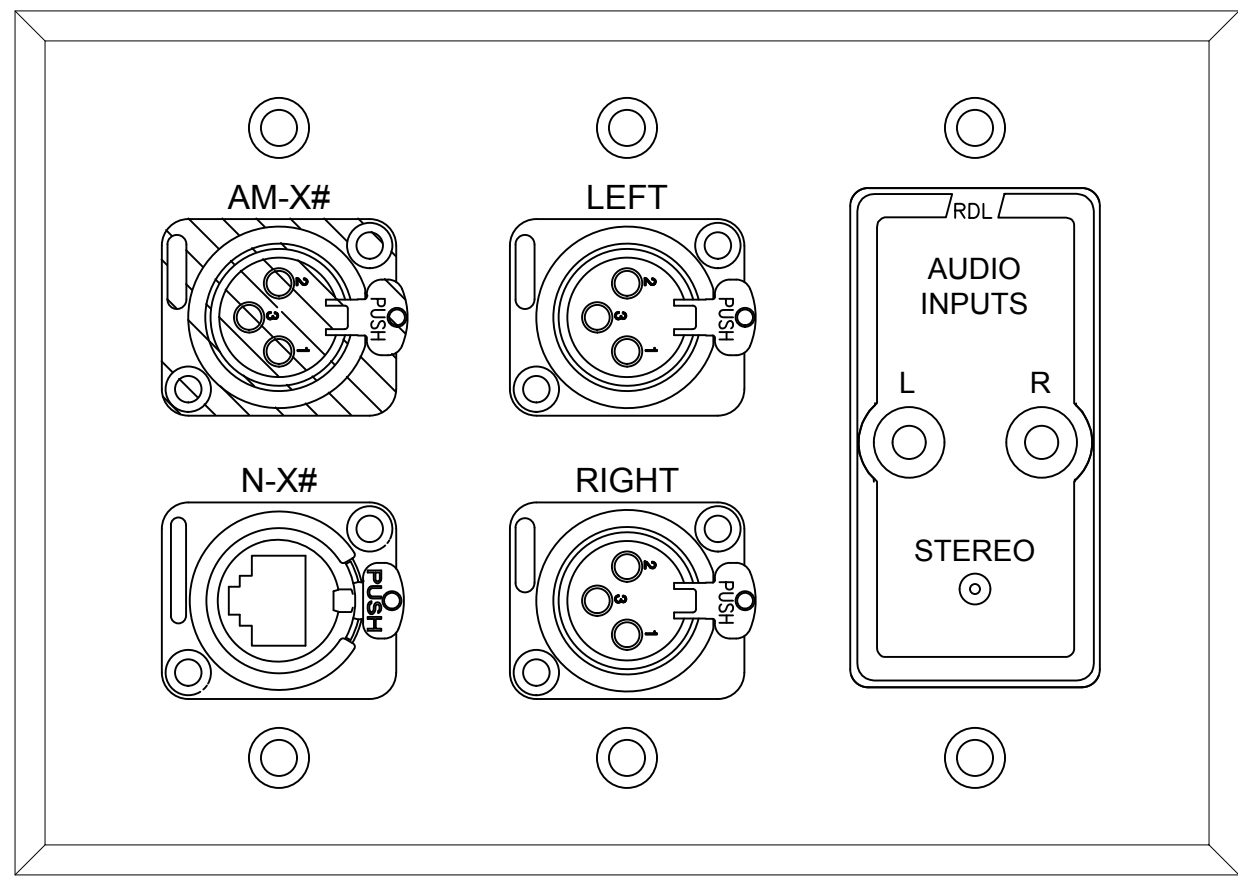


3 AV PANEL AV-G7,8  
12"=1'-0" THIS DEVICE WEIGHS LESS THAN 20 LBS.

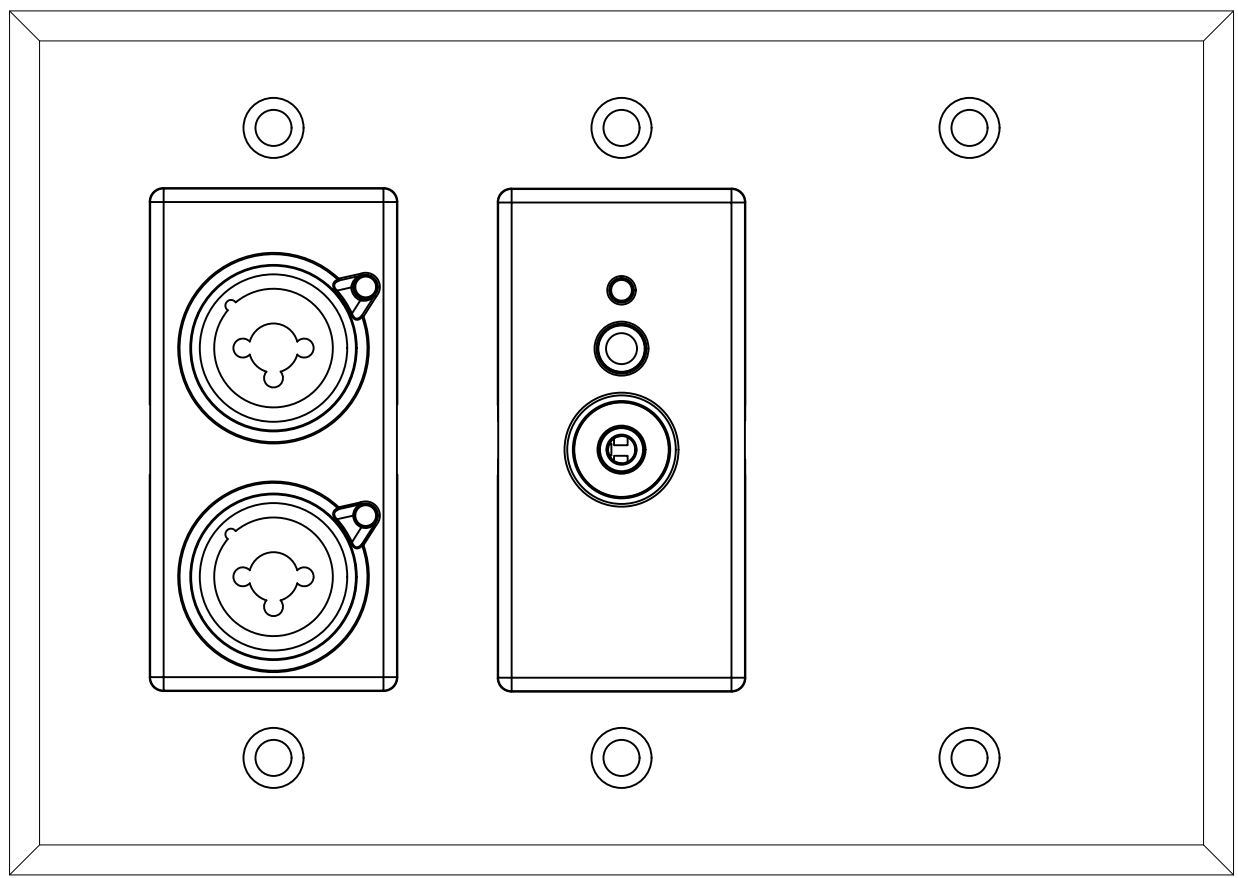


4 AV PANEL FM  
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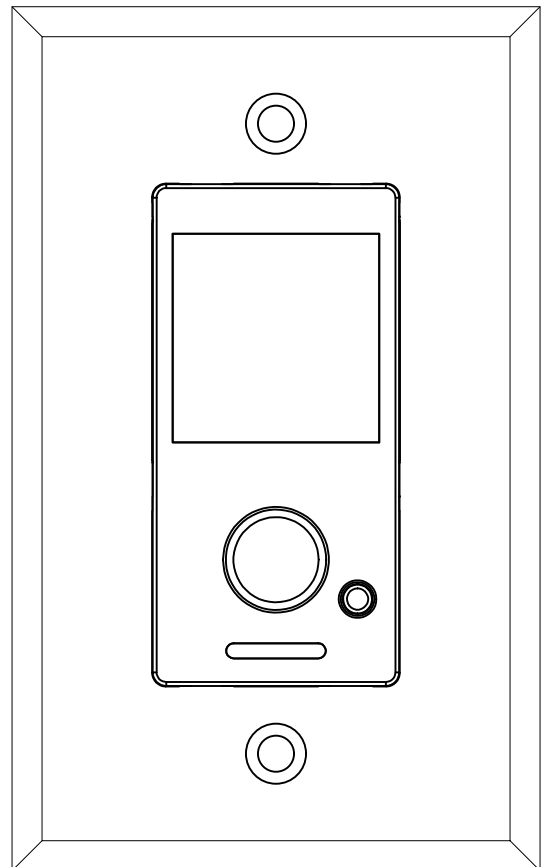
5 AV PANEL WX  
12"=1'-0" THIS DEVICE WEIGHS LESS THAN 20 LBS.

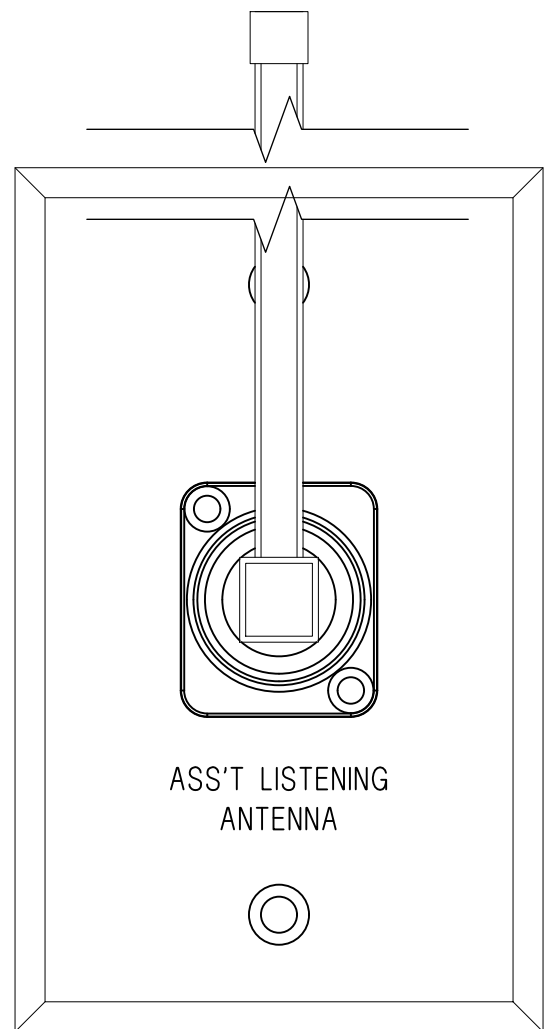


6 AV PANEL LS-1  
12"=1'-0" THIS DEVICE WEIGHS LESS THAN 20 LBS.

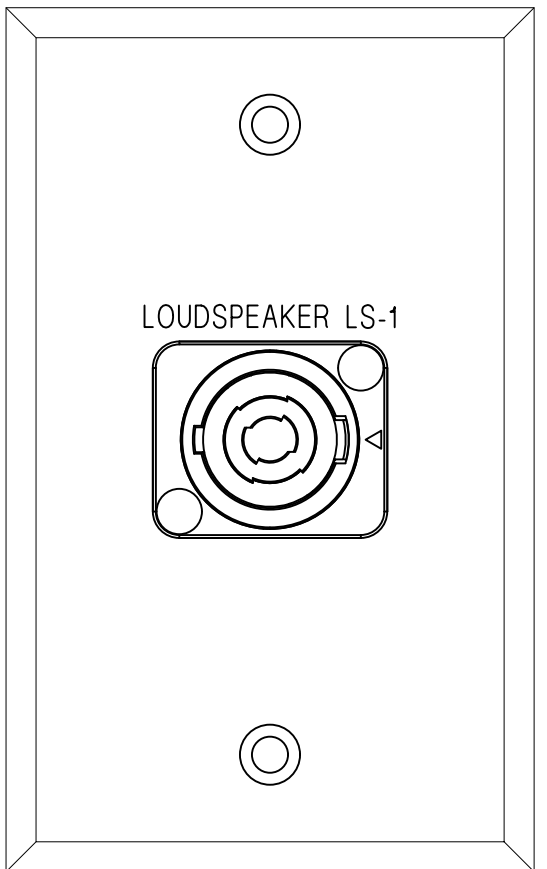


7 AV PANEL LS-2  
12"=1'-0" THIS DEVICE WEIGHS LESS THAN 20 LBS.

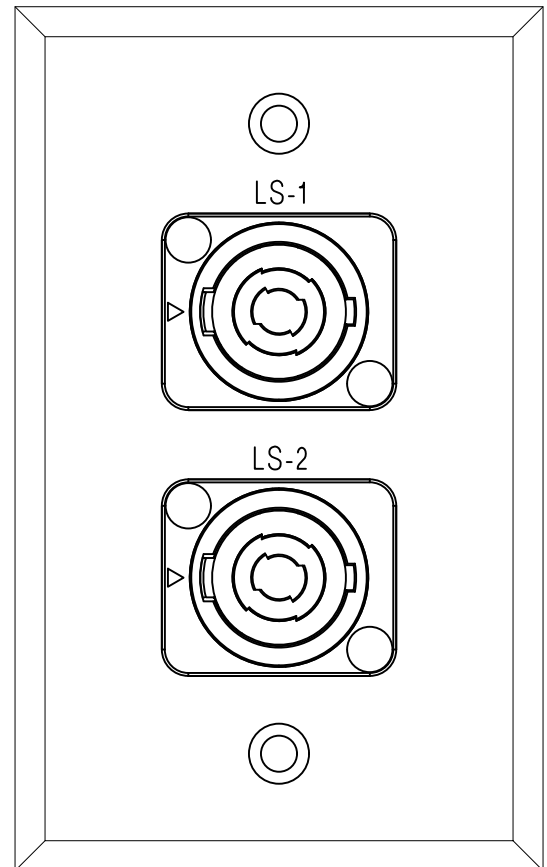

8 AV PANEL CSP-2  
12"=1'-0" THIS DEVICE WEIGHS LESS THAN 20 LBS.

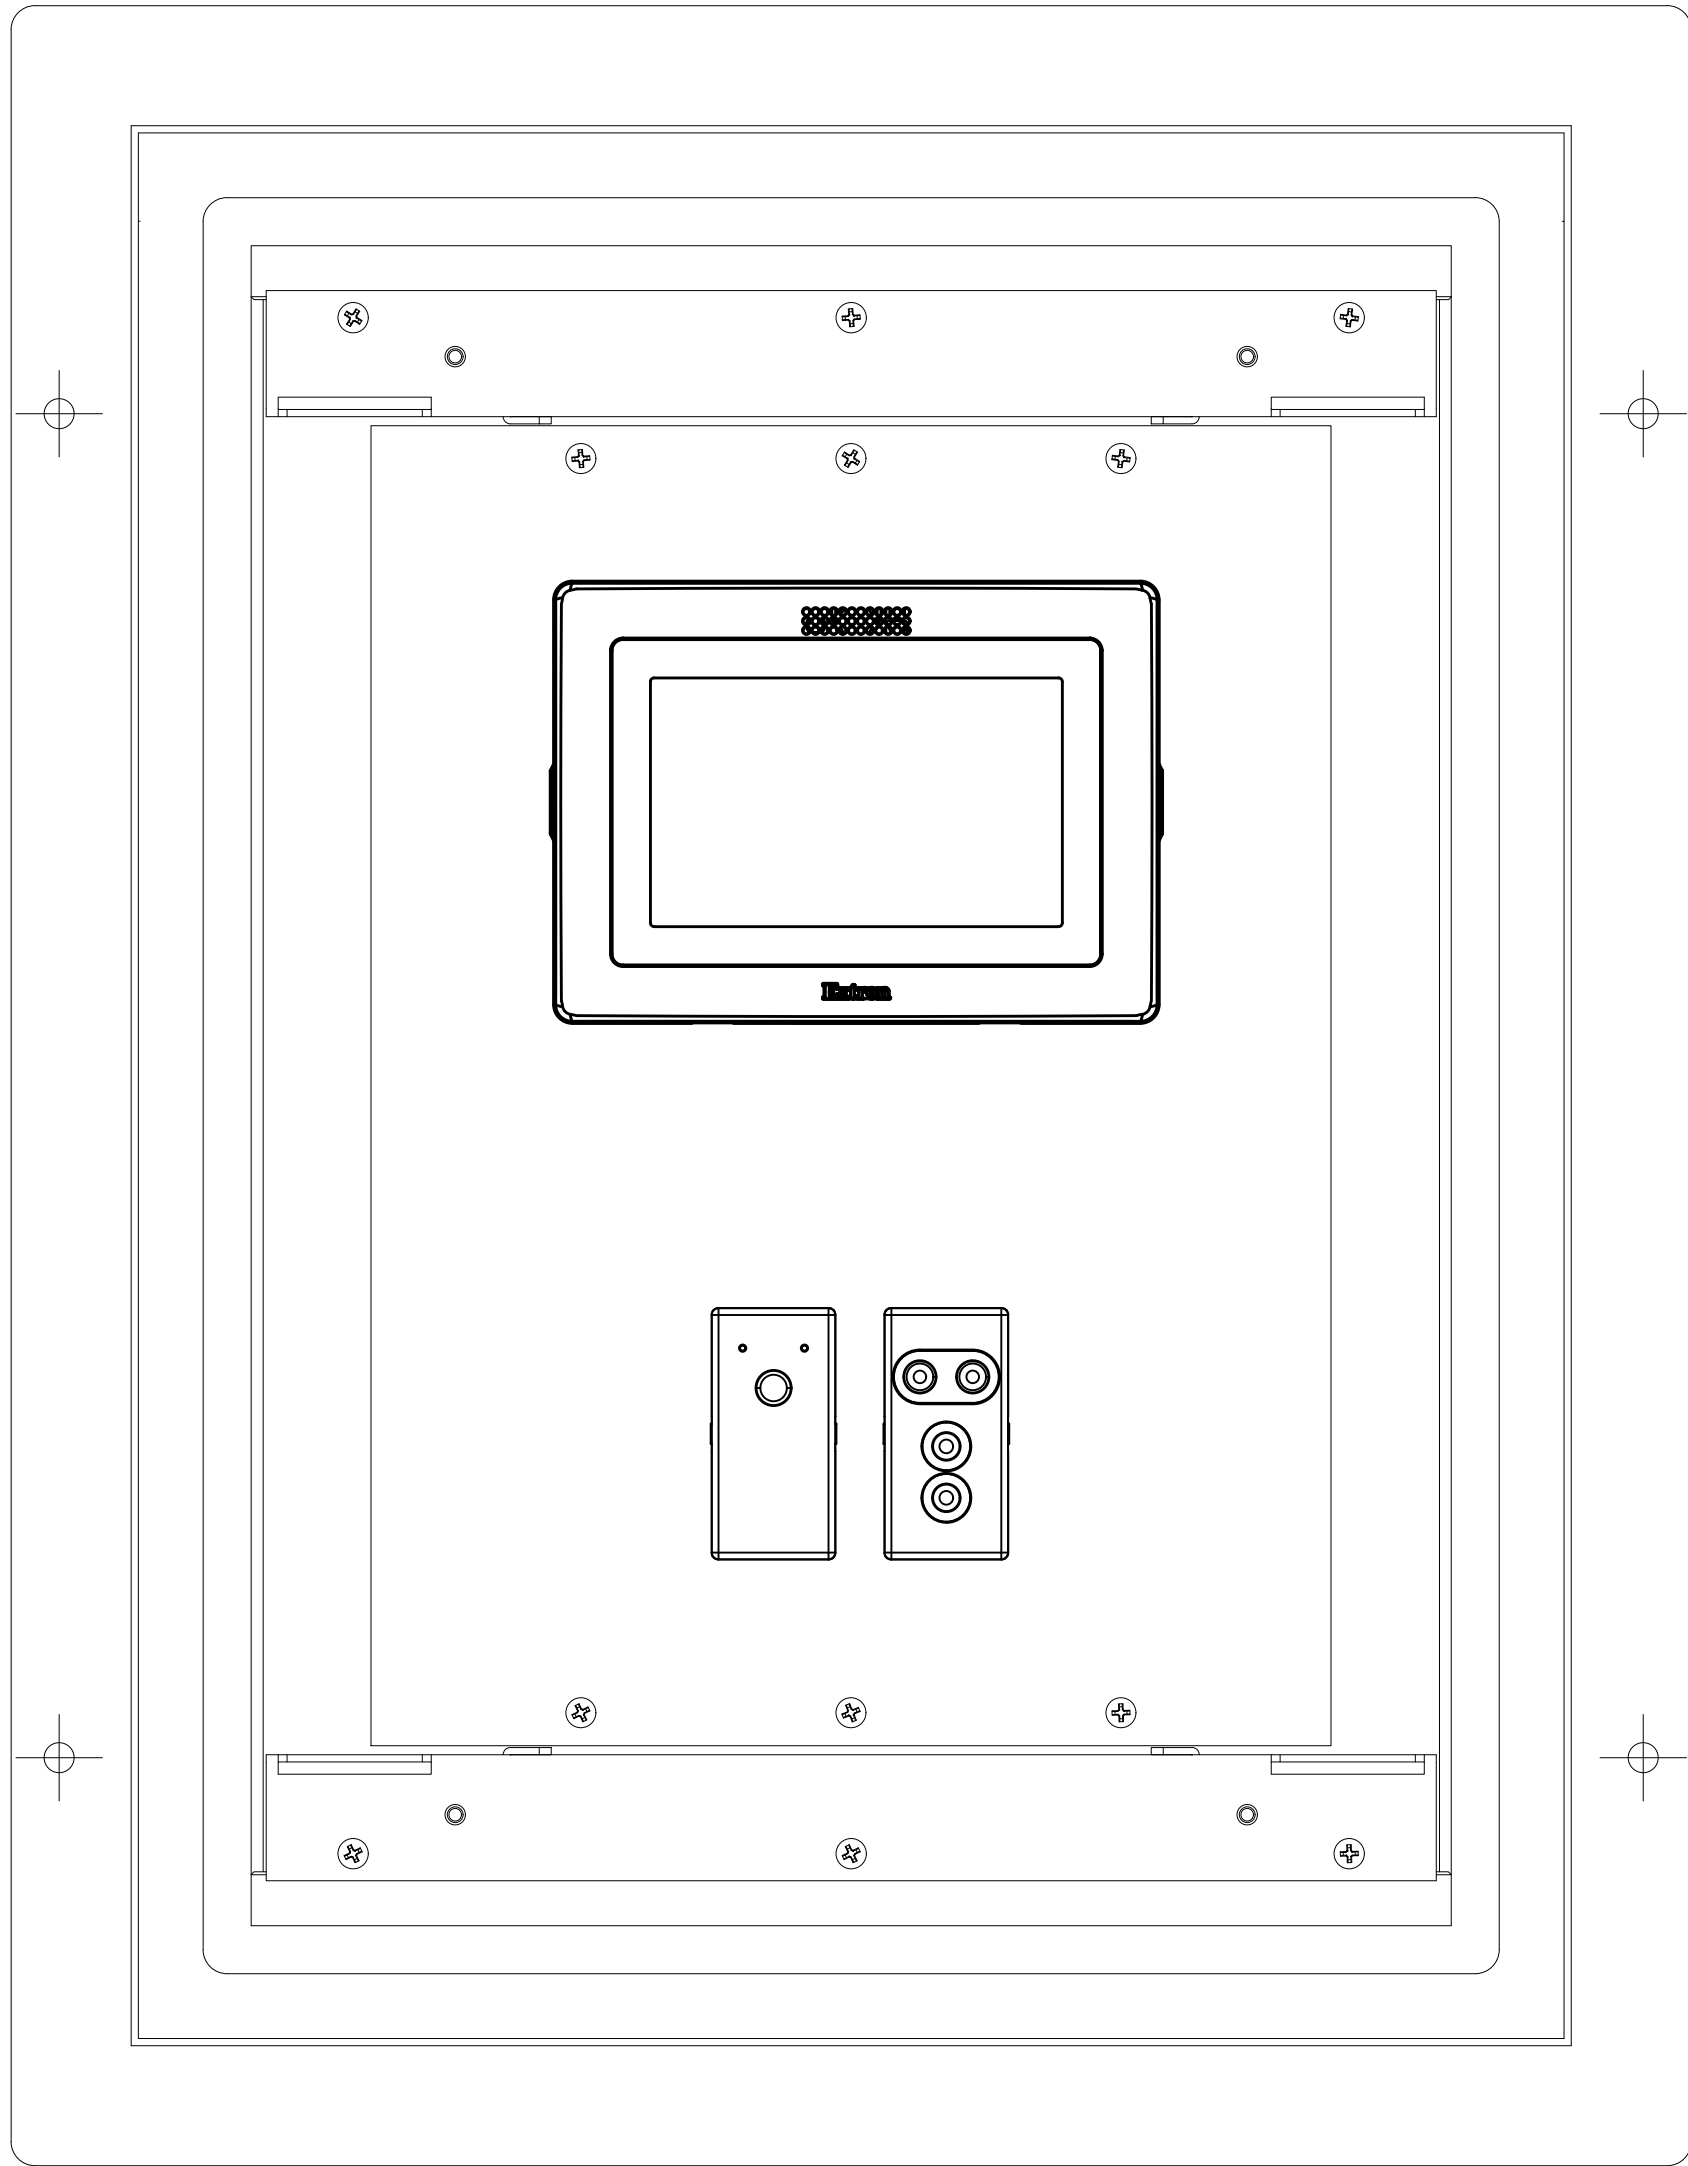

9 AV PANEL CSP-1  
12"=1'-0"

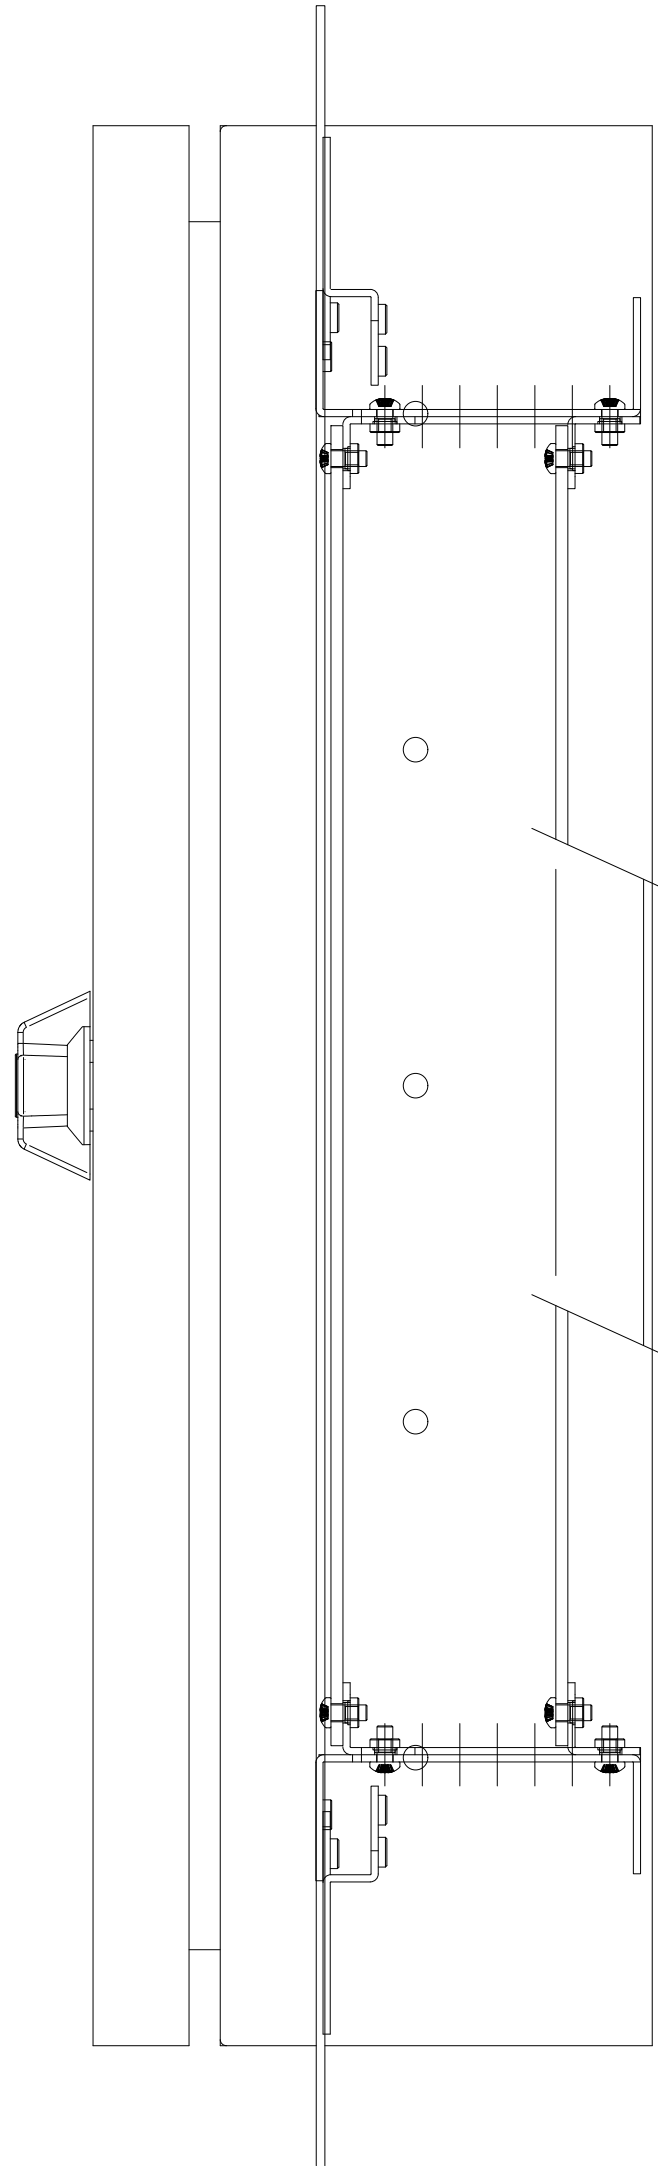

THIS DEVICE WEIGHS LESS THAN 20 LBS.

#### GENERAL NOTES

- ALL AC OUTLETS, CONDUIT & BACKBOXES BY ELECTRICAL.
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- A/V CONTRACTOR TO COORDINATE WITH ELECTRICAL TO DETERMINE EXACT LOCATION OF A/V BACKBOXES.
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ARCHITECTS  
Main:  
636 Fifth Street, Santa Rosa, CA 95404  
East Bay:  
55 Harrison Street, Suite 525,  
Oakland, CA 94607  
(707) 576-0829

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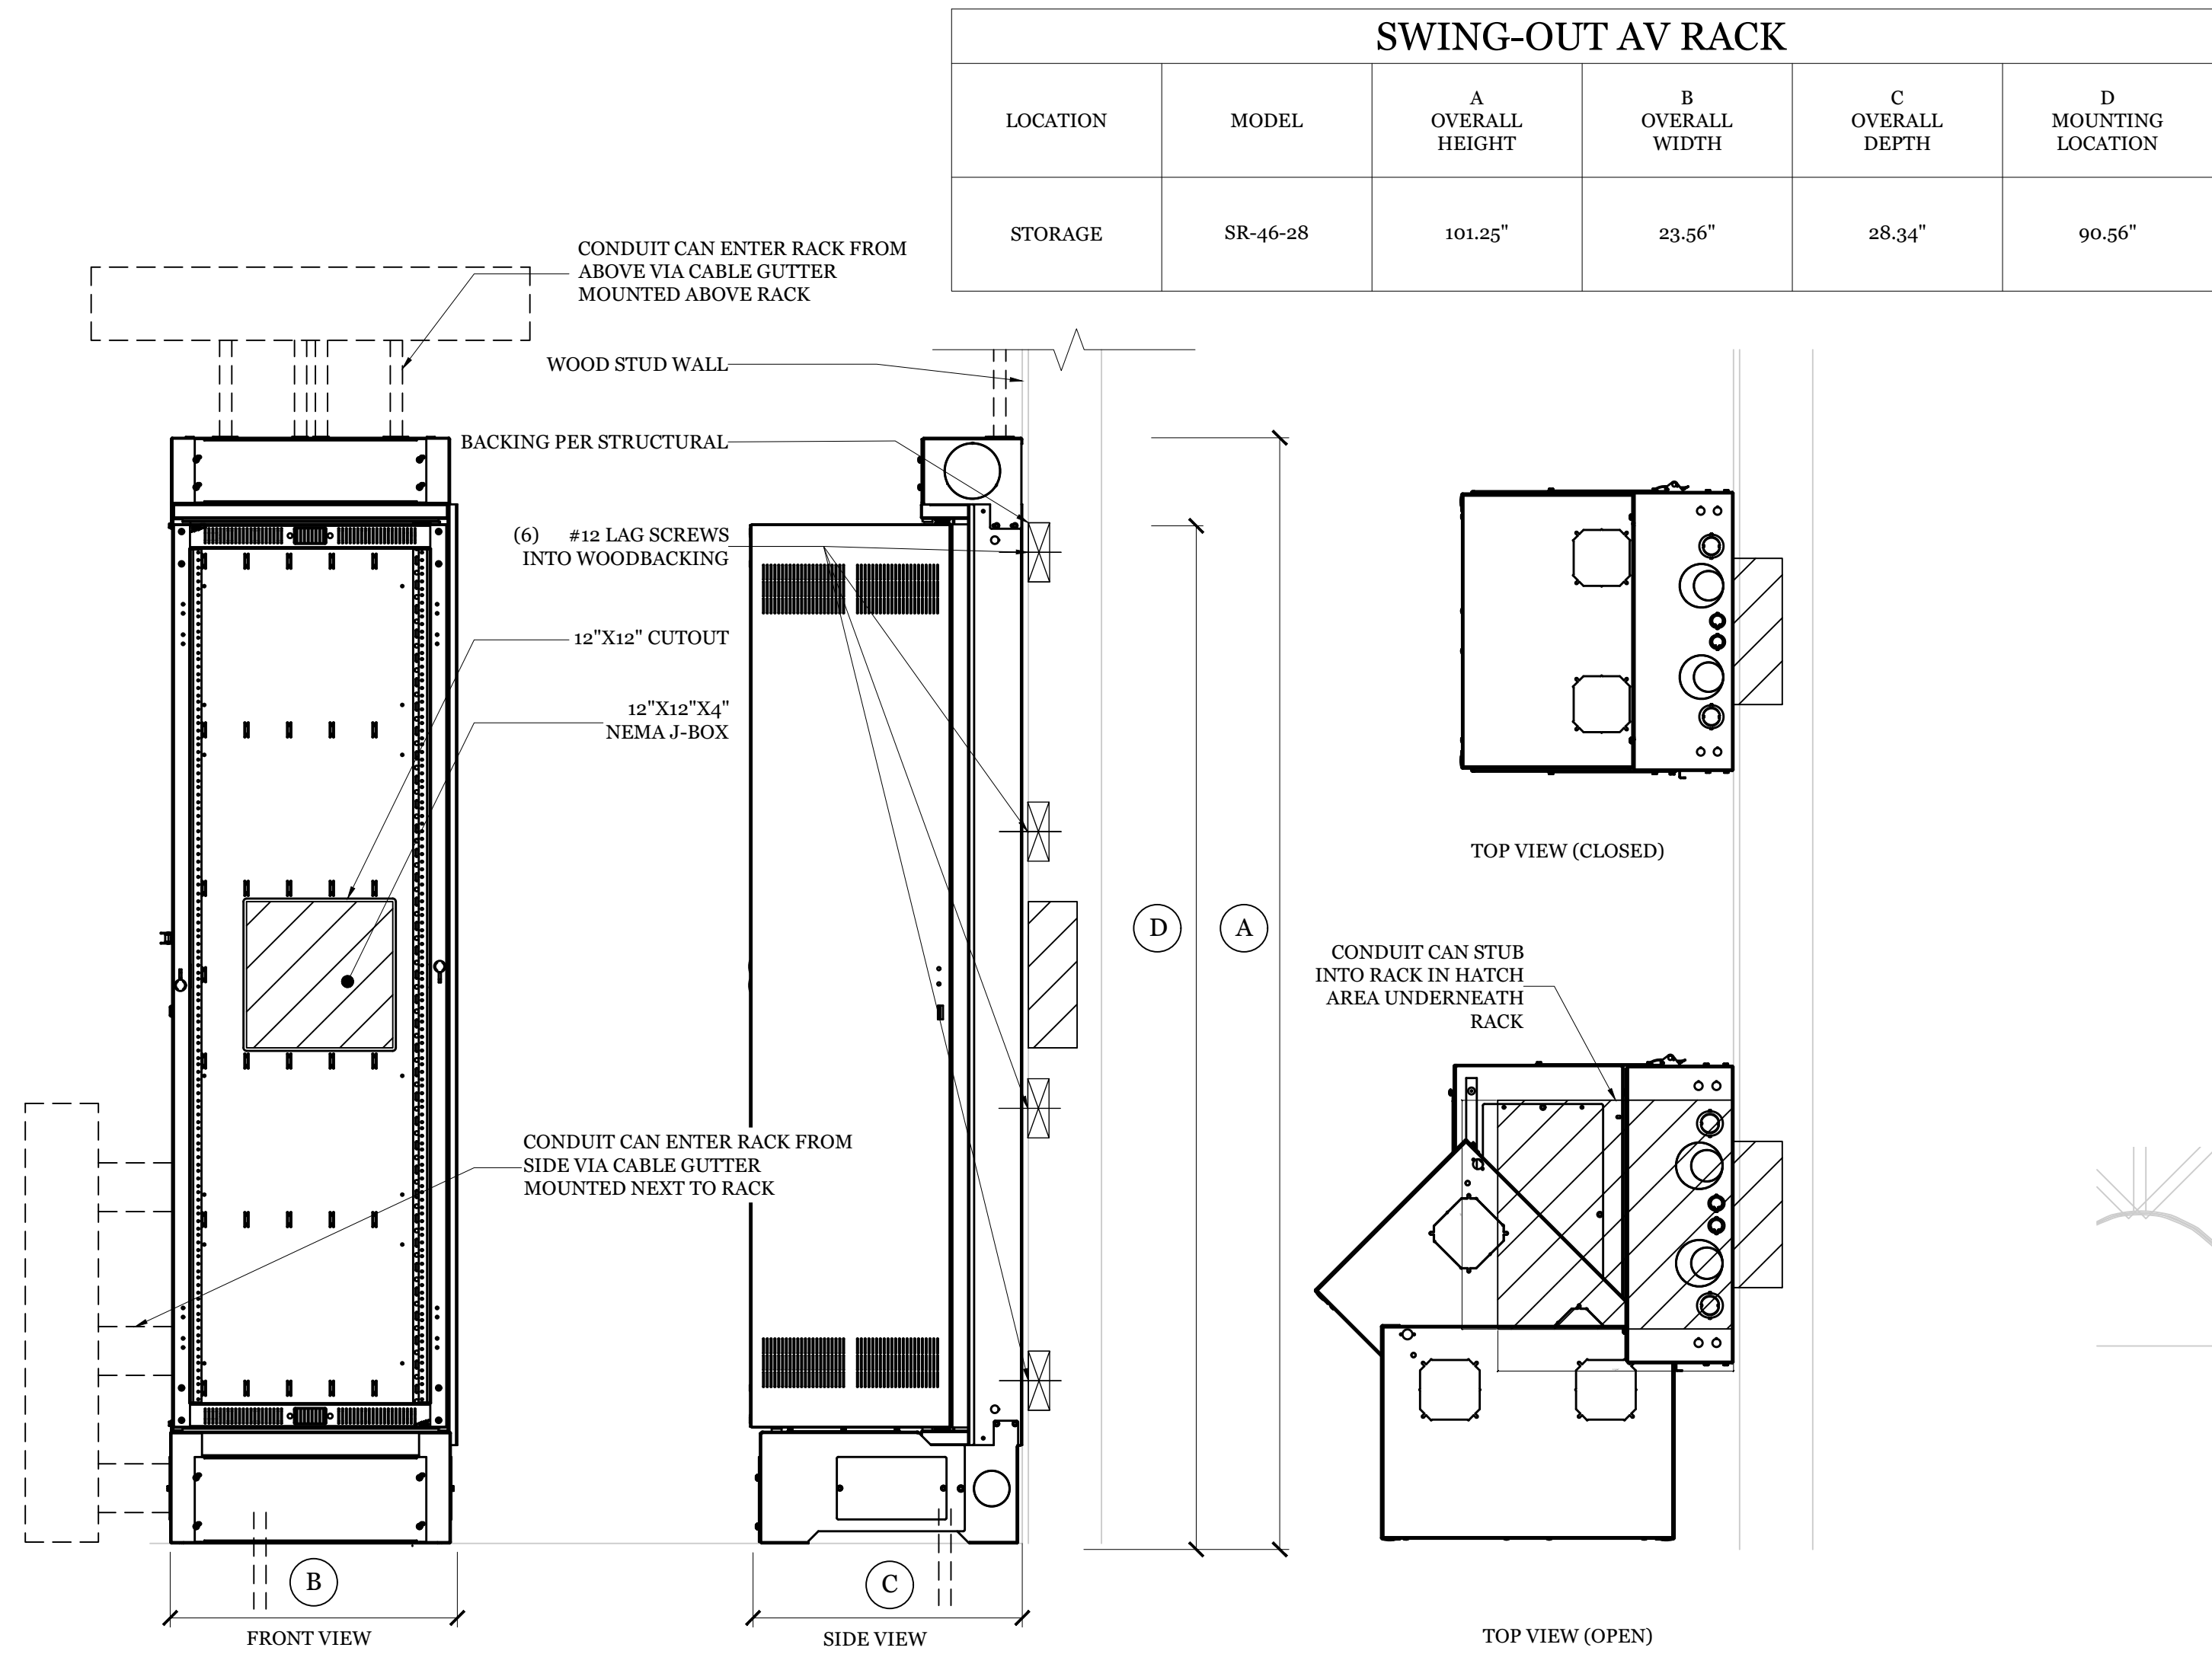
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#### AV PANEL ELEVATIONS





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#### AV-M7.1





EMPTY WEIGHT: 270 LBS  
EQUIPMENT WEIGHT: 230 LBS  
TOTAL MAX WEIGHT: 500 LBS

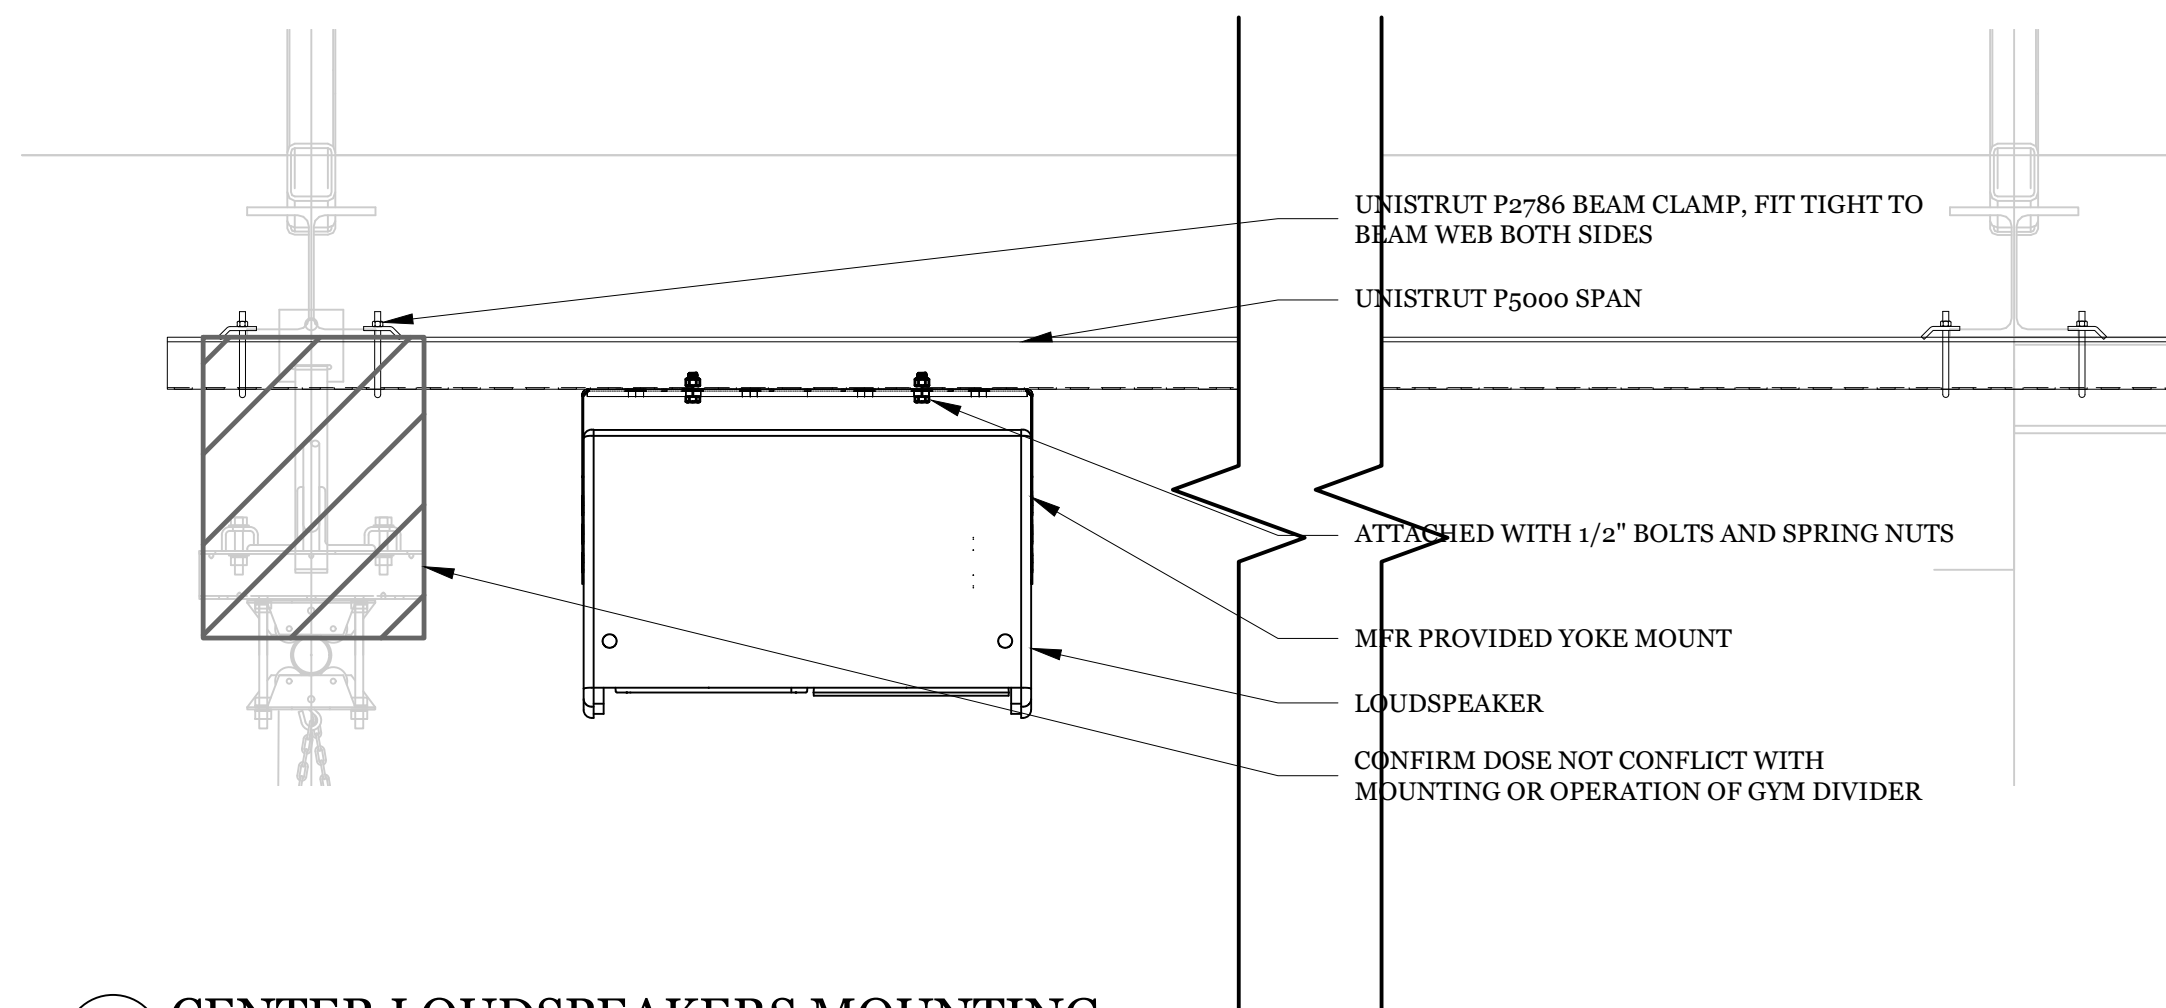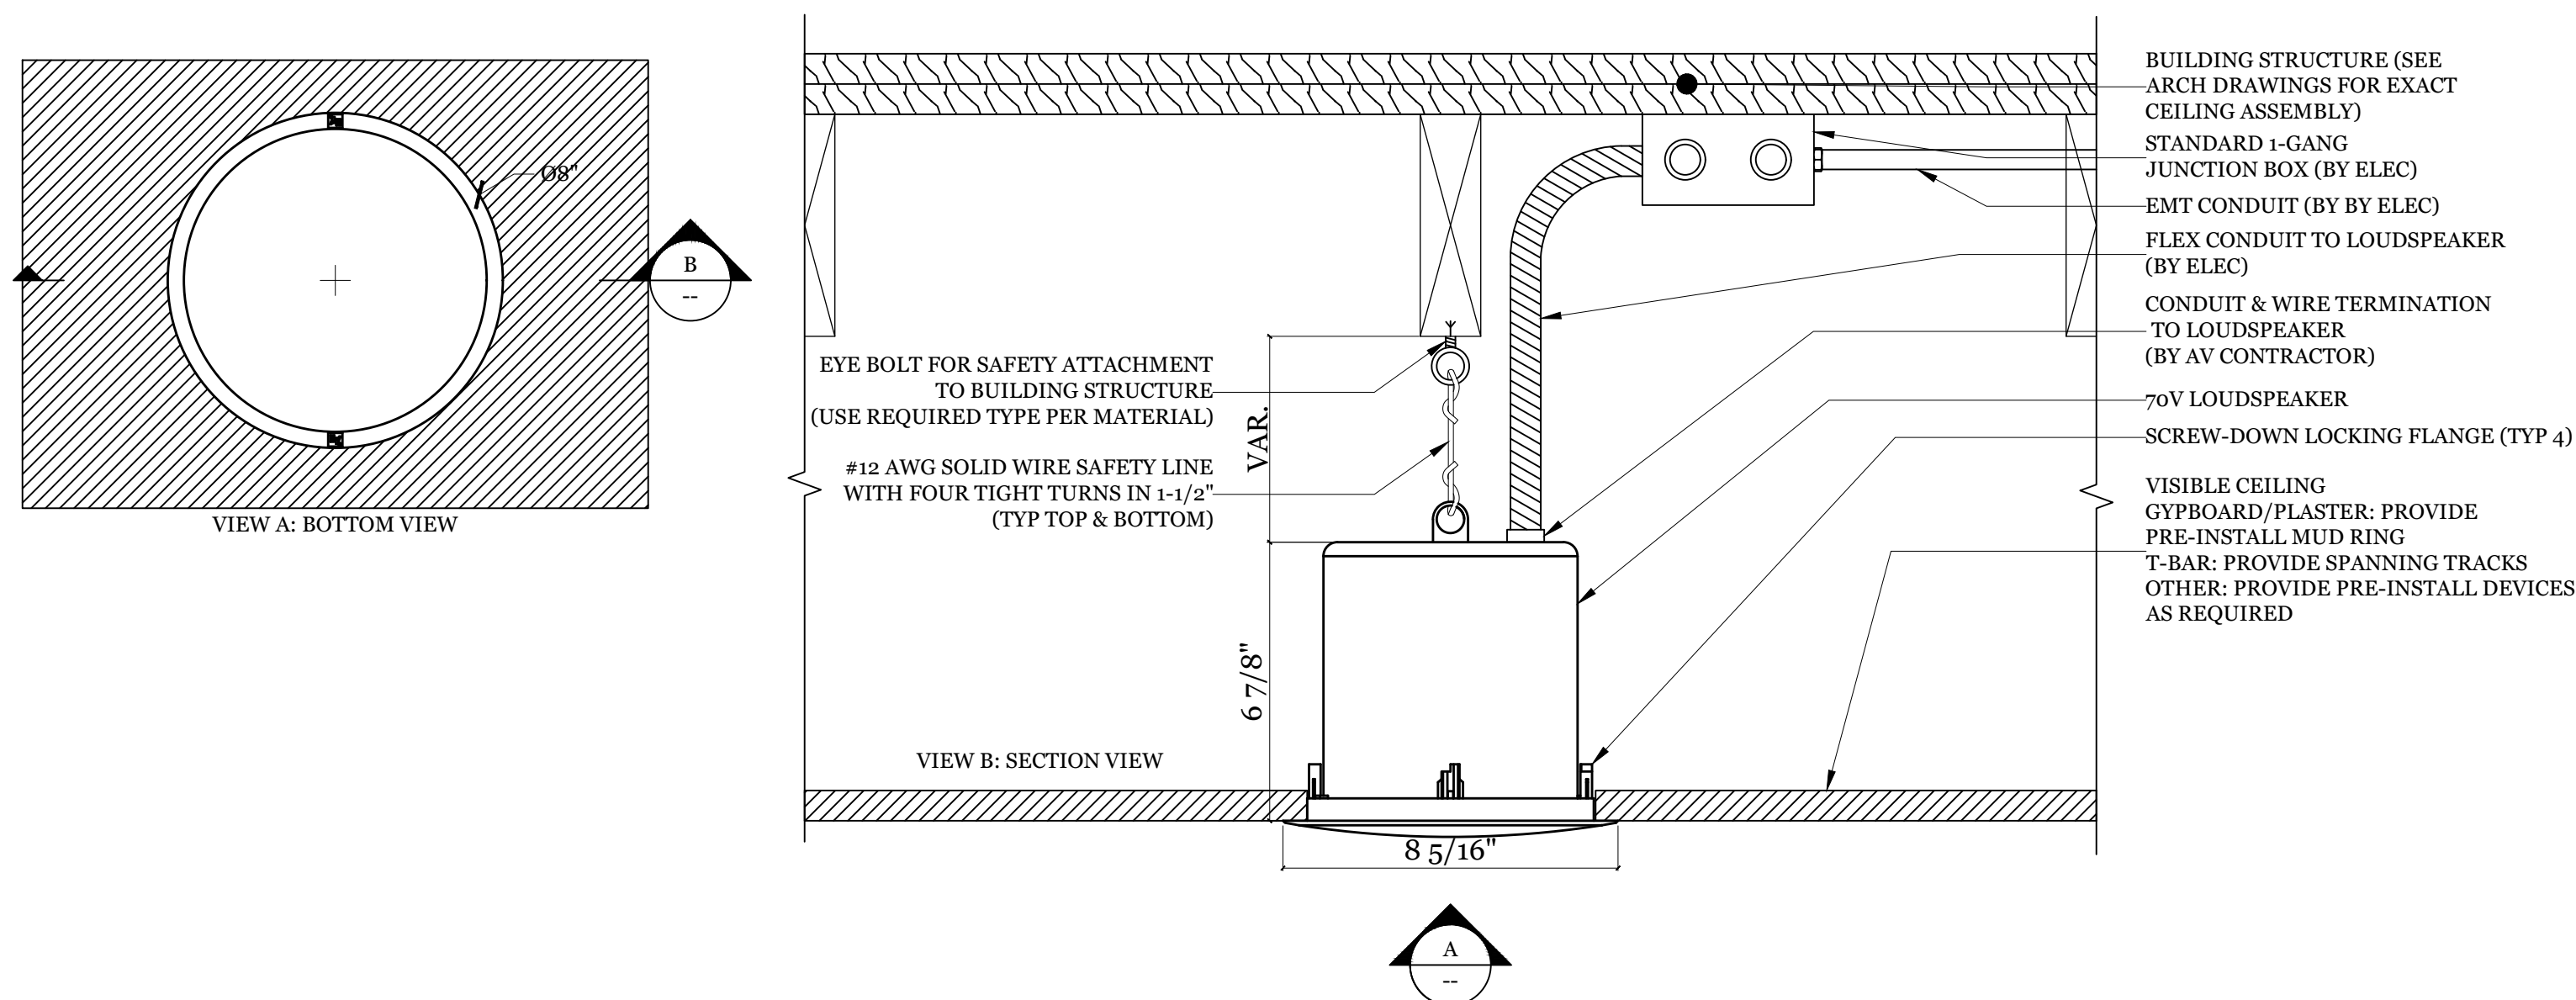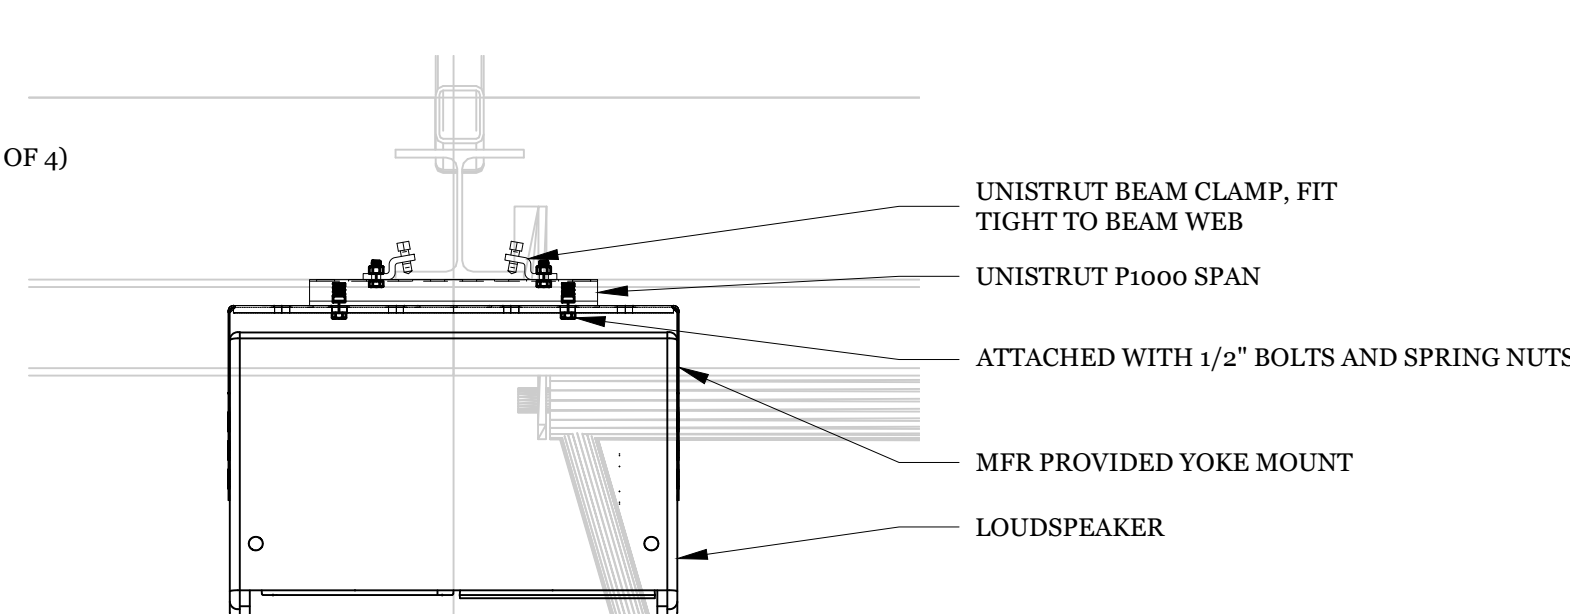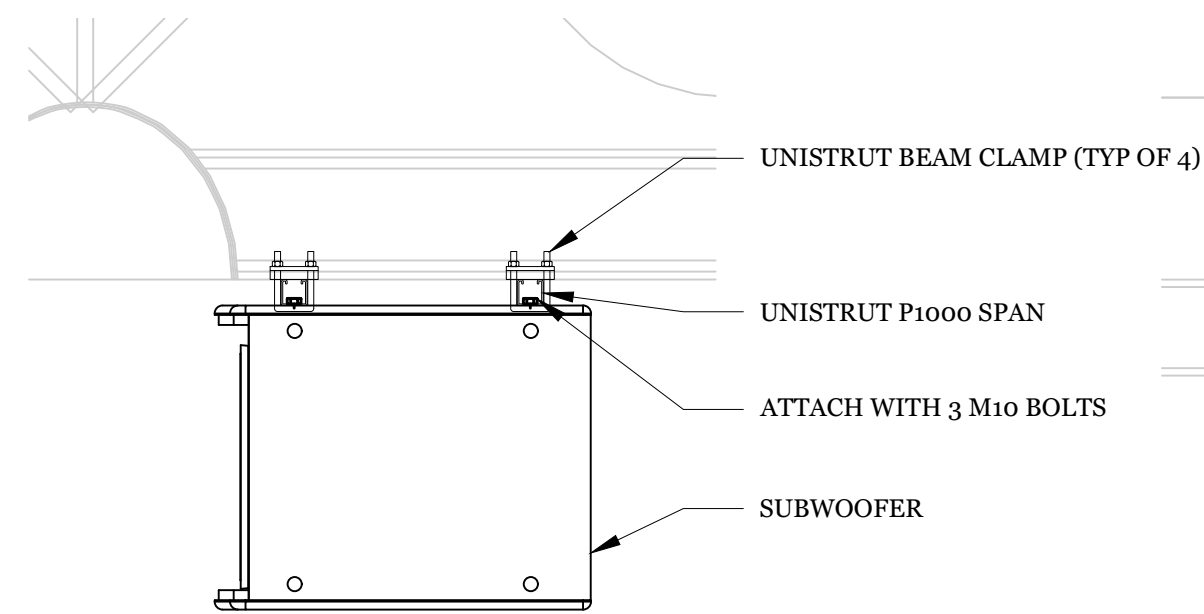

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Main:  
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SHEET TITLE

## AV MOUNTING DETAILS



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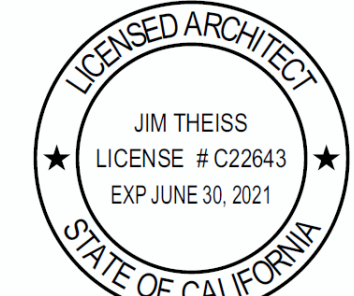




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ARCHITECTS

**Main:**  
636 Fifth Street, Santa Rosa, CA 95404

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Oakland, CA 94607  
(707) 576-0829

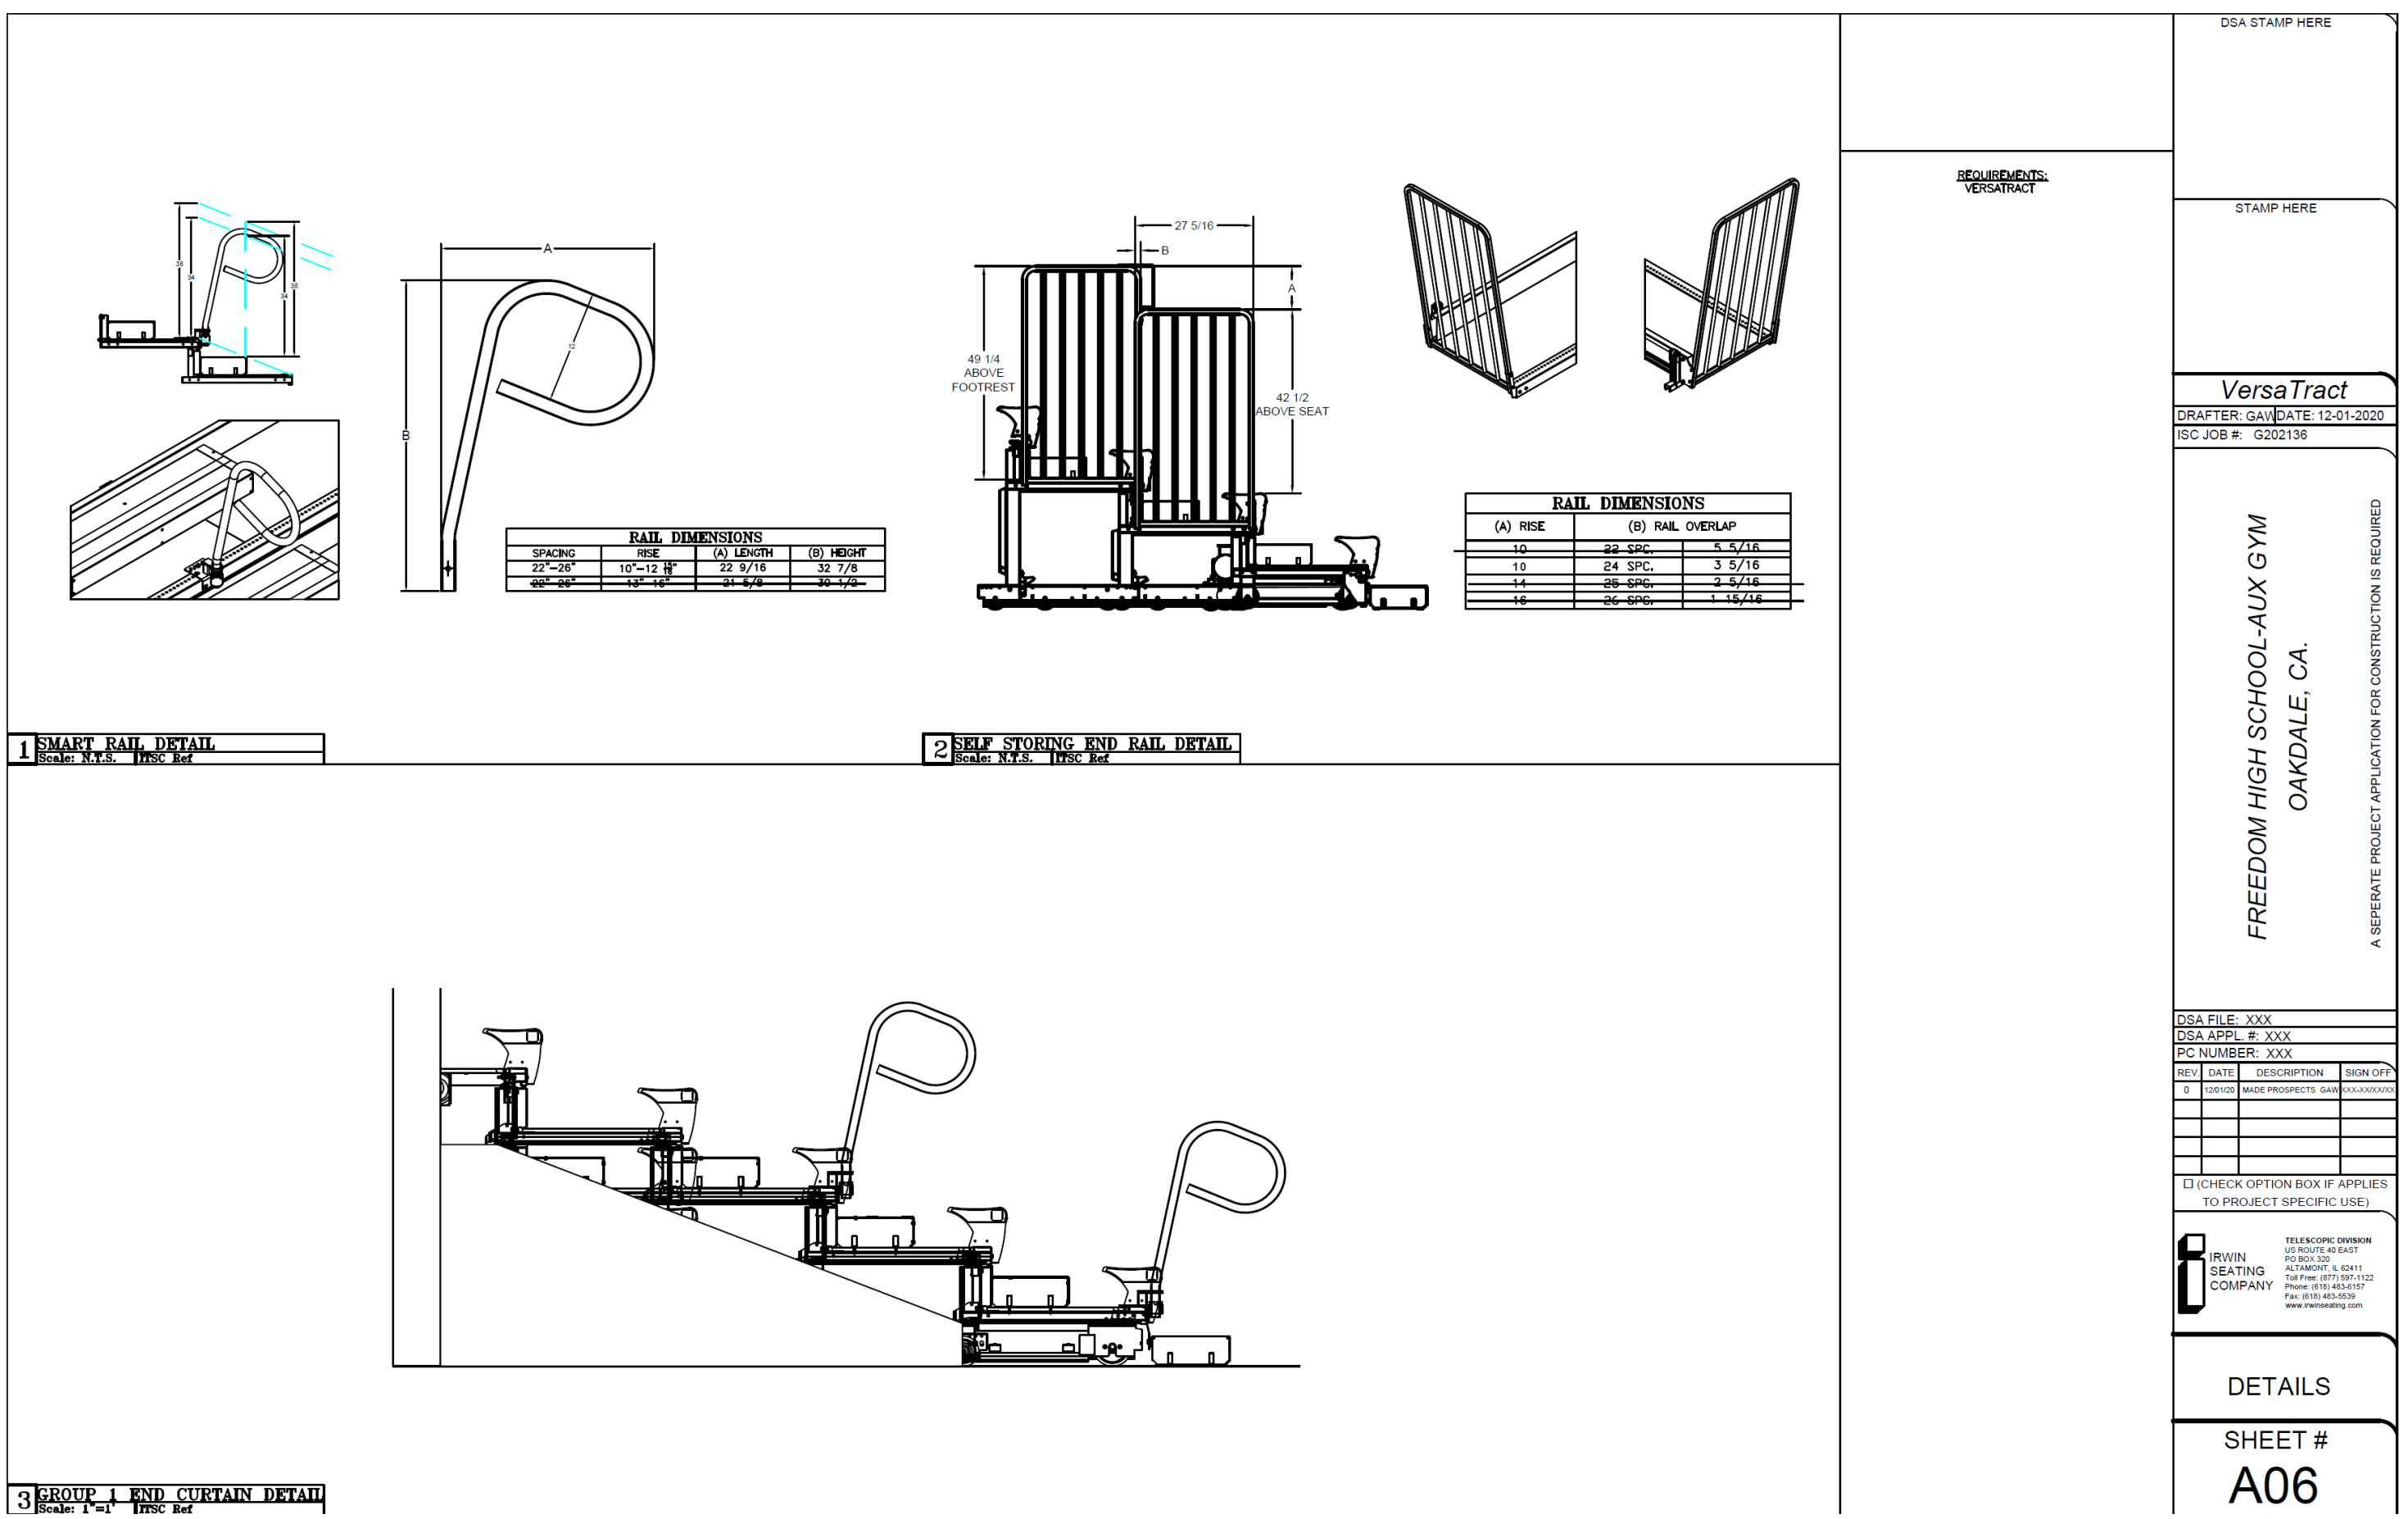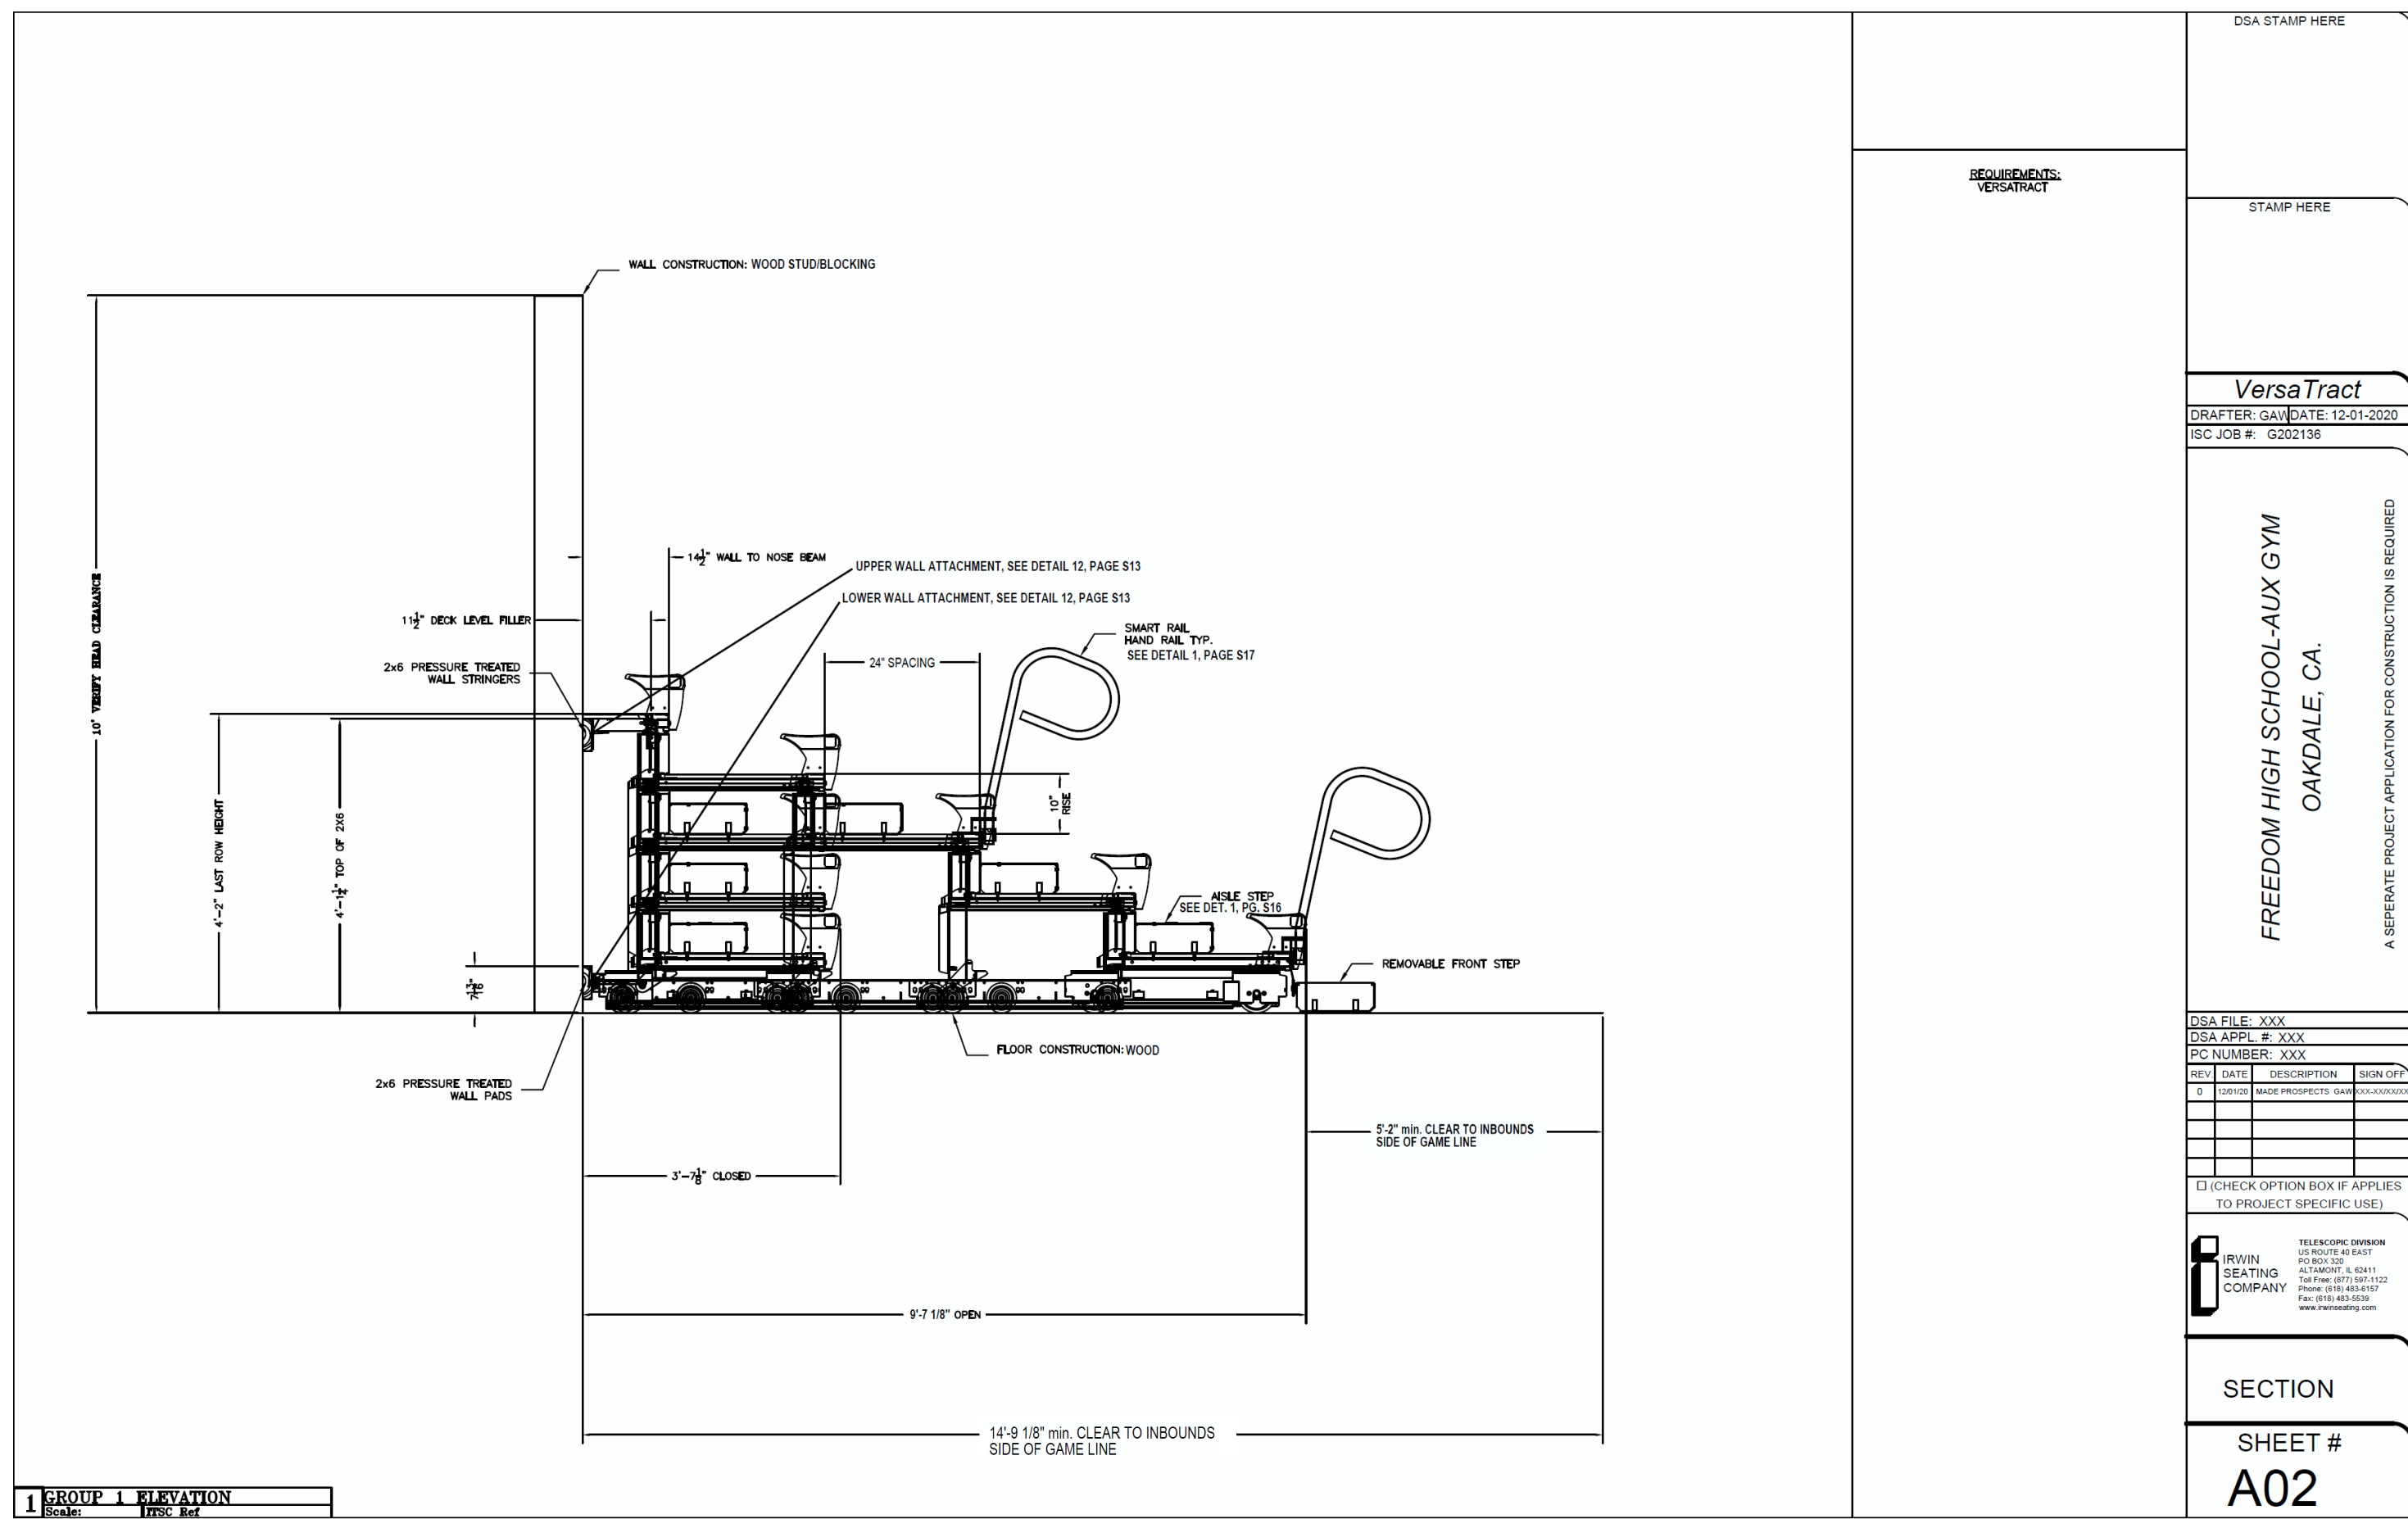

SIGNED: MAY 5, 2021

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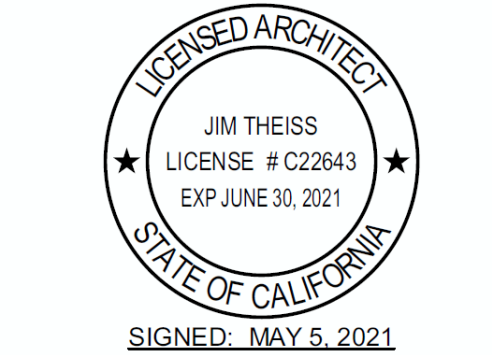
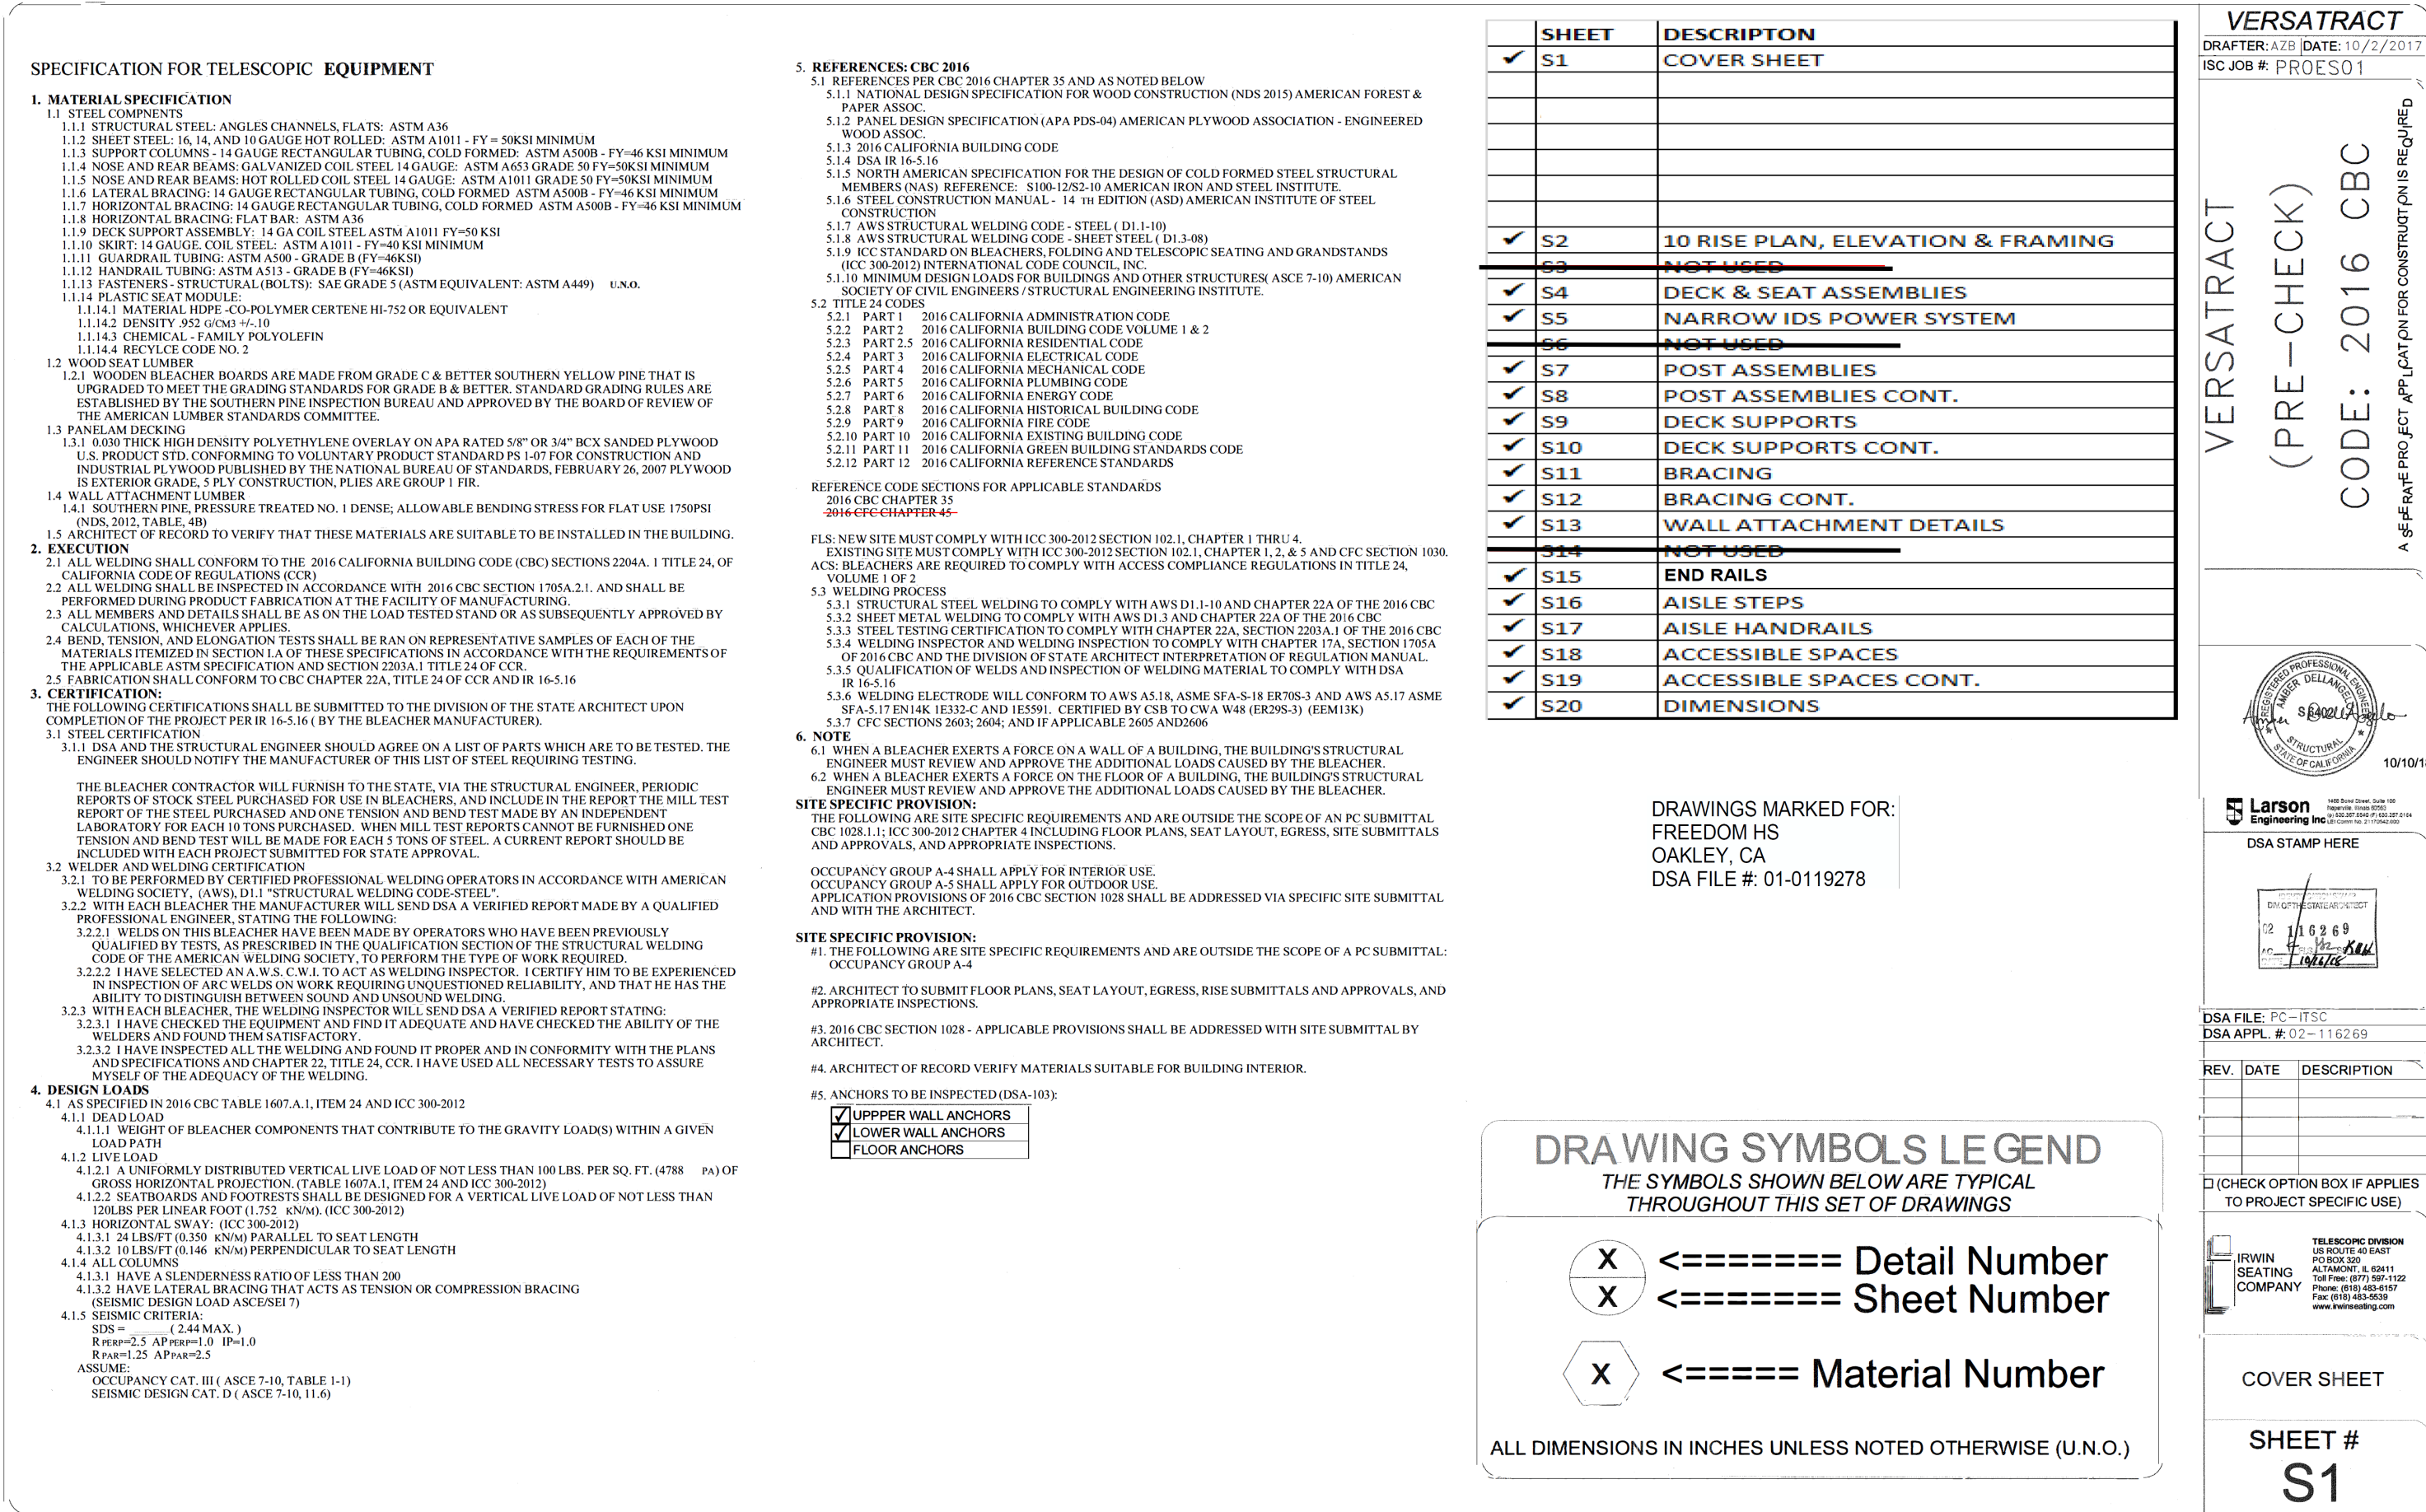
SHEET TITLE

A02: SECTION VIEW  
A03: DETAILS

SHEET NUMBER

## B2





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LIBERTY UNION  
HIGH SCHOOL  
DISTRICT

[illegible]

DSA APP NO. 01-119278

ARCH PROJECT NO: 1869.00

DRAWN BY:

DRAWING SCALE: _____

PTN: 61721-78 FILE NO: 7-H4

BID DOCUMENT

APRIL 27, 2021

SHEET TITLE

## REFERENCES


S2: 10" DISC PLAN ELEVATION

## 02.10 ROCKET EARTH, ELEVATION & FRAMING

SHEET NUMBER

**B3**



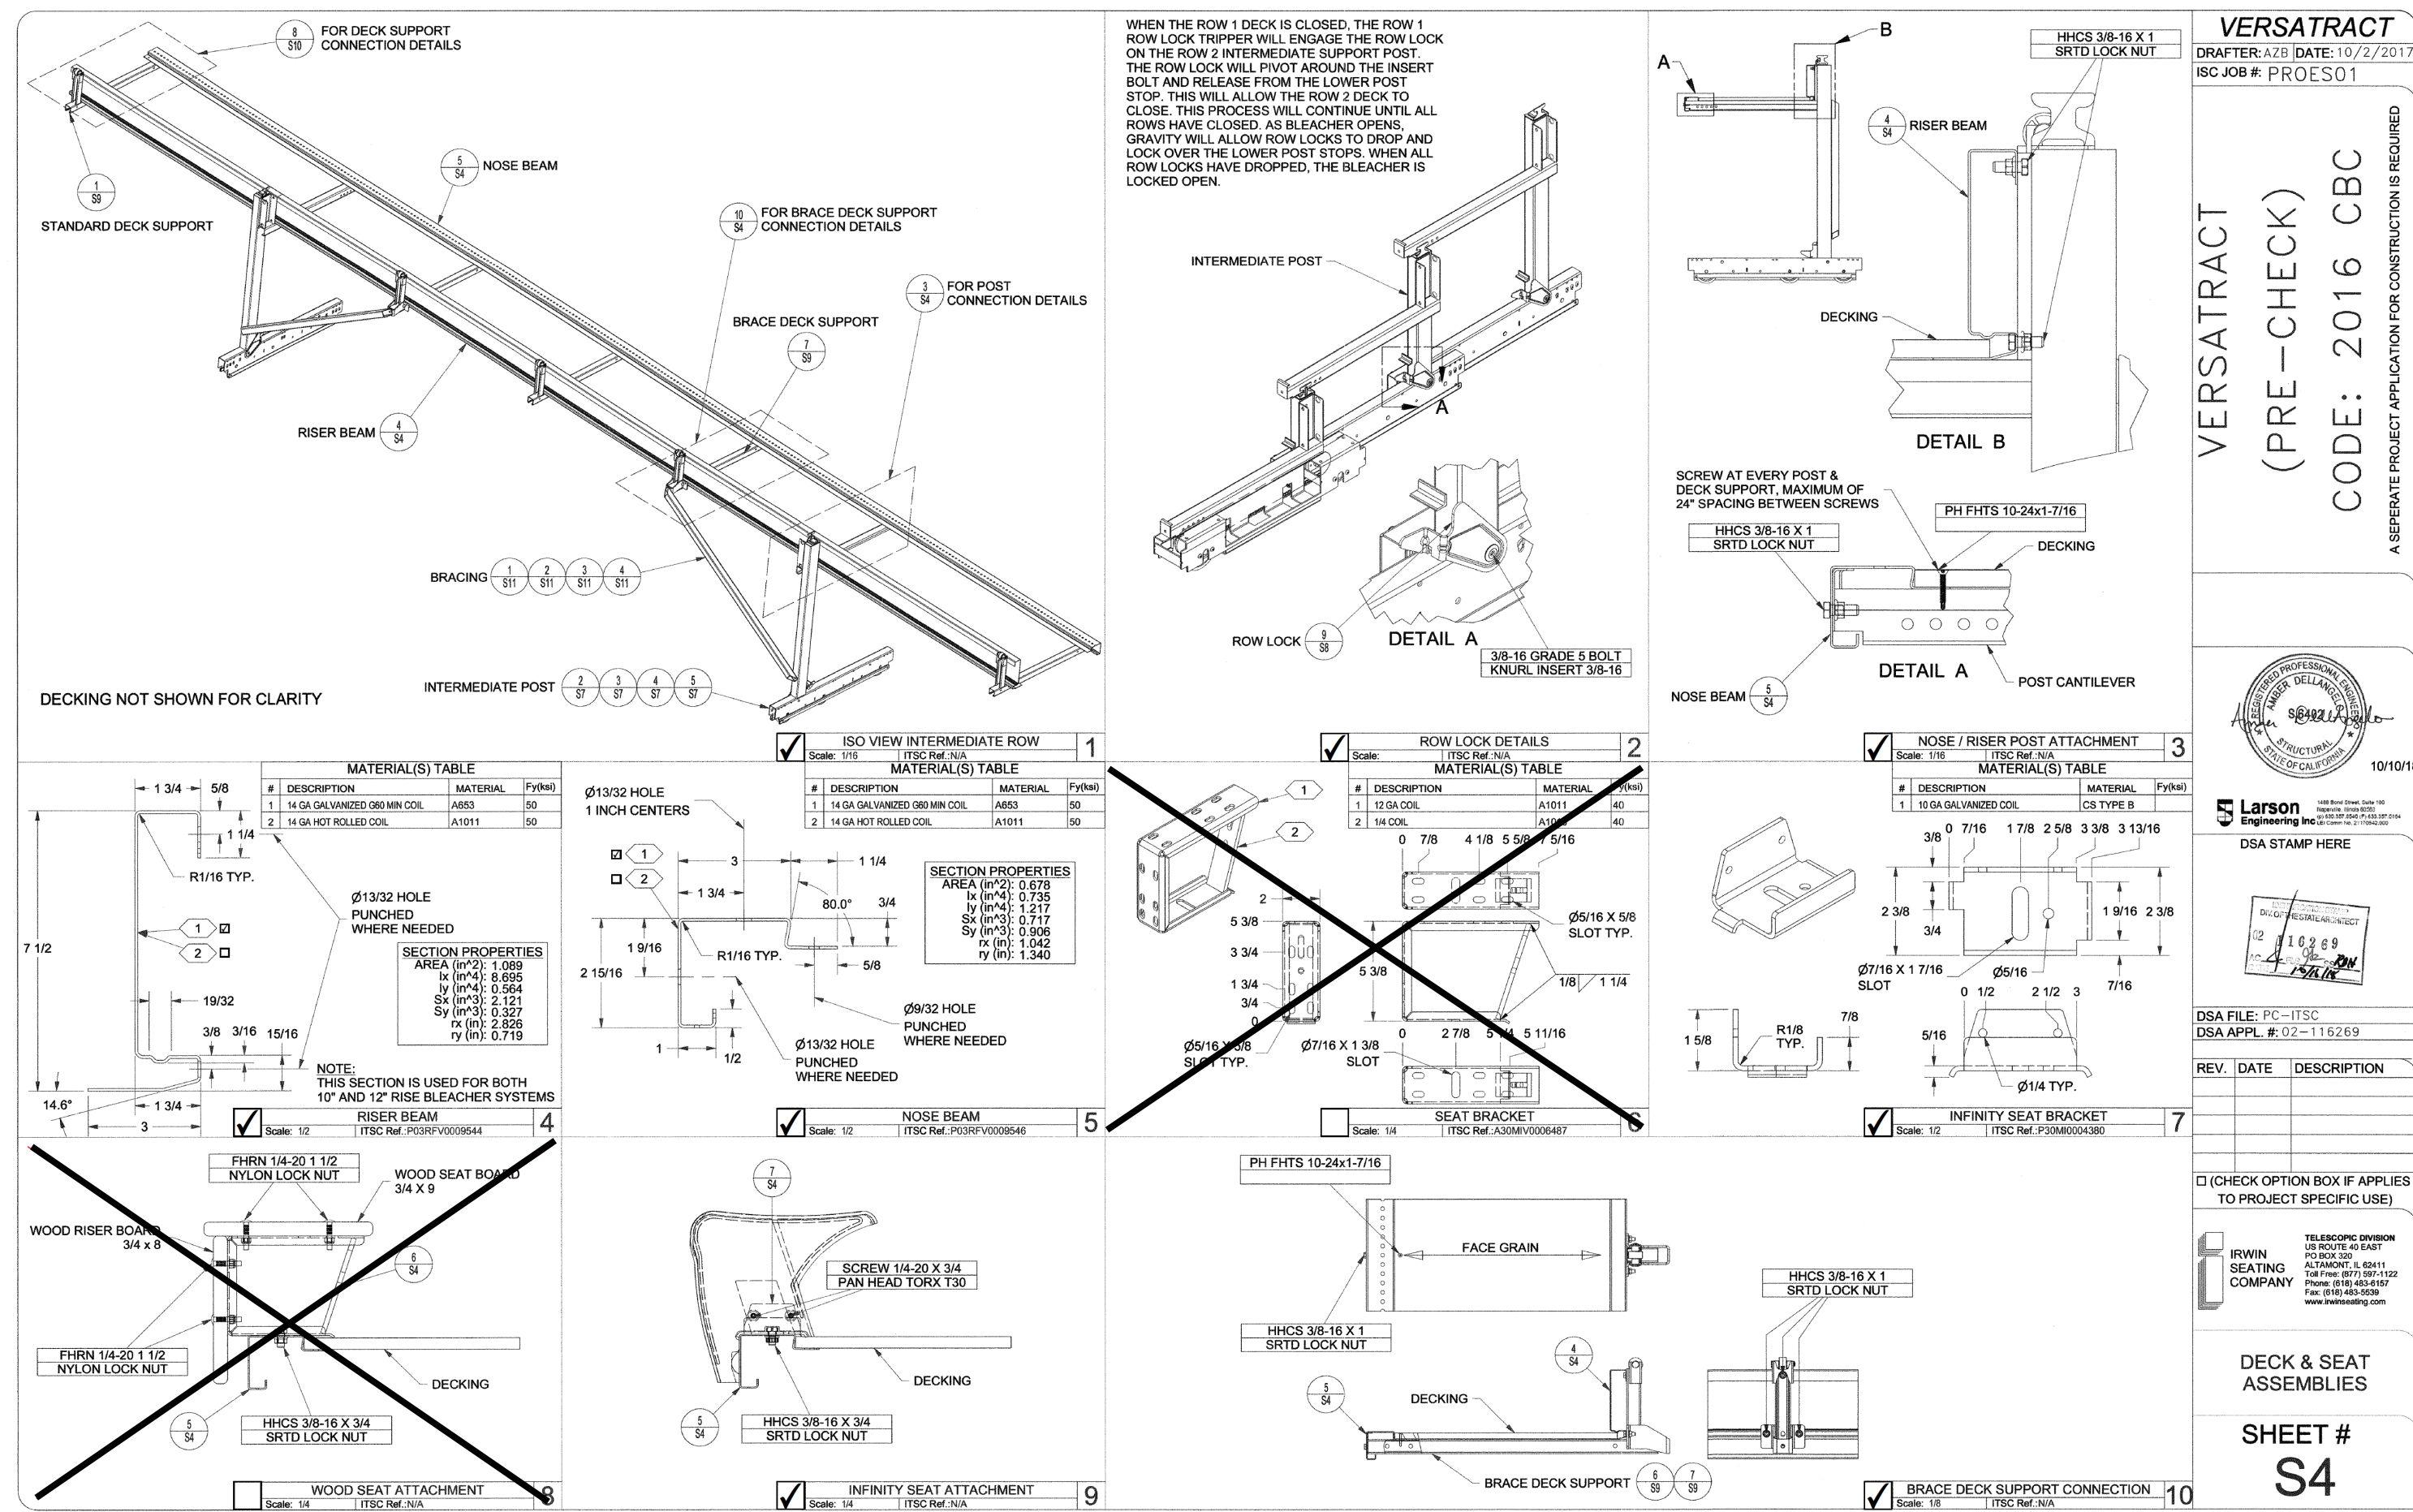

**FREEDOM  
HIGH SCHOOL**

## NEW AUXILIARY GYMNASIUM

1050 NEROLY RD,  
OAKLEY, CA 94561

LIBERTY UNION  
HIGH SCHOOL  
DISTRICT[illegible]

DSA APP NO. 01-119278

ARCH PROJECT NO: 1869.00

DRAWN BY:

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PTN: 61721-78 FILE NO: 7-H4

BID DOCUMENT

APRIL 27, 2021

**SHEET TITLE**

#### S4: DECK & SEAT ASSEMBLIES

### 33. NARROW IDS POWER ASST

_____

SHEET NUMBER



54

**B4**


## References

_____



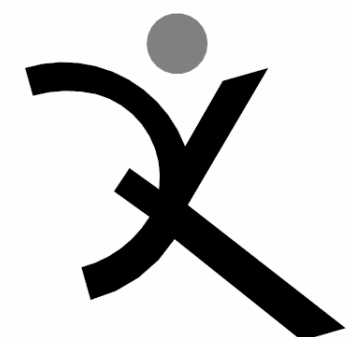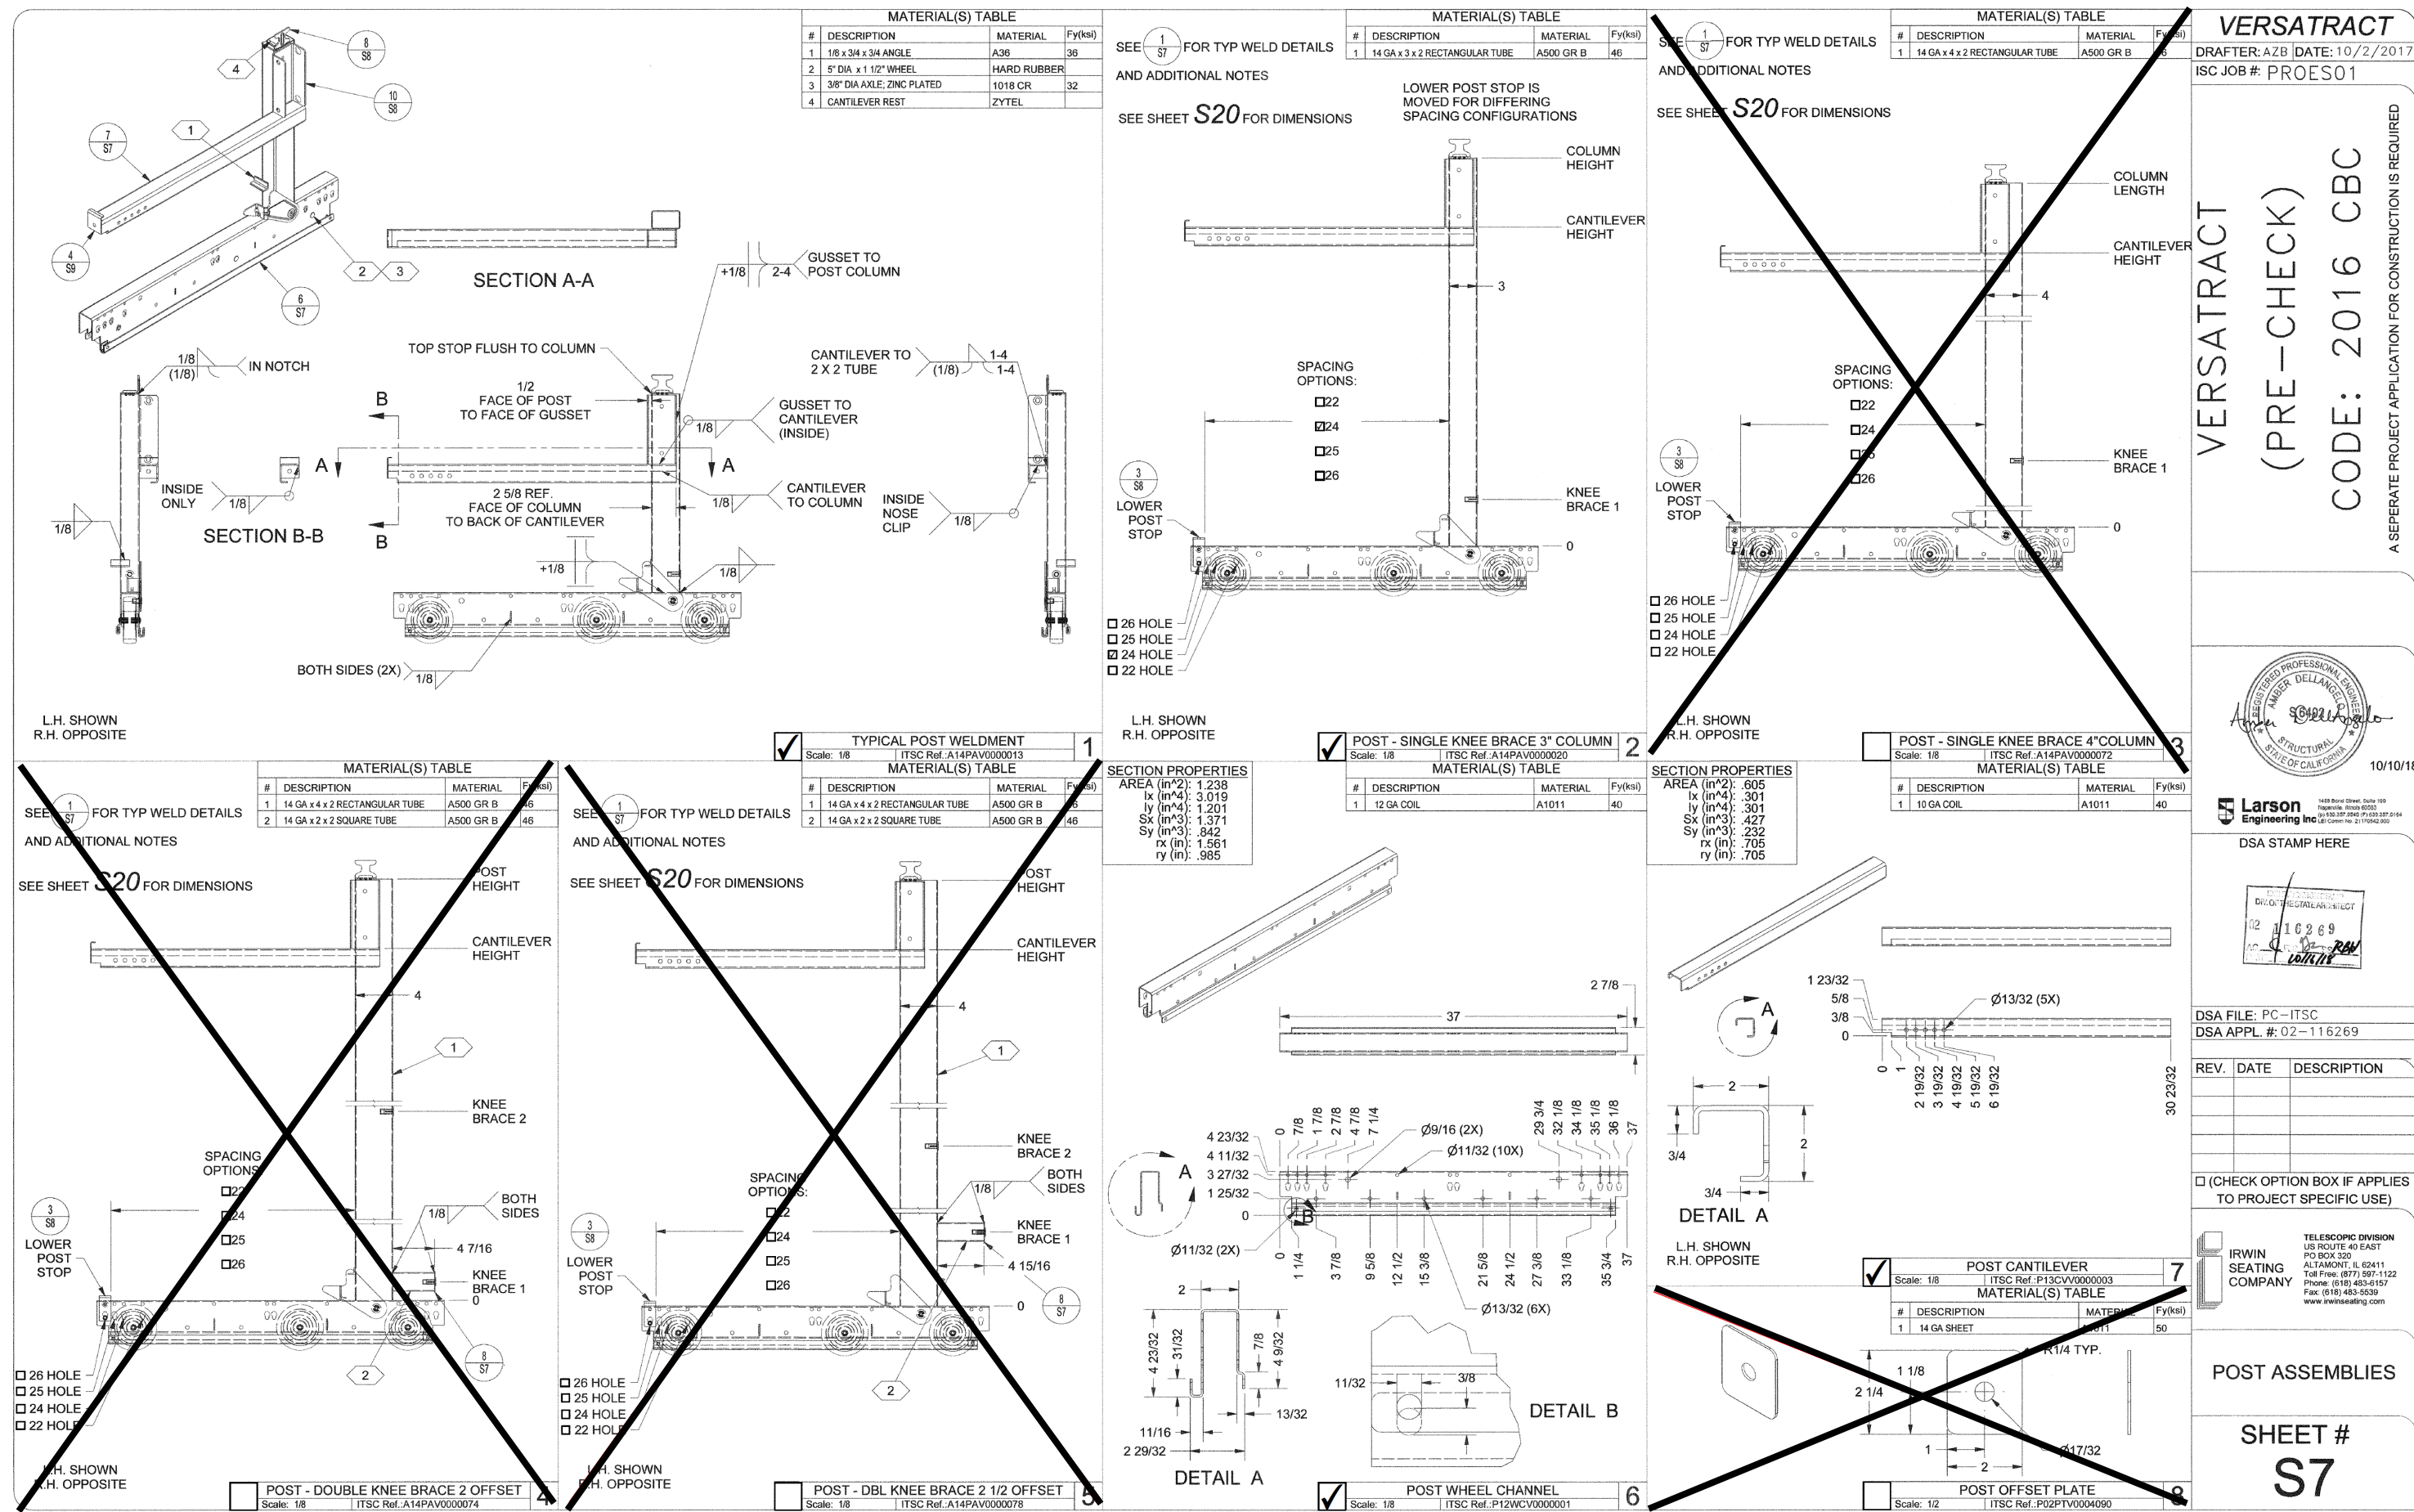

QUATTROCCHI KWOK  
ARCHITECTS  
**Main:**  
636 Fifth Street, Santa Rosa, CA 95404  
**East Bay:**  
55 Harrison Street, Suite 525,  
Oakland, CA 94607  
(707) 576-0829

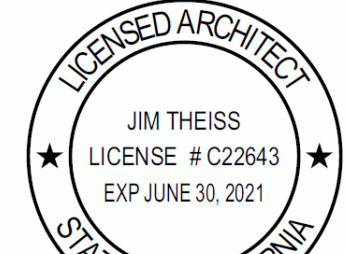

SIGNED: MAY 5, 2021

**FREEDOM  
HIGH SCHOOL**

## NEW AUXILIARY GYMNASIUM

1050 NEROLY RD,  
OAKLEY, CA 94561

LIBERTY UNION  
HIGH SCHOOL  
DISTRICT

[illegible]

DSA APP NO. 01-119278

ARCH PROJECT NO: 1869.00

DRAWN BY

DRAWING SCALE:

PTN: 61721-78

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APR

SHEET TITLE

## REFERENCES

37. POST AS  
00. POST AS

### Sub. POST AS


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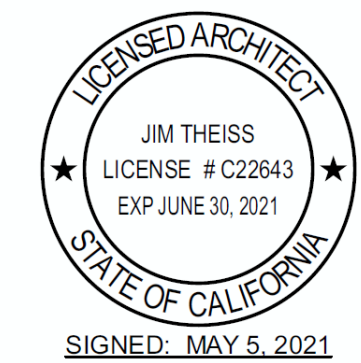
**D**

10/10/2016





QUATTROCCHI KWOK  
ARCHITECTS  
**Main:**  
636 Fifth Street, Santa Rosa, CA 95404  
**East Bay:**  
55 Harrison Street, Suite 525,  
Oakland, CA 94607  
(707) 576-0829

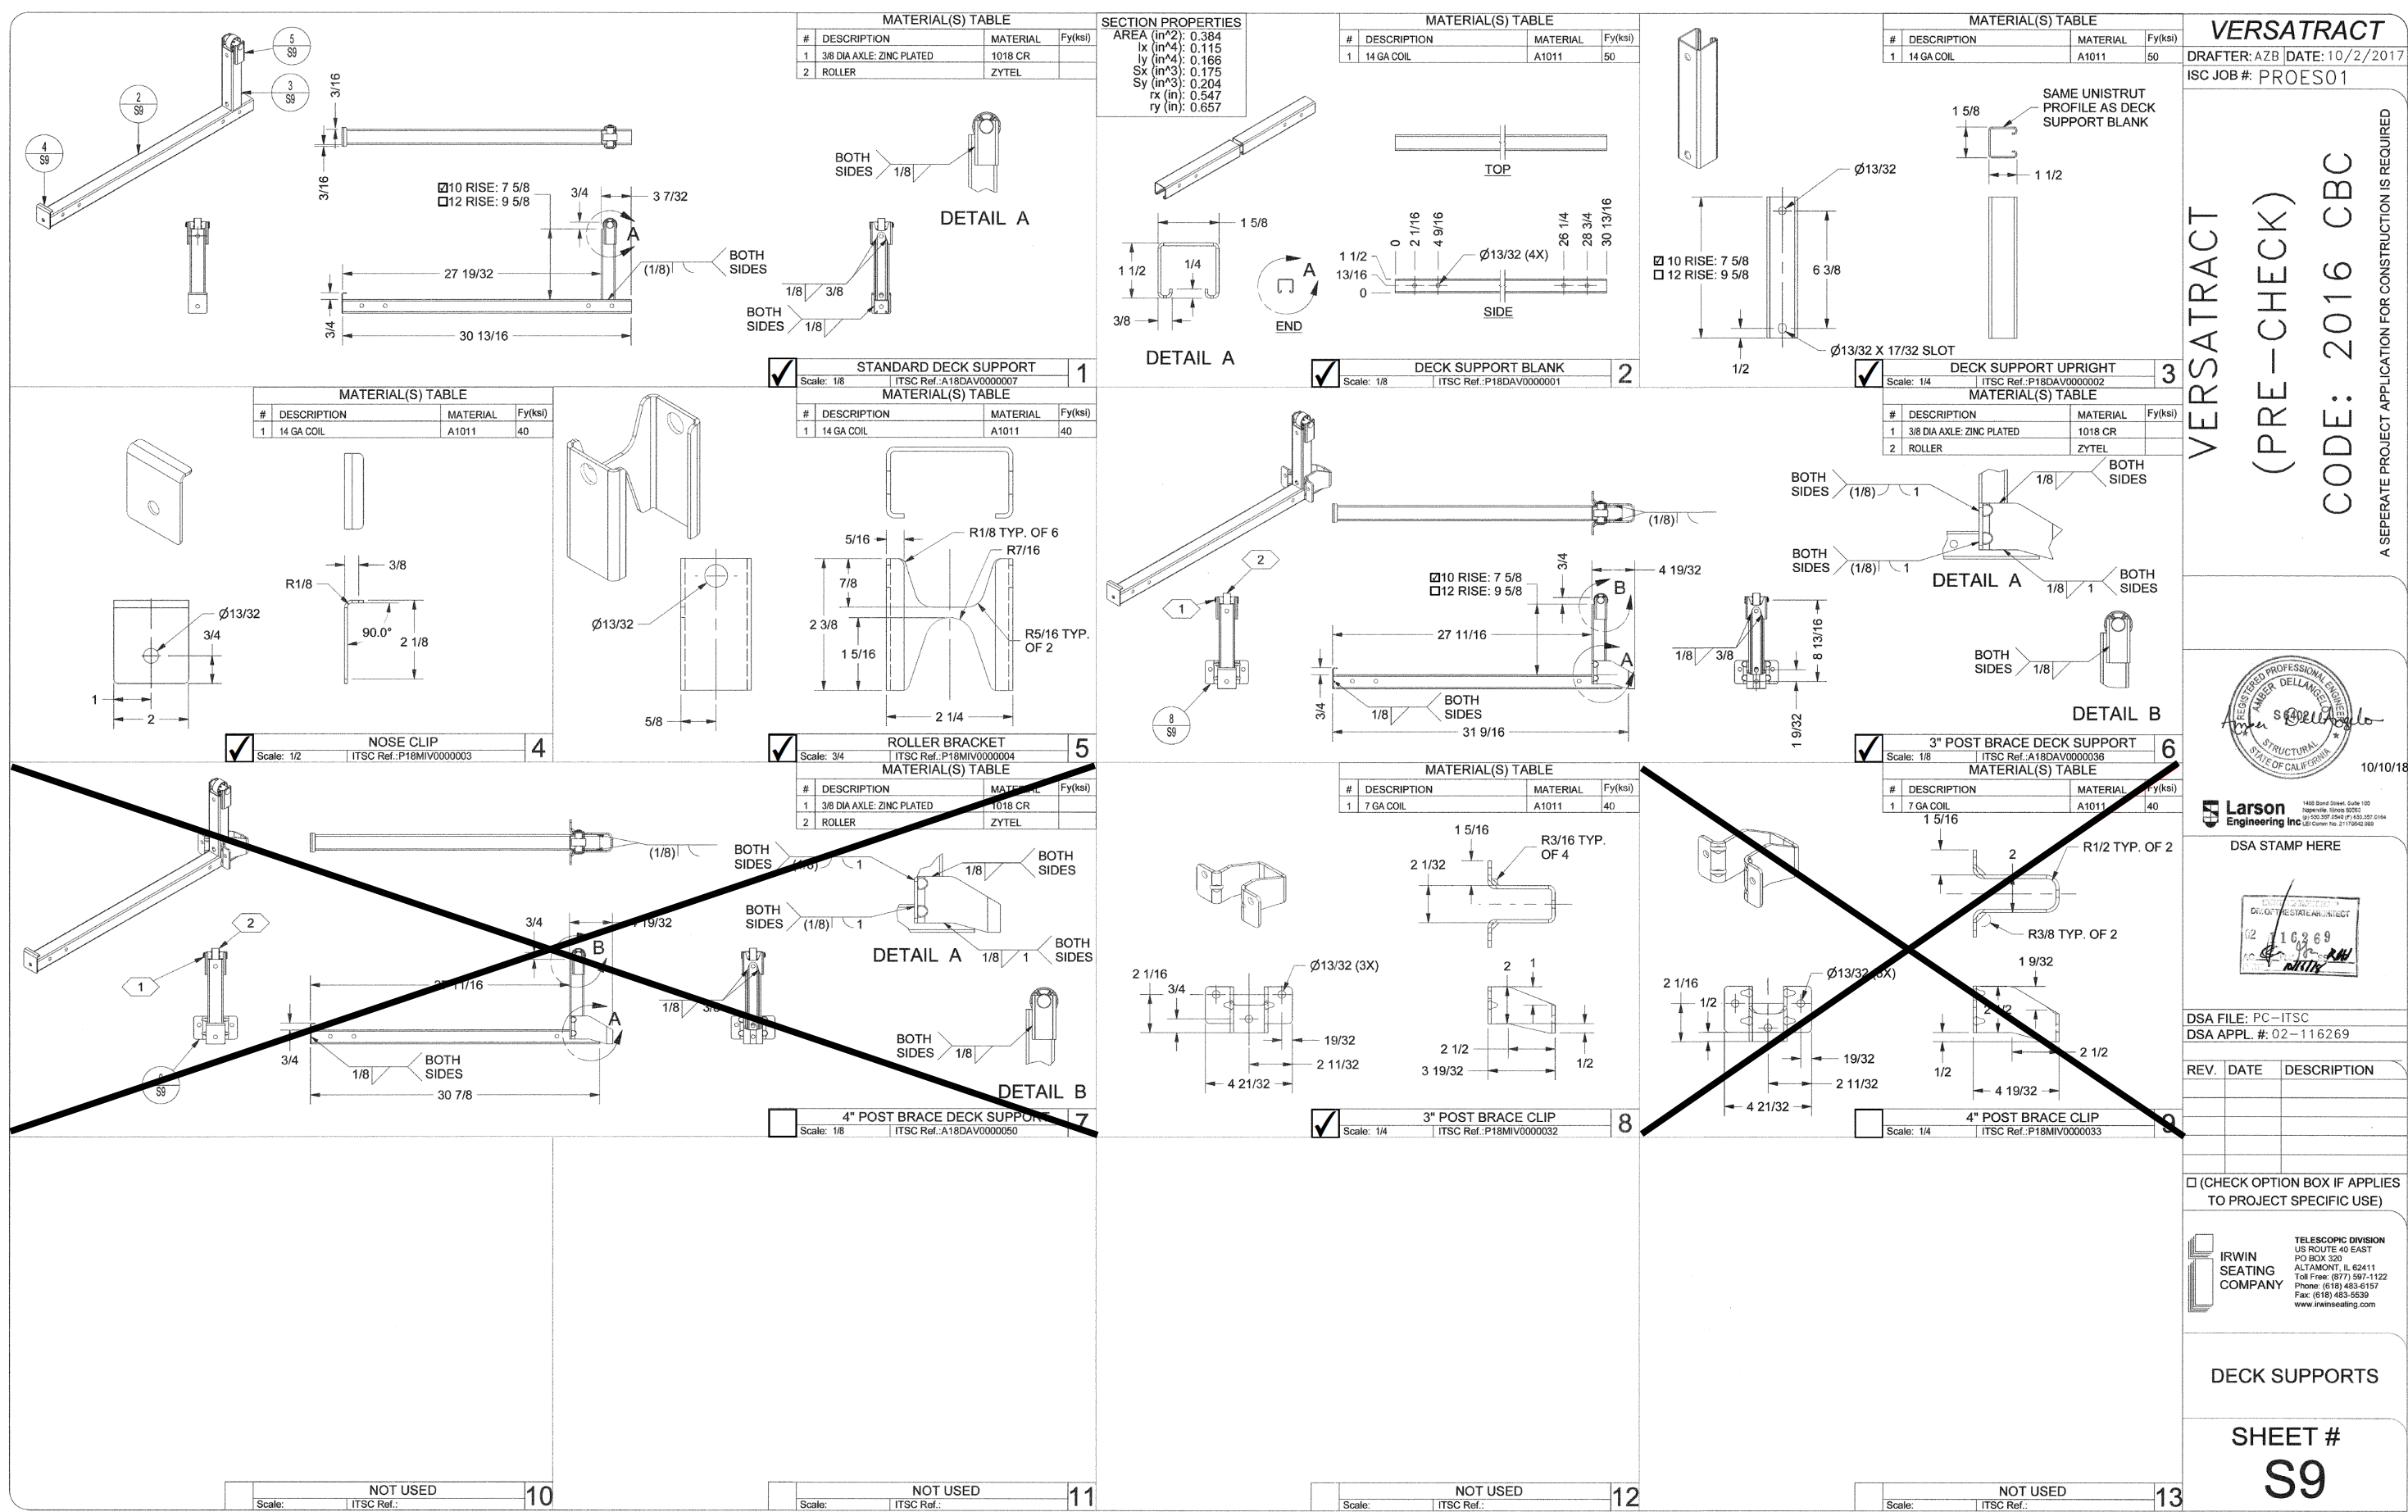

**FREEDOM  
HIGH SCHOOL**

## NEW AUXILIARY GYMNASIUM

1050 NEROLY RD,  
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ARCH PROJECT NO: 1869.00

DRAWN BY:

DRAWING SCALE:

PTN: 61721-78 FILE NO: 7-H4

## BID DOCUMENT

APRIL 27, 2021



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S9: DECK SUPPORTS  
S10: DECK SUPPORTS CONT.

SHEET NUMBER

**B6**




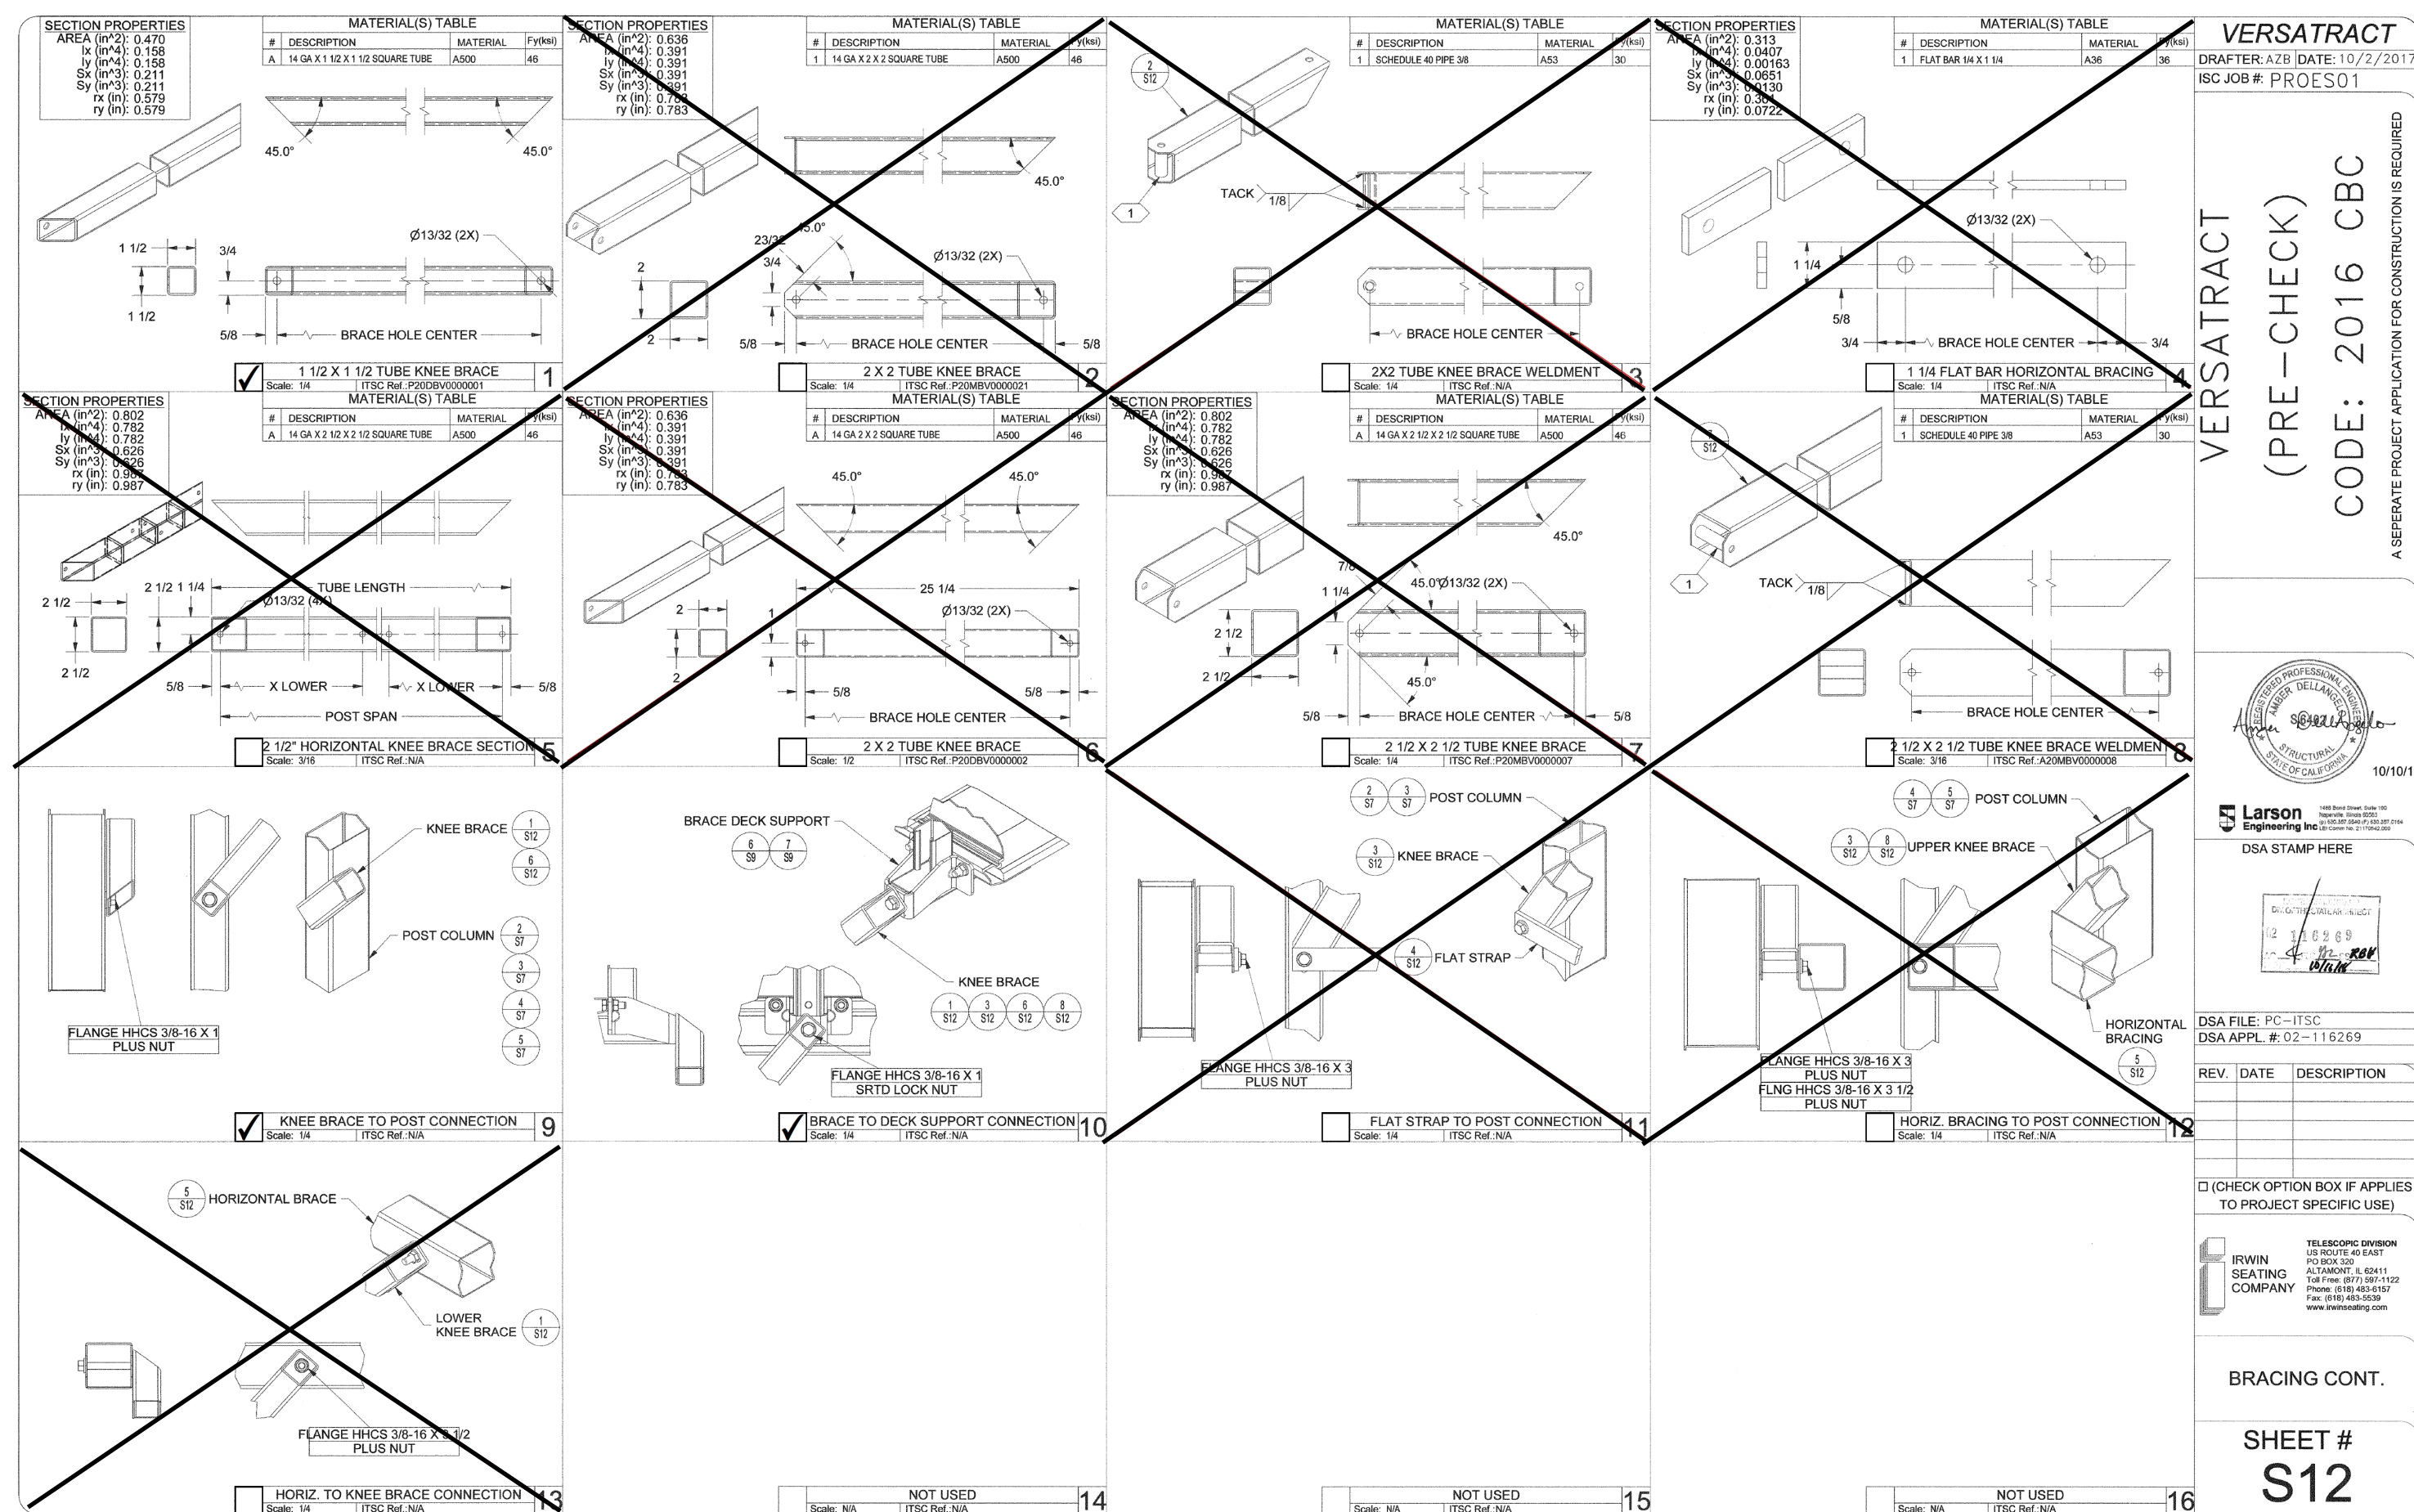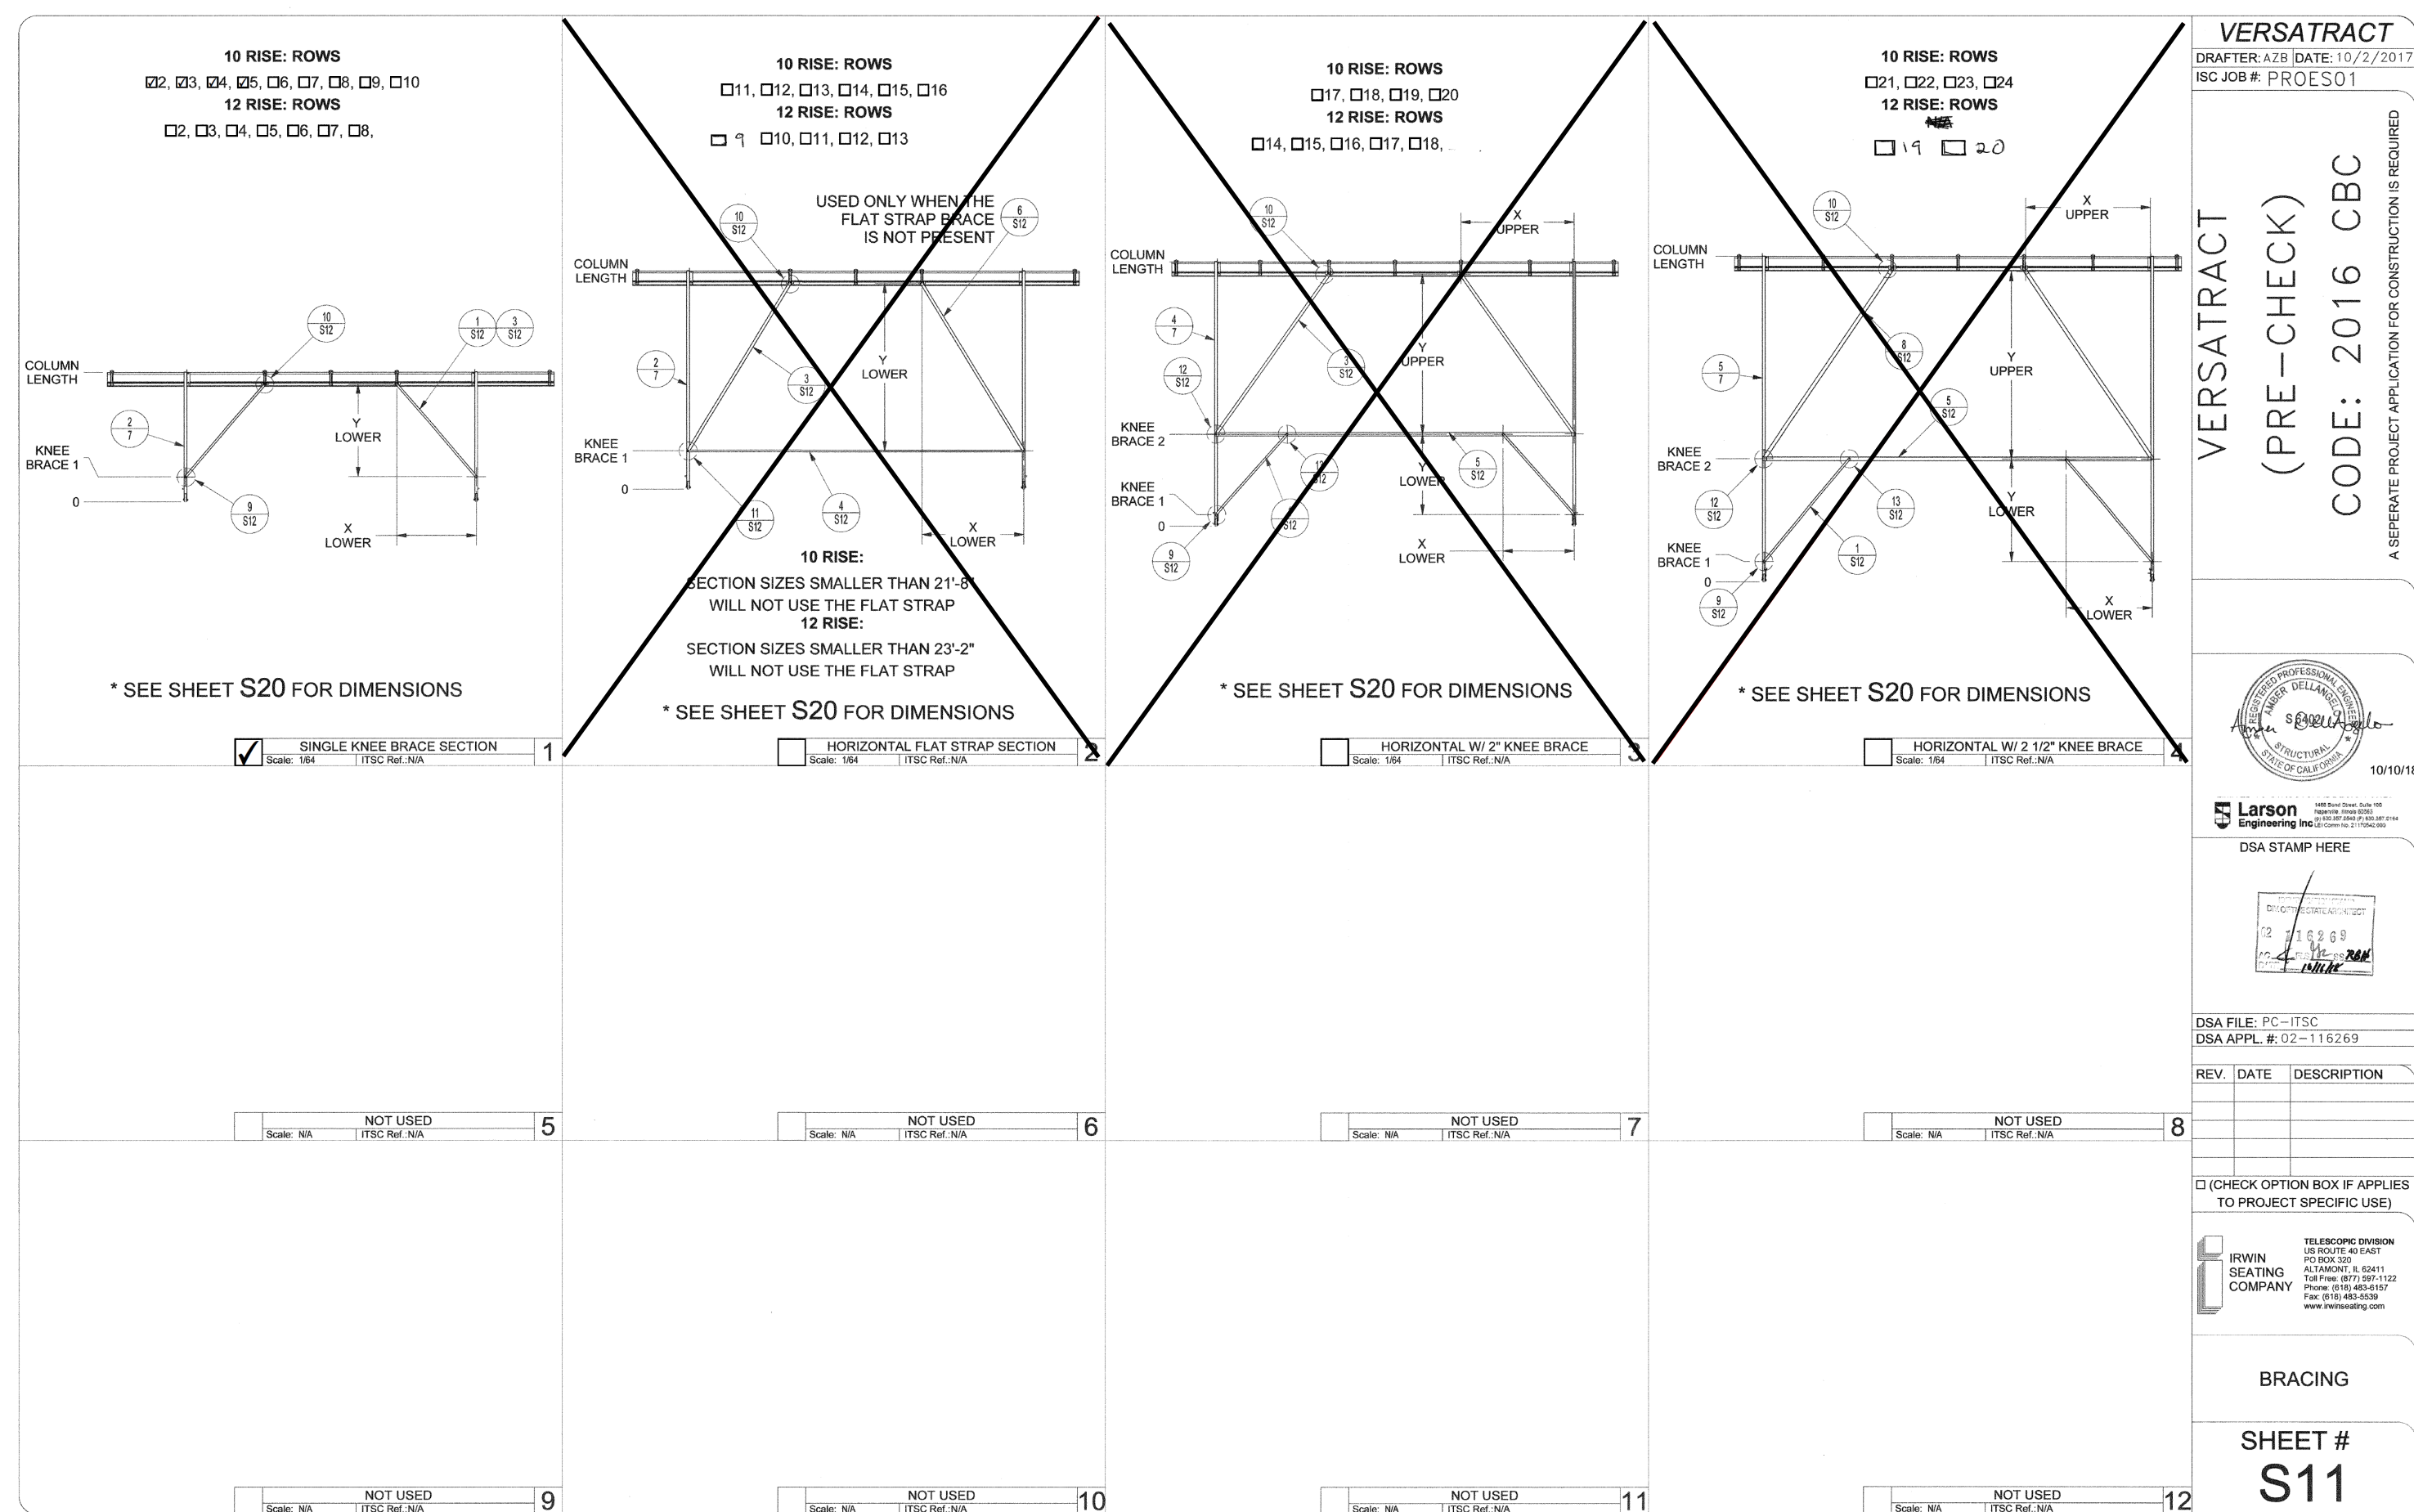

QUATTROCCHI KWOK  
ARCHITECTS

**Main:**  
636 Fifth Street, Santa Rosa, CA 95404

**East Bay:**  
55 Harrison Street, Suite 525,  
Oakland, CA 94607  
(707) 576-0829

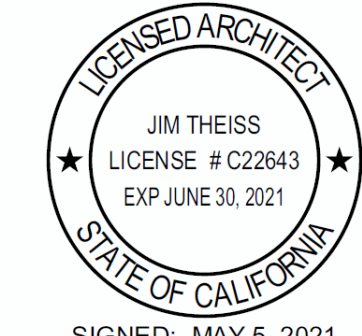

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**FREEDOM  
HIGH SCHOOL**

## NEW AUXILIARY GYMNASIUM

1050 NEROLY RD,  
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ARCH PROJECT NO: 1869.00

DRAWN BY:

DRAWING SCALE:

PTN: 61721-78 FILE NO: 7-H4

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APRIL 27, 2021



SHEET TITLE

S11: BRACING  
S12: BRACING CONT.

SHEET NUMBER

**B7**




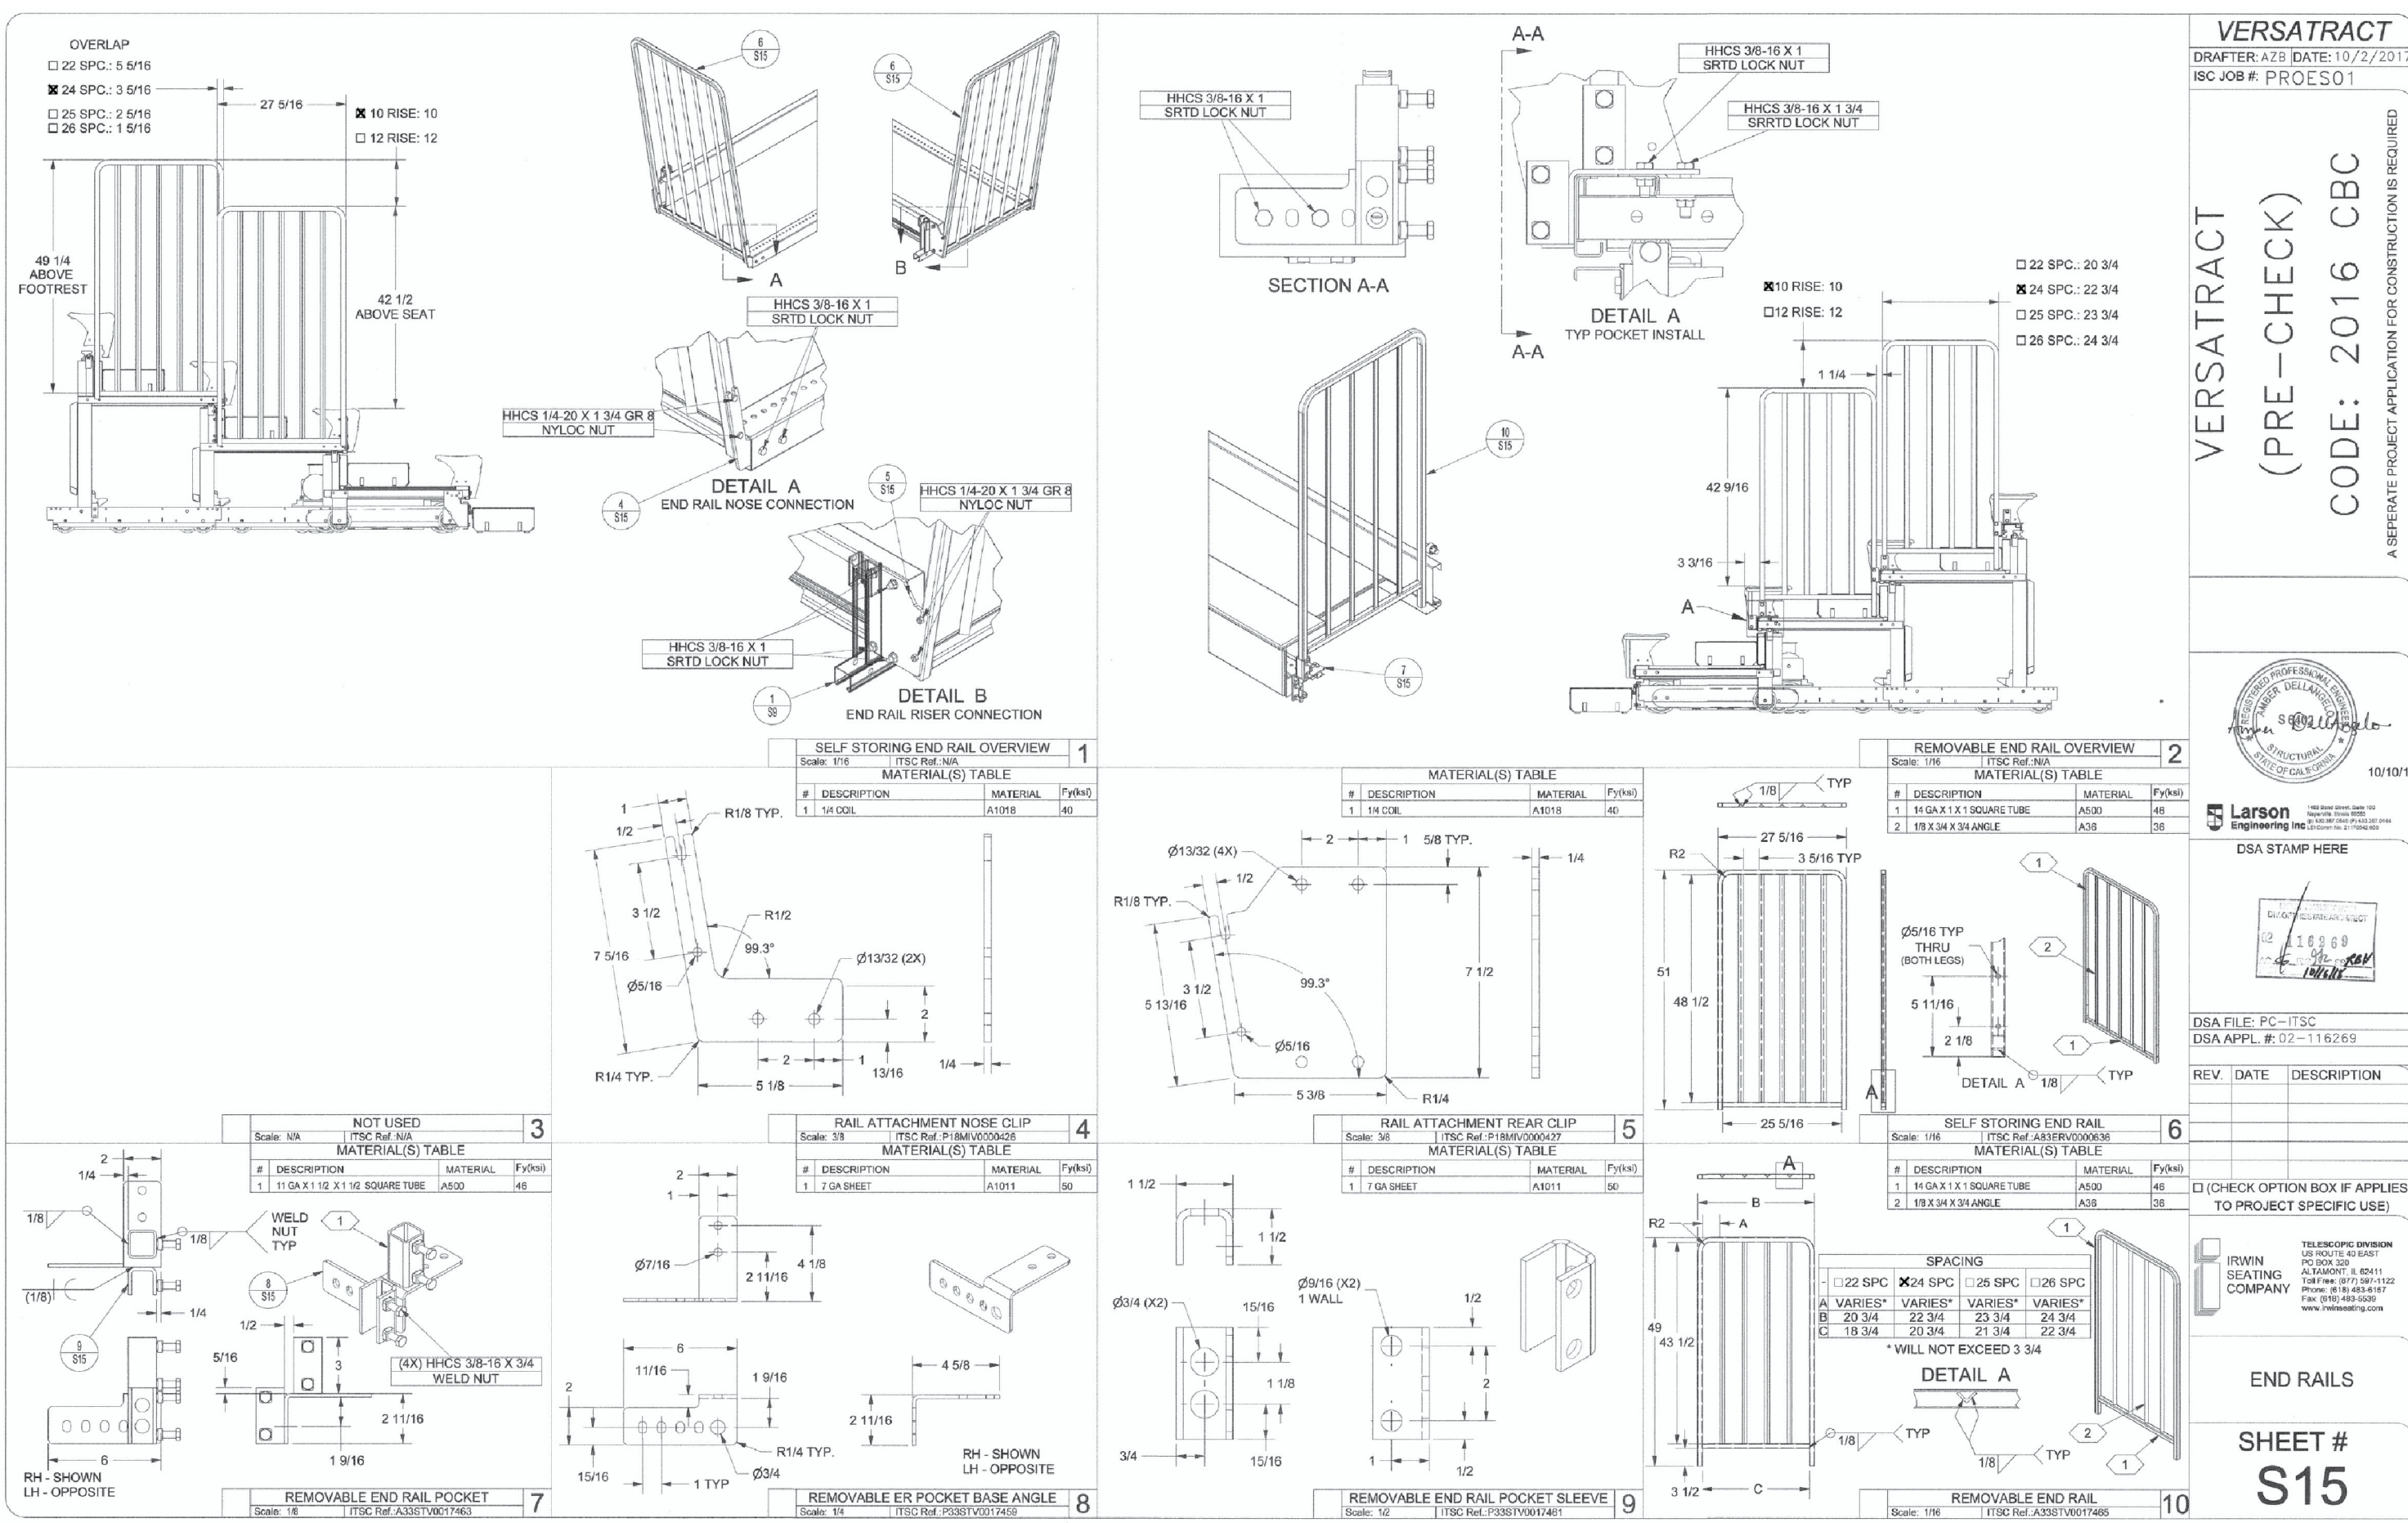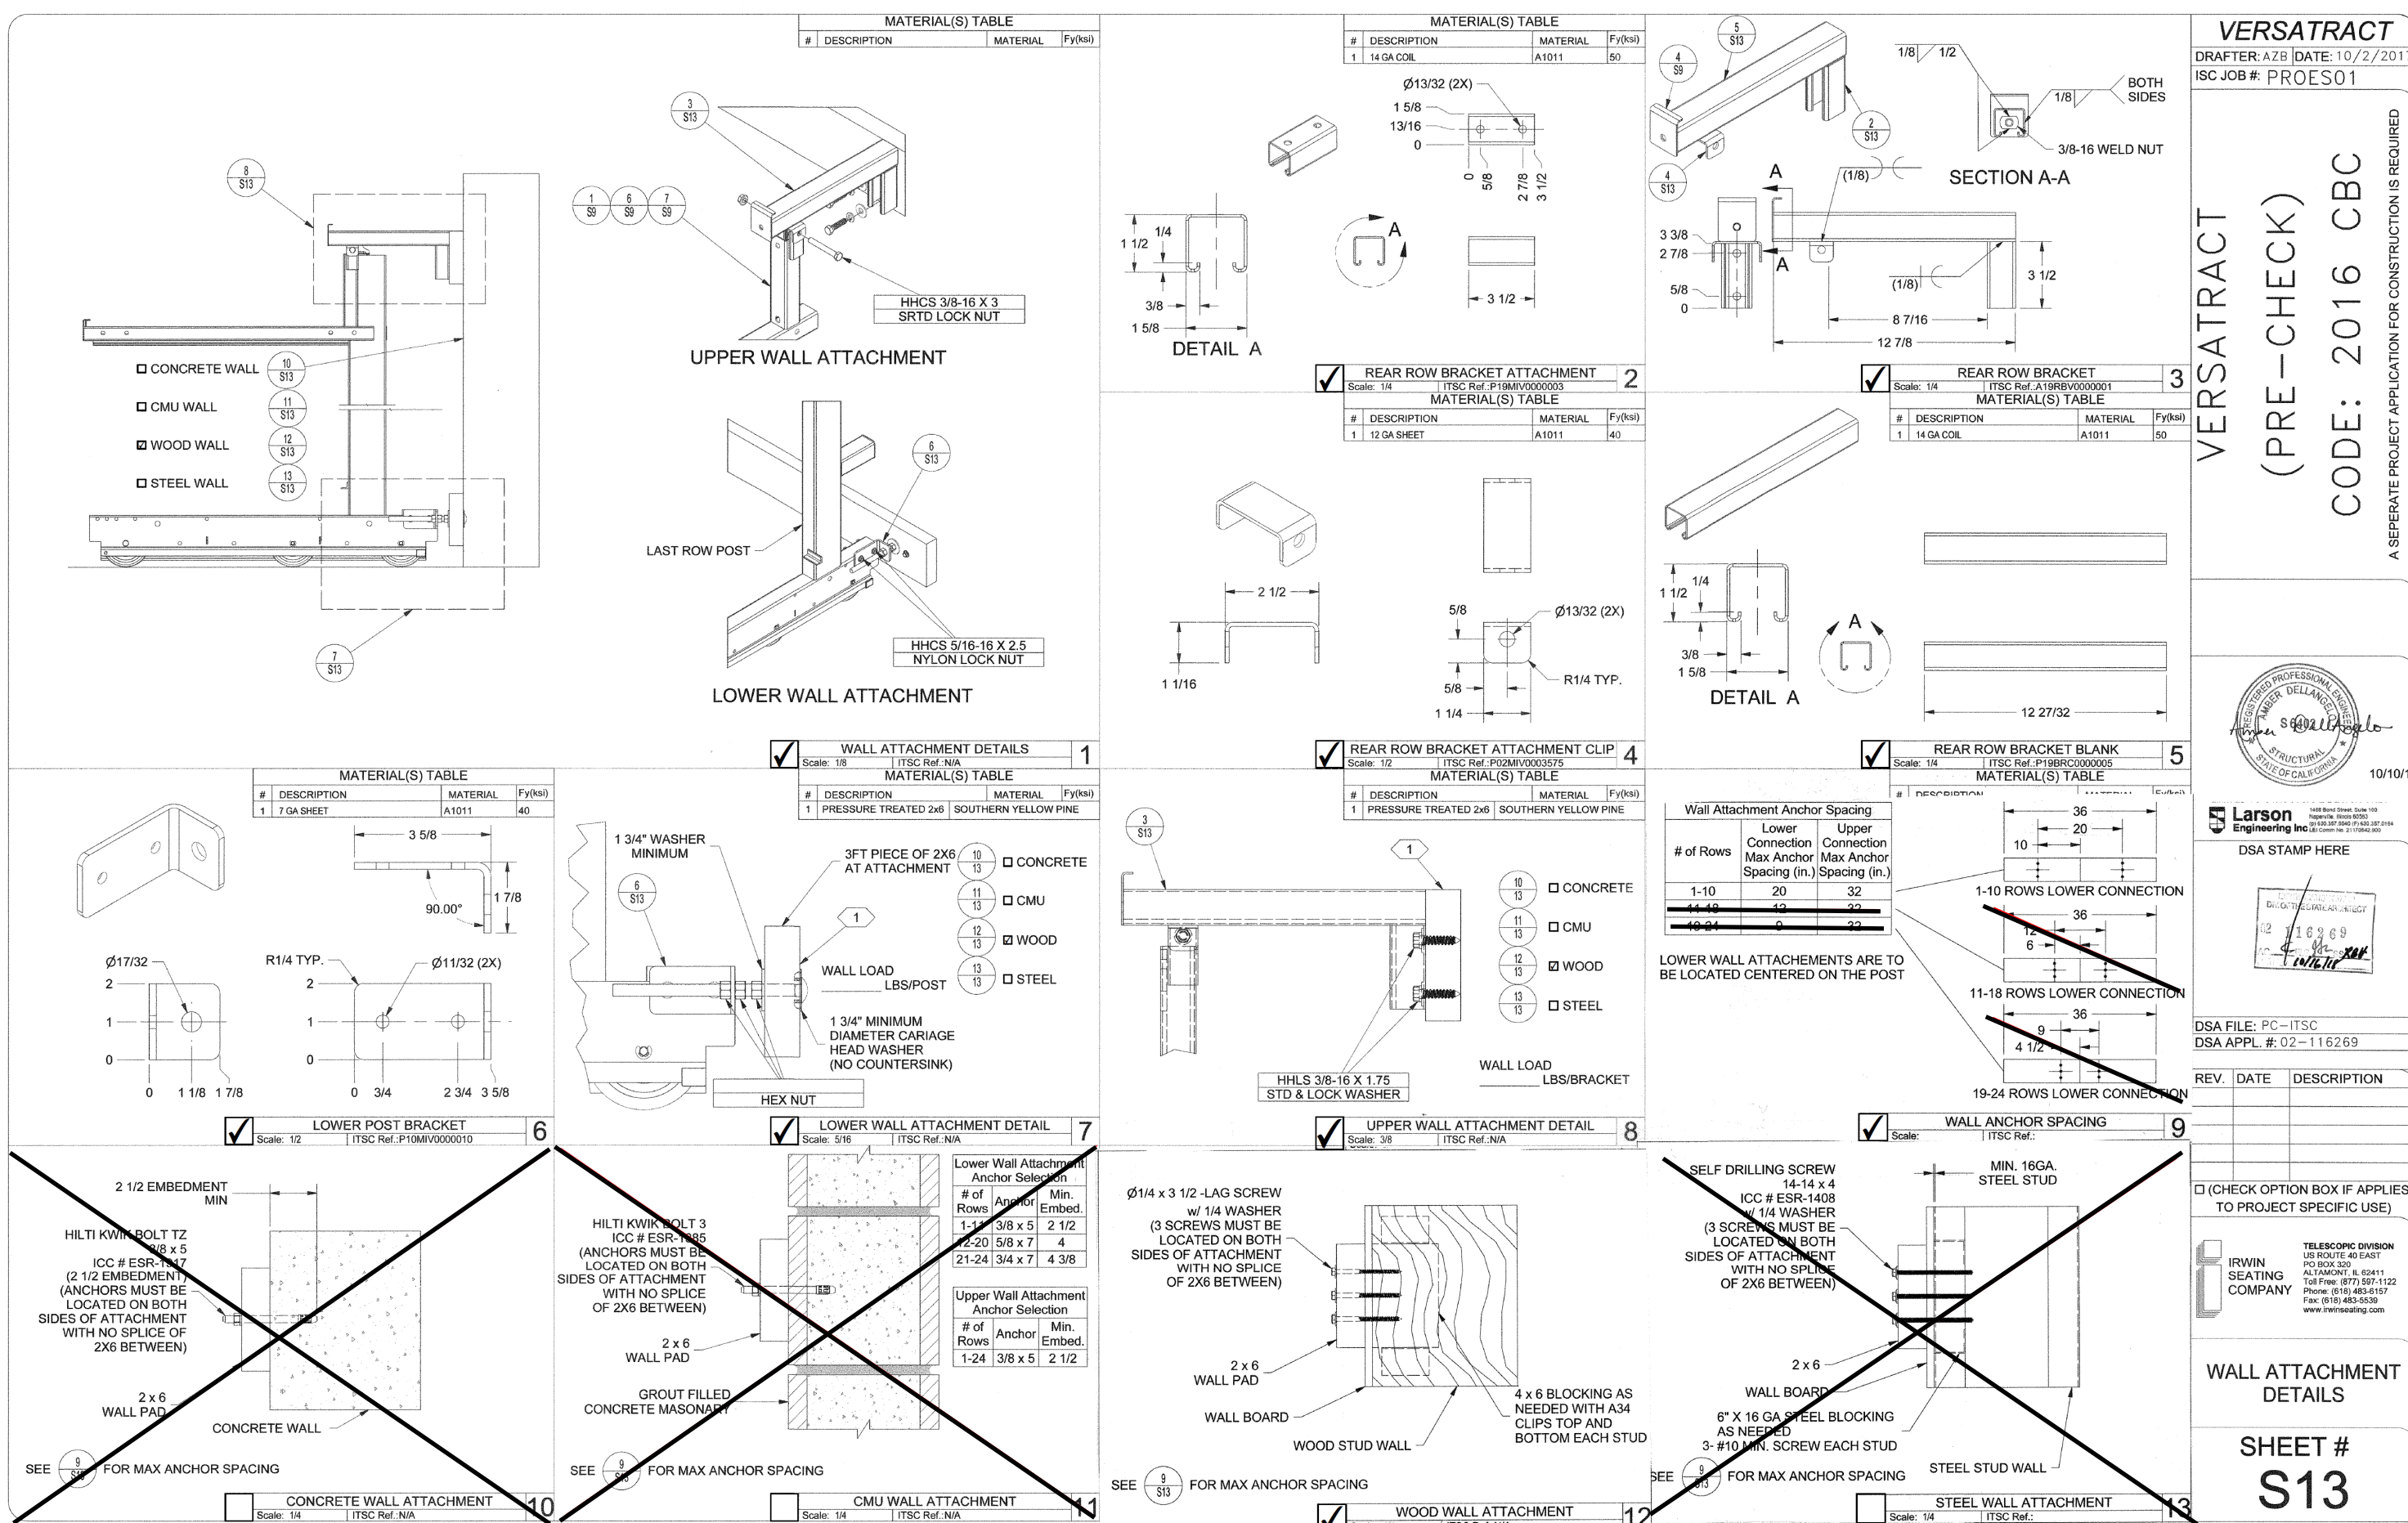

QUATTROCCHI KWOK  
ARCHITECTS

**Main:**  
636 Fifth Street, Santa Rosa, CA 95404

**East Bay:**  
55 Harrison Street, Suite 525,  
Oakland, CA 94607  
(707) 576-0829

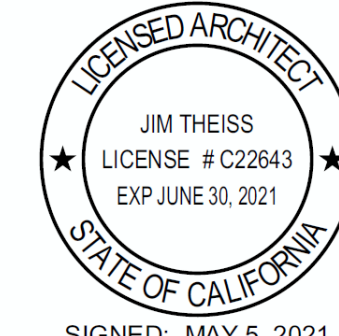

SIGNED: MAY 5, 2021

**FREEDOM  
HIGH SCHOOL**

## NEW AUXILIARY GYMNASIUM

1050 NEROLY RD,  
OAKLEY, CA 94561

LIBERTY UNION  
HIGH SCHOOL  
DISTRICT[illegible]

DSA APP NO. 01-119278

ARCH PROJECT NO: 1869.00

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DRAWING SCALE: _____

PTN: 01721-78 FILE NO: 7-114

BID DOCUMENT

APRIL 27, 2021


SHEET TITLE

S13: WALL ATTACHMENT  
DETAILS  
S15: END RAILS

SHEET NUMBER


**B8**



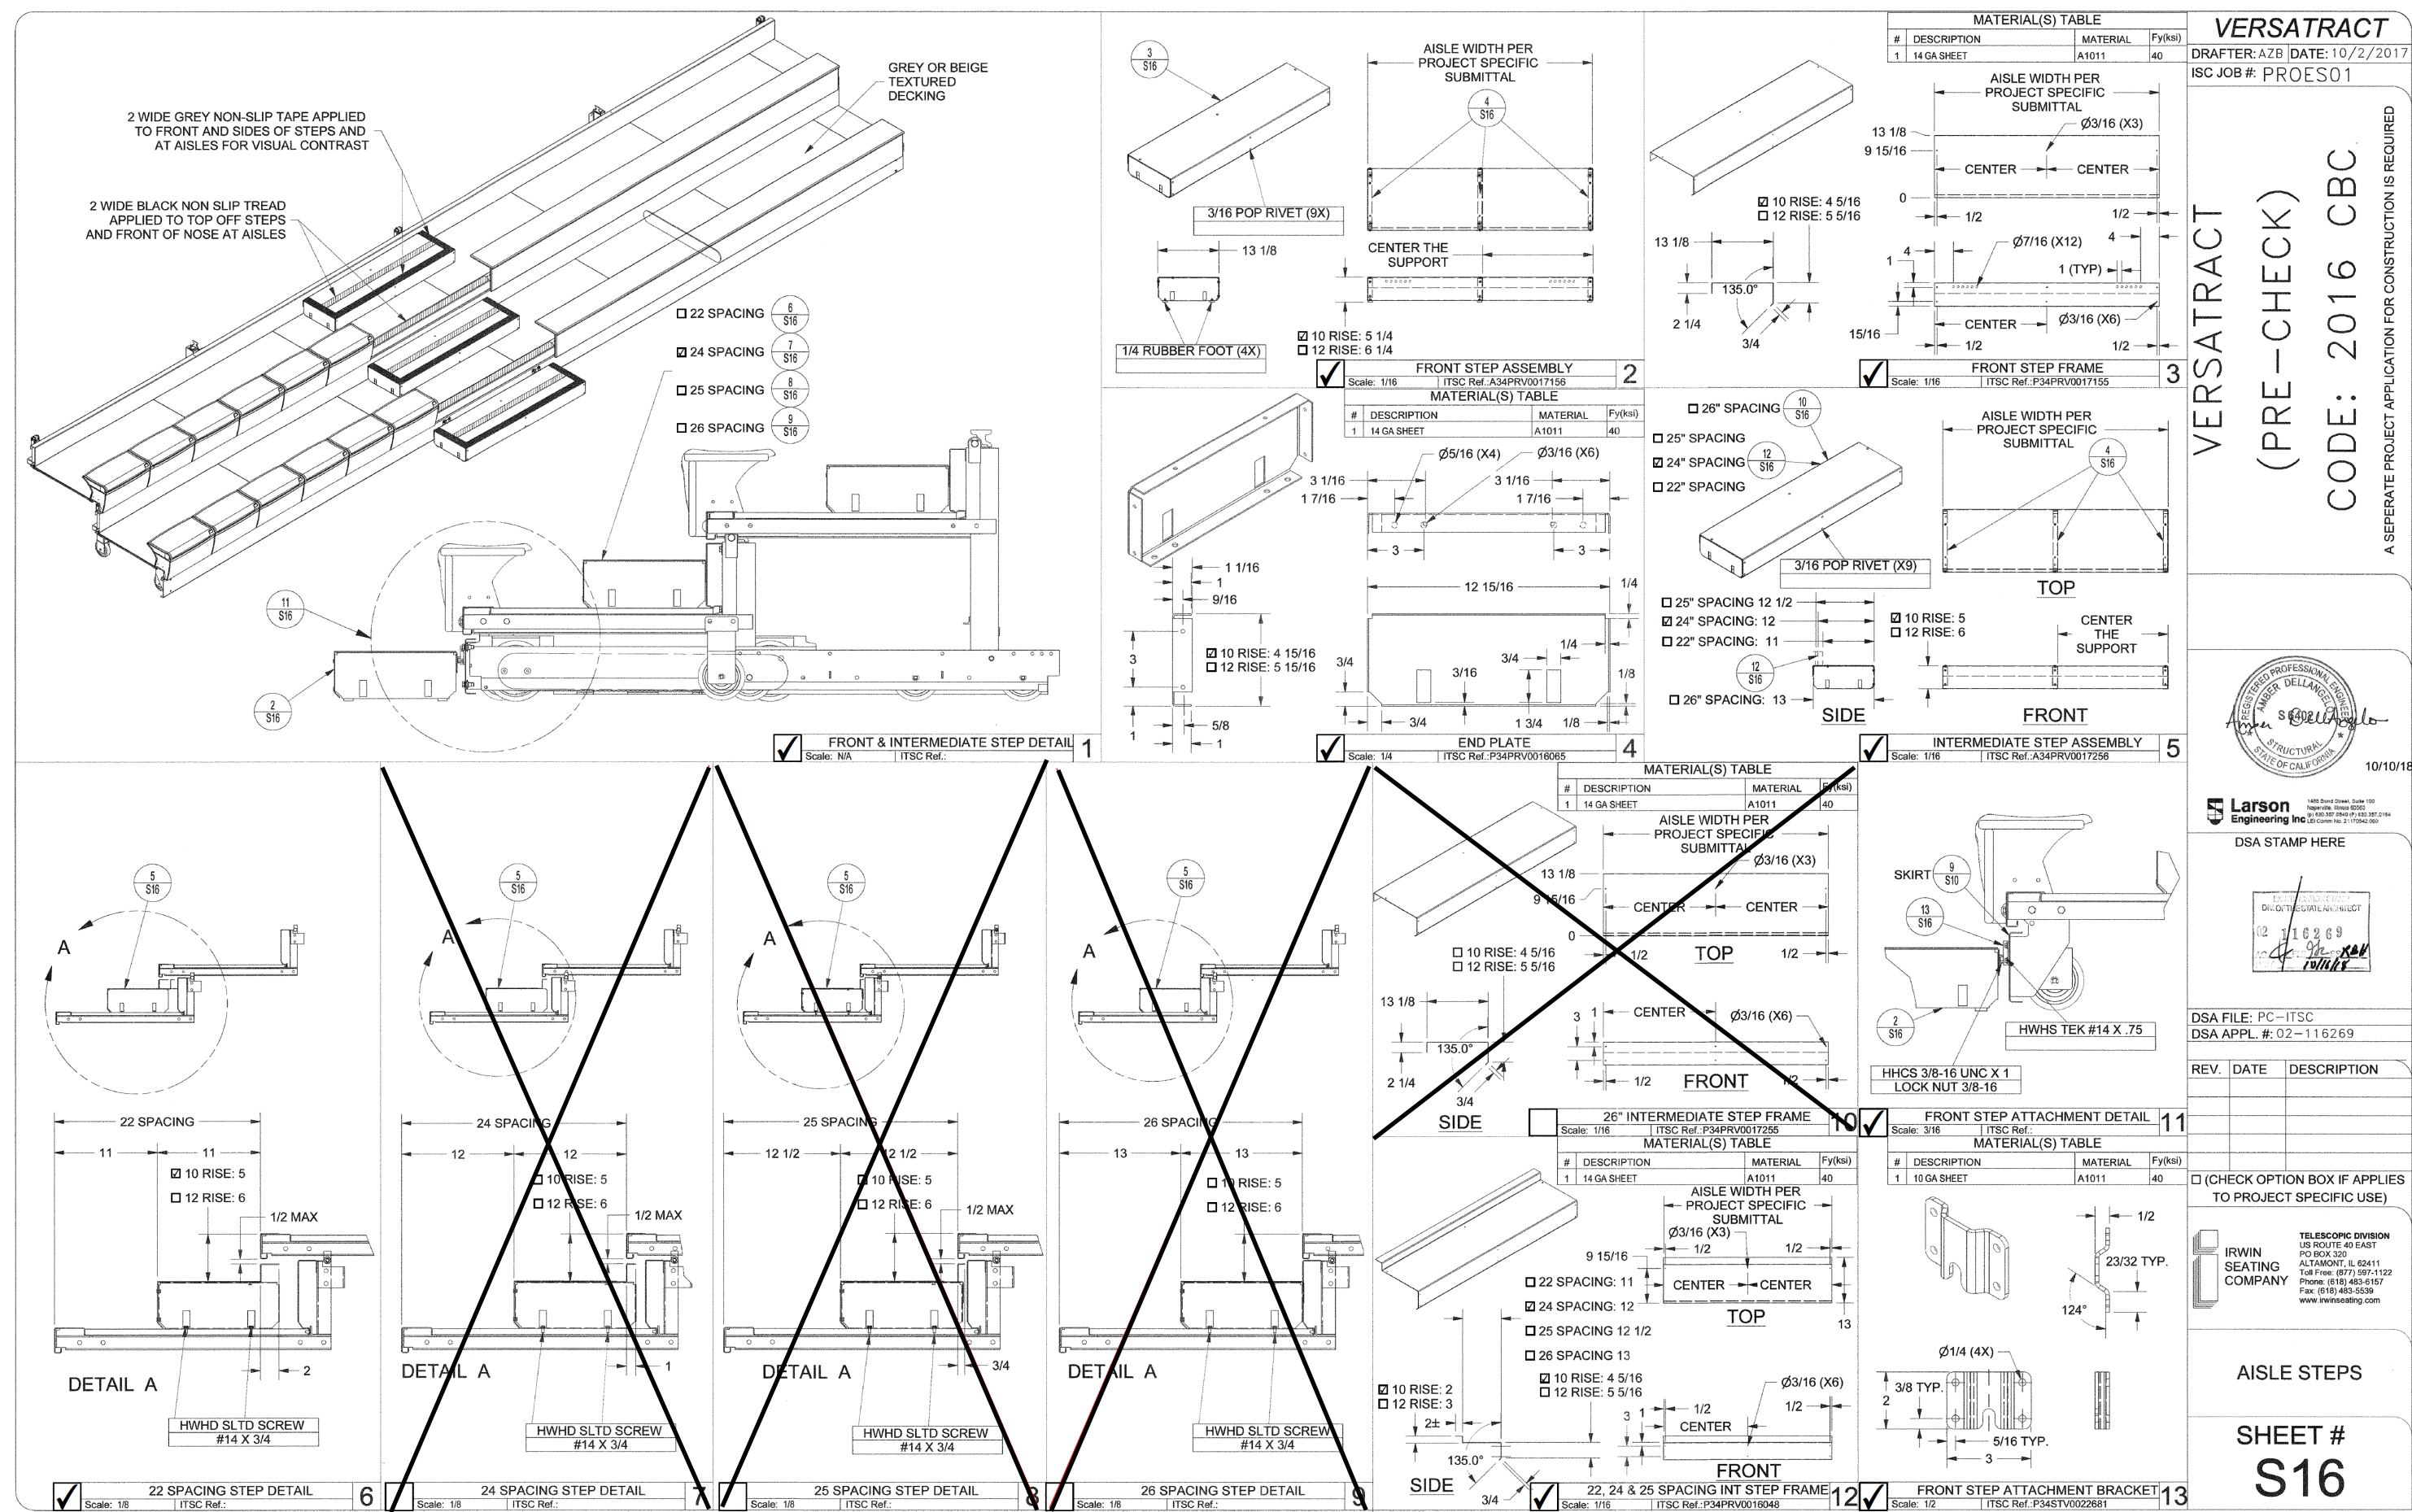

**Main:**  
636 Fifth Street, Santa Rosa, CA 95404

**East Bay:**  
55 Harrison Street, Suite 525,  
Oakland, CA 94607  
(707) 576-0829

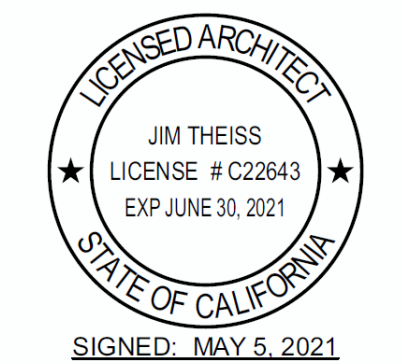

**FREEDOM  
HIGH SCHOOL**

## NEW AUXILIARY GYMNASIUM

1050 NEROLY RD,  
OAKLEY, CA 94561

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HIGH SCHOOL  
DISTRICT[illegible]

DSA APP NO. 01-119278

ARCH PROJECT NO: 1869.00

DRAWN BY:

DRAWING SCALE:

PTN: 61721-78

FILE NO: 7-H4

BID DOCUMENT

APRIL 27, 2021

**SHEET TITLE**



**S16: AISLE STEPS**

S17: AISLE HAND RAIL

SHEET NUMBER

**B9**



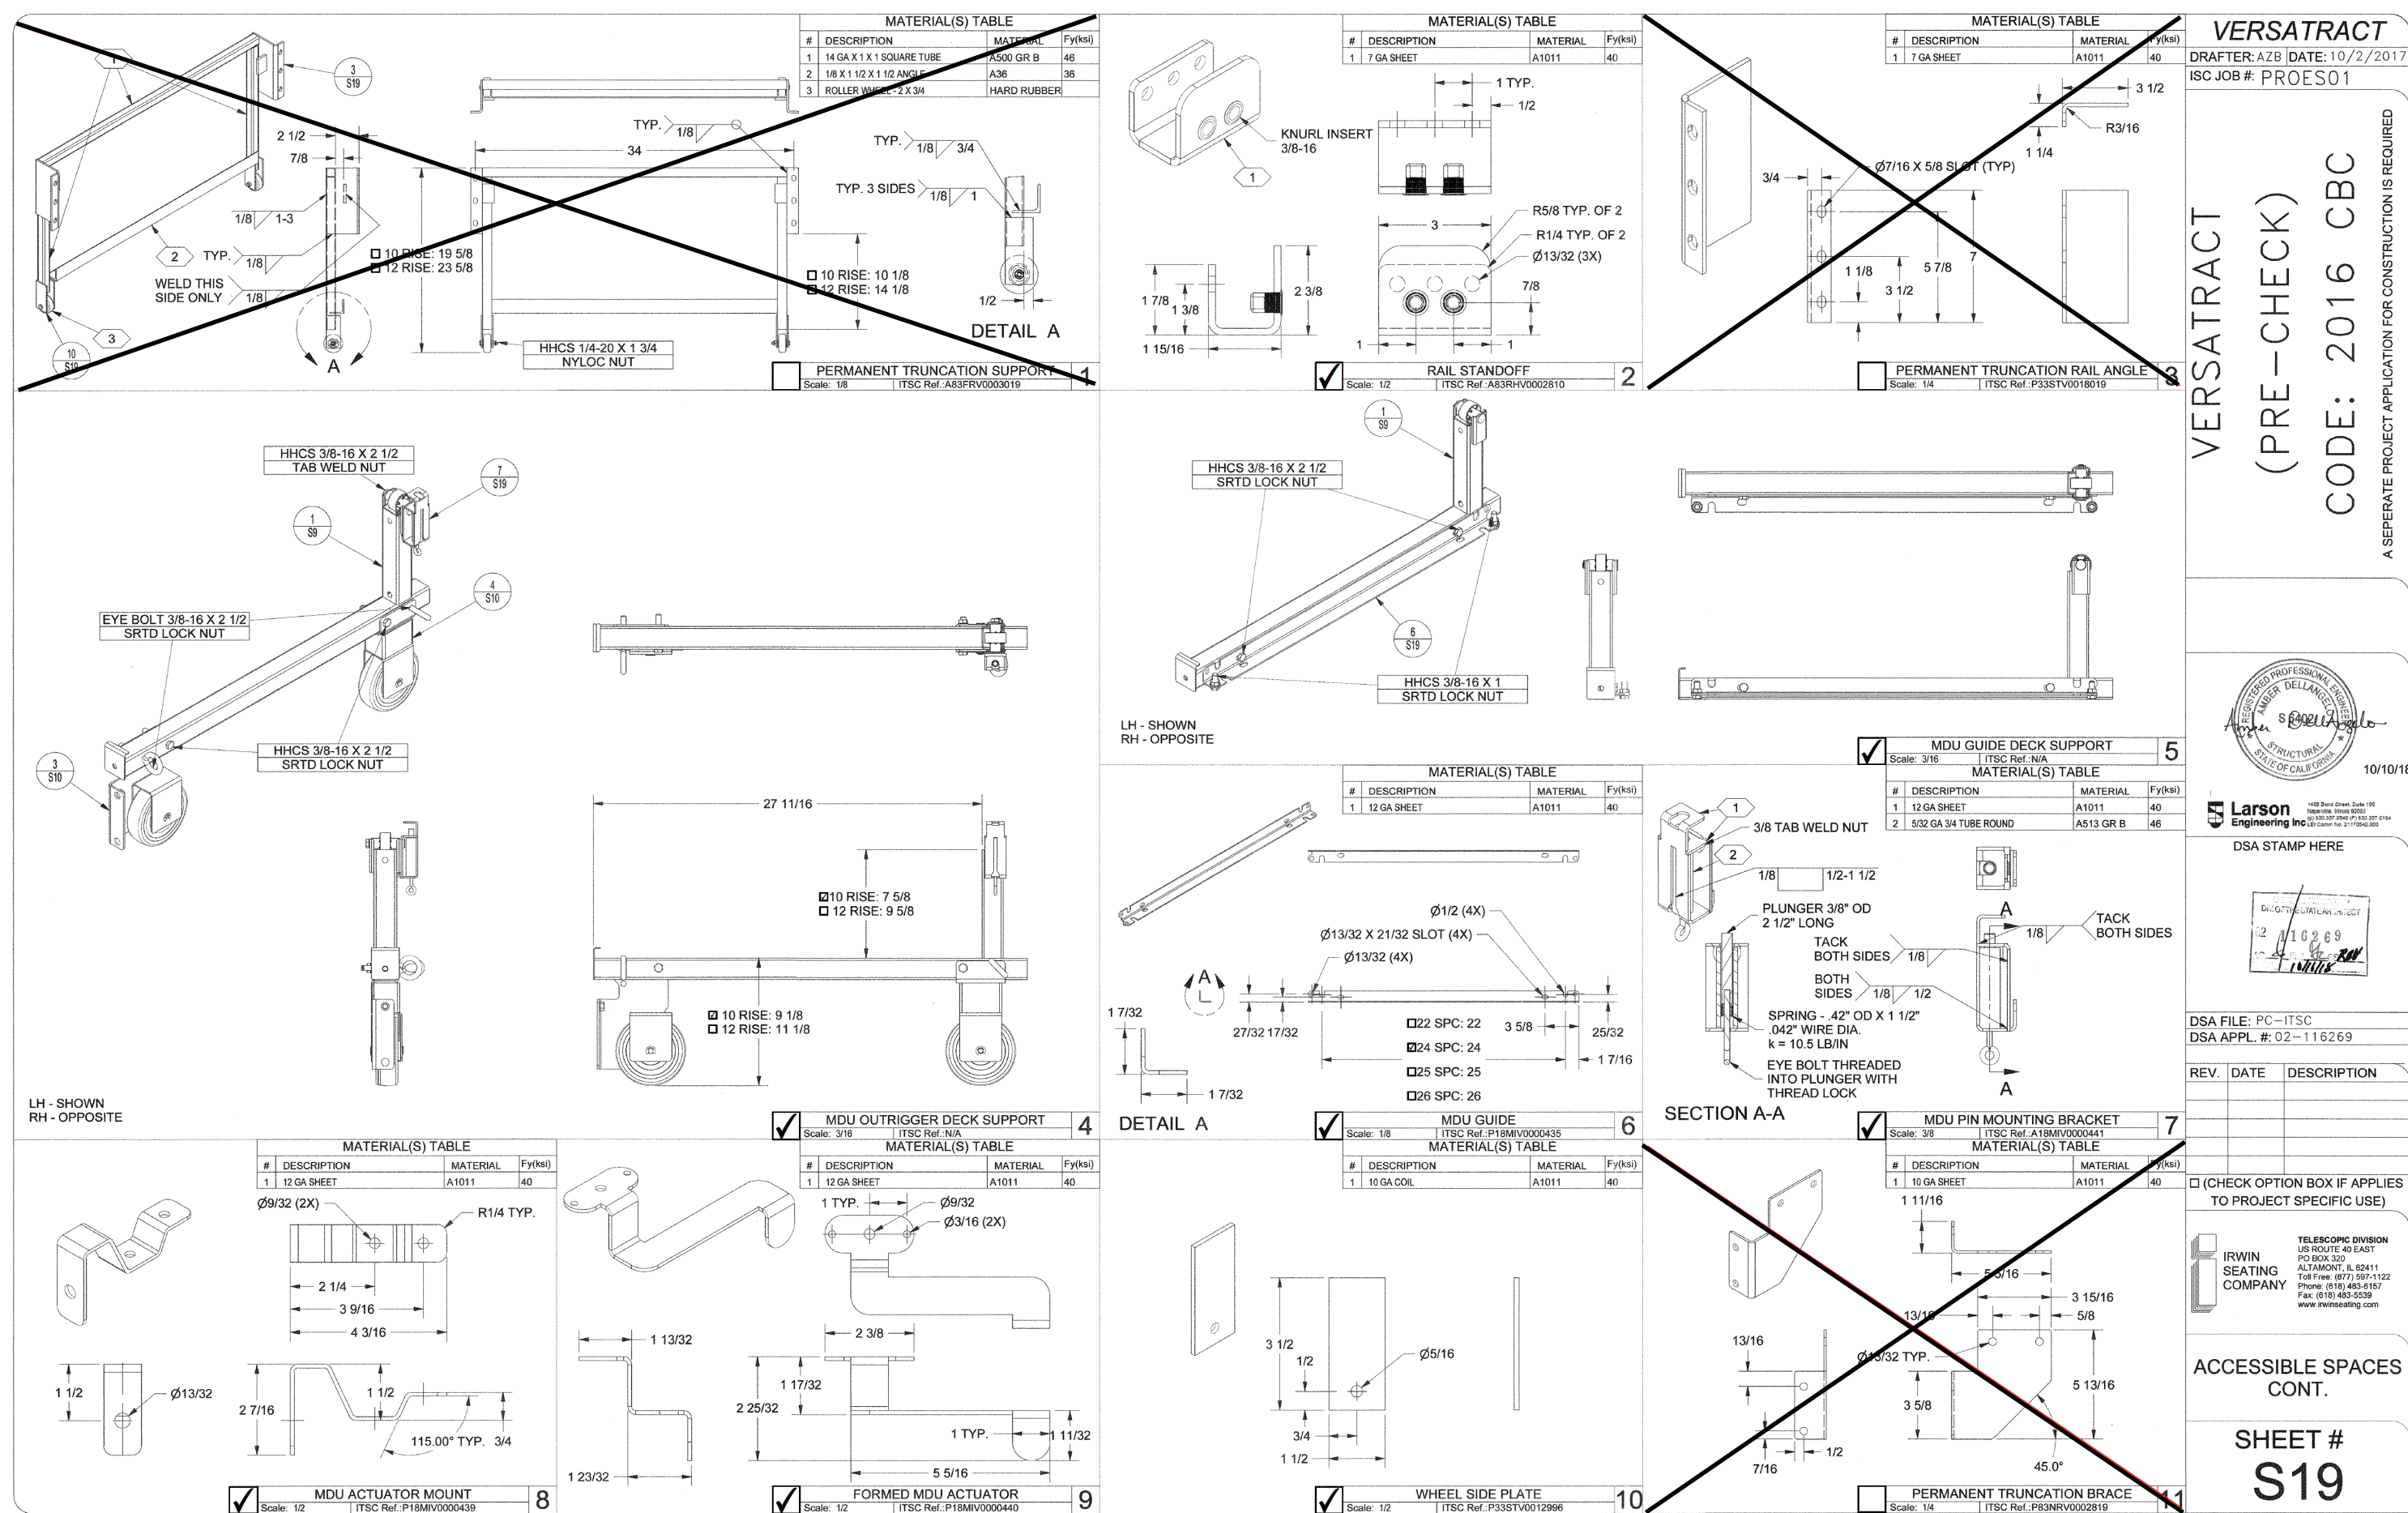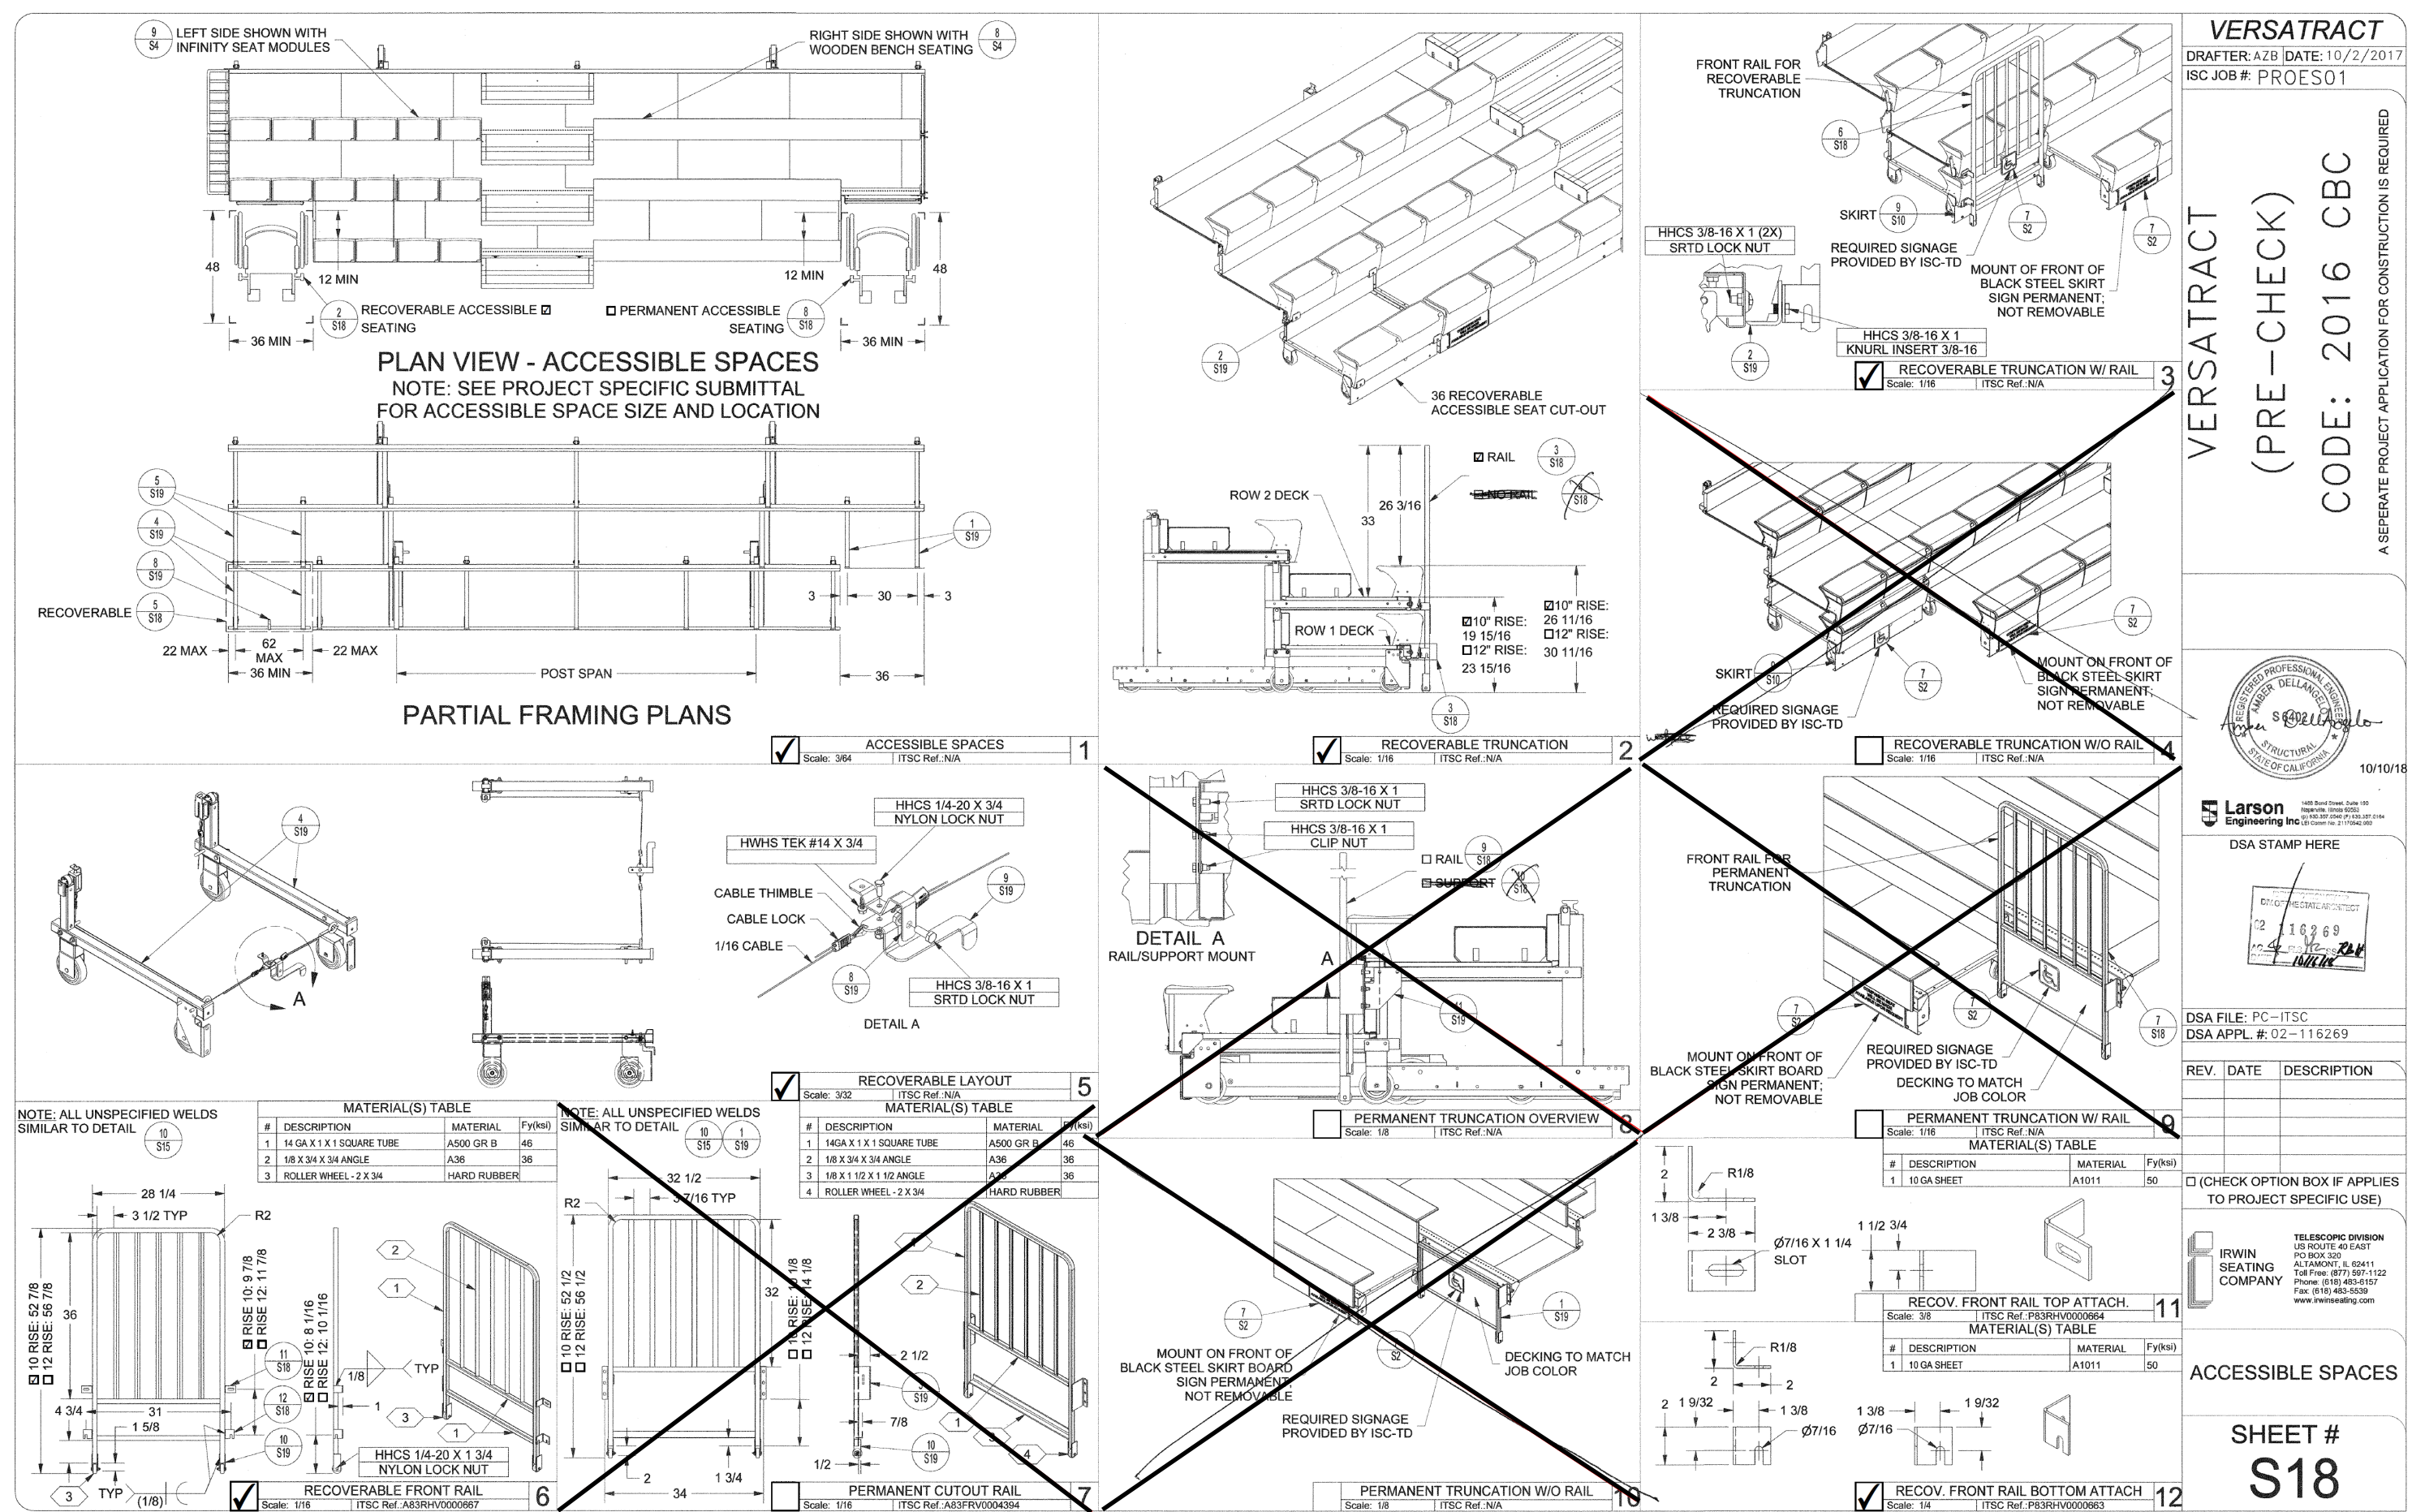


QUATTROCCHI KWOK  
ARCHITECTS

**Main:**  
636 Fifth Street, Santa Rosa, CA 95404

**East Bay:**  
55 Harrison Street, Suite 525,  
Oakland, CA 94607  
(707) 576-0829



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DSA APP NO. 01-119278

ARCH PROJECT NO: 1869.00

DRAWN BY:

DRAWING SCALE:

PTN: 61721-78 FILE NO: 7-H4

BID DOCUMENT

APRIL 27, 2021

**SHEET TITLE**

## S18: ACCESSIBLE SPACES

**S19: ACCESSIBLE SPACES  
CONT.**

SHEET NUMBER

# B10



**VERSATRAC**  
(PRE - CHECK)

**DATE:** 10/17/2017  
**ISS JOB #:** PROES01

**CODE:** 2016 CBC

A SEPARATE PROJECT APPLICATION FOR CONSTRUCTION IS REQUIRED



10/17/2017



USA STAMP HERE



**DSA FILE #:** 0.07-116269  
**PC NUMBER:**  
**REV.** **DATE** **DESCRIPTION**


☐ (CHECK OPTION BOX IF APPLIES TO PROJECT SPECIFIC USE)



TO BE COMPLETED BY:  
 IRWIN SEALING  
 10000 W. 10TH AVE  
 FARMER, TEXAS 79040  
 TEL: 817-434-0022  
 FAX: 817-434-0022  
[www.irwinsealing.com](http://www.irwinsealing.com)

**DIMENSIONS**

**SHEET #**  
**S20**

## SHEET TITLE

SHEET NUMBER

D11

# B11

## DATA

_____

_____



Project Name:	Freedom High School Auxiliary Gym	NRCC-PRF-01-E	Page 1 of 15
Project Address:	1050 Neroly Road Oakley 94561	Calculation Date/Time:	12:27, Tue, Dec 22, 2020
Input File Name:	Freedom High Auxiliary Gym.cbd19x		

A. GENERAL INFORMATION			
1. Project Location (city)	Oakley	8. Standards Version	Compliance2019
2. CA Zip Code	94561	9. Compliance Software (version)	EnergyPro 8.2
3. Climate Zone	12	10. Weather File	CONCORD_724936_CZ2010.epw
4. Total Conditioned Floor Area in Scope	9,848 ft²	11. Building Orientation (deg)	(N) 0 deg
5. Total Unconditioned Floor Area	0 ft²	12. Permitted Scope of Work	NewEnvelopeAndMechanical
6. Total # of Stories (Habitable Above Grade)	1	13 Building Type(s)	Nonresidential
7. Total # of dwelling units	0	14 Gas Type	NaturalGas

B. PROJECT SUMMARY			
Table Instructions: Table B shows which building components are included in the performance calculation. If indicated as not included, the project must show compliance prescriptively if within permit application.			
Envelope (see Table G)	Building Components Complying via Performance		Building Components Complying Prescriptively
	<input checked="" type="checkbox"/> Performance	Covered Process: Commercial Kitchens	<input type="checkbox"/> Performance The following building components are ONLY eligible for prescriptive compliance and should be documented on the NRCC form listed if within the scope of the permit application (i.e. compliance will not be shown on the NRCC-PRF-E).
	<input type="checkbox"/> Not included		<input checked="" type="checkbox"/> Not included
	<input checked="" type="checkbox"/> Performance	Covered Process: Computer Rooms	<input type="checkbox"/> Performance Indoor Lighting (Unconditioned)\$140.6 NRCC-L7J-E
Mechanical (see Table H)	<input type="checkbox"/> Not included		<input checked="" type="checkbox"/> Not included Outdoor Lighting \$140.7 NRCC-L7O-E
Domestic Hot Water (see Table I)	<input checked="" type="checkbox"/> Performance	Covered Process: Laboratory Exhaust	<input type="checkbox"/> Performance Sign Lighting \$140.8 NRCC-L7S-E
	<input type="checkbox"/> Not included		<input checked="" type="checkbox"/> Not included Mandatory Measures
Lighting (Indoor Conditioned, see Table K)	<input type="checkbox"/> Performance		Electrical power systems, commissioning, solar ready, elevator and escalator requirements are mandatory and should on the NRCC form listed if applicable (i.e. compliance will not be shown on the NRCC-PRF-E)
	<input checked="" type="checkbox"/> Not included		Electrical Power Distribution \$110.11 NRCC-ELC-E is required
Solar Thermal Water Heating (see Table L)	<input type="checkbox"/> Performance		Commissioning \$120.8 NRCC-CMR-E is required
	<input checked="" type="checkbox"/> Not included		Solar Ready \$110.10 NRCC-SRA-E is required

CA Building Energy Efficiency Standards- 2019 Nonresidential Compliance Report Version: NRCC-PRF-01-E-10092020-6384 Report Generated at: 2020-12-22 12:27:58

Project Name:	Freedom High School Auxiliary Gym	NRCC-PRF-01-E	Page 4 of 15
Project Address:	1050 Neroly Road Oakley 94561	Calculation Date/Time:	12:27, Tue, Dec 22, 2020
Input File Name:	Freedom High Auxiliary Gym.cbd19x		

E. HERS VERIFICATION	
This Section Does Not Apply	
F. ADDITIONAL REMARKS	
This Section Does Not Apply	

G1. ENVELOPE GENERAL INFORMATION (conditioned spaces only)			
1	2	3	4
Opaque Surfaces & Orientation	Total Gross Surface Area (ft²)	Total Fenestration Area (ft²)	Window to Wall Ratio (%)
North-Facing¹	3,856 ft²	32 ft²	00.8%
East-Facing²	2,081 ft²	90 ft²	04.3%
South-Facing³	3,856 ft²	116 ft²	03.0%
West-Facing⁴	2,080 ft²	84 ft²	04.0%
Total	11,873 ft²	322 ft²	02.7%
Roof	10,448 ft²	16 ft²	00.2%

Notes:  
¹ North-Facing is oriented to within 45 degrees of true north, including 45°00'00" east of north (NE), but excluding 45°00'00" west of north (NW).  
² East-Facing is oriented to within 45 degrees of true east, including 45°00'00" south of east (SE), but excluding 45°00'00" north of east (NE).  
³ South-Facing is oriented to within 45 degrees of true south, including 45°00'00" west of south (SW), but excluding 45°00'00" east of south (SE).  
⁴ West-Facing is oriented to within 45 degrees of true west, including 45°00'00" north of due west (NW), but excluding 45°00'00" south of west (SW).

G2. CRRC ROOFING PRODUCT SUMMARY				
1	2	3	4	5
Assembly Name	Roof Pitch	Aged Solar Reflectance	Thermal Emittance	SRI
BUR Roof rigid insulation35	Low Slope	0.63	0.75	Not Provided

CA Building Energy Efficiency Standards- 2019 Nonresidential Compliance Report Version: NRCC-PRF-01-E-10092020-6384 Report Generated at: 2020-12-22 12:27:58

Project Name:	Freedom High School Auxiliary Gym	NRCC-PRF-01-E	Page 7 of 15
Project Address:	1050 Neroly Road Oakley 94561	Calculation Date/Time:	12:27, Tue, Dec 22, 2020
Input File Name:	Freedom High Auxiliary Gym.cbd19x		

H1. DRY SYSTEM EQUIPMENT (furnaces, air handling units, heat pumps, VRF, economizers etc.)									
Dry System Equipment¹ (Fan & Economizer info included below in Table N)									
1	2	3	4	5	6	7	8	9	10
Equipment Name	Equipment Type	Qty	Total Heating Output (kBtu/h)	Heating Supp Heat Source (V/N)	Supp Heat Output (kBtu/h)	Efficiency	Total Cooling Output (kBtu/h)	Cooling Efficiency	STATUS
AC3	SZAC (Packaged3Phase)	1	67	No	0	AFUE-81.0	60	SEER-16.00 / EER-11.70	N
HP-FC1	SZHP (Split1Phase)	1	10	No	0	HSPF-8.200	11	SEER-14.000 / EER-13.000	N
HP-FC2	SZHP (Split1Phase)	1	22	No	0	HSPF-8.200	18	SEER-14.000 / EER-12.700	N

¹ Status: N - New, A - Altered, E - Existing

H2. FAN SYSTEMS SUMMARY¹												
1	2	3	4	5	6	7	8	9	10	11	12	13
Name or Item Tag	System Type packaged, DOAS, etc.	Design OA CFM	Supply Fan CFM	BHP	Watts	Control	CFM	BHP	Watts	Control	Economizer Type (if present)	STATUS
AC1 and 2	SZAC	1800	5000	2,500	2082.7	ConstantVolume	NA	NA	NA	NA	FixedDryRebult	N
AC3	SZAC	697	2000	1,000	862.0	ConstantVolume	NA	NA	NA	NA	FixedDryRebult	N
HP-FC1	SZHP	19	378	0.160	139.9	ConstantVolume	NA	NA	NA	NA	NoEconomizer	N
HP-FC2	SZHP	0	484	0.206	179.9	ConstantVolume	NA	NA	NA	NA	NoEconomizer	N

¹ Status: N - New, A - Altered, E - Existing

H3. EXHAUST FAN SUMMARY						
1	2	3	4	5	6	7
System ID	Zone Name	Qty	CFM	Motor BHP	Motor Watts	Total Static Pressure (in H2O)
104 Custodian42	2-107 Classroom	1	150	0.046	40.0	1.26

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Project Name:	Freedom High School Auxiliary Gym	NRCC-PRF-01-E	Page 2 of 15
Project Address:	1050 Neroly Road Oakley 94561	Calculation Date/Time:	12:27, Tue, Dec 22, 2020
Input File Name:	Freedom High Auxiliary Gym.cbd19x		

C1. COMPLIANCE RESULTS FOR PERFORMANCE COMPONENTS (Annual TDV Energy Use, kBtu/ft²-yr)			
COMPLIES			
Energy Component	Standard Design (TDV)	Proposed Design (TDV)	Compliance Margin (TDV)¹
Space Heating	16.01	4.26	11.75
Space Cooling	87.91	76.85	11.06
Indoor Fans	97.58	88.87	8.71
Heat Rejection	--	--	--
Pumps & Misc.	--	--	--
Domestic Hot Water	7.58	10.68	-3.10
Indoor Lighting	71.79	71.79	--
ENERGY STANDARDS COMPLIANCE TOTAL	280.87	252.45	28.42 (10.1%)

¹ Notes: The number in parenthesis following the Compliance Margin in column 4, represents the Percent Better than Standard.

C2. RESULTS FOR 'ABOVE CODE' QUALIFICATIONS¹			
<input type="checkbox"/> This project is pursuing CalGreen Tier 1		<input type="checkbox"/> This project is pursuing CalGreen Tier 2	
Miscellaneous Energy Component	Standard Design (TDV)	Proposed Design (TDV)	Compliance Margin (TDV)¹
Receptacle	100.59	100.59	--
Process	--	--	--
Other Ltg	--	--	--
Process Motors	--	--	--
COMPLIANCE TOTAL PLUS MISCELLANEOUS COMPONENTS	381.46	353.04	28.4 (7.5%)

¹ Notes: This table is used to document compliance with programs OTHER THAN Title 24 Part 6, if applicable.

CA Building Energy Efficiency Standards- 2019 Nonresidential Compliance Report Version: NRCC-PRF-01-E-10092020-6384 Report Generated at: 2020-12-22 12:27:58

Project Name:	Freedom High School Auxiliary Gym	NRCC-PRF-01-E	Page 5 of 15
Project Address:	1050 Neroly Road Oakley 94561	Calculation Date/Time:	12:27, Tue, Dec 22, 2020
Input File Name:	Freedom High Auxiliary Gym.cbd19x		

G3. OPAQUE SURFACE ASSEMBLY SUMMARY								
1	2	3	4	5	6	7	8	9
Surface Name	Surface Type	Area (ft²)	Framing Type	Cavity R-Value	Continuous R-Value	U-Factor / F-Factor / C-Factor	SPRINKLER	Description of Assembly Layers
R-19 Wall gym8	ExteriorWall	9274	Wood	19	NA	U-Factor: 0.060	N	Stucco - 7/8 in. Plywood - 5/8 in. Wood framed wall, 24in. OC, 7.25in., R-19 Gypsum Board - 5/8 in.
Gymnasium Metal Roof17	Roof	7800	NA	0	34	U-Factor: 0.027	N	Metal Standing Seam - 1/16 in. Fiberboard sheathing - 1/2 in. Compliance Insulation R34.00 Gypsum Board - 5/8 in. Metal Deck - 1/16 in.
Slab On Grade22	UndergroundFloor	9848	NA	0	NA	F-Factor: 0.730	N	Slab Type = UnheatedSlabOnGrade Insulation Orientation = None Insulation R-Value = R0
R-19 Wall26	ExteriorWall	2599	Wood	19	NA	U-Factor: 0.067	N	Stucco - 7/8 in. Plywood - 5/8 in. Wood framed wall, 16in. OC, 5.5in., R-19 Gypsum Board - 5/8 in.
BUR Roof rigid insulation35	Roof	2648	NA	0	24	U-Factor: 0.037	N	Built-up roofing- 3/8 in. Fiberboard sheathing - 1/2 in. Compliance Insulation R24.00 Plywood - 3/4 in.
Interior R-0 Wall39	InteriorWall	300	NA	0	NA	U-Factor: 0.304	N	Gypsum Board - 5/8 in. Air Cavity - Wall Roof Ceiling - 4 in. or more Gypsum Board - 1/2 in.

¹ Status: N - New, A - Altered, E - Existing

G4. OPAQUE DOOR SUMMARY		
1	2	3
Assembly Name	Overall U-factor	Status¹
Metal Door55	0.700	N

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Input File Name:	Freedom High Auxiliary Gym.cbd19x		

H4. Wet System Equipment (boilers, chillers, cooling towers, etc.)											
1	2	3	4	5	6	7	8	9	10	11	12
Name or Item Tag	Equipment Type	Qty	Vol (gal)	Rated Capacity (kBtu/h)	Efficiency	Standby Loss	Pumps				Status
							Qty	GPM	HP	VSD [Y/N]	
Status: N = New, A = Altered, E = Existing											
H5. SYSTEM SPECIAL FEATURES											
1	2	3	4	5	6						
System Name	Optimum Start	Window Interlocks per §140.4(n)	Evaporative Cooling	Heat Recovery	Other Controls						
AC1 and 2	No Optimum Start	NA	No Evaporative Cooler	No Heat Recovery	1 Zones With CO2Sensor Vent. Control, No DDC Fixed Drybulb Economizer No Supply Air Temp. Control						
AC3	No Optimum Start	NA	No Evaporative Cooler	No Heat Recovery	1 Zones With CO2Sensor Vent. Control, No DDC Fixed Drybulb Economizer No Supply Air Temp. Control						
HP-FC1	No Optimum Start	NA	No Evaporative Cooler	No Heat Recovery	No DCV Controls, No DDC No Economizer No Supply Air Temp. Control						
HP-FC2	No Optimum Start	NA	No Evaporative Cooler	No Heat Recovery	No DCV Controls, No DDC No Economizer No Supply Air Temp. Control						
DHW1 - SHW	NA	NA	NA	NA	Fixed Temperature Control, No DDC						

Notes: This table includes controls related to the performance path only. For projects using the prescriptive path, mandatory and prescriptive controls requirements are documented on the NRCC-MCH-E.

H6. MECHANICAL VENTILATION								
1	2	3	4	5	6	7	8	9
Zone Name	Mechanical Ventilation						DCV or Occupant Sensor Controls, or Both	
	Ventilation Function	# hotel rooms	# of people	# of bedrooms	Supply OA CFM	Exhaust CFM		Conditioned Area (sf)
1-101 Gymnasium	Education - Multiuse assembly	0	240.01	0	3600	0	7200	NA

CA Building Energy Efficiency Standards- 2019 Nonresidential Compliance Report Version: NRCC-PRF-01-E-10092020-6384 Report Generated at: 2020-12-22 12:27:58

Project Name:	Freedom High School Auxiliary Gym	NRCC-PRF-01-E	Page 3 of 15
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Input File Name:	Freedom High Auxiliary Gym.cbd19x		

C3. ENERGY USE SUMMARY						
Energy Component	Standard Design Site (MWh)	Proposed Design Site (MWh)	Margin (MWh)	Standard Design Site (MBtu)	Proposed Design Site (MBtu)	Margin (MBtu)
Space Heating	--	0.0	--	79.1	20.1	59.0
Space Cooling	14.9	13.5	1.4	--	--	--
Indoor Fans	27.8	29.8	-2.0	--	--	--
Heat Rejection	--	--	--	--	--	--
Pumps & Misc.	--	--	--	--	--	--
Domestic Hot Water	1.6	4.1	-2.5	19.2	--	--
Indoor Lighting	23.9	23.9	0.0	--	--	--
Compliance Total	68.2	71.3	-3.1	98.3	20.1	78.2
Receptacle	33.6	33.6	0.0	--	--	--
Process	--	--	--	--	--	--
Other Ltg	--	--	--	--	--	--
Process Motors	--	--	--	--	--	--
TOTAL	101.8	104.9	-3.1	98.3	20.1	78.2

C4. UNMET LOAD HOURS	
This Section Does Not Apply	

D. EXCEPTIONAL CONDITIONS	
This project includes partial performance compliance scope options. The building must show compliance with all other applicable compliance scope options (performance or prescriptively) before occupying.	
The aged solar reflectance and aged thermal emittance must be listed in the Cool Roof Rating Council database of certified products. For projects where initial reflectance is used, the initial reflectance must be listed, and the aged reflectance is calculated by the software program and used in the compliance model.	
This project uses the Simplified Geometry Performance Modeling Approach which is not capable of modeling daylighting controls and assumes the prescriptive Secondary Daylit Control requirements are met. PRESCRIPTIVE COMPLIANCE documentation (form NRCC-LTI-02-E) for the requirements of section 140.6(d) Automatic Daylighting Controls in Secondary Daylit Zones is required.	
The user model includes spaces that are designed to be served by mechanical cooling systems, but the cooling systems were not included in the simulation model. A cooling system has been modeled for both the proposed and standard cases.	
The user model includes spaces without sufficient cooling equipment. Cooling equipment has been added to the model to meet cooling loads.	

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G5. FENESTRATION ASSEMBLY SUMMARY								
1	2	3	4	5	6	7	8	9
Fenestration Assembly Name / Tag or L.B.	Fenestration Type / Product Type / Frame Type	Certification Method¹	Assembly Method	Area ft²	Overall U-factor	Overall SHGC	Overall VT	STATUS
Door Dual Metal Clear	VerticalFenestration GlazedDoor MetalFraming	Default Performance	SiteBuilt	210	0.77	0.70	0.53	N
Tubular 1x1 x 8 Skylights	Skylight FixedWindow MetalFramingWithThermalBreak	Default Performance	Manufactured	16	1.11	0.69	1.00	N
Storefront Dual Metal Clear	VerticalFenestration CurtainWall MetalFraming	Default Performance	SiteBuilt	112	0.71	0.73	0.88	N

¹ Newly installed fenestration shall have a certified NRCC Label Certificate or use the CCC default tables found in Table 110.6-A and Table 110.6-B. Center of Glass (COG) values are for the glass only, determined by the manufacturer, and are shown for ease of verification. Site-built fenestration values are calculated per Nonresidential Appendix N46 and are used in the analysis.  
² Status: N - New, A - Altered, E - Existing

G6. OVERHANG DETAILS	
This Section Does Not Apply	

G7. FIN DETAILS	
This Section Does Not Apply	

H. HVAC SYSTEM SUMMARY	

H1. DRY SYSTEM EQUIPMENT (furnaces, air handling units, heat pumps, VRF, economizers etc.)
--------------------------------------------------------------------------------------------



BIMcloud: archserver - BIMcloud Basic for ARCHICAD 22/1869.00 Freedom HS Aux. Gym - CD-4/27/2021:1:28 PM

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I. DOMESTIC/SERVICE HOT WATER SYSTEM SUMMARY

I1. DHW EQUIPMENT SUMMARY										
1	2	3	4	5	6	7	8	9	10	11
DHW Name	Heater Element Type	Tank Type	Qty	Tank Vol (gal)	Rated Input (kBtu/h)	Efficiency	Tank Insulation R-value (Int/Ext)	Standby Loss Fraction	Heat Pump Type	Tank Location or Ambient Condition
AO Smith DEL 202	Electricity	Storage	1	20.00	3.0 (kW)	UEF: 0.92	NA	SBLF: NA	NA	NA

I2. MULTI-FAMILY CENTRAL DHW SYSTEM DETAILS

This Section Does Not Apply

I3. SOLAR HOT WATER HEATING SUMMARY

This Section Does Not Apply

J. COVERED PROCESS SUMMARY

This Section Does Not Apply

K. INDOOR LIGHTING SUMMARY

This Section Does Not Apply

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L. DECLARATION OF REQUIRED CERTIFICATES OF INSTALLATION

Table Instructions: Selections shall be made by Documentation Author to indicate which Certificates of Installation must be submitted for the features to be recognized for compliance. These documents must be retained and provided to the building inspector during construction and can be found online at: [https://www.energy.ca.gov/title24/2019standards/2019_compliance_documents/Nonresidential_Documents/NRCA/](https://www.energy.ca.gov/title24/2019standards/2019_compliance_documents/Nonresidential_Documents/NRCA/)

Building Component	YES		Form/Title	Field Inspector	
	Pass	Fail		Pass	Fail
Envelope	<input checked="" type="checkbox"/>	<input type="checkbox"/>	NRCI-ENV-01-E - Must be submitted for all buildings	<input type="checkbox"/>	<input type="checkbox"/>
Mechanical	<input checked="" type="checkbox"/>	<input type="checkbox"/>	NRCI-MCH-01-E - Must be submitted for all buildings	<input type="checkbox"/>	<input type="checkbox"/>
Plumbing	<input checked="" type="checkbox"/>	<input type="checkbox"/>	NRCI-PLB-01-E - Must be submitted for all buildings	<input type="checkbox"/>	<input type="checkbox"/>
	<input type="checkbox"/>	<input checked="" type="checkbox"/>	NRCI-PLB-02-E - Must be submitted for high-rise residential and hotel/motel central hot water distribution systems to be recognized for compliance	<input type="checkbox"/>	<input type="checkbox"/>
	<input type="checkbox"/>	<input checked="" type="checkbox"/>	NRCI-PLB-03-E - Must be submitted for high-rise residential and hotel/motel single dwelling unit hot water system distribution systems to be recognized for compliance	<input type="checkbox"/>	<input type="checkbox"/>
	<input type="checkbox"/>	<input checked="" type="checkbox"/>	NRCI-PLB-21-E - Must be HERS verified for central systems in high-rise residential hotel/motel application	<input type="checkbox"/>	<input type="checkbox"/>
	<input type="checkbox"/>	<input checked="" type="checkbox"/>	NRCI-PLB-22-E - Must be HERS verified for single dwelling unit systems in high-rise residential, hotel/motel application	<input type="checkbox"/>	<input type="checkbox"/>
	<input type="checkbox"/>	<input checked="" type="checkbox"/>	NRCI-STH-01-E - Must be submitted for solar hot water heating systems	<input type="checkbox"/>	<input type="checkbox"/>
Indoor Lighting	<input type="checkbox"/>	<input checked="" type="checkbox"/>	NRCI-LTI-01-E - Must be submitted for all buildings	<input type="checkbox"/>	<input type="checkbox"/>
	<input type="checkbox"/>	<input checked="" type="checkbox"/>	NRCI-LTI-02-E - Must be submitted for a lighting control system, or for an Energy Management Control System (EMCS) to be recognized for compliance	<input type="checkbox"/>	<input type="checkbox"/>
	<input type="checkbox"/>	<input checked="" type="checkbox"/>	NRCI-LTI-04-E - Must be submitted for two interlocked systems serving an auditorium, a convention center, a conference room, a multipurpose room, or a theater to be recognized for compliance	<input type="checkbox"/>	<input type="checkbox"/>
	<input type="checkbox"/>	<input checked="" type="checkbox"/>	NRCI-LTI-05-E - Must be submitted for a Power Adjustment Factor (PAF) to be recognized for compliance	<input type="checkbox"/>	<input type="checkbox"/>
Covered Process	<input type="checkbox"/>	<input checked="" type="checkbox"/>	NRCI-LTI-06-E - Must be submitted for additional wattage installed in a video conferencing studio to be recognized for compliance	<input type="checkbox"/>	<input type="checkbox"/>
	<input type="checkbox"/>	<input checked="" type="checkbox"/>	NRCI-PRC-01-E - Must be submitted for all Covered Processes	<input type="checkbox"/>	<input type="checkbox"/>

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M. DECLARATION OF REQUIRED CERTIFICATES OF ACCEPTANCE

Table Instructions: Selections shall be made by Documentation Author to indicate which Certificates of Acceptance must be submitted for the features to be recognized for compliance. These documents must be provided to the building inspector during construction and must be completed through an Acceptance Test Technician Certification Provider (ATTCP). For more information visit: [https://www.energy.ca.gov/title24/2019standards/2019_compliance_documents/Nonresidential_Documents/NRCA/](https://www.energy.ca.gov/title24/2019standards/2019_compliance_documents/Nonresidential_Documents/NRCA/)

Building Component	YES		Form/Title	Field Inspector	
	Pass	Fail		Pass	Fail
Envelope	<input checked="" type="checkbox"/>	<input type="checkbox"/>	NRCA-ENV-02-F - NRFC label verification for fenestration	<input type="checkbox"/>	<input type="checkbox"/>
Indoor Lighting	<input type="checkbox"/>	<input checked="" type="checkbox"/>	NRCA-ENV-03-F - Daylighting Design PAFs	<input type="checkbox"/>	<input type="checkbox"/>
	<input type="checkbox"/>	<input checked="" type="checkbox"/>	NRCA-LTI-02-A - Occupancy Sensors and Automatic Time Switch Controls	<input type="checkbox"/>	<input type="checkbox"/>
	<input type="checkbox"/>	<input checked="" type="checkbox"/>	NRCA-LTI-03-A - Automatic Daylight Controls	<input type="checkbox"/>	<input type="checkbox"/>
Covered Process	<input type="checkbox"/>	<input checked="" type="checkbox"/>	NRCA-LTI-04-A - Demand Responsive Lighting Controls	<input type="checkbox"/>	<input type="checkbox"/>
	<input type="checkbox"/>	<input checked="" type="checkbox"/>	NRCA-LTI-05-A - Institutional Tuning Power Adjustment Factor (PAF)	<input type="checkbox"/>	<input type="checkbox"/>
	<input type="checkbox"/>	<input checked="" type="checkbox"/>	NRCA-PRC-02-F - Kitchen Exhaust	<input type="checkbox"/>	<input type="checkbox"/>
	<input type="checkbox"/>	<input checked="" type="checkbox"/>	NRCA-PRC-03-F - Garage Exhaust	<input type="checkbox"/>	<input type="checkbox"/>
	<input type="checkbox"/>	<input checked="" type="checkbox"/>	NRCA-PRC-12-F - Elevator Lighting and Ventilation Controls	<input type="checkbox"/>	<input type="checkbox"/>
	<input type="checkbox"/>	<input checked="" type="checkbox"/>	NRCA-PRC-13-F - Escalator and Moving Walkways Speed Control	<input type="checkbox"/>	<input type="checkbox"/>
	<input type="checkbox"/>	<input checked="" type="checkbox"/>	NRCA-PRC-14-F - Lab Exhaust Ventilation System	<input type="checkbox"/>	<input type="checkbox"/>
<input type="checkbox"/>	<input checked="" type="checkbox"/>	NRCA-PRC-15-F - Fume Hood Automatic Sash Closures System	<input type="checkbox"/>	<input type="checkbox"/>	

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M. DECLARATION OF REQUIRED CERTIFICATES OF ACCEPTANCE

Table Instructions: Selections shall be made by Documentation Author to indicate which Certificates of Acceptance must be submitted for the features to be recognized for compliance. These documents must be provided to the building inspector during construction and must be completed through an Acceptance Test Technician Certification Provider (ATTCP). For more information visit: [https://www.energy.ca.gov/title24/2019standards/2019_compliance_documents/Nonresidential_Documents/NRCA/](https://www.energy.ca.gov/title24/2019standards/2019_compliance_documents/Nonresidential_Documents/NRCA/)

Building Component	YES		Form/Title	Field Inspector	
	Pass	Fail		Pass	Fail
Mechanical	<input checked="" type="checkbox"/>	<input type="checkbox"/>	NRCA-MCH-02-A Outdoor Air must be submitted for all newly installed HVAC units. Note: MCH02-A can be performed in conjunction with MCH-07-A Supply Fan VFD Acceptance (if applicable) since testing activities overlap	<input type="checkbox"/>	<input type="checkbox"/>
	<input type="checkbox"/>	<input checked="" type="checkbox"/>	NRCA-MCH-03-A Constant Volume Single Zone HVAC	<input type="checkbox"/>	<input type="checkbox"/>
	<input type="checkbox"/>	<input checked="" type="checkbox"/>	NRCA-MCH-04(a)-H Air Distribution Duct Leakage - HERS Verification required	<input type="checkbox"/>	<input type="checkbox"/>
	<input type="checkbox"/>	<input checked="" type="checkbox"/>	NRCA-MCH-04(b)-A Air Distribution Duct Leakage - ATT only	<input type="checkbox"/>	<input type="checkbox"/>
	<input checked="" type="checkbox"/>	<input type="checkbox"/>	NRCA-MCH-05-A Air Economizer Controls	<input type="checkbox"/>	<input type="checkbox"/>
	<input checked="" type="checkbox"/>	<input type="checkbox"/>	NRCA-MCH-06-A Demand Control Ventilation Systems Acceptance must be submitted for all systems required to employ demand controlled ventilation (refer to §120.1(c)(3) can vary outside ventilation flow rates based on maintaining interior carbon dioxide (CO2) concentration setpoints	<input type="checkbox"/>	<input type="checkbox"/>
	<input type="checkbox"/>	<input checked="" type="checkbox"/>	NRCA-MCH-07-A Supply Fan Variable Flow Controls	<input type="checkbox"/>	<input type="checkbox"/>
	<input type="checkbox"/>	<input checked="" type="checkbox"/>	NRCA-MCH-08-A Valve Leakage Test	<input type="checkbox"/>	<input type="checkbox"/>
	<input type="checkbox"/>	<input checked="" type="checkbox"/>	NRCA-MCH-09-A Supply Water Temperature Reset Controls	<input type="checkbox"/>	<input type="checkbox"/>
	<input type="checkbox"/>	<input checked="" type="checkbox"/>	NRCA-MCH-10-A Hydronic System Variable Flow Controls	<input type="checkbox"/>	<input type="checkbox"/>
	<input type="checkbox"/>	<input checked="" type="checkbox"/>	NRCA-MCH-11-A Automatic Demand Shed Controls	<input type="checkbox"/>	<input type="checkbox"/>
	<input checked="" type="checkbox"/>	<input type="checkbox"/>	NRCA-MCH-12-A FDD for Packaged Direct Expansion Units	<input type="checkbox"/>	<input type="checkbox"/>
	<input type="checkbox"/>	<input checked="" type="checkbox"/>	NRCA-MCH-13-A Automatic FDD for Air Handling Units and Zone Terminal Units Acceptance	<input type="checkbox"/>	<input type="checkbox"/>
	<input type="checkbox"/>	<input checked="" type="checkbox"/>	NRCA-MCH-14-A Distributed Energy Storage DX AC Systems Acceptance	<input type="checkbox"/>	<input type="checkbox"/>
	<input type="checkbox"/>	<input checked="" type="checkbox"/>	NRCA-MCH-15-A Thermal Energy Storage (TES) System Acceptance	<input type="checkbox"/>	<input type="checkbox"/>
	<input type="checkbox"/>	<input checked="" type="checkbox"/>	NRCA-MCH-16-A Supply Air Temperature Reset Controls	<input type="checkbox"/>	<input type="checkbox"/>
	<input type="checkbox"/>	<input checked="" type="checkbox"/>	NRCA-MCH-17-A Condenser Water Temperature Reset Controls	<input type="checkbox"/>	<input type="checkbox"/>
	<input type="checkbox"/>	<input checked="" type="checkbox"/>	NRCA-MCH-18 Energy Management Control Systems	<input type="checkbox"/>	<input type="checkbox"/>
	<input type="checkbox"/>	<input checked="" type="checkbox"/>	NRCA-MCH-19 Occupancy Sensor Controls	<input type="checkbox"/>	<input type="checkbox"/>

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N. DECLARATION OF REQUIRED CERTIFICATES OF VERIFICATION

Table Instructions: Selections shall be made by Documentation Author to indicate which Certificates of Verification must be submitted for the features to be recognized for compliance. These documents must be retained and provided to the building inspector during construction and can be found online at: [https://www.energy.ca.gov/title24/2019standards/2019_compliance_documents/Nonresidential_Documents/NRCA/](https://www.energy.ca.gov/title24/2019standards/2019_compliance_documents/Nonresidential_Documents/NRCA/)


Building Component	YES		Form/Title	Field Inspector	
	Pass	Fail		Pass	Fail
Mechanical	<input type="checkbox"/>	<input checked="" type="checkbox"/>	NRCV-MCH-04-H Duct Leakage Test	<input type="checkbox"/>	<input type="checkbox"/>
	<input type="checkbox"/>	<input checked="" type="checkbox"/>	NRCV-MCH-24-H Enclosure Air Leakage	<input type="checkbox"/>	<input type="checkbox"/>
	<input type="checkbox"/>	<input checked="" type="checkbox"/>	NRCV-MCH-27 Indoor Air Quality & Mechanical Ventilation	<input type="checkbox"/>	<input type="checkbox"/>
Plumbing	<input type="checkbox"/>	<input checked="" type="checkbox"/>	NRCV-MCH-32-H Local Mechanical Exhaust	<input type="checkbox"/>	<input type="checkbox"/>
	<input type="checkbox"/>	<input checked="" type="checkbox"/>	NRCV-PLB-21-H - HERS verified central systems in high-rise residential, hotel/motel application	<input type="checkbox"/>	<input type="checkbox"/>
	<input type="checkbox"/>	<input checked="" type="checkbox"/>	NRCV-PLB-22-H - HERS verified single dwelling unit systems in high-rise residential, hotel/motel application	<input type="checkbox"/>	<input type="checkbox"/>

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DOCUMENTATION AUTHOR'S DECLARATION STATEMENT

I certify that this Certificate of Compliance documentation is accurate and complete.

Documentation Author Name: Sarah Perula      Signature: 


Company: SOLDATA Energy Consulting      Signature Date: 2020-12-22

Address: 2227 Capricorn Way      City/State/Zip: Santa Rosa CA 95407      CEA/HERS Certification Identification (if applicable): NR16-90-20043      Phone: 707.545.4440

RESPONSIBLE PERSON'S DECLARATION STATEMENT


I certify the following under penalty of perjury, under the laws of the State of California:

1. The information provided on this Certificate of Compliance is true and correct.  
2. I am eligible under Division 3 of the Business and Professions Code to accept responsibility for the building design or system design identified on this Certificate of Compliance (responsible designer).  
3. The energy features and performance specifications, materials, components, and manufactured devices for the building design or system design identified on this Certificate of Compliance conform to the requirements of Title 24, Part 1 and Part 6 of the California Code of Regulations.  
4. The building design features or system design features identified on this Certificate of Compliance are consistent with the information provided on other applicable compliance documents, worksheets, calculations, plans and specifications submitted to the enforcement agency for approval with this building permit application.  
5. I will ensure that a completed signed copy of this Certificate of Compliance shall be made available with the building permit(s) issued for the building, and made available to the enforcement agency for all applicable inspections. I understand that a completed signed copy of this Certificate of Compliance is required to be included with the documentation the buldger provides to the building owner at occupancy.

Responsible Envelope Designer Name: Jim Theiss, Architect      Signature: 

Company: Quattrocchi Kwok Architects      Address: 636 Fifth Street      Date Signed: 12/23/2020      City/State/Zip: Santa Rosa CA 95404      Title: Architect      License #: C-22643      Phone: 707.576-0829

Responsible Lighting Designer Name:      Signature: NOT IN SCOPE      Company: O'Mahony & Myer Electrical Eng & Lighting Dsgn      Address: 4340 Redwood Hwy, Suite 245      Date Signed:      City/State/Zip: San Rafael CA 94903      Phone: 415.492-0420      Title:      License #:

Responsible Mechanical Designer Name: - specify -      Signature: 

Company: Costa Engineers Inc.      Address: 3274 Villa Lane      Date Signed: December 22nd, 2020      City/State/Zip: Napa CA 94558      Title: Principal      License #: M31600      Phone: 707.252-9177

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STATE OF CALIFORNIA  
Solar Ready Areas  
NRCC-SRA-E

CALIFORNIA ENERGY COMMISSION  
NRCC-SRA-E

CERTIFICATE OF COMPLIANCE

This document is used to demonstrate compliance with mandatory requirements in §110.10 for newly constructed buildings which are either high-rise multifamily ten stories or fewer, hotel/motel ten stories or fewer or all other nonresidential buildings three stories or fewer. It is also used to demonstrate compliance with additions to these building types which add more than 2,000 ft² of roof area. Alterations or additions of less than 2,000 ft² are not required to comply with §110.10.

Project Name: Freedom High School Auxiliary Gym      Report Page: (Page 1 of 5)  
Project Address: 1050 Neroly Road      Date Prepared: 12/22/2020

A. GENERAL INFORMATION

01 Project Location (city)	Oakley	04 Building Type	Other nonresidential bldg 3 stories or fewer
02 Climate Zone	12	05 Construction Type	New Construction
03 <input type="checkbox"/> Roof is designed for vehicle traffic, parking or for heliport			
03a Plan sheet showing roof design for vehicle traffic, parking or heliport exception:			

B. PROJECT SCOPE

The compliance path the project is using to comply per §110.10(b)(1)(B) is indicated below.

My project consists of (check one):

<input checked="" type="checkbox"/>	Provide Solar Ready Area no exceptions	The project has allocated a solar zone on the roof plan per requirements in §110.10(b), as documented in Table F.
<input type="checkbox"/>	Exception to Solar Ready Area: Installed Solar Photovoltaic System	The project includes a permanently installed solar electric system having a nameplate DC power rating, measured under Standard Test Conditions, of no less than one watt per square foot of roof area as documented in Table G.
<input type="checkbox"/>	Exception to Solar Ready Area: Installed Solar Water Heating System	The project is a hotel/motel or high-rise multifamily occupancy and includes a permanently installed domestic solar water-heating system complying with §150.1(c)(8)(iii) and Reference Residential Appendix RA4, as documented in Table H.
<input type="checkbox"/>	Exception to Solar Ready Area: Smart Thermostat and Alternative Energy Efficiency Measure	The project is a high-rise multifamily occupancy where all thermostats in each dwelling unit comply with §110.12(a), AND at least one additional measure listed in Exception 4 to §110.10(b)(1)(B) is installed, as documented in Table I.

Registration Number:      Registration Date/Time:      Registration Provider: Energysoft  
CA Building Energy Efficiency Standards - 2019 Nonresidential Compliance      Report Version: 2019.1.003      Report Generated: 2020-12-22 12:28:26  
Schema Version: rev 20200601

STATE OF CALIFORNIA  
Solar Ready Areas  
NRCC-SRA-E

CALIFORNIA ENERGY COMMISSION  
NRCC-SRA-E

CERTIFICATE OF COMPLIANCE

Project Name: Freedom High School Auxiliary Gym      Report Page: (Page 2 of 5)  
Project Address: 1050 Neroly Road      Date Prepared: 12/22/2020

C. COMPLIANCE RESULTS

Results in this table are automatically calculated from data input and calculations in Tables F through I. Note: If any cell on this table says "DOES NOT COMPLY" or "COMPLIES with Exceptional Conditions" refer to Table D for guidance or see the applicable Table referenced below.

Allocated Solar Zone		Installed PV System		Installed SWH System		Smart Tstat and Alternative EE Measure		09
01	02	03	04	05	06	07	08	
Required Minimum Area (ft²)	Designated Area (ft²)	Required Minimum DC Power Rating (Watts)	Designed DC Power Rating (Watts)	Required Minimum Solar Savings Fraction	Designed/Rated Solar Savings Fraction	IAS Compliant Thermostat Specified?	Alternative Energy Efficiency Measure	
(See Table F)		(See Table G)		(See Table H)		(See Table I)		
1564.8	<= 1700	OR	<= 1700	OR	<= 1700	OR	<= 1700	COMPLIES
Sheet A-M4.1		Location within the construction documents showing the location for inverters and metering equipment and a pathway for the routing of conduit/plumbing to the electrical service/ water heating system per §110.10(c).						COMPLIES

D. EXCEPTIONAL CONDITIONS

This table is auto-filled with uneditable comments because of selections made or data entered in tables throughout the form.

E. ADDITIONAL REMARKS

This table includes remarks made by the permit applicant to the Authority Having Jurisdiction.

Registration Number:      Registration Date/Time:      Registration Provider: Energysoft  
CA Building Energy Efficiency Standards - 2019 Nonresidential Compliance      Report Version: 2019.1.003      Report Generated: 2020-12-22 12:28:26  
Schema Version: rev 20200601

STATE OF CALIFORNIA  
Solar Ready Areas  
NRCC-SRA-E

CALIFORNIA ENERGY COMMISSION  
NRCC-SRA-E

CERTIFICATE OF COMPLIANCE

Project Name: Freedom High School Auxiliary Gym      Report Page: (Page 3 of 5)  
Project Address: 1050 Neroly Road      Date Prepared: 12/22/2020

F. ALLOCATED SOLAR ZONE

This table is completed if the project is designating a solar zone to comply with §110.10(b)(1)(B). New construction consider the total roof area; Additions consider newly added roof area. This table demonstrates that the project has designated the minimum area required for the Allocated Solar Zone, and also that the requirements for Solar Zone Subareas have been met. Each subarea must be shown on a roof plan or documented in construction documents. The solar zones must also comply with fire code requirements, including, but not limited to, setback and pathway requirements. Requirements for interconnection pathways must also be included in construction documents, and the location is specified in this table.

Required Minimum Solar Zone

01	02	03	04	05	06	07	08
Minimum Solar Zone Area Calculation Method	Total New or Added Roof Area (ft²)	Total New or Added Roof Area Covered with Skylights (ft²)	Minimum Solar Zone Based on Total or Added Roof Area (0.15 x (Roof-Skylt) (ft²))	Method/ Tools Used to Determine Annual Solar Access for Potential Zones¹	Potential Solar Zone Areas: Roof areas with >= 70% Solar Access Low Sloped Area (<= 2:12 pitch) (ft²) Steep-Sloped Area (> 2:12 pitch) Oriented 90° ± 300° (ft²)	Minimum Solar Zone Based on Potential Solar Zone Area (ft²)	Required Minimum Solar Zone Area (ft²)
	10448	16	1564.8				1564.8

Designated Solar Zone Subareas

09	10	11	12	13	14	15	16	17	18	19
Subarea Name or Tag	Building Plan Reference	Roof or Overhang Slope (Low <= 2:12 pitch) (Steep > 2:12 pitch)	Is Steep-Sloped Roof or Overhang between 90 and 300 degrees?	Subarea Complies with Title 24, Part 9	Solar Zone Subarea Free of Obstructions per §110.10(b)(3)(B)	Subarea is Required Distance from Potential Obstructions per §110.10(b)(3)(B)	Is the Smallest Dimension 5 feet or greater?	Min. Area Required per Subarea (ft²)	Designated Area (ft²)	Subarea Complies?
Gym North	Sheet A-M4.1	LowSlope	No	Yes	Yes	Yes	Yes	160	600	COMPLIES
Gym South	Sheet A-M4.1	LowSlope	No	Yes	Yes	Yes	Yes	160	600	COMPLIES

Registration Number:      Registration Date/Time:      Registration Provider: Energysoft  
CA Building Energy Efficiency Standards - 2019 Nonresidential Compliance      Report Version: 2019.1.003      Report Generated: 2020-12-22 12:28:26  
Schema Version: rev 20200601



FREEDOM  
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GYMNASIUM  
  
1050 NEROLY RD,  
OAKLEY, CA 94561

LIBERTY UNION  
HIGH SCHOOL  
DISTRICT

DSA APP NO. 01-119278  
ARCH PROJECT NO: 1869.00  
DRAWN BY:  
DRAWING SCALE:  
PTN: 61721-78      FILE NO: 7-H4  
BID DOCUMENT  
APRIL 27, 2021  
SHEET TITLE

TITLE 24  
ENERGY CALCS

SHEET NUMBER

T-1.2



STATE OF CALIFORNIA

Solar Ready Areas

CALIFORNIA ENERGY COMMISSION

NRCC-SRA-E

CERTIFICATE OF COMPLIANCE

NRCC-SRA-E

Project Name:

Freedom High School Auxiliary Gym

Report Page:

(Page 4 of 5)

Project Address:

1050 Neroly Road

Date Prepared:

12/22/2020

Classroom Wing	Sheet A-M4.1	LowSlope	No	Yes	Yes	Yes	Yes	Yes	160	500	COMPLIES
Total Designated Solar Zone Area (ft ² ):										1700	
Interconnection Pathways											
Location in construction documents showing the location for inverters and metering equipment and a pathway for the routing of conduit/ plumbing to the electrical service/ water heating system per §110.10(c).											
										Sheet A-M4.1	
FOOTNOTE: This field is used to document how the percentage of annual solar access was determined per §110.10(b)(1)B. Solar access is the ratio of solar insolation including shade to the solar insolation without shade. Shading from obstructions located on the roof or any other part of the building shall not be included in the determination of annual solar access.											
G. PERMANENTLY INSTALLED SOLAR PHOTOVOLTAIC (PV) SYSTEM											
This section does not apply to this project.											
H. PERMANENTLY INSTALLED SOLAR HOT WATER SYSTEMS											
This section does not apply to this project.											
I. SMART THERMOSTATS AND ALTERNATIVE EFFICIENCY MEASURE											
This section does not apply to this project.											
J. DECLARATION OF REQUIRED CERTIFICATES OF INSTALLATION											
Selections have been made based on information provided in this document. If any selections have been changed by the permit applicant, an explanation should be included Table E.											
Additional Remarks. These documents must be provided to the building inspector during construction and can be found online at https://www.energy.ca.gov/title24/2019standards/2019_compliance_documents/Nonresidential_Documents/NRCI/											
Yes	No	Form/Title	Field Inspector								
			Pass	Fail							
<input type="radio"/>	<input checked="" type="radio"/>	NRCI-SPV-01-E - Must be submitted for all newly installed Photovoltaic Systems (PV) being used to comply with §110.10(b)(1)B for high-rise multifamily, Hotel/Motel buildings less than 10 stories and nonresidential buildings less than 4 stories.	<input type="checkbox"/>	<input type="checkbox"/>							
<input type="radio"/>	<input checked="" type="radio"/>	NRCI-STH-01-E - Must be submitted for all newly installed Solar Water Heating systems being used to comply with §110.10(b)(1)B for high-rise multifamily, Hotel/Motel buildings less than 10 stories and nonresidential buildings less than 4 stories.	<input type="checkbox"/>	<input type="checkbox"/>							
K. DECLARATION OF REQUIRED CERTIFICATES OF ACCEPTANCE											
There are no Certificates of Acceptance applicable to solar ready requirements.											
Registration Number:			Registration Date/Time:			Registration Provider: Energysoft					
CA Building Energy Efficiency Standards - 2019 Nonresidential Compliance			Report Version: 2019.1.003 Schema Version: rev 20200601			Report Generated: 2020-12-22 12:28:26					

STATE OF CALIFORNIA

Solar Ready Areas

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CERTIFICATE OF COMPLIANCE

NRCC-SRA-E

Project Name:

Freedom High School Auxiliary Gym

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(Page 5 of 5)

Project Address:

1050 Neroly Road

Date Prepared:

12/22/2020

DOCUMENTATION AUTHOR'S DECLARATION STATEMENT

I certify that this Certificate of Compliance documentation is accurate and complete.

Documentation Author Name: Sarah Pernulla

Documentation Author Signature: Sarah Pernulla

Company: SOLDATA Energy Consulting

Signature Date: 2020-12-22

Address: 2227 Capricorn Way

City/State/Zip: Santa Rosa CA 95407

Phone: 707.545.4440

CIAT/HERS Certification Identification (if applicable): NR16-90-20043

RESPONSIBLE PERSON'S DECLARATION STATEMENT

I certify the following under penalty of perjury, under the laws of the State of California:

1. The information provided on this Certificate of Compliance is true and correct.

2. I am eligible under Division 3 of the Business and Professions Code to accept responsibility for the building design or system design identified on this Certificate of Compliance (responsible designer).

3. The energy features and performance specifications, materials, components, and manufactured devices for the building design or system design identified on this Certificate of Compliance conform to the requirements of Title 24, Part 1 and Part 6 of the California Code of Regulations.

4. The building design features or system design features identified on this Certificate of Compliance are consistent with the information provided on other applicable compliance documents, worksheets, calculations, plans and specifications submitted to the enforcement agency for approval with this building permit application.

5. I will ensure that a completed signed copy of this Certificate of Compliance shall be made available with the building permit(s) issued for the building, and made available to the enforcement agency for all applicable inspections. I understand that a completed signed copy of this Certificate of Compliance is required to be included with the documentation the builder provides to the building owner at occupancy.

Responsible Designer Name: Jim Theiss, Architect

Responsible Designer Signature: Jim Theiss

Company: Quattrocchi Kwok Architects

Date Signed: 2020-12-22

Address: 636 Fifth Street

City/State/Zip: Santa Rosa CA 95404

License: C-22643

Phone: 707.576-0829

Registration Number:

CA Building Energy Efficiency Standards - 2019 Nonresidential Compliance

Registration Date/Time:

Report Version: 2019.1.003  
Schema Version: rev 20200601

Registration Provider: Energysoft

Report Generated: 2020-12-22 12:28:26



QUATTROCCHI KWOK  
ARCHITECTS

Main:  
636 Fifth Street, Santa Rosa, CA 95404

East Bay:  
55 Harrison Street, Suite 525,  
Oakland, CA 94607  
(707) 576-0829



JIM THEISS  
LICENSE # C22643  
EXP JUNE 30, 2021

SIGNED: MAY 5, 2021

FREEDOM  
HIGH SCHOOL

NEW AUXILIARY  
GYMNASIUM

1050 NEROLY RD,  
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DISTRICT


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DRAWN BY:

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PTN: 61721-78 FILE NO: 7-H4

BID DOCUMENT

APRIL 27, 2021

SHEET TITLE


TITLE 24  
ENERGY CALCS

SHEET NUMBER

T-1.3



BIMcloud: archserver - BIMcloud Basic for ARCHICAD 22/1869.00 Freedom HS Aux. Gym_CD/4/27/2021:1:28 PM

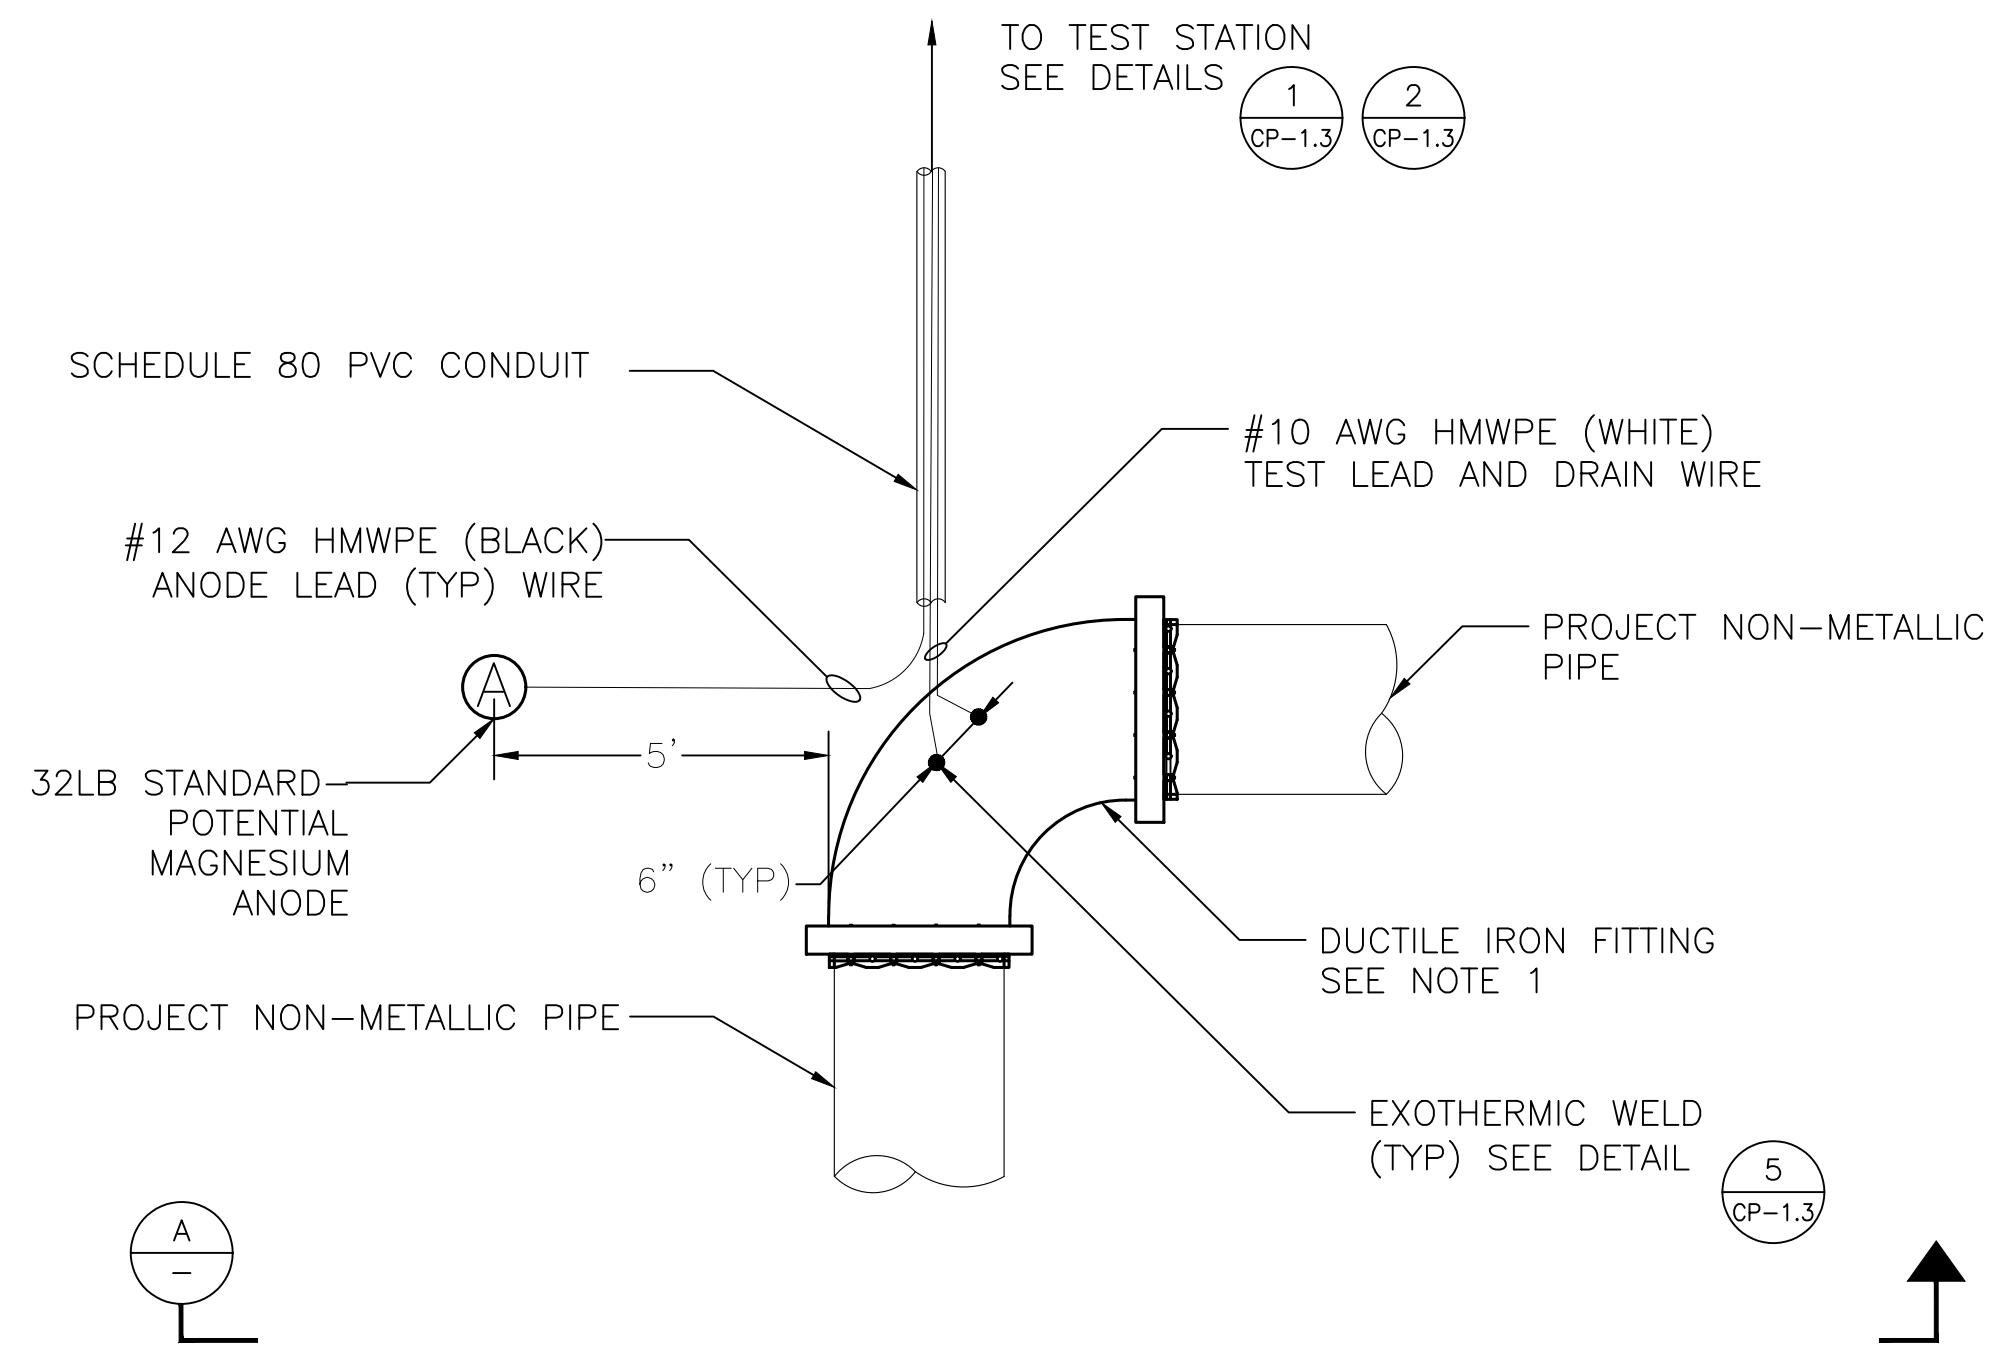


NOTE:

1. DUCTILE IRON FITTING MAY BE DIFFERENT GEOMETRY, SUCH AS TEE OR INLINE.
2. WRAP FITTING IN PETROLATUM WAX TAPE AND OVERLAP PIPE BY 2 TIMES THE PIPE DIAMETER.

ANODE TEST STATION (ATS) FOR METALLIC FITTING  
OR VALVE ON NON-METALLIC PIPE PLAN VIEW

NTS

1

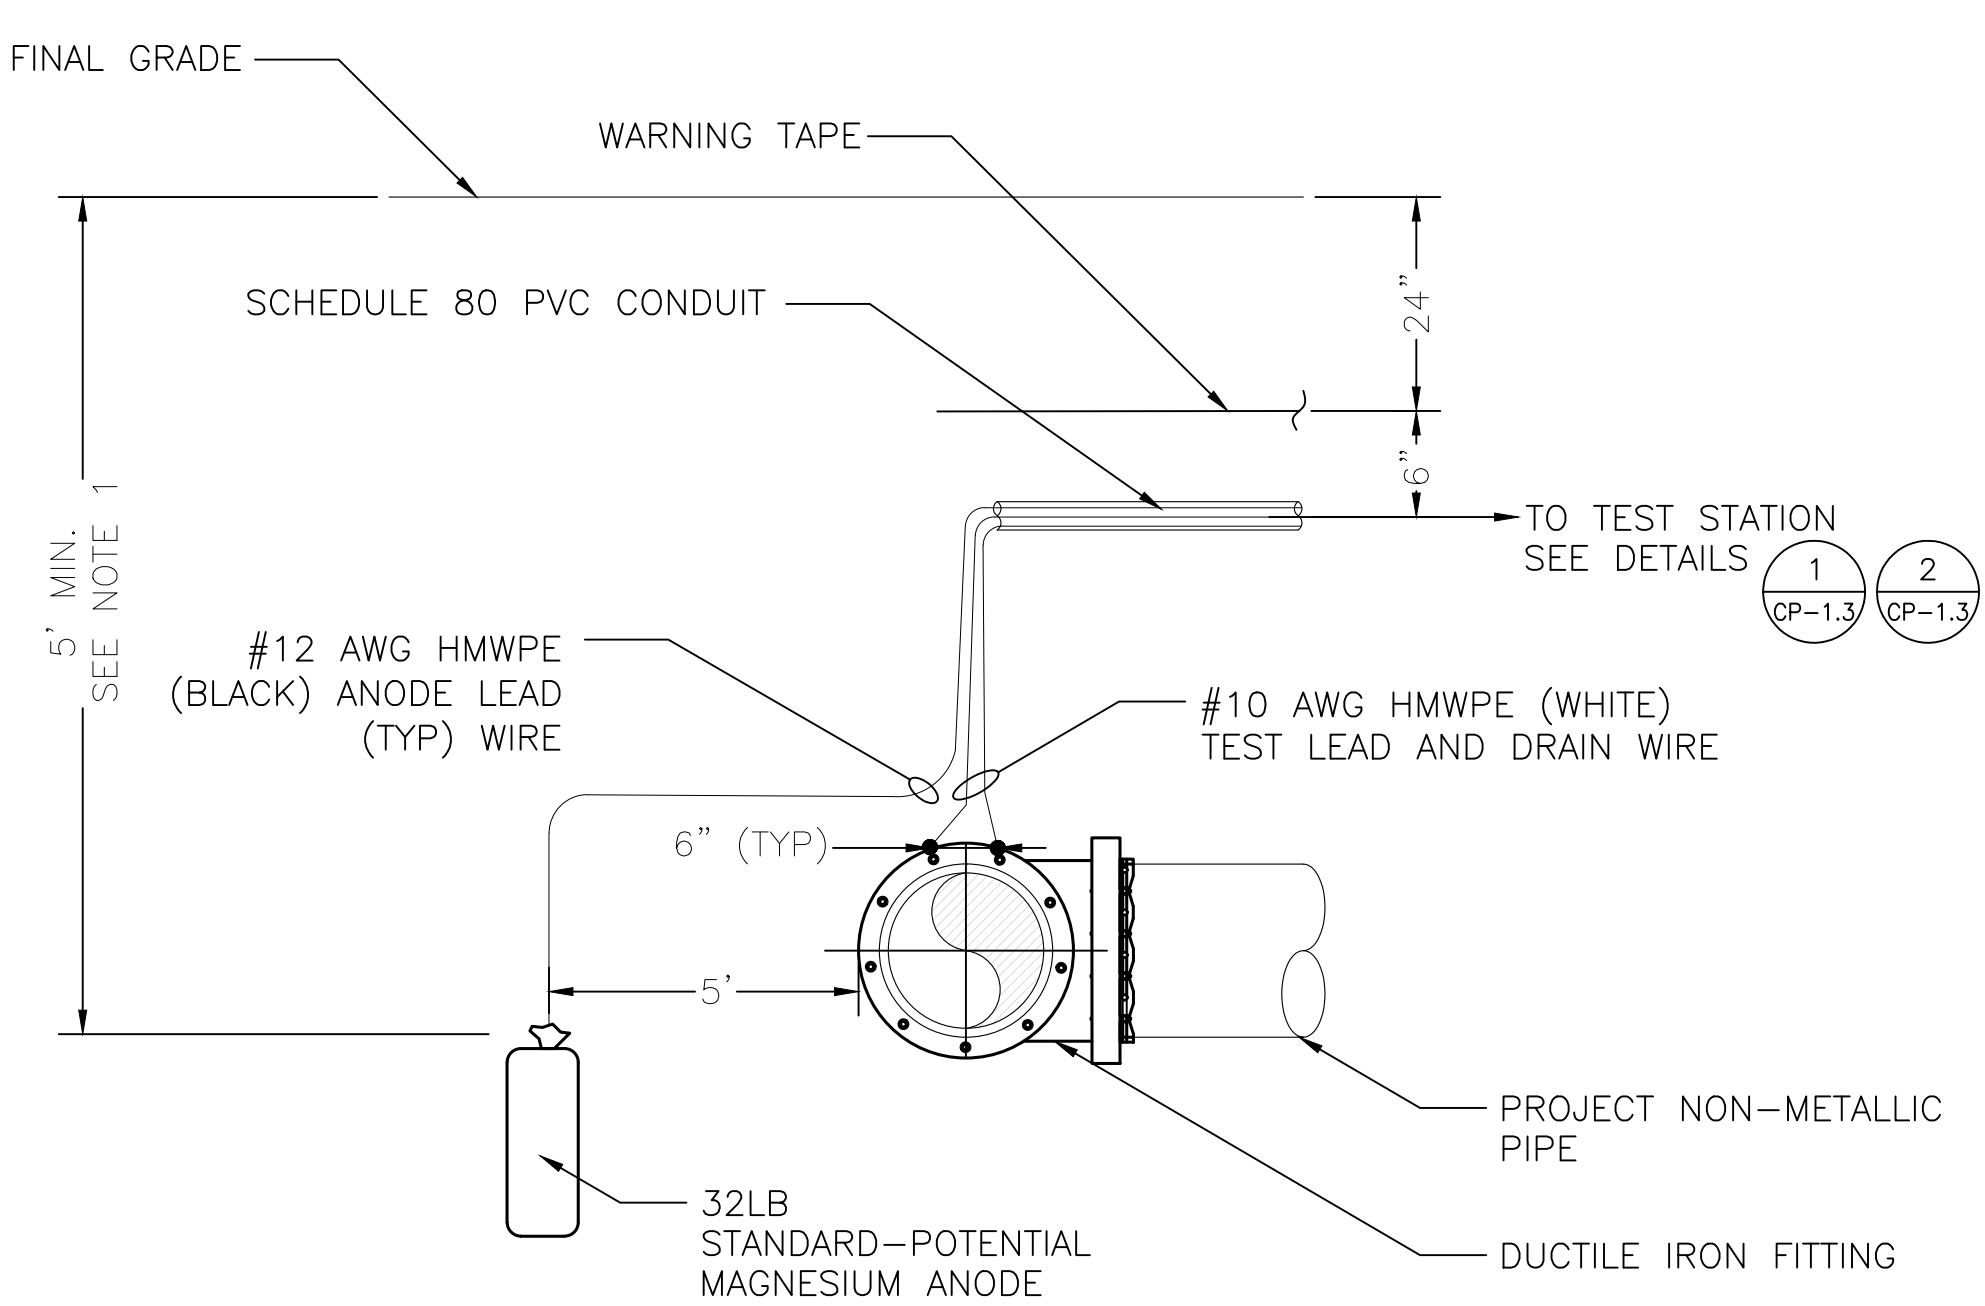


NOTE:

1. TOP OF ANODE SHALL BE AT OR BELOW PIPE INVERT.

ANODE TEST STATION (ATS) FOR METALLIC FITTING  
OR VALVE ON NON-METALLIC PIPE SECTION VIEW

NTS

A

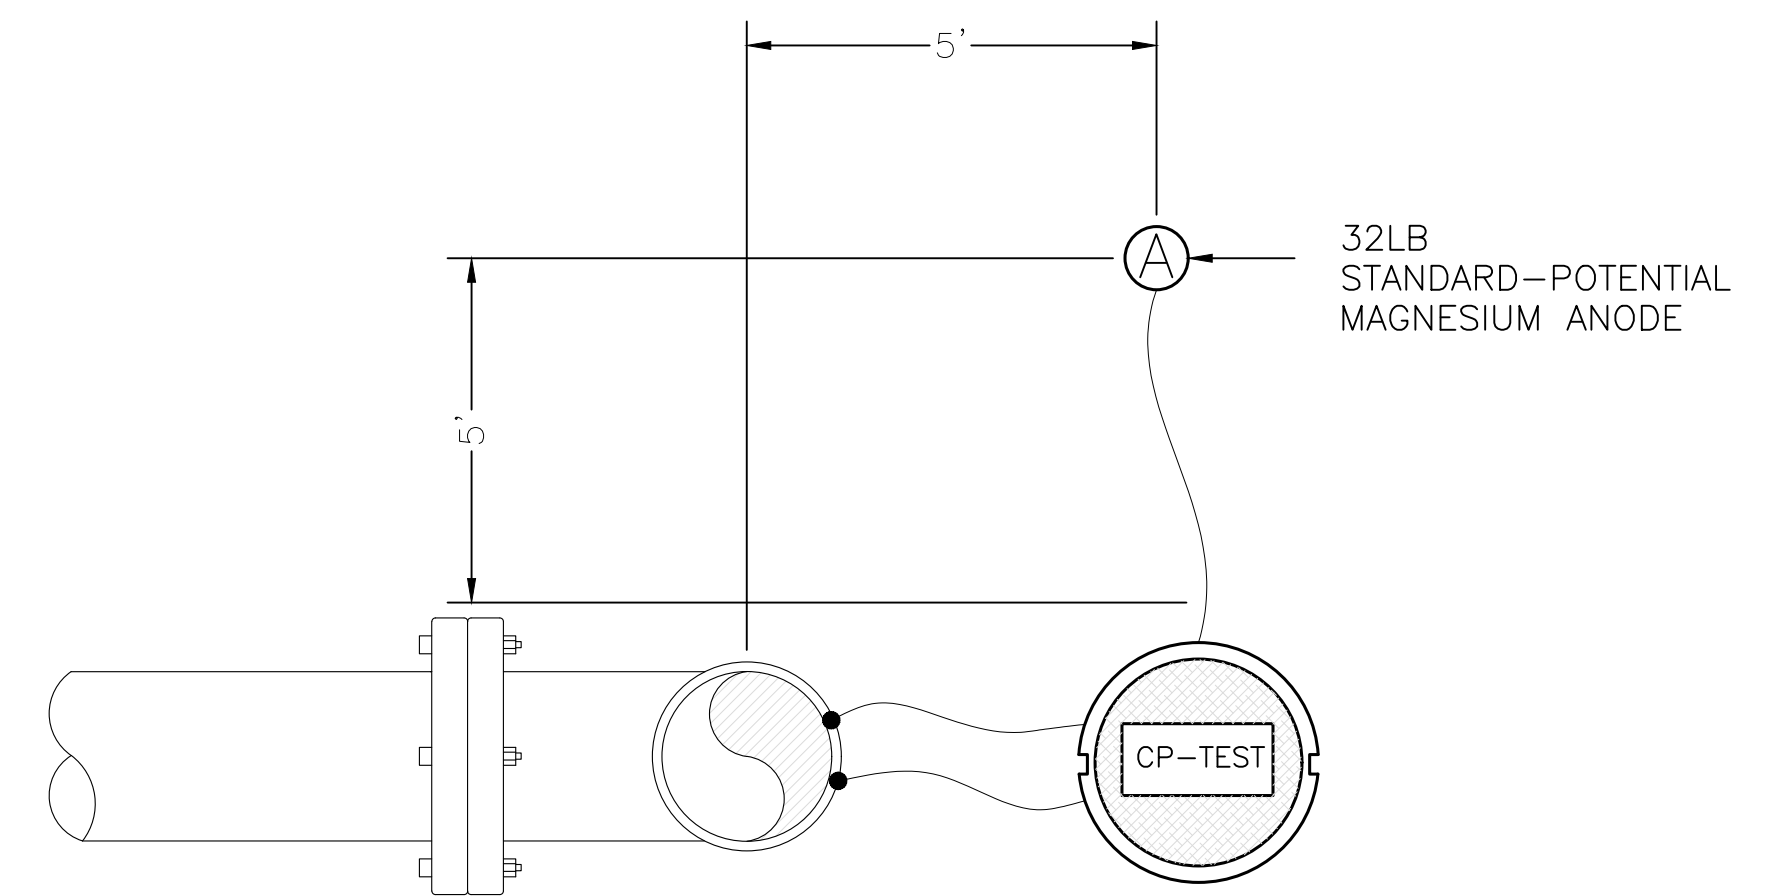


B

ANODE TEST STATION (ATS) FOR RISER  
PLAN VIEW

NTS

2

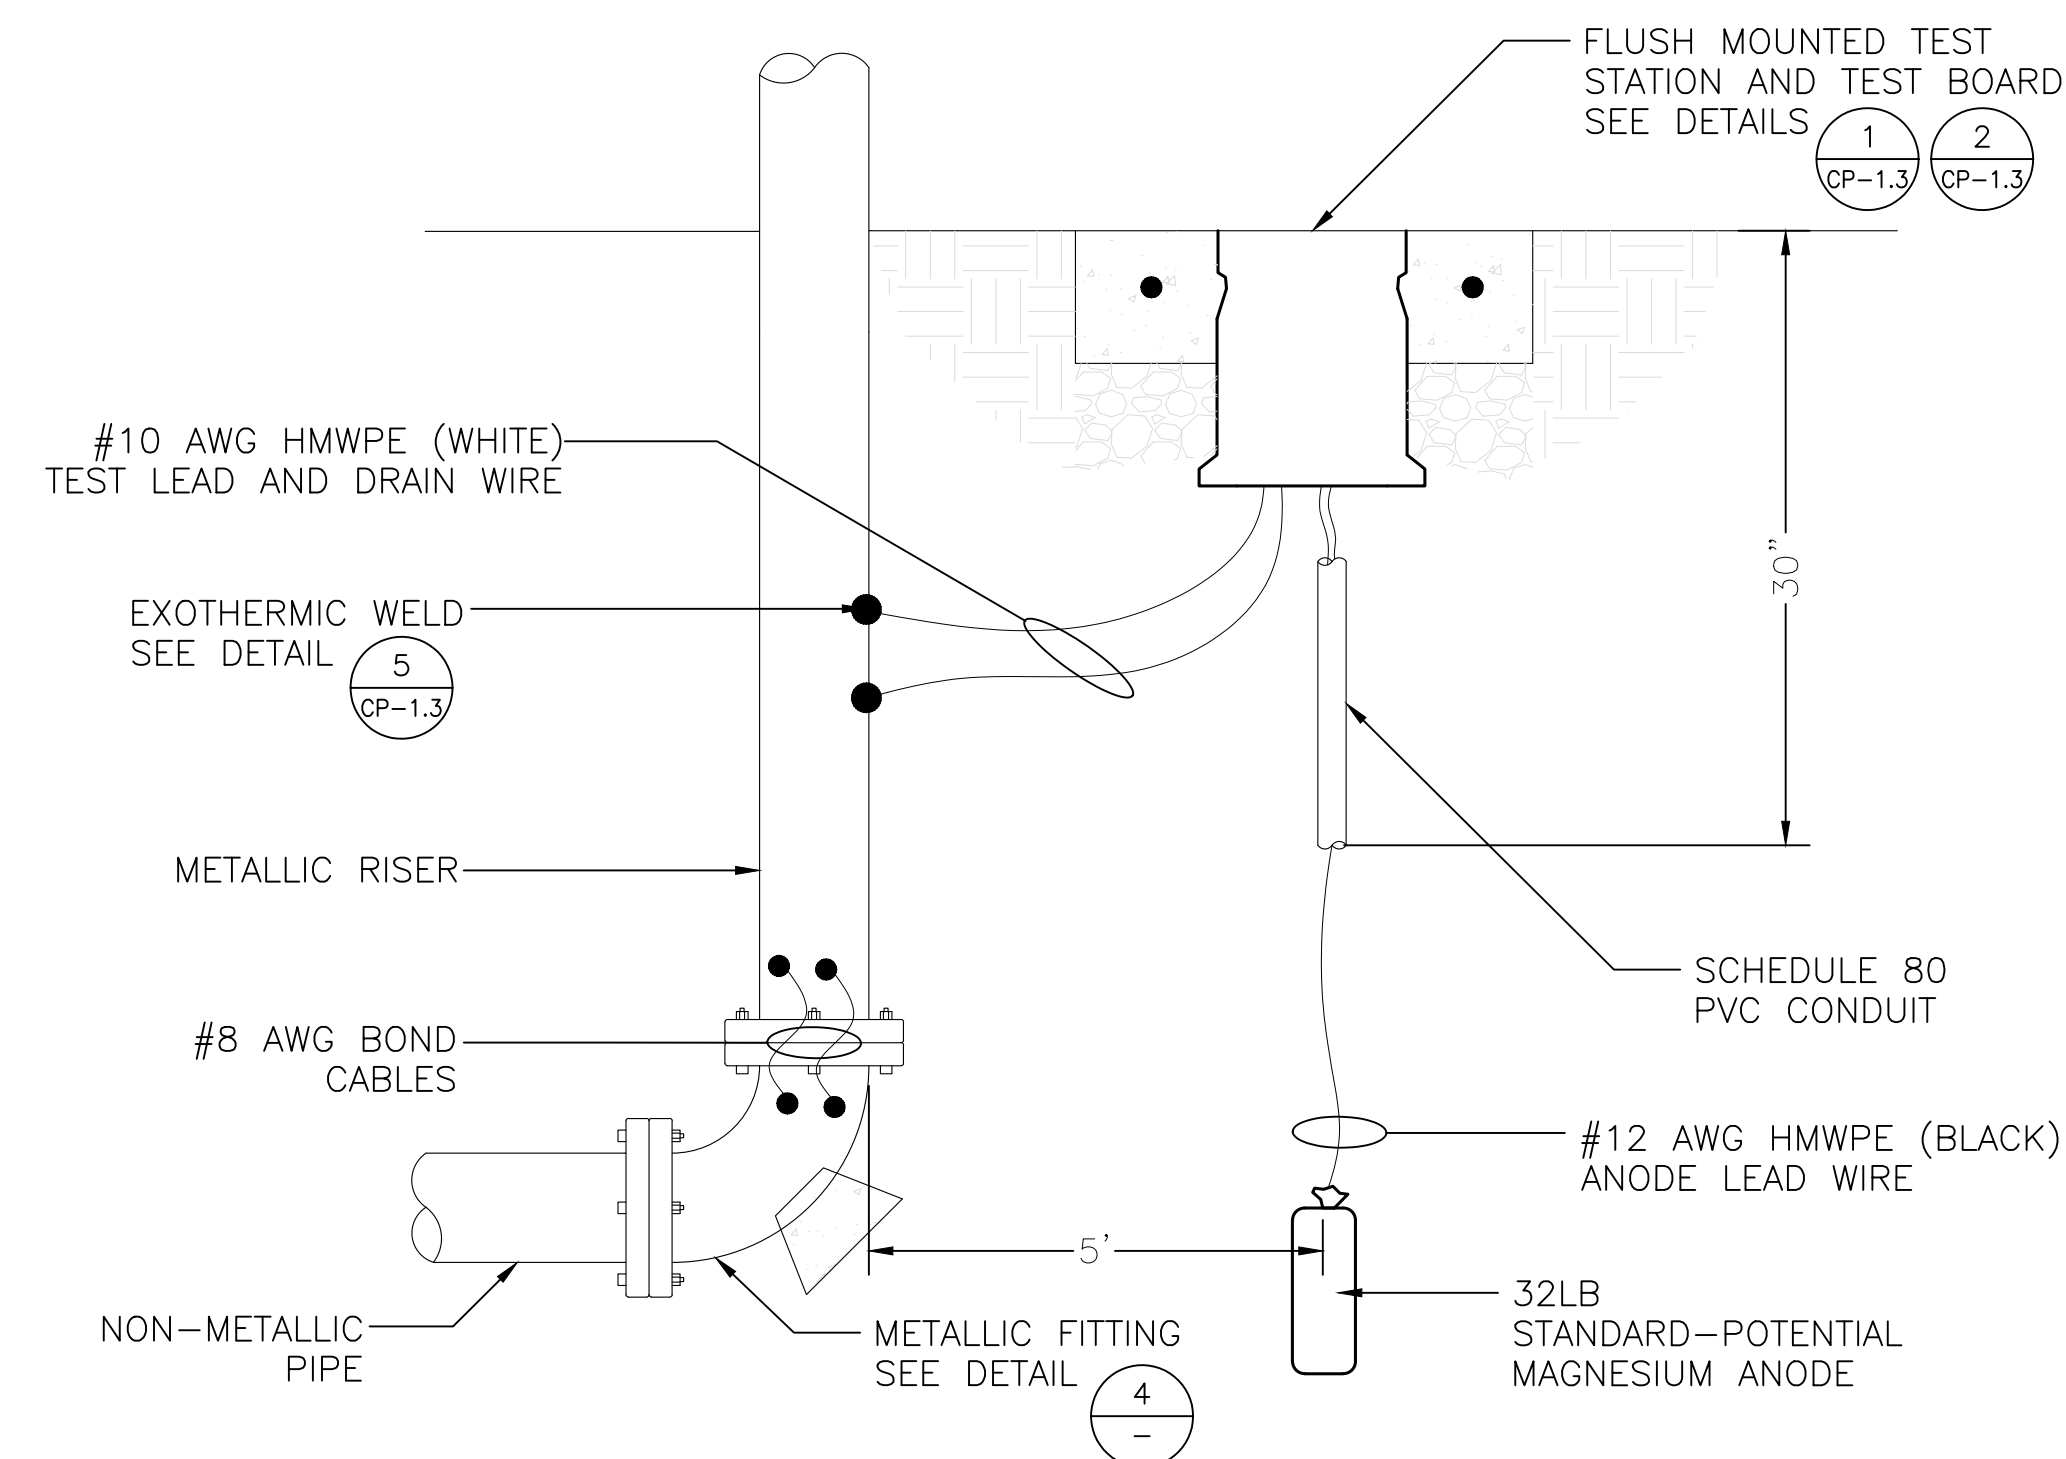

NOTE:


1. IF RISER IS DUCTILE IRON, BOND PIPE AND FITTINGS. RISER MAY HAVE 90 DEGREE ELBOW OR TEE. DUCTILE IRON PIPE AND FITTINGS SHALL HAVE POLYETHYLENE ENCASEMENT.
2. IF RISER IS STAINLESS STEEL, WRAP IN PETROLATUM WAX TAPE.

ANODE TEST STATION (ATS) FOR RISER  
SECTION VIEW

NTS

B

DETAIL NOT USED

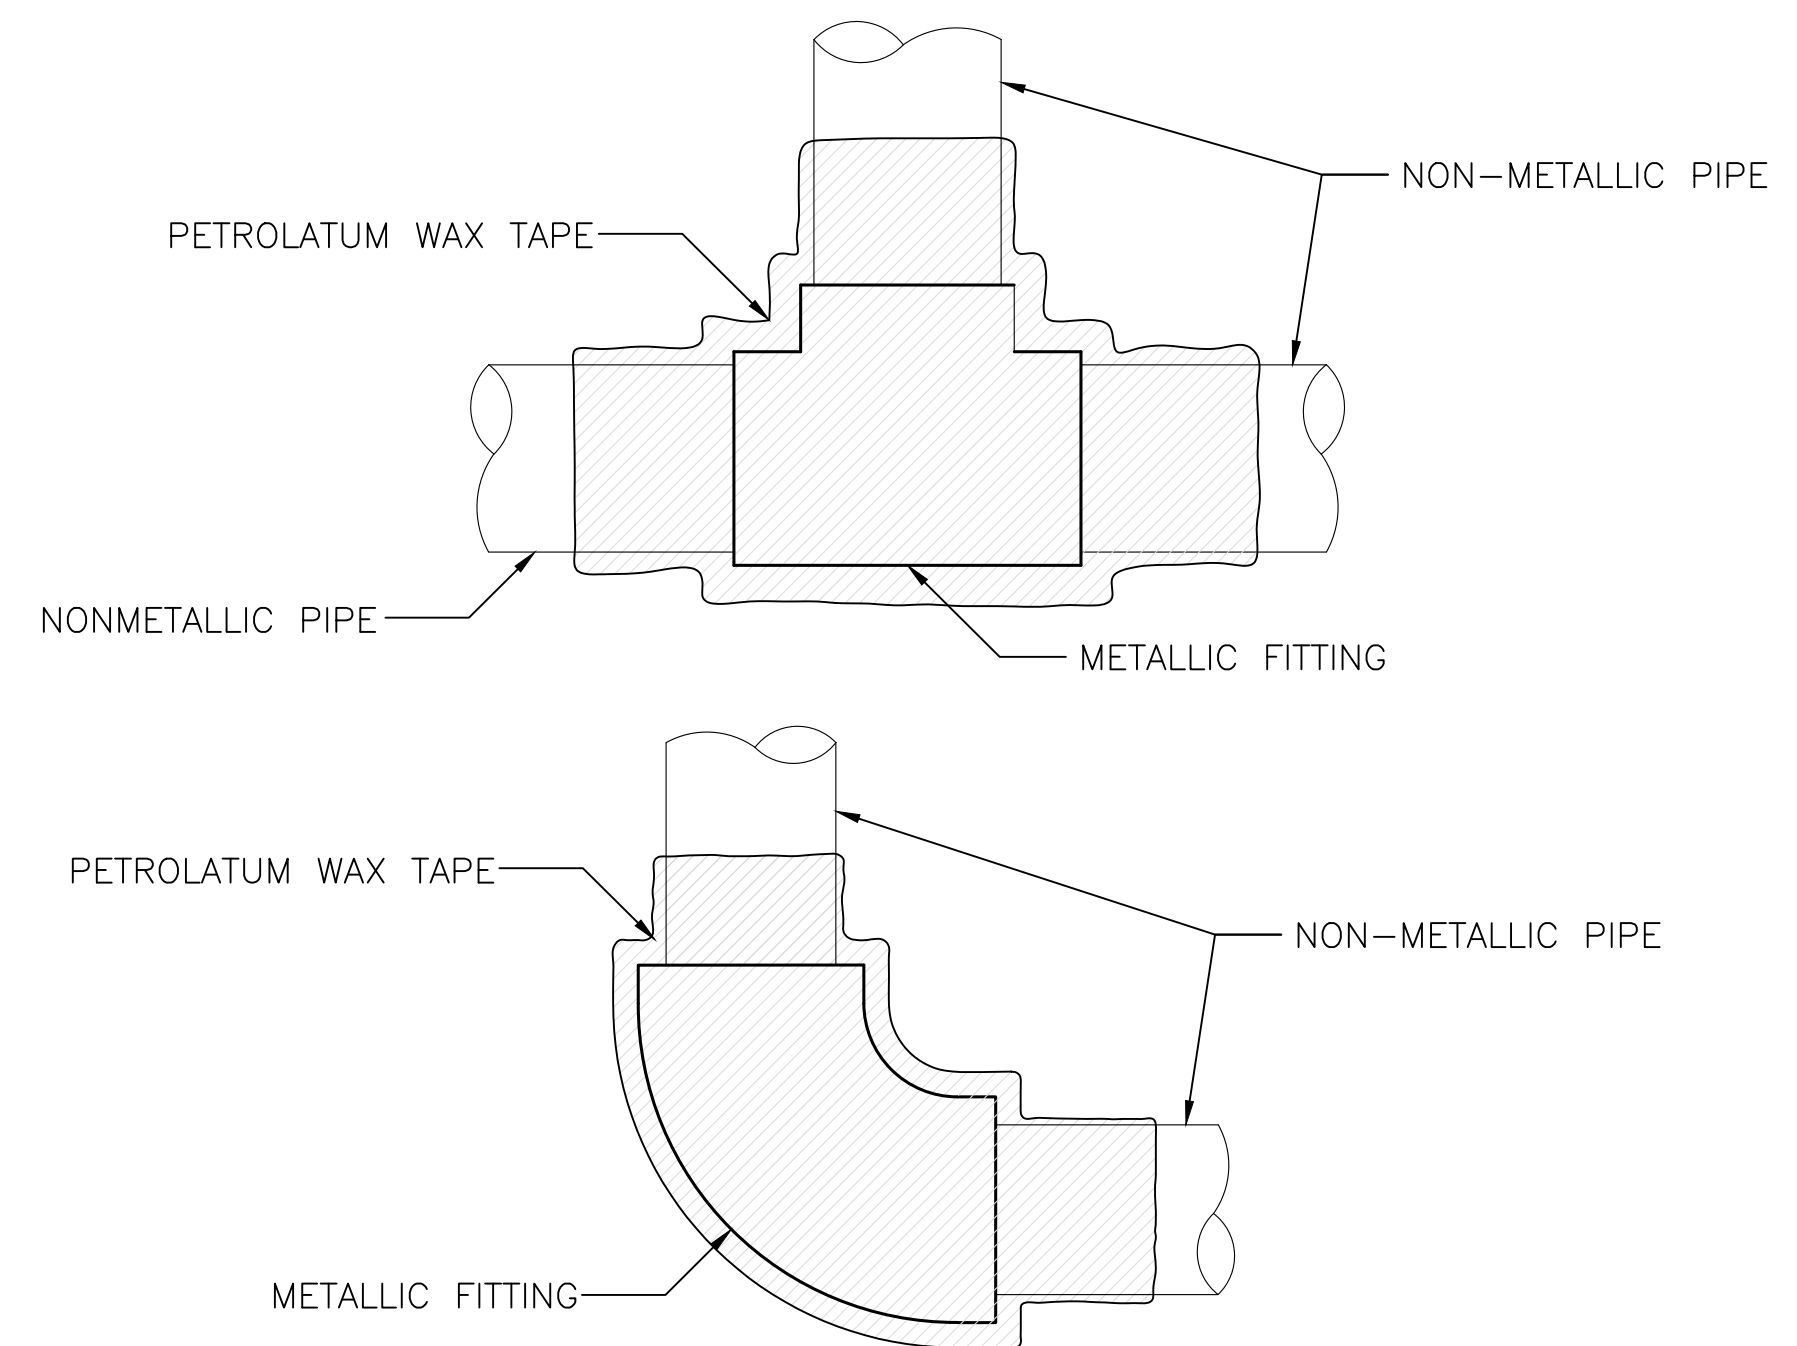

NOTES:

1. PETROLATUM WAX TAPE SHALL OVERLAP PIPE BY 2 TIMES THE PIPE DIAMETER.
2. ENCASE FITTING AND PETROLATUM WAX TAPE IN CONCRETE WITH 2-INCH COVER AT MINIMUM

CORROSION CONTROL FOR 2-INCH DIAMETER  
METALLIC FITTING

NTS

4



Main:  
636 Fifth Street, Santa Rosa, CA 95404  
East Bay:  
55 Harrison Street, Suite 525,  
Oakland, CA 94607  
(707) 576-0829



1000 Broadway, Suite 320  
Oakland, CA 94607  
Tel. (510) 903-6600, Fax (510) 903-6601

**FREEDOM  
HIGH SCHOOL**

**NEW AUXILIARY  
GYMNASIUM**

1050 NEROLY RD,  
OAKLEY, CA 94561

**LIBERTY UNION  
HIGH SCHOOL  
DISTRICT**

DSA APP NO. 01-119278

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PTN: 61721-78 FILE NO: 7-H4

**BID DOCUMENT**

**APRIL 27, 2021**

SHEET TITLE


**CATHODIC  
PROTECTION**

SHEET NUMBER


**CP1.1**




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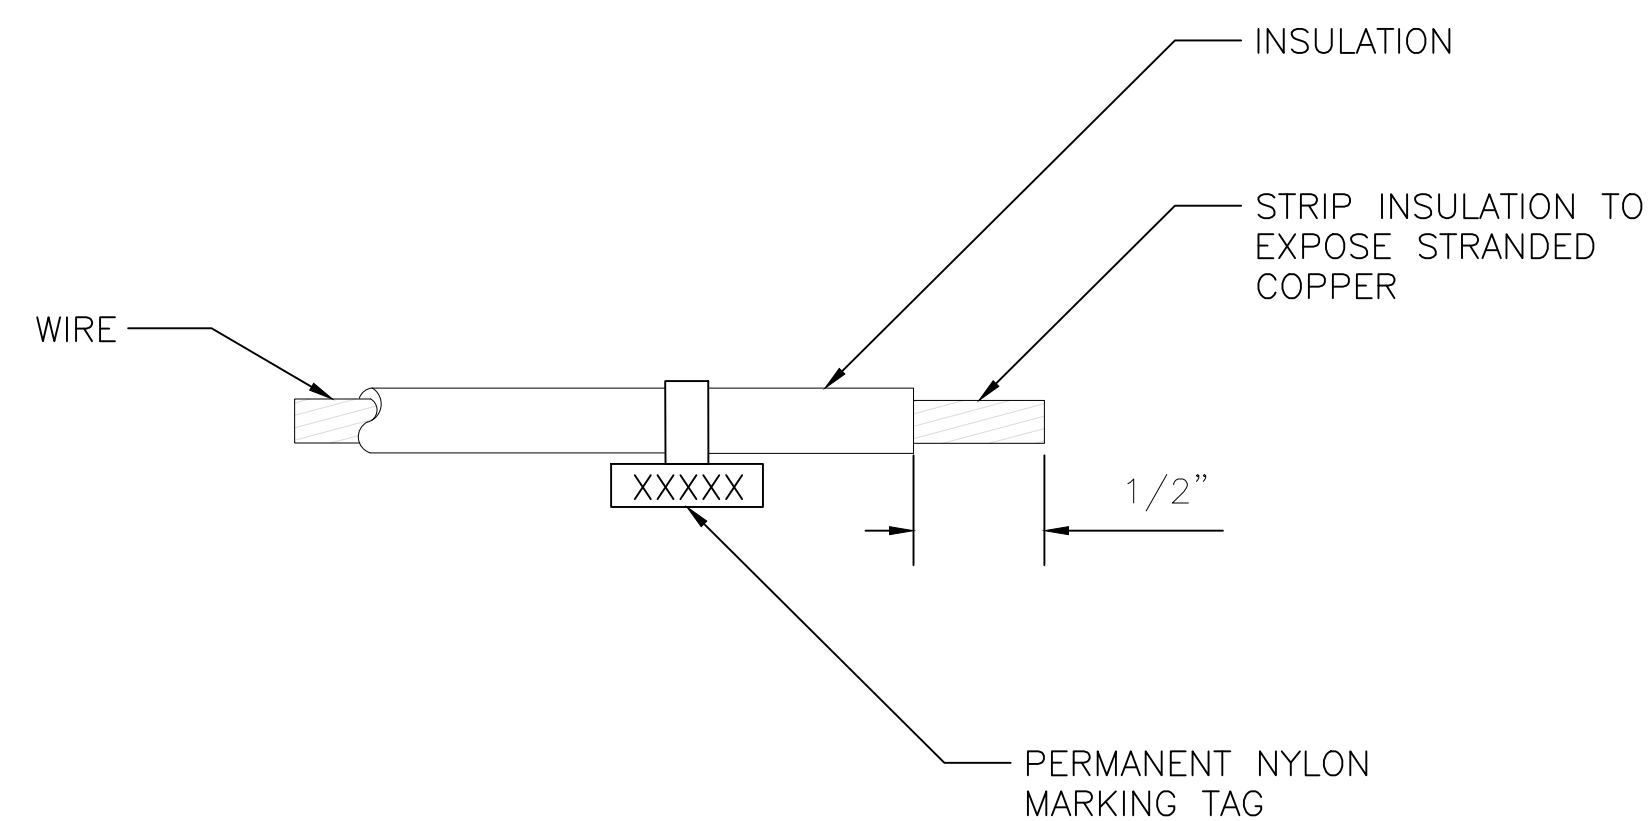
FLUSH MOUNTED TEST STATION DETAIL  
NTS (1)

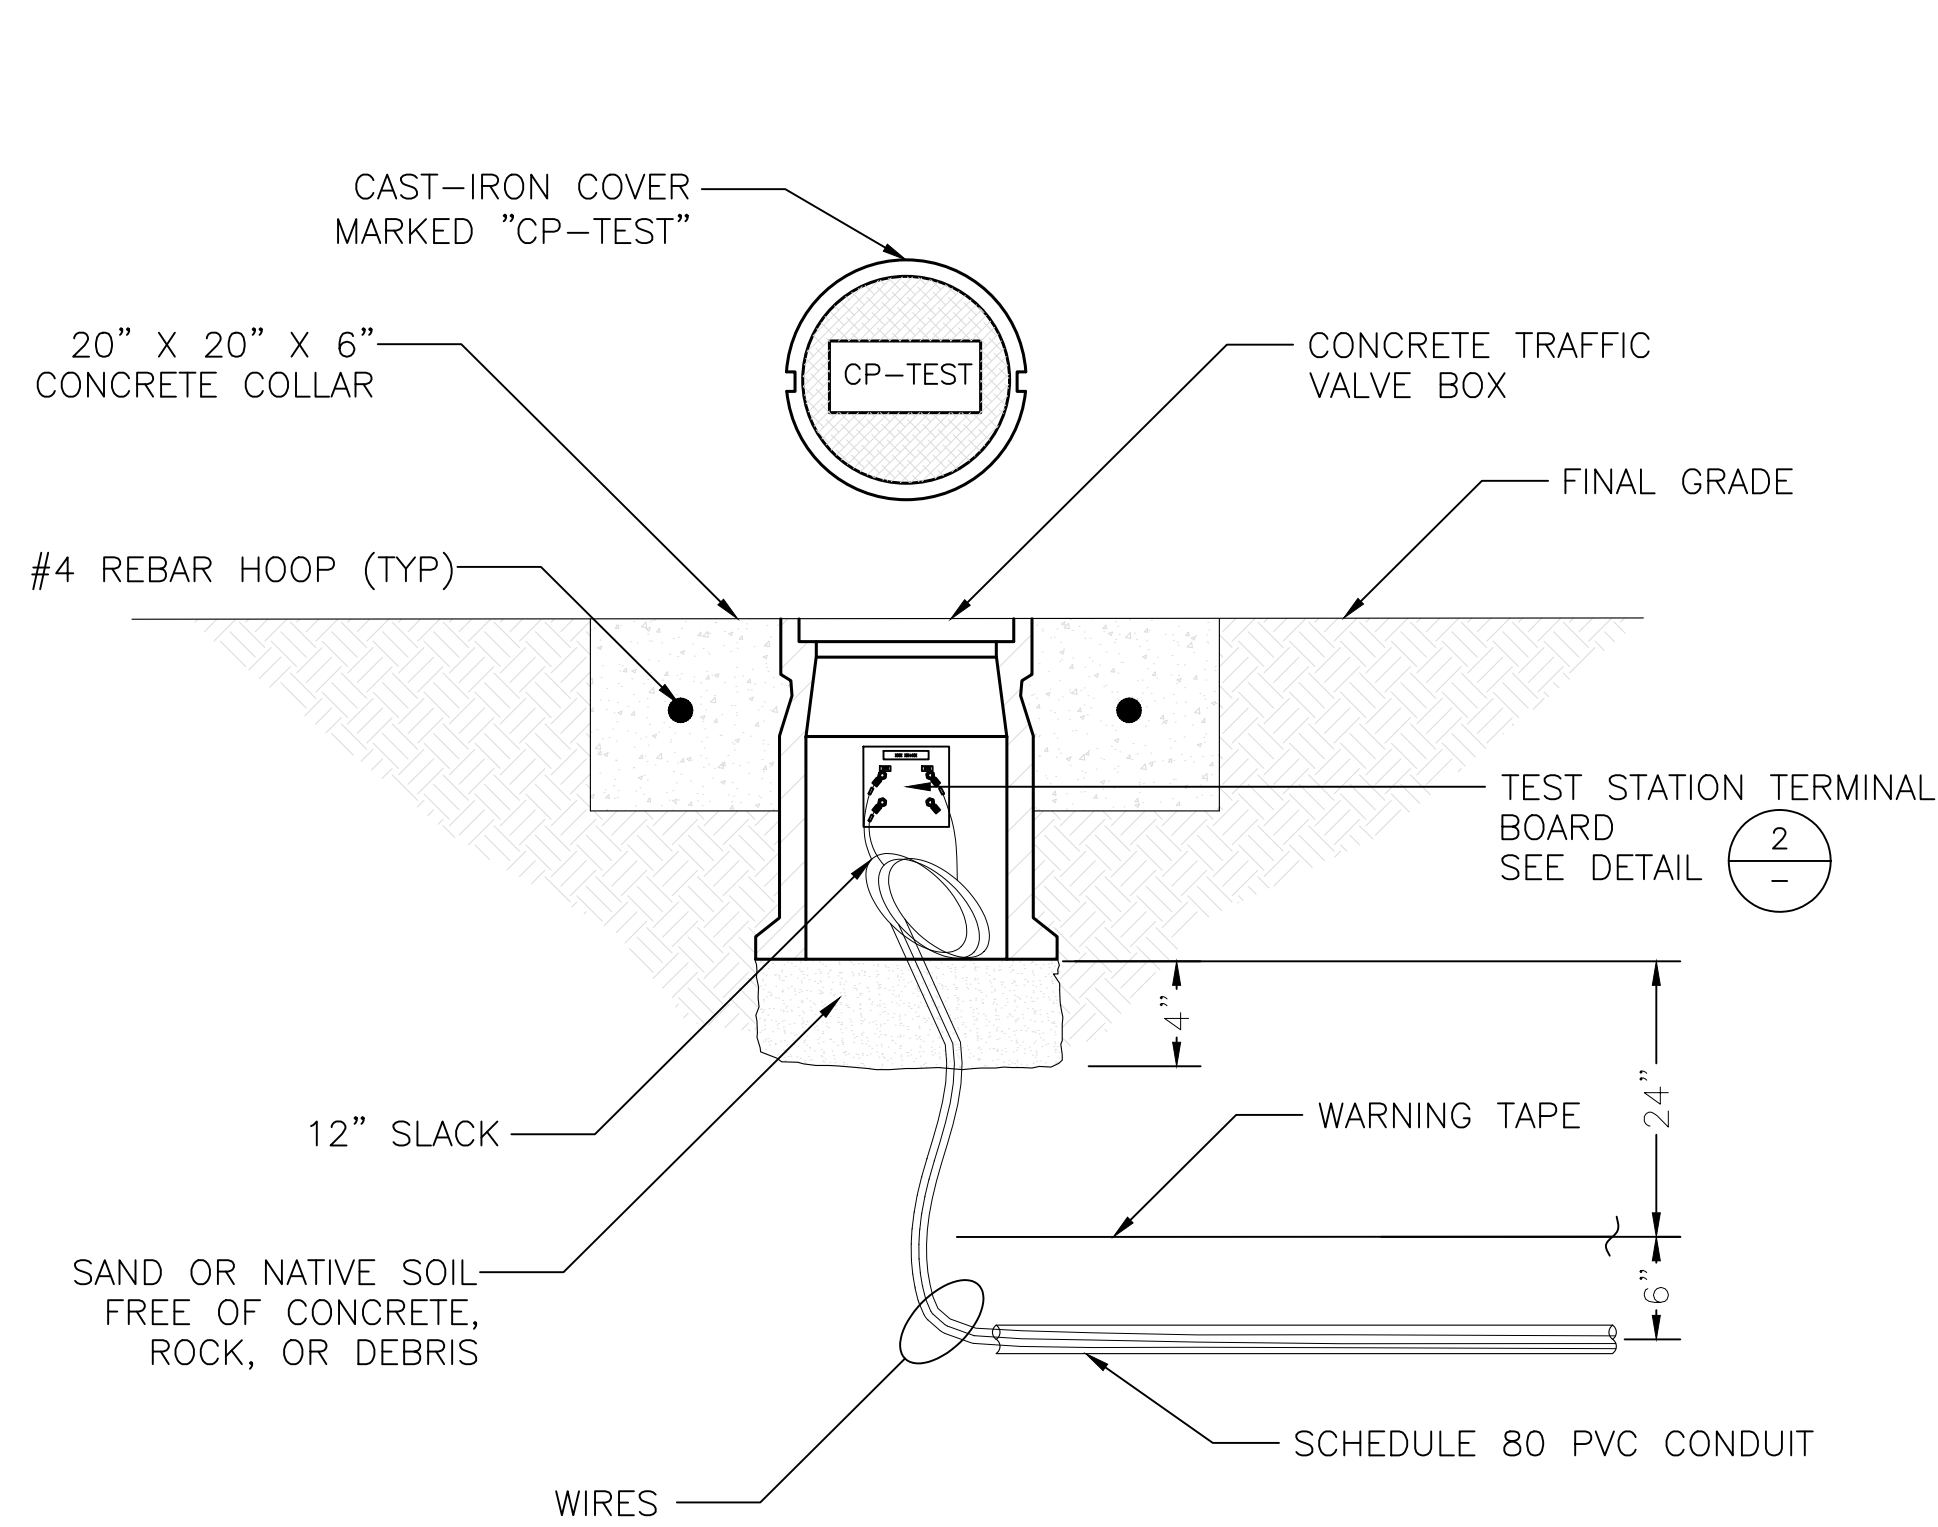


FLUSH-MOUNTED ANODE TEST STATION  
(ATS) TERMINAL BOARD DETAIL  
NTS (2)

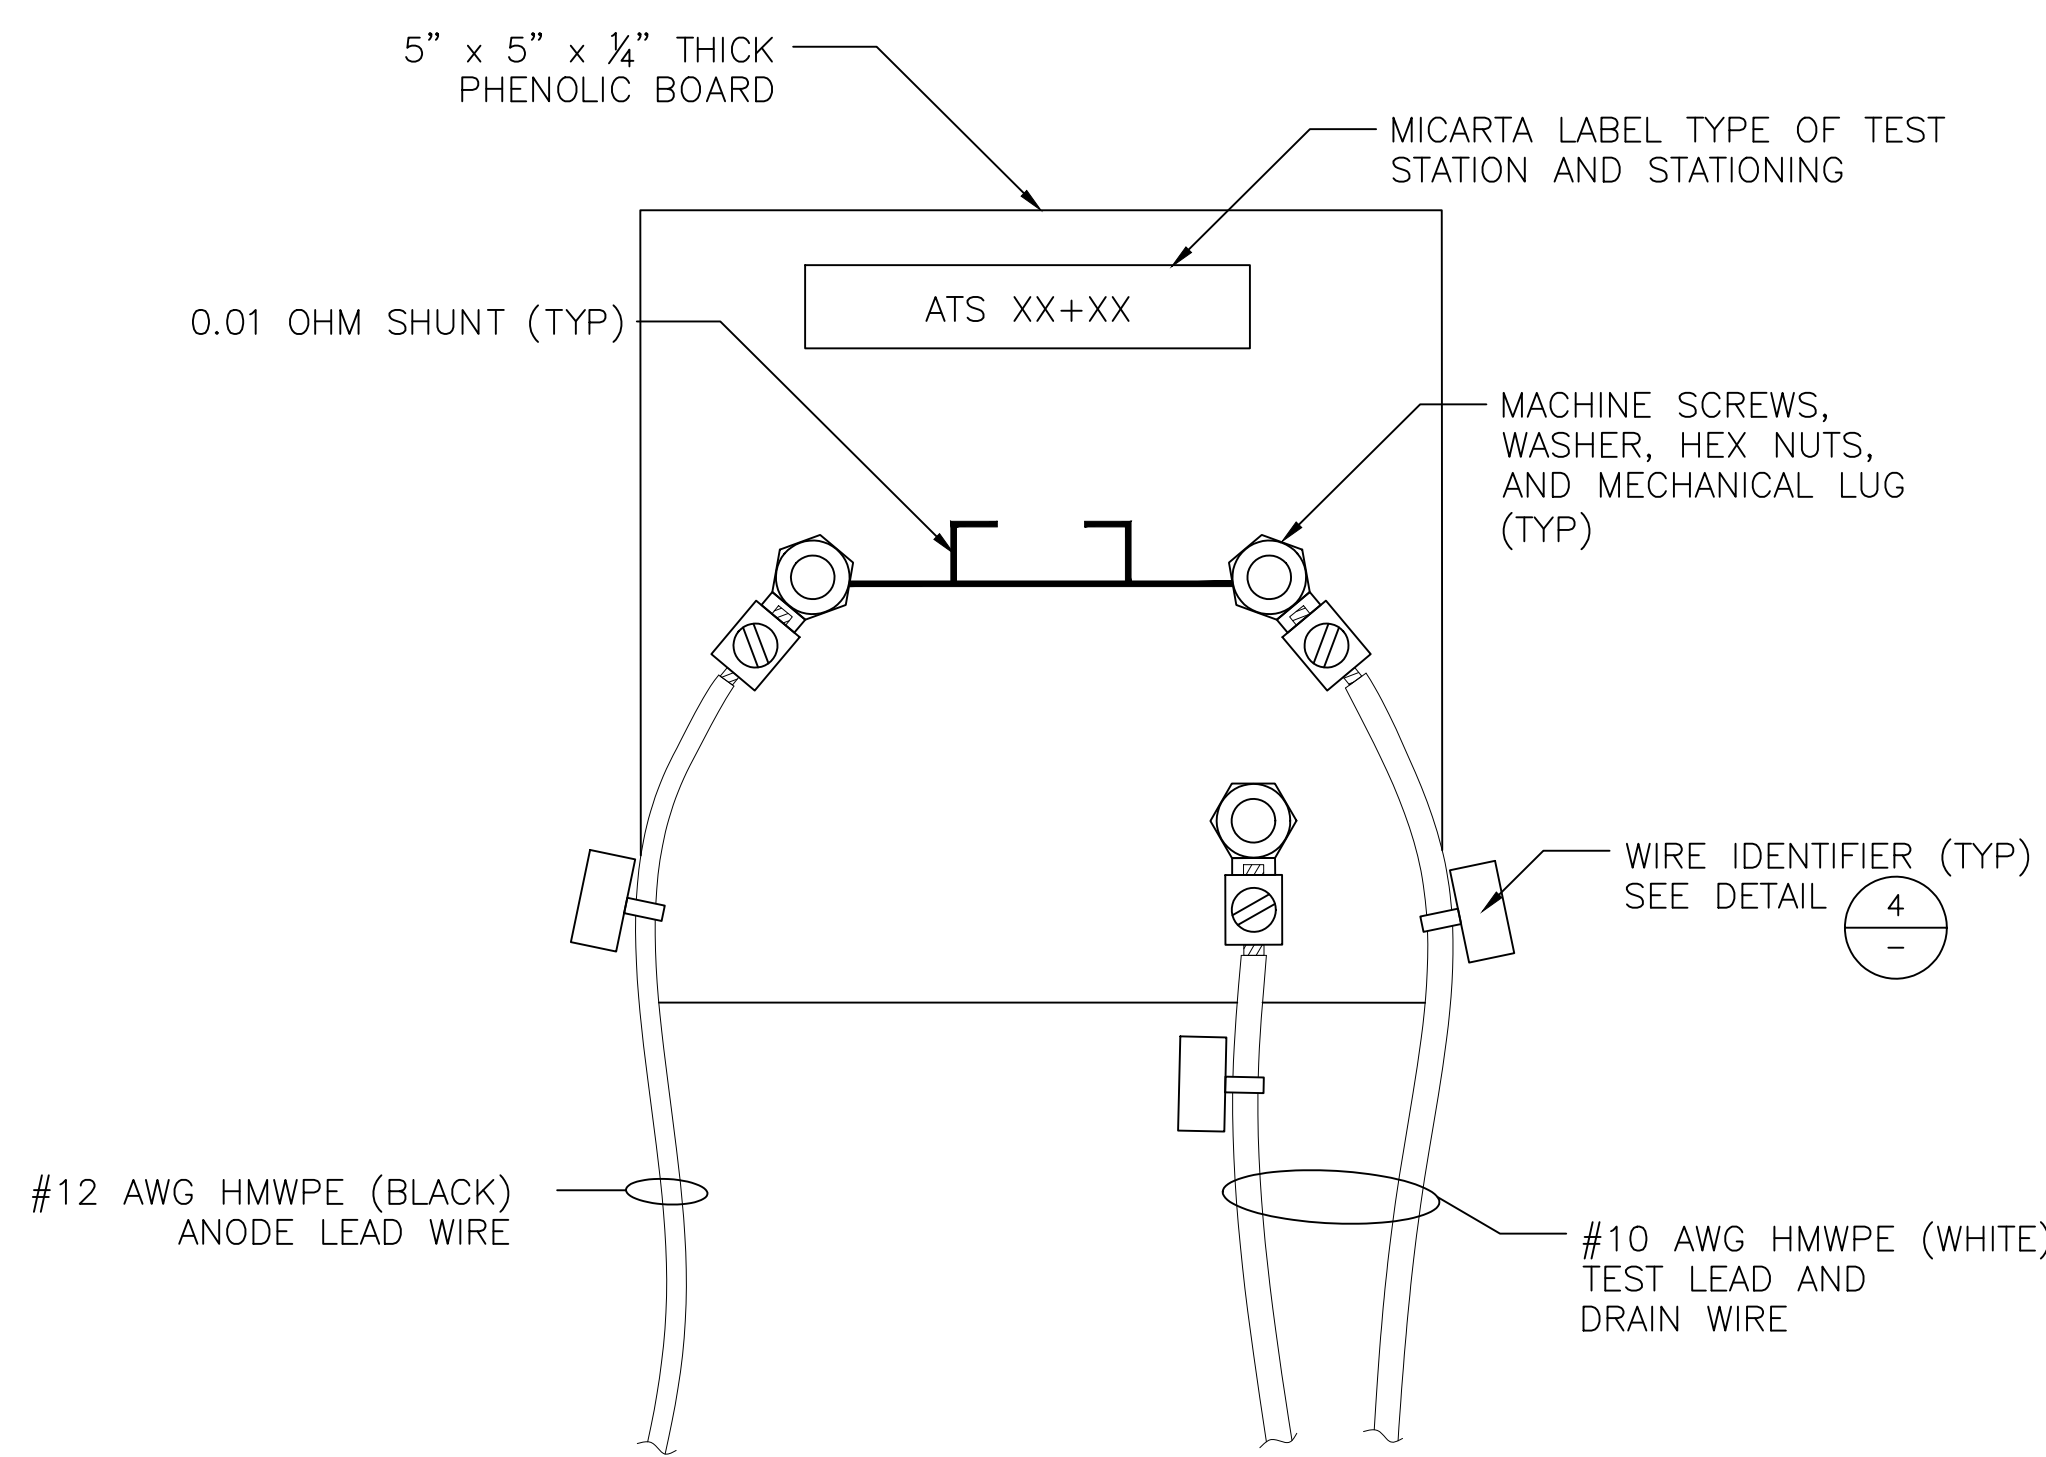

DIELECTRIC INSULATING FLANGE KIT DETAIL  
WITH SECTION VIEW  
NTS (3)

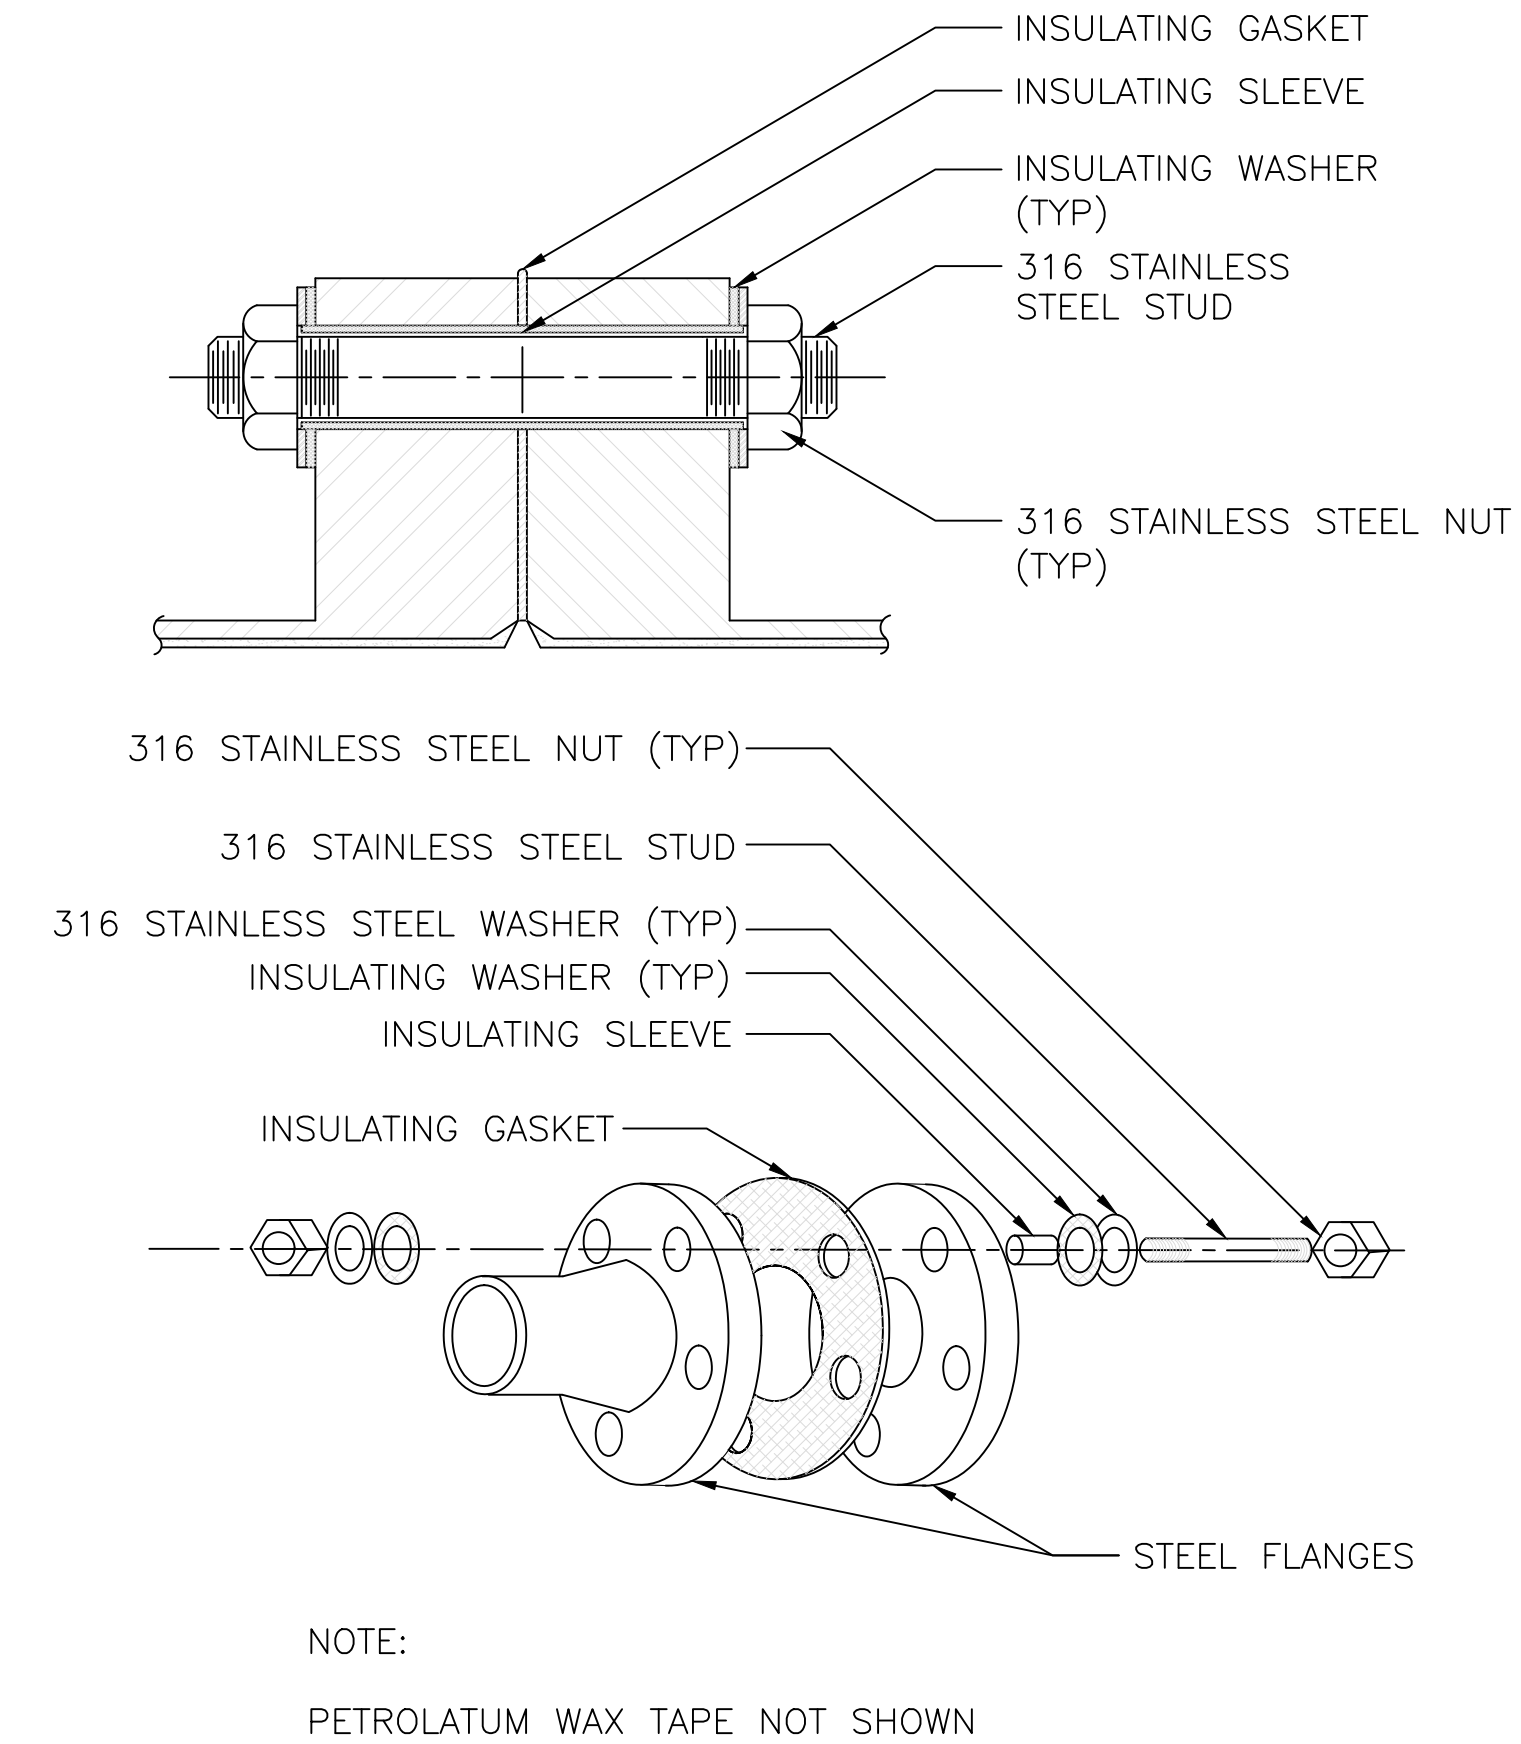

WIRE IDENTIFIER DETAIL  
NTS (4)

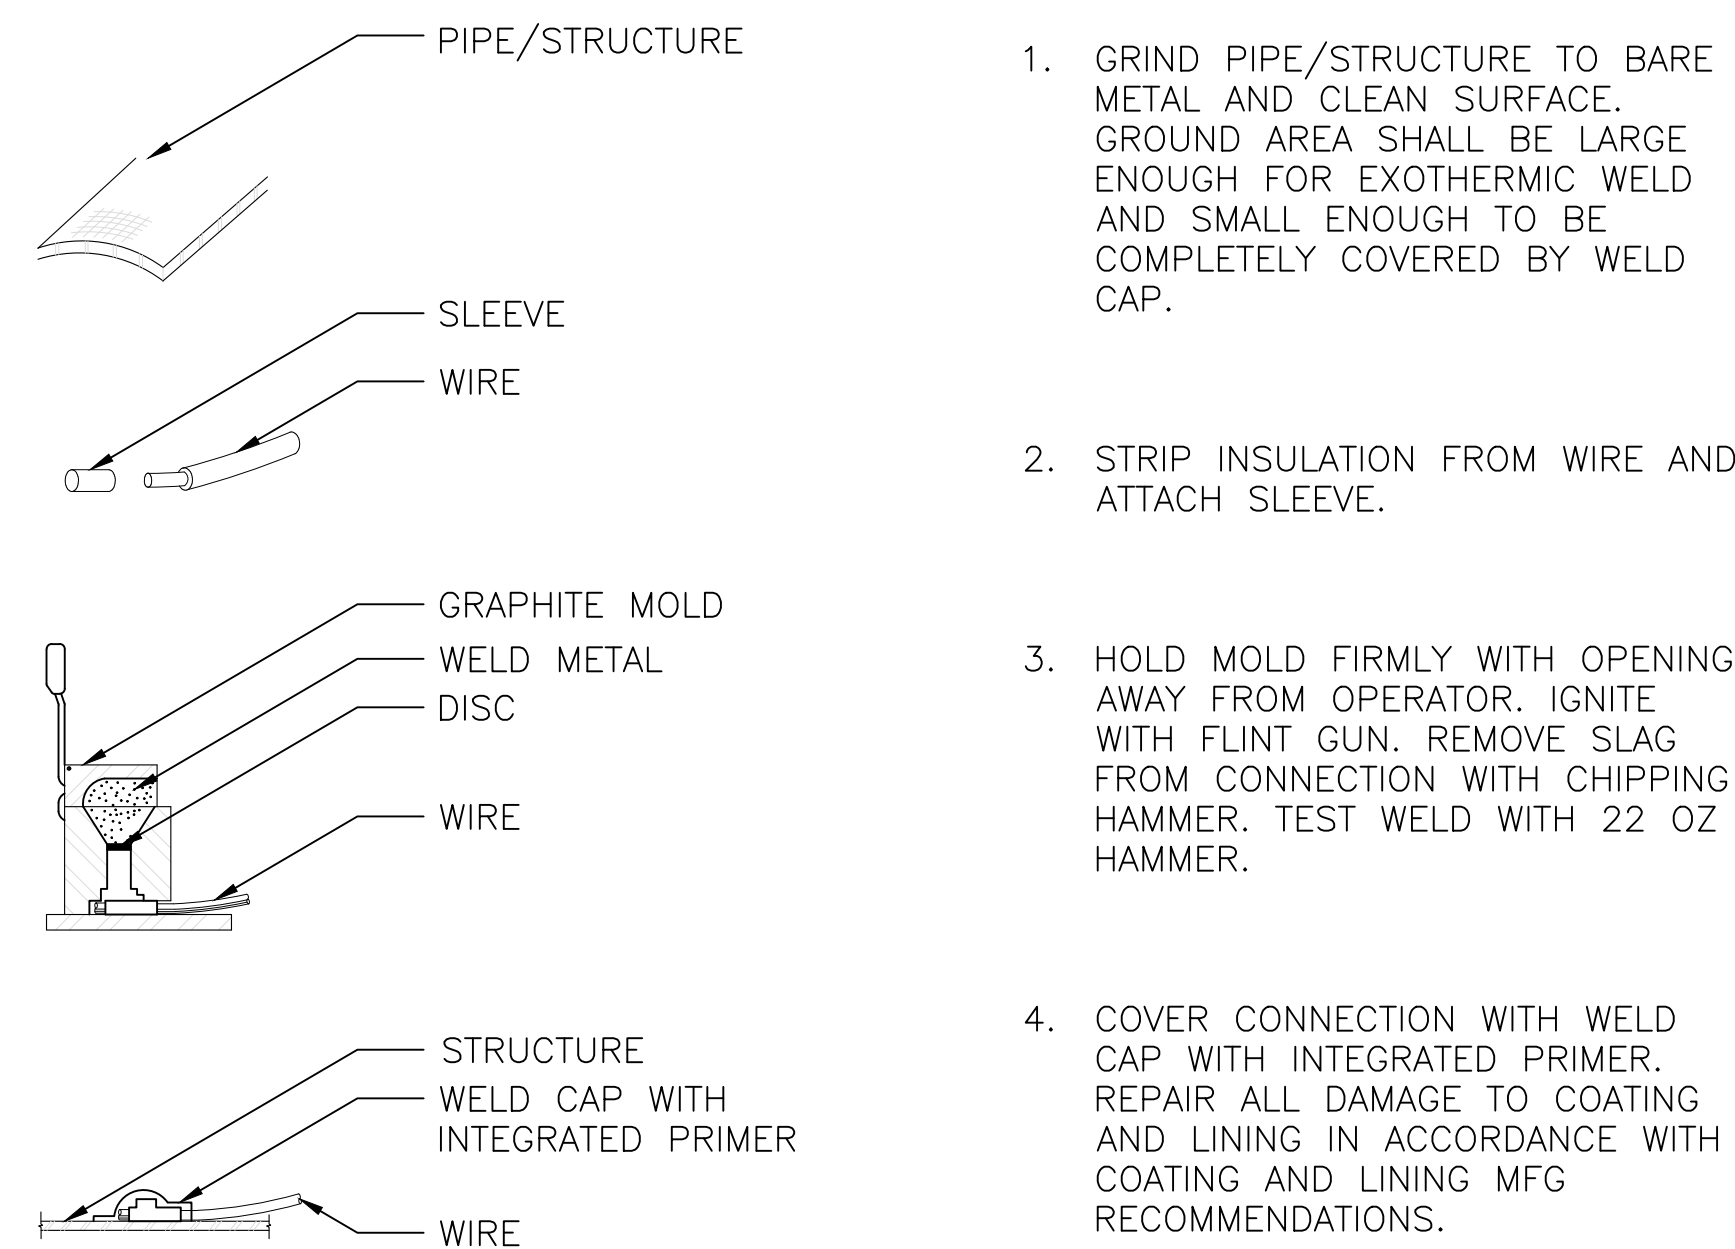

EXOTHERMIC WELD DETAIL FOR  
DUCTILE IRON AND STEEL PIPE  
NTS (5)

**QUATTROCCHI KWOK ARCHITECTS**  
Main:  
636 Fifth Street, Santa Rosa, CA 95404  
East Bay:  
55 Harrison Street, Suite 525,  
Oakland, CA 94607  
(707) 576-0829

**V&A**  
1000 Broadway, Suite 320  
Oakland, CA 94607  
Tel: (510) 903-6600, Fax (510) 903-6601

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**APRIL 27, 2021**

SHEET TITLE

**CATHODIC  
PROTECTION**

SHEET NUMBER

**CP1.2**